#### **GENERAL NOTES**

#### **CODE AND STANDARDS**

1. ALL WORK SHALL COMPLY WITH 2017 NATIONAL ELECTRIC CODE (NEC), 2018 NORTH CAROLINA BUILDING CODE (NCBC), 2018 NORTH CAROLINA RESIDENTIAL CODE (NCRC), PLUMBING CODE (NCPC), AND ALL STATE AND LOCAL BUILDING, ELECTRICAL, AND PLUMBING CODES.

2. DRAWINGS HAVE BEEN DETAILED ACCORDING TO UL LISTING REQUIREMENTS.

#### SITE NOTES / OSHA REGULATION

1. A LADDER SHALL BE IN PLACE FOR INSPECTION IN COMPLIANCE WITH OSHA REGULATIONS

2. THE PV MODULES ARE CONSIDERED NON-COMBUSTIBLE AND THIS SYSTEM IS A UTILITY INTERACTIVE SYSTEM.

3. THE SOLAR PV INSTALLATION SHALL NOT OBSTRUCT ANY PLUMBING. MECHANICAL. OR BUILDING ROOF VENTS. 4. ROOF COVERINGS SHALL BE DESIGNED, INSTALLED, AND MAINTAINED IN ACCORDANCE WITH THIS CODE AND

THE APPROVED MANUFACTURER'S INSTRUCTIONS SUCH THAT THE ROOF COVERING SHALL SERVE TO PROTECT THE BUILDING OR STRUCTURE.

5. NO. OF SHINGLE LAYERS: 1

#### **SOLAR CONTRACTOR**

1. MODULE CERTIFICATIONS WILL INCLUDE UL1703, IEC61646, IEC61730.

2. IF APPLICABLE, MODULE GROUNDING LUGS MUST BE INSTALLED AT THE MARKED GROUNDING LUG HOLES PER THE MANUFACTURER'S INSTALLATION REQUIREMENTS.

3. AS INDICATED BY DESIGN, OTHER NRTL LISTED MODULE GROUNDING DEVICES MAY BE USED IN PLACE OF STANDARD GROUNDING LUGS AS SHOWN IN MANUFACTURER DOCUMENTATION AND APPROVED BY THE AHJ.

4. CONDUIT AND WIRE SPECIFICATIONS ARE BASED ON MINIMUM CODE REQUIREMENTS AND ARE NOT MEANT TO LIMIT UP-SIZING AS REQUIRED BY FIFLD CONDITIONS

5. CONDUIT POINT OF PENETRATION FROM EXTERIOR TO INTERIOR TO BE INSTALLED AND SEALED WITH A SUITABLE SEALING COMPOUND.

6. DC WIRING LIMITED TO MODULE FOOTPRINT W/ ENPHASE AC SYSTEM.

7. ENPHASE WIRING SYSTEMS SHALL BE LOCATED AND SECURED UNDER THE ARRAY W/ SUITABLE WIRING CLIPS. 8. MAX DC VOLTAGE CALCULATED USING MANUFACTURER PROVIDED TEMP COEFFICIENT FOR VOC UNLESS NOT AVAII ABI F

9. ALL INVERTERS, MOTOR GENERATORS, PHOTOVOLTAIC MODULES, PHOTOVOLTAIC PANELS, AC PHOTOVOLTAIC MODULES, DC COMBINERS, DC-TO-DC CONVERTERS, SOURCE CIRCUIT COMBINERS, AND CHARGE CONTROLLERS INTENDED FOR USE IN A PHOTOVOLTAIC POWER SYSTEM WILL BE IDENTIFIED AND LISTED FOR THE APPLICATION PER NEC 690.4(B).

10. ALL SIGNAGE TO BE PLACED IN ACCORDANCE WITH LOCAL BUILDING CODE.

11. TERMINALS AND LUGS WILL BE TIGHTENED TO MANUFACTURER TORQUE SPECIFICATIONS (WHEN PROVIDED) IN ACCORDANCE WITH NEC CODE 110.14(D) ON ALL ELECTRICAL CONNECTIONS.

#### **EQUIPMENT LOCATIONS**

1. PROPER ACCESS AND WORKING CLEARANCE AROUND EXISTING AND PROPOSED ELECTRICAL EQUIPMENT WILL BE PROVIDED AS PER SECTION NEC 110.26.

2. EQUIPMENT INSTALLED IN DIRECT SUNLIGHT MUST BE RATED FOR EXPECTED OPERATING TEMPERATURE AS SPECIFIED BY NEC 690.31(A) AND NEC TABLE 310.15(B)

3. ALL EQUIPMENT SHALL BE INSTALLED ACCESSIBLE TO QUALIFIED PERSONNEL ACCORDING TO NEC

4. ALL COMPONENTS ARE LISTED FOR THEIR PURPOSE AND RATED FOR OUTDOOR USAGE WHEN APPROPRIATE.

#### PROJECT INFORMATION:

**NUMBER OF STORIES: 2 CONDUIT RUN:** Interior **ECOBEE QTY**: 2

**LIGHT BULB QTY:** 0 **PV METER:** Not Required

#### **ROOF TYPE (1) INFORMATION:**

**ROOF TYPE:** Comp Shingle FRAMING TYPE: Rafter **SHEATHING TYPE: OSB** 

STANDOFF: SFM Infinity Switchblade Flashkit

RACKING: Unirac SFM Infinity @ 48" OC Portrait / 64" OC Landscape

**NUMBER OF ATTACHMENTS: 49** 

#### **ROOF TYPE (2) INFORMATION (IF APPLICABLE):**

\*SEE PV4.2


#### SYSTEM TO BE INSTALLED INFORMATION:

SYSTEM SIZE: 9.6 kW DC

MODULE TYPE: (24) REC Solar REC400AA Pure **INVERTER TYPE:** Enphase IQ7+ Microinverters

**MONITORING:** Enphase IQ Combiner 3 X-IQ-AM1-240-3

#### **AERIAL VIEW**

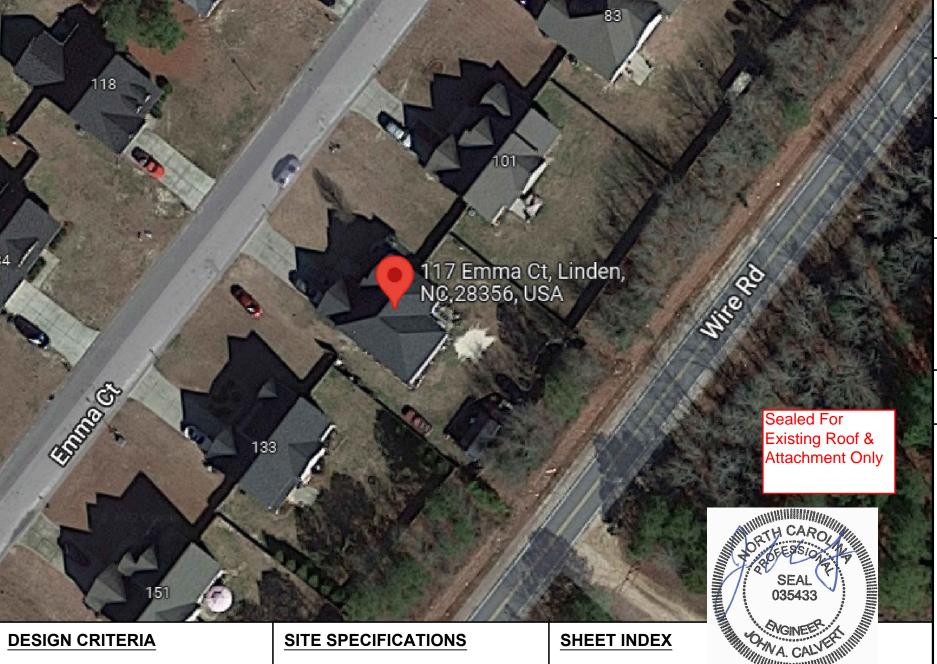

WIND SPEED: 115 MPH GROUND SNOW LOAD: 15 lb/ft2 **WIND EXPOSURE FACTOR:** C **SEISMIC DESIGN CATEGORY:** B **CONSTRUCTION - V-B ZONING: RESIDENTIAL** 

#### **SCOPE OF WORK**

INSTALLATION OF UTILITY INTERACTIVE PHOTOVOLTAIC SOLAR SYSTEM AND ANY NECESSARY ADDITIONAL WORK NEEDED FOR INSTALLATION.

**PV1** - COVER SHEET

PV2 - SITE PLAN PV3 - ROOF PLAN

**PV4** - STRUCTURAL

PV5 - ELECTRICAL 3-LINE DIAGRAM **PV6** - ELECTRICAL CALCULATIONS

PV7 - WARNING LABELS AND LOCATIONS (ALL OTHER SHEETS AS REQUIRED)

SS - PRODUCT SPEC. SHEETS

Firm No.: D-0369

#### **UTILITY COMPANY:**

Duke Energy NC

#### **PERMIT ISSUER:**

**Harnett County** 

**CUSTOMER INFORMATION** 

Sherah Liverpool-Archer Emma (

DRAWING BY:

3/9/2022

#### **ENPHASE ENERGY**

**BLUE RAVEN** 

1403 N. Research Way Orem. UT 84097

800.377.4480

WWW BLUERAVENSOLAR COM

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IN CONNECTION WITH THE SALE AND USE OF THE RESPECTIVE EQUIPMENT

WITHOUT THE WRITTEN PERMISSION

OF BLUE RAVEN SOLAR LLC.

**NABCEP** 

**CERTIFIED** 

PV INSTALLATION

**PROFESSIONAL** 

Scott Gurney

#PV-011719-015866

CONTRACTOR:

**BRS FIELD OPS** 

385-498-6700

Carolina 28356

Linden, North

SIZE

**SYSTEM** 

20 9

 $\overset{\mathsf{DC}}{\mathsf{D}}$ 

PLOT DATE:

March 9, 2022

PROJECT NUMBER:

479794

SHEET NAME:

0

**COVER SHEET** 

REVISION:

PV1

CB AC MSP M **13**1°c **Š ⊠**î∘ **13**1°c **S S**∮: **S ⊠**i≎ ⊠îc **S**ic **13**16 BSic BSic **LEGEND** 

JUNCTION BOX

СВ

LC

**UTILITY METER** 

MAIN SERVICE PANEL

AC AC DISCONNECT

**COMBINER BOX** 

LOAD CENTER

SUB SUBPANEL

PV **PV METER** 

TS TRANSFER SWITCH

FIRE SETBACK

PROPERTY LINE

SCALE: 1/16" = 1'-0"

Sealed For Existing Roof & Attachment Only



**BLUE RAVEN** 

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> CERTIFIED PV INSTALLATION **PROFESSIONAL**

Scott Gurney #PV-011719-015866 **TRENCHING** 

> CONTRACTOR: **BRS FIELD OPS** 385-498-6700

Sherah Liverpool-Archer

Linden, North Carolina 28356 117 Emma Ct.

DC SYSTEM SIZE: 9.6 kW DC

DRAWING BY:

**CUSTOMER INFORMATION:** 

ENPHASE ENERGY

PLOT DATE:

March 9, 2022

PROJECT NUMBER:

479794

SHEET NAME:


SITE PLAN

REVISION: 0 AGE NUMBER: PV2

FRONT OF HOME

117 Emma Ct.

Firm No. : D-0369

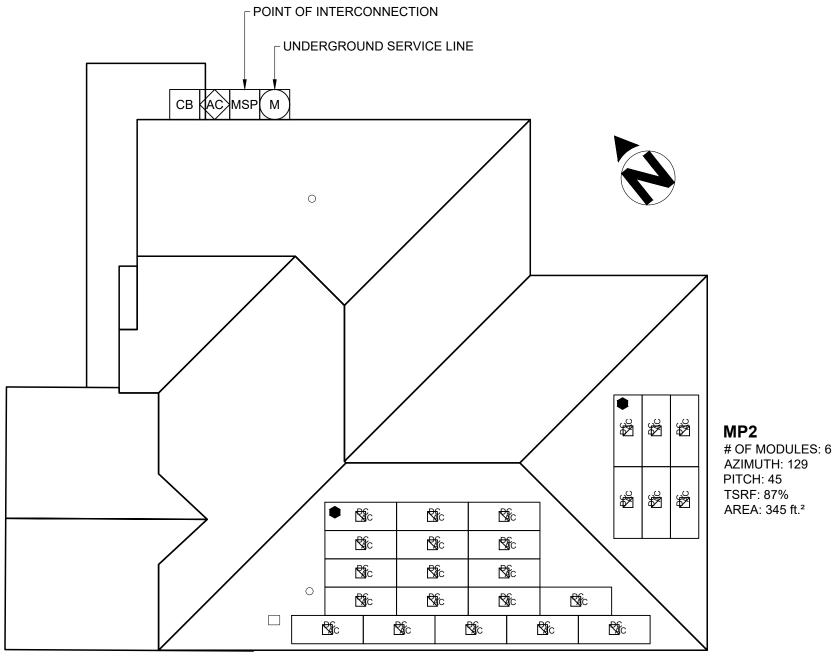

MP1 # OF MODULES: 18 AZIMUTH: 219 PITCH: 45 TSRF: 91% AREA: 665 ft.2

**LEGEND** 

JUNCTION BOX



MAIN SERVICE PANEL

AC AC DISCONNECT

СВ **COMBINER BOX** 

LOAD CENTER LC

SUB SUBPANEL

PV **PV METER** TS TRANSFER SWITCH

FIRE SETBACK

**TRENCHING** 

PROPERTY LINE

SCALE: 1/8" = 1'-0"

Sealed For



**CUSTOMER INFORMATION:** 

DRAWING BY:

Sherah Liverpool-Archer

Emma Ct.

**ENPHASE ENERGY** 

**BLUE RAVEN** 

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> **NABCEP** CERTIFIED

PV INSTALLATION

**PROFESSIONAL** Scott Gurney

#PV-011719-015866

CONTRACTOR: **BRS FIELD OPS** 

385-498-6700

Linden, North Carolina 28356

DC SYSTEM SIZE: 9.6 kW DC

PLOT DATE:

March 9, 2022

PROJECT NUMBER:

479794

SHEET NAME:

**ROOF PLAN** 

REVISION:

0


AGE NUMBER: PV3

Firm No. : D-0369

DC SYSTEM SIZE: 9.6 kW DC MODULE: (REC Solar REC400AA Pure) INVERTER(S): Enphase IQ7+ Microinverters

AREA: 345 ft.2

Existing Roof & Attachment Only

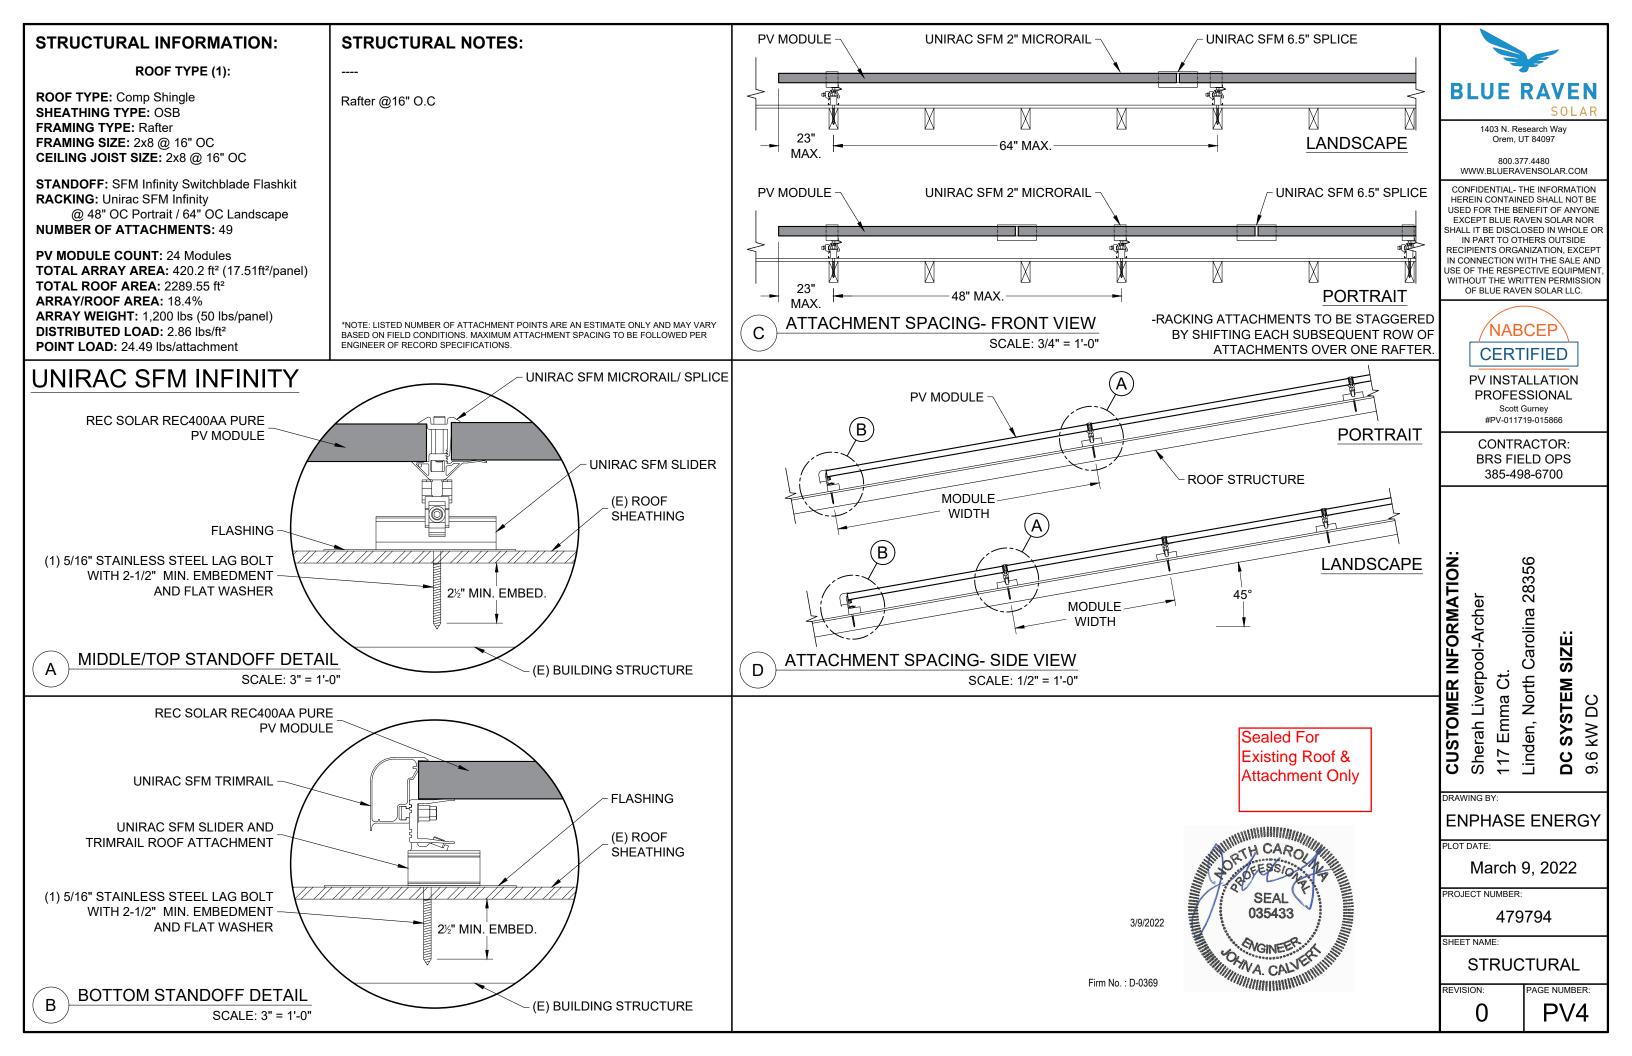



#### **ELECTRICAL NOTES:**

SUPPLY SIDE BREAKER IN MSP, POI EXTERIOR

**DESIGNER NOTES:** 

24 INVERTERS x 290 W AC = 6.96 kW AC PANEL WATTAGE = 400 W DC

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PV INSTALLATION **PROFESSIONAL** 

Scott Gurney #PV-011719-015866

CONTRACTOR: **BRS FIELD OPS** 385-498-6700

Sherah Liverpool-Archer

Linden, North Carolina 28356 Emma Ct

SIZE

SYSTEM S KW DC

DC 9.6

DRAWING BY:

**CUSTOMER INFORMATION** 

**ENPHASE ENERGY** 

PLOT DATE:

March 9, 2022


PROJECT NUMBER:

479794

**ELECTRICAL** 

REVISION:

PV5

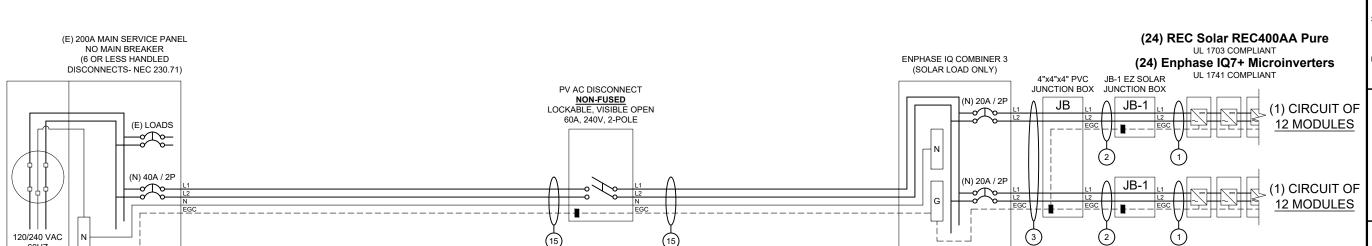





#### **INTERCONNECTION NOTES**

1 PHASE

TO UTILITY GRID

VERIFICATION WILL BE DONE TO ENSURE THE

GROUNDING ELECTRODE SYSTEM IS CONGRUENT

IF NOT, A NEW GROUND ROD WILL BE INSTALLED.

WITH CURRENT REQUIREMENTS. (NEC 250 PART III)

(E) GROUNDING ELECTRODE(S)

705.11 AN ELECTRIC POWER PRODUCTION SOURCE, WHERE CONNECTED TO THE SUPPLY SIDE OF THE SERVICE DISCONNECTING MEANS AS PERMITTED IN 230.82(6), SHALL COMPLY WITH 705.11 (A) THROUGH (E).

(N) %" COPPER GROUND ROD, 8' LONG, MIN. 6' FROM (E)

GROUNDING CONDUCTOR.

GEC INSTALLED PER NEC

250.64: 6 OR 4 AWG SOLID

**PERMIT ISSUER:** Harnett County

**UTILITY COMPANY:** Duke Energy NC

MODULE SPECIFICATIONS	REC Solar REC400AA Pure
RATED POWER (STC)	400 W
MODULE VOC	48.8 V DC
MODULE VMP	42.1 V DC
MODULE IMP	9.51 A DC
MODULE ISC	10.3 A DC
VOC CORRECTION	-0.24 %/°C
VMP CORRECTION	-0.26 %/°C
SERIES FUSE RATING	25 A DC
ADJ. MODULE VOC @ ASHRAE LOW TEMP	52.9 V DC
ADJ. MODULE VMP @ ASHRAE 2% AVG. HIGH T	EMP 37.5 V DC

MICROINVERTER SPECIFICATIONS	Enphase IQ7+	Micro	inverters
POWER POINT TRACKING (MPPT) MIN/MAX	22 -	60	V DC
MAXIMUM INPUT VOLTAGE		60	V DC
MAXIMUM DC SHORT CIRCUIT CURRENT		15	A DC
MAXIMUM USABLE DC INPUT POWER		440	W
MAXIMUM OUTPUT CURRENT		1.21	A AC
AC OVERCURRENT PROTECTION		20	Α
MAXIMUM OUTPUT POWER		290	W
CEC WEIGHTED EFFICIENCY		97	%

AC PHOTOVOLATIC	MODULE MARKIN	G (NEC 690 52)

NOMINAL OPERATING AC VOLTAGE	240 V AC
NOMINAL OPERATING AC FREQUENCY	47 - 68 HZ AC
MAXIMUM AC POWER	240 VA AC
MAXIMUM AC CURRENT	1.0 A AC
MAXIMUM OCPD RATING FOR AC MODULE	20 A AC

DESIGN LOCATION AND TEMPERATURES	
TEMPERATURE DATA SOURCE	ASHRAE 2% AVG. HIGH TEMP
STATE	North Carolina
CITY	Linden
WEATHER STATION	SEYMOUR-JOHNSON AFB
ASHRAE EXTREME LOW TEMP (°C)	-10
ASHRAE 2% AVG. HIGH TEMP (°C)	35

SYSTEM ELECTRICAL SPECIFICATIONS	CIR 1	CIR 2	CIR 3	CIR 4	CIR 5	CIR 6
NUMBER OF MODULES PER MPPT	12	12				
DC POWER RATING PER CIRCUIT (STC)	4800	4800				
TOTAL MODULE NUMBER	24 MODULES					
STC RATING OF ARRAY	9600W DC					
AC CURRENT @ MAX POWER POINT (IMP)	14.5	14.5				
MAX. CURRENT (IMP X 1.25)	18.15	18.15				
OCPD CURRENT RATING PER CIRCUIT	20	20				
MAX. COMB. ARRAY AC CURRENT (IMP)	29.0					
MAX. ARRAY AC POWER	6960W AC					

AC VOLTAGE RISE CALCULATIONS	DIST (FT)	COND.	VRISE(V)	VEND(V)	%VRISE	
VRISE SEC. 1 (MICRO TO JBOX)	43.2	12 Cu.	2.09	242.09	0.87%	
VRISE SEC. 2 (JBOX TO COMBINER BOX)	70	10 Cu.	2.58	242.58	1.08%	
VRISE SEC. 3 (COMBINER BOX TO POI)	10	6 Cu.	0.30	240.30	0.12%	
TOTAL VRISE			4.97	244.97		

PHOTOVOLTAIC AC	DISCONNECT	<b>OUTPUT LABEL</b>	(NEC 690.54)

AC OUTPUT CURRENT	29.0 A AC
NOMINAL AC VOLTAGE	240 V AC

CONDUCTOR SIZE CALCULATIONS						
	MICROINVERTER TO	MAX. SHORT CIRCUIT CURRRENT (ISC) =		14.5	A AC	
	JUNCTION BOX (1) MAX. CURRENT (ISC X1.25) =				A AC	
		CONDUCTOR (TC-ER, COPPER (90°C)) =		12	AWG	
		CONDUCTOR RATING =		30	A	
		AMB. TEMP. AMP. CORRECTION =	35	0.96		
		ADJUSTED AMP. =		28.8	>	18.2
	JUNCTION BOX TO	MAX. SHORT CIRCUIT CURRRENT (ISC) =		14.5	A AC	
	JUNCTION BOX (2)	MAX. CURRENT (ISC X1.25) =		18.2	A AC	
		CONDUCTOR (UF-B, COPPER (60°C)) =	19	10	AWG	
		CONDUCTOR RATING =	19	30	A	
		CONDUIT FILL DERATE =	2	1		
		AMB. TEMP. AMP. CORRECTION =	35	0.96		
		ADJUSTED AMP. =		28.8	>	18.2
	JUNCTION BOX TO	MAX. SHORT CIRCUIT CURRRENT (ISC) =		14.5	A AC	
	COMBINER BOX (3)	MAX. CURRENT (ISC X1.25) =		18.2	A AC	
		CONDUCTOR (UF-B, COPPER (60°C)) =	24	10	AWG	
		CONDUCTOR RATING =	24	30	Α	
		CONDUIT FILL DERATE =	4	0.8		
		AMB. TEMP. AMP. CORRECTION =	35	0.96		
		ADJUSTED AMP. =		23.04	>	18.2
	COMBINER BOX TO	INVERTER RATED AMPS =		29.0	A AC	
	MAIN PV OCPD (15)	MAX. CURRENT (RATED AMPS X1.25) =		36.3	A AC	
	CON	DUCTOR (THWN-2, COPPER (75°C TERM.)) =	38	6	AWG	
		CONDUCTOR RATING =	41	65	Α	
		CONDUIT FILL DERATE =	3	1		

AMB. TEMP. AMP. CORRECTION = 35 0.96

ADJUSTED AMP. =

62.4 > 36.3

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PV INSTALLATION **PROFESSIONAL** 

Scott Gurney #PV-011719-015866

CONTRACTOR: **BRS FIELD OPS** 385-498-6700

28356

Carolina

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SYSTEM

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#### **GROUNDING NOTES**

- 1. A GROUNDING ELECTRODE SYSTEM IN ACCORDANCE WITH [NEC 690.47] AND [NEC 250.50-60] SHALL BE PROVIDED. PER [NEC 690.47], THE GROUNDING ELECTRODE SYSTEM OF AN EXISTING BUILDING MAY BE USED AND BE BONDED AT THE SERVICE ENTRANCE. IF EXISTING SYSTEM IS INACCESSIBLE, OR INADEQUATE, OR IS ONLY METALLIC WATER PIPING, A SUPPLEMENTAL GROUNDING ELECTRODE WILL BE USED AT THE INVERTER LOCATION CONSISTING OF A UL LISTED 8 FT GROUND ROD WITH ACORN CLAMP.
- 2. THE GROUNDING ELECTRODE CONDUCTOR SHALL BE PROTECTED FROM PHYSICAL DAMAGE BETWEEN THE GROUNDING ELECTRODE AND THE PANEL (OR INVERTER) IF SMALLER THAN #6 AWG COPPER WIRE PER [NEC 250.64(B)]. THE GROUNDING ELECTRODE CONDUCTOR WILL BE CONTINUOUS, EXCEPT FOR
- SPLICES OR JOINTS AT BUSBARS WITHIN LISTED EQUIPMENT PER [NEC 250.64(C)].
  3. GROUNDING ELECTRODE CONDUCTORS SHALL BE NO LESS THAN 8 AWG AND NO GREATER THAN 6 AWG COPPER AND BONDED TO THE EXISTING GROUNDING ELECTRODE TO PROVIDE FOR A COMPLETE SYSTEM. 4. PV SYSTEM SHALL BE GROUNDED IN ACCORDANCE TO [NEC 250.21], [NEC TABLE 250.122], AND ALL METAL PARTS OR MODULE FRAMES ACCORDING TO [NEC 690.46]
- 5. MODULE SOURCE CIRCUITS SHALL BE GROUNDED IN ACCORDANCE TO [NEC 690.42].
- 6. THE GROUNDING CONNECTION TO A MODULE SHALL BE ARRANGED SUCH THAT THE REMOVAL OF A
- MODULE DOES NOT INTERRUPT A GROUNDED CONDUCTOR TO ANOTHER MODULE.

  7. EACH MODULE WILL BE GROUNDED USING THE SUPPLIED CONNECTION POINTS IDENTIFIED IN THE MANUFACTURER'S INSTALLATION INSTRUCTIONS
- 8. ENCLOSURES SHALL BE PROPERLY PREPARED WITH REMOVAL OF PAINT/FINISH AS APPROPRIATE WHEN GROUNDING EQUIPMENT WITH TERMINATION GROUNDING LUGS.
- 9. GROUNDING SYSTEM COMPONENTS SHALL BE LISTED FOR THEIR PURPOSE, AND GROUNDING DEVISES EXPOSED TO THE ELEMENTS SHALL BE RATED FOR DIRECT BURIAL
- 10. GROUNDING AND BONDING CONDUCTORS SHALL BE COPPER, SOLID OR STRANDED, AND BARE WHEN **EXPOSED**
- 11. EQUIPMENT GROUNDING CONDUCTORS SHALL BE SIZED ACCORDING TO [NEC 690.45] AND BE A MINIMUM OF 10 AWG WHEN NOT EXPOSED TO DAMAGE (6 AWG SHALL BE USED WHEN EXPOSED TO
- 12. GROUNDING AND BONDING CONDUCTORS, IF INSULATED, SHALL BE COLOR CODED GREEN (OR MARKED GREEN IF 4 AWG OR LARGER).
- 13. ALL CONDUIT BETWEEN THE UTILITY AC DISCONNECT AND THE POINT OF CONNECTION SHALL HAVE GROUNDED BUSHINGS AT BOTH ENDS
- 14. SYSTEM GEC SIZED ACCORDING TO [NEC 690.47], [NEC TABLE 250.66], DC SYSTEM GEC SIZED ACCORDING TO [NEC 250.166], MINIMUM 8 AWG WHEN INSULATED, 6 AWG WHEN EXPOSED TO DAMAGE.
- 15. EXPOSED NON-CURRENT CARRYING METAL PARTS OF MODULE FRAMES. EQUIPMENTS. AND CONDUCTOR ENCLOSURES SHALL BE GROUNDED IN ACCORDANCE WITH [NEC 250.134] OR [NEC 250.136(A)]

#### **WIRING & CONDUIT NOTES**

- . ALL CONDUIT SIZES AND TYPES, SHALL BE LISTED FOR ITS PURPOSE AND APPROVED FOR THE SITE **APPLICATIONS**
- 2. BOLTED CONNECTION REQUIRED IN DC DISCONNECTS ON THE WHITE GROUNDED CONDUCTOR (USE POLARIS BLOCK OR NEUTRAL BAR).
- 3. ANY CONNECTION ABOVE LIVE PARTS MUST BE WATERTIGHT. REDUCING WASHERS DISALLOWED ABOVE LIVE PARTS, MEYERS HUBS RECOMMENDED
- 4. UV RESISTANT CABLE TIES (NOT ZIP TIES) USED FOR PERMANENT WIRE MANAGEMENT OFF THE ROOF SURFACE IN ACCORDANCE WITH [NEC 110.2,110.3(A-B)]
- 5. SOLADECK JUNCTION BOXES MOUNTED FLUSH WITH ROOF SURFACE TO BE USED FOR WIRE MANAGEMENT AND AS FLASHED ROOF PENETRATIONS FOR INTERIOR CONDUIT RUNS.
- 6. ALL PV CABLES AND HOMERUN WIRES BE TYPE USE-2, AND SINGLE-CONDUCTOR CABLE LISTED AND IDENTIFIED AS PV WIRE, TYPE TC-ER, OR EQUIVALENT; ROUTED TO SOURCE CIRCUIT COMBINER BOXES AS
- '. ALL CONDUCTORS AND OCPD SIZES AND TYPES SPECIFIED ACCORDING TO [NEC 690.8] FOR MULTIPLE CONDUCTORS.
- 8. ALL PV DC CONDUCTORS IN CONDUIT EXPOSED TO SUNLIGHT <u>SHALL BE INSTALLED AT LEAST 7/8" ABOVE</u> THE ROOF SURFACE AND DERATED ACCORDING TO [NEC TABLE 310.15 (B)(2)(A)], [NEC TABLE 310.15(B)(3)(A)].& [NEC 310.15(B)(3)(C)].
- 9. EXPOSED ROOF PV DC CONDUCTORS SHALL BE USE-2, 90°C RATED, WET AND UV RESISTANT, AND UL LISTED RATED FOR 600V, UV RATED SPIRAL WRAP SHALL BE USED TO PROTECT WIRE FROM SHARP
- 10. PHASE AND NEUTRAL CONDUCTORS SHALL BE DUAL RATED THHN/THWN-2 INSULATED, 90°C RATED, WET AND UV RESISTANT, RATED FOR 600V
- 11. 4-WIRE DELTA CONNECTED SYSTEMS HAVE THE PHASE WITH THE HIGHER VOLTAGE TO GROUND MARKED ORANGE OR IDENTIFIED BY OTHER EFFECTIVE MEANS.
- 12. ALL SOURCE CIRCUITS SHALL HAVE INDIVIDUAL SOURCE CIRCUIT PROTECTION
- 13. VOLTAGE DROP LIMITED TO 2% FOR DC CIRCUITS AND 3% FOR AC CIRCUITS
- 14. NEGATIVE GROUNDED SYSTEMS DC CONDUCTORS SHALL BE COLOR CODED AS FOLLOWS: DC POSITIVE- RED (OR MARKED RED), DC NEGATIVE- GREY (OR MARKED GREY)
- 15. POSITIVE GROUNDED SYSTEMS DC CONDUCTORS COLOR CODED:
- DC POSITIVE- GREY (OR MARKED GREY), DC NEGATIVE- BLACK (OR MARKED BLACK)
- 16. AC CONDUCTORS >4AWG COLOR CODED OR MARKED: PHASE A OR L1- BLACK, PHASE B OR L2- RED, PHASE C OR L3- BLUE, NEUTRAL- WHITE/GRAY
- \* USE-2 IS NOT INDOOR RATED BUT PV CABLE IS RATED THWN/THWN-2 AND MAY BE USED INSIDE
- USE-2 IS AVAILABLE AS UV WHITE
- 17. RIGID CONDUIT, IF INSTALLED, (AND/OR NIPPLES) MUST HAVE A PULL BUSHING TO PROTECT WIRES.
- 18. IF CONDUIT DETERMINED TO BE RAN THROUGH ATTIC IN FIELD THEN CONDUIT WILL BE EITHER EMT, FMC, OR MC CABLE IF  $\underline{\text{DC}}$  CURRENT COMPLYING WITH [NEC 690.31], [NEC 250.118(10)]. DISCONNECTING MEANS SHALL COMPLY WITH [NEC 690.13] AND [NEC 690.15].
- 19. CONDUIT RAN THROUGH ATTIC WILL BE AT LEAST 18" BELOW ROOF SURFACE COMPLYING WITH INEC 230.6(4)] AND SECURED NO GREATER THAN 6' APART PER [NEC 330.30(B)].

**CUSTOMER INFORMATIO** Sherah Liverpool-Arche

North Emma Linden, I

DRAWING BY

**ENPHASE ENERGY** 

PLOT DATE:

March 9, 2022

PROJECT NUMBER:

479794

SHEET NAME:

**ELEC CALCS** 

REVISION:

PV6

#### STANDARD LABELS

#### **ADDITIONAL LABELS**

#### **↑ WARNING**

ELECTRIC SHOCK HAZARD

TERMINALS ON THE LINE AND LOAD SIDES MAY BE ENERGIZED IN THE OPEN POSITION

PHOTOVOLTAIC SYSTEM

RATED AC OUTPUT CURRENT 29 04 A

NOMINAL OPERATING AC VOLTAGE  $\,\,240\,\,
m V$ 

AC DISCONNECT

#### LABEL 1

LABEL 2

LABEL 3

FOR PV SYSTEM DISCONNECTING MEANS WHERE THE LINE AND LOAD TERMINALS MAY BE ENERGIZED IN THE OPEN POSITION INFC 690 13(B))

SHALL BE MARKED AT AN ACCESSIBLE LOCATION AT

THE DISCONNECTING MEANS AS A POWER SOURCE

NOMINAL OPERATING AC VOLTAGE. [NEC 690.54]

AND WITH THE RATED AC OUTPUT CURRENT AND THE

IF INTERCONNECTING LOAD SIDE, INSTALL THIS LABEL

ANYWHERE THAT IS POWERED BY BOTH THE UTILITY

AND THE SOLAR PV SYSTEM, IE. MAIN SERVICE PANEL

AND SUBPANELS. [NEC 705.12(B)(3)]

## WARNING

MAIN DISTRIBUTION UTILITY DISCONNECT(S)

POWER TO THIS BUILDING IS ALSO SUPPLIED FROM A ROOF MOUNTED SOLAR ARRAY WITH A RAPID SHUTDOWN DISCONNECTING MEANS GROUPED AND LABELED WITHIN LINE OF SITE AND 10 FT OF THIS LOCATION

#### LABEL 8

PERMANENT PLAQUE OR DIRECTORY DENOTING THE LOCATION OF ALL ELECTRIC POWER SOURCE DISCONNECTING MEANS ON OR IN THE PREMISES SHALL BE INSTALLED AT EACH SERVICE EQUIPMENT LOCATION AND AT THE LOCATION(S) OF THE SYSTEM DISCONNECT(S) FOR ALL ELECTRIC POWER PRODUCTION SOURCES CAPABLE OF BEING INTERCONNECTED. [2017 NEC 705.10]

### WARNING

POWER TO THIS BUILDING IS ALSO SUPPLIED FROM MAIN DISTRIBUTION UTILITY DISCONNECT LOCATED

#### LABEL 9

PERMANENT PLAQUE OR DIRECTORY DENOTING THE LOCATION OF ALL ELECTRIC POWER SOURCE DISCONNECTING MEANS ON OR IN THE PREMISES SHALL BE INSTALLED AT EACH SERVICE EQUIPMENT LOCATION AND AT THE LOCATION(S) OF THE SYSTEM DISCONNECT(S) FOR ALL ELECTRIC POWER PRODUCTION SOURCES CAPABLE OF BEING INTERCONNECTED. [2017 NEC 705.10]

### WARNING

POWER TO THIS BUILDING IS ALSO SUPPLIED FROM A ROOF MOUNTED SOLAR ARRAY. SOLAR ARRAY RAPID SHUTDOWN DISCONNECT IS LOCATED OUTSIDE NEXT TO THE UTILITY METER.

#### LABEL 10

PERMANENT PLAQUE OR DIRECTORY TO BE LOCATED AT MAIN SERVICE EQUIPMENT DENOTING THE LOCATION OF THE RAPID SHUTDOWN SYSTEM DISCONNECTING MEANS IF SOLAR ARRAY RAPID SHUTDOWN DISCONNECTING SWITCH IS NOT GROUPED AND WITHIN LINE OF SITE OF MAIN SERVICE DISCONNECTING MEANS. [2017 NEC 705.10 AND 690.56(C)(1)]

### WARNING

**DUAL POWER SUPPLY** 

SOURCES: UTILITY GRID AND PV SOLAR ELECTRIC SYSTEM

#### **⚠ WARNING**

POWER SOURCE OUTPUT CONNECTION

DO NOT RELOCATE THIS OVERCURRENT DEVICE

#### LABEL 4

APPLY TO THE DISTRIBUTION EQUIPMENT ADJACENT TO THE BACK-FED BREAKER FROM THE POWER SOURCE. INEC 705.12(B)(2)1

#### WARNING

PHOTOVOLTAIC SYSTEM **COMBINER PANEL** 

DO NOT ADD LOADS

#### LABEL 11

PERMANENT PLAQUE OR DIRECTORY TO BE LOCATED AT AC COMBINER PANEL. [NEC 110.21(B)]

#### **! WARNING**

THIS EQUIPMENT FED BY MULTIPLE SOURCES. TOTAL RATING OF ALL OVERCURRENT DEVICES, EXCLUDING MAIN SUPPLY OVERCURRENT DEVICE, SHALL NOT EXCEED AMPACITY OF BUSBAR.

#### LABEL 5

APPLY TO THE PV COMBINER BOX [NEC 705.12 (3)(3)]

#### WARNING: PHOTOVOLTAIC **POWER SOURCE**

LABEL 12

**SUBPANEL** 

AT EXPOSED RACEWAYS, CABLE TRAYS, COVERS AND ENCLOSURES OF JUNCTION BOXES, AND OTHER WIRING METHODS. [NEC 690.31(G)(3&4)]

#### SOLAR PV SYSTEM EQUIPPED WITH RAPID SHUTDOWN

RAPID SHUTDOWN **SWITCH FOR** 

SOLAR PV SYSTEM

SWITCH TO THE "OFF" POSITION TO SHUT DOWN PV SYSTEM



#### LABEL 6

BUILDINGS WITH PV SYSTEMS SHALL HAVE A PERMANENT LABEL LOCATED AT EACH SERVICE EQUIPMENT LOCATION TO WHICH THE PV SYSTEMS ARE CONNECTED OR AT AN APPROVED READILY OF RAPID SHUTDOWN INITIATION DEVICES. INEC 690.56(C)1

VISIBLE LOCATION AND SHALL INDICATE THE LOCATION

SIGN LOCATED AT RAPID SHUT DOWN DISCONNECT SWITCH INEC 690.56(C)(2)1

#### AC **PV COMBINER** UTILITY MAIN PV (IF INTERCONNECTION DISCONNECT **METER** SERVICE PANEL IS MADE HERE) **METER** BOX 6 6 2 2 1 1 1 3 2 3 7 8 2 5 IF BREAKER **1**1 4 9 OR PLACARD IS USED 8 ) or (10 OR PLACARD

#### **LABELING NOTES**

1) LABELS CALLED OUT ACCORDING TO ALL COMMON CONFIGURATIONS. ELECTRICIAN TO DETERMINE EXACT REQUIREMENTS IN THE FIELD PER CURRENT NEC AND LOCAL CODES AND MAKE APPROPRIATE ADJUSTMENTS. 2) LABELING REQUIREMENTS BASED ON THE 2017 & 2020 NEC CODE, OSHA STANDARD 19010.145, ANSIZ535.

3) MATERIAL BASED ON THE REQUIREMENTS OF THE AHJ 4) LABELS TO BE OF SUFFICIENT DURABILITY TO WITHSTAND THE ENVIRONMENT INVOLVED AND SHALL NOT BE

HANDWRITTEN [NEC 110.21]

\*ELECTRICAL DIAGRAM SHOWN ABOVE IS FOR LABELING PURPOSES ONLY. NOT AN ACTUAL REPRESENTATION OF EQUIPMENT AND CONNECTIONS TO BE INSTALLED. LABEL LOCATIONS PRESENTED MAY VARY DEPENDING ON TYPE OF INTERCONNECTION METHOD AND LOCATION PRESENTED ON 3 LINE DIAGRAM. 3 LINE DIAGRAM ON PV5 TO REFLECT ACTUAL REPRESENTATION OF PROPOSED SCOPE OF WORK

# **BLUE RAVEN**

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PV INSTALLATION **PROFESSIONAL** 

Scott Gurney #PV-011719-015866

CONTRACTOR: **BRS FIELD OPS** 385-498-6700

Sherah Liverpool-Archer

Linden, North Carolina 28356

SIZE

SYSTEM (

DC 9

DC

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Emma

DRAWING BY:

**CUSTOMER INFORMATION** 

#### ENPHASE ENERGY

PLOT DATE:

March 9, 2022

PROJECT NUMBER:

479794

SHEET NAME:

LABELS

REVISION:

AGE NUMBER: 0

PV7

## **Enphase** IQ 7 and IQ 7+ **Microinverters**

IQ7

The high-powered smart grid-ready

Enphase IQ 7 Micro™ and Enphase IQ 7+ Micro™ dramatically simplify the installation process while achieving the highest system efficiency.

Part of the Enphase IQ System, the IQ 7 and IQ 7+ Microinverters integrate with the Enphase IQ Envoy™, Enphase IQ Battery™, and the Enphase Enlighten™ monitoring and analysis software.

IQ Series Microinverters extend the reliability standards set forth by previous generations and undergo over a million hours of power-on testing, enabling Enphase to provide an industry-leading warranty of up to 25 years.

#### Easy to Install

- · Lightweight and simple
- · Faster installation with improved, lighter two-wire cabling
- Built-in rapid shutdown compliant (NEC 2014 & 2017)

#### Productive and Reliable

- Optimized for high powered 60-cell/120 half-cell and 72cell/144 half-cell\* modules
- More than a million hours of testing
- · Class II double-insulated enclosure
- UL listed

#### Smart Grid Ready

- · Complies with advanced grid support, voltage and frequency ride-through requirements
- · Remotely updates to respond to changing grid requirements
- Configurable for varying grid profiles
- Meets CA Rule 21 (UL 1741-SA)

<sup>\*</sup> The IQ 7+ Micro is required to support 72-cell/144 half-cell modules.



INPUT DATA (DC)

Enphase IQ 7 and IQ 7+ Microinverters

0 : 2::::: (2 0)			•		
Commonly used module pairings <sup>1</sup>	235 W - 350 W +	F		235 W - 440 W -	+
Module compatibility	60-cell/120 half	f-cell PV modules		60-cell/120 half	f-cell and 72-
	only			cell/144 half-ce	II PV modules
Maximum input DC voltage	48 V			60 V	
Peak power tracking voltage	27 V - 37 V			27 V - 45 V	
Operating range	16 V - 48 V			16 V - 60 V	
Min/Max start voltage	22 V / 48 V			22 V / 60 V	
Max DC short circuit current (module lsc)	15 A			15 A	
Overvoltage class DC port	II			II	
DC port backfeed current	0 A			0 A	
PV array configuration		ed array; No addi <sup>.</sup>			
	AC side protect	ion requires max	20 <i>A</i>	per branch circu	uit
OUTPUT DATA (AC)	IQ 7 Microinve	erter		IQ 7+ Microin	verter
Peak output power	250 VA			295 VA	
Maximum continuous output power	240 VA			290 VA	
Nominal (L-L) voltage/range <sup>2</sup>	240 V / 211-264 V	208 V / 183-229 V		240 V / 211-264 V	208 V / 183-229 V
Maximum continuous output current	1.0 A (240 V)	1.15 A (208 V)		1.21 A (240 V)	1.39 A (208 V)
Nominal frequency	60 Hz			60 Hz	
Extended frequency range	47 - 68 Hz			47 - 68 Hz	
AC short circuit fault current over 3 cycles	5.8 Arms			5.8 Arms	
Maximum units per 20 A (L-L) branch circuit <sup>3</sup>	16 (240 VAC)	13 (208 VAC)		13 (240 VAC)	11 (208 VAC)
Overvoltage class AC port	III			III	
AC port backfeed current	18 mA			18 mA	
Power factor setting	1.0			1.0	
Power factor (adjustable)	0.85 leading (	0.85 lagging		0.85 leading (	0.85 lagging
EFFICIENCY	@240 V	@208 V		@240 V	@208 V
Peak efficiency	97.6 %	97.6 %		97.5 %	97.3 %
CEC weighted efficiency	97.0 %	97.0 %		97.0 %	97.0 %

I07PLUS-72-2-US

Ī	Ambient temperature range	-40°C to +65°C
	Relative humidity range	4% to 100% (condensing)
	0	NAO 4 / A

MC4 (or Amphenol H4 UTX with additional Q-DCC-5 adapter) Connector type Dimensions (HxWxD) 212 mm x 175 mm x 30.2 mm (without bracket) 1.08 kg (2.38 lbs) Weight

Cooling Natural convection - No fans Approved for wet locations Yes

Environmental category / UV exposure rating

Pollution degree Class II double-insulated, corrosion resistant polymeric enclosure Enclosure

NEMA Type 6 / outdoor

**FEATURES** 

**MECHANICAL DATA** 

Communication Power Line Communication (PLC) Monitoring Enlighten Manager and MyEnlighten monitoring options. Both options require installation of an Enphase IQ Envoy.

Disconnecting means The AC and DC connectors have been evaluated and approved by UL for use as the load-break disconnect required by NEC 690.

Compliance CA Rule 21 (UL 1741-SA)

UL 62109-1, UL1741/IEEÉ1547, FCC Part 15 Class B, ICES-0003 Class B, CAN/CSA-C22.2 NO. 107.1-01

This product is UL Listed as PV Rapid Shut Down Equipment and conforms with NEC 2014, NEC 2017, and NEC 2020 section 690.12 and C22.1-2015 Rule 64-218 Rapid Shutdown of PV Systems, for AC and DC conductors, when installed according manufacturer's instructions.

- 1. No enforced DC/AC ratio. See the compatibility calculator at <a href="https://enphase.com/en-us/support/module-compatibility">https://enphase.com/en-us/support/module-compatibility</a>.

**ENPHASE**. To learn more about Enphase offerings, visit **enphase.com** ENPHASE



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CONTRACTOR: **BRS FIELD OPS** 385.498.6700

Nominal voltage range can be extended beyond nominal if required by the utility.
 Limits may vary. Refer to local requirements to define the number of microinverters per branch in your area.

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## **Enphase IQ Combiner 3**

(X-IQ-AM1-240-3)



#### Smart

busbar assembly.

 Includes IQ Envoy for communication and control

The **Enphase IQ Combiner 3**™ with Enphase

streamlines PV and storage installations by

providing a consistent, pre-wired solution for

residential applications. It offers up to four

2-pole input circuits and Eaton BR series

IQ Envoy™ consolidates interconnection

equipment into a single enclosure and

- · Flexible networking supports Wi-Fi, Ethernet, or cellular
- Optional AC receptacle available for PLC
- Provides production metering and optional consumption monitoring

#### Simple

- · Reduced size from previous combiner
- · Centered mounting brackets support single stud mounting
- · Supports back and side conduit entry
- Up to four 2-pole branch circuits for 240 VAC plug-in breakers (not included)
- 80 A total PV or storage branch circuits

#### Reliable

- Durable NRTL-certified NEMA type 3R enclosure
- Five-year limited warranty
- UL listed

#### **Enphase IQ Combiner 3**

#### MODEL NUMBER

Circuit Breakers

IQ Combiner 3 IQ Combiner 3 with Enphase IQ Envoy™ printed circuit board for integrated revenue grade PV X-IQ-AM1-240-3 production metering (ANSI C12.20 +/- 0.5%) and optional\* consumption monitoring (+/- 2.5%).

#### ACCESSORIES and REPLACEMENT PARTS (not included, order separately)

Enphase Mobile Connect™ CELLMODEM-03 (4G/12-year data plan) CELLMODEM-01 (3G/5-year data plan) Consumption Monitorina\* CT CT-200-SPLIT \* Consumption monitoring is required for Enphase Storage Systems

Plug and play industrial grade cellular modem with data plan for systems up to 60 microinverters. (Available in the US, Canada, Mexico, Puerto Rico, and the US Virgin Islands, CELLMODEM-M1 (4G based LTE-M/5-year data plan) where there is adequate cellular service in the installation area.)

Split core current transformers enable whole home consumption metering (+/- 2.5%).

Supports Eaton BR210, BR215, BR220, BR230, BR240, BR250, and BR260 circuit breakers.

Wireless USB adapter Installed at the IQ Envoy. For communications with Enphase Encharge™ storage and Enphase COMMS-KIT-01 Enpower™ smart switch. Includes USB cable for connection to IQ Envoy or Enphase IQ Combiner™ and allows redundant wireless communication with Encharge and Enpower

BRK-10A-2-240 Circuit breaker, 2 pole, 10A, Eaton BR210 BRK-15A-2-240 Circuit breaker, 2 pole, 15A, Eaton BR215 BRK-20A-2P-240 Circuit breaker, 2 pole, 20A, Eaton BR220

EPLC-01 Power line carrier (communication bridge pair), quantity - one pair XA-PLUG-120-3 Accessory receptacle for Power Line Carrier in IQ Combiner 3 (required for EPLC-01)

XA-ENV-PCBA-3 Replacement IQ Envoy printed circuit board (PCB) for Combiner 3

#### **ELECTRICAL SPECIFICATIONS**

Rating	Continuous duty
System voltage	120/240 VAC, 60 Hz
Eaton BR series busbar rating	125 A
Max. continuous current rating (output to grid)	65 A
Max. fuse/circuit rating (output)	90 A
Branch circuits (solar and/or storage)	Up to four 2-pole Eaton BR series Distributed Generation (DG) breakers only (not included)
Max. continuous current rating (input from PV)	64 A
Max. total branch circuit breaker rating (input)	80A of distributed generation / 90A with IQ Envoy breaker included
Production Metering CT	200 A solid core pre-installed and wired to IQ Envoy

#### MECHANICAL DATA

	MEGHANIOAL DATA	
	Dimensions (WxHxD)	49.5 x 37.5 x 16.8 cm (19.5" x 14.75" x 6.63"). Height is 21.06" (53.5 cm with mounting brackets
	Weight	7.5 kg (16.5 lbs)
	Ambient temperature range	-40° C to +46° C (-40° to 115° F)
	Cooling	Natural convection, plus heat shield
	Enclosure environmental rating	Outdoor, NRTL-certified, NEMA type 3R, polycarbonate construction
	Wire sizes	<ul> <li>20 A to 50 A breaker inputs: 14 to 4 AWG copper conductors</li> <li>60 A breaker branch input: 4 to 1/0 AWG copper conductors</li> <li>Main lug combined output: 10 to 2/0 AWG copper conductors</li> <li>Neutral and ground: 14 to 1/0 copper conductors</li> <li>Always follow local code requirements for conductor sizing.</li> </ul>
	Altitude	To 2000 meters (6,560 feet)

#### INTERNET CONNECTION OPTIONS

Integrated Wi-Fi	802.11b/g/n
Ethernet	Optional, 802.3, Cat5E (or Cat 6) UTP Ethernet cable (not included)
Cellular	Optional, CELLMODEM-01 (3G) or CELLMODEM-03 (4G) or CELLMODEM-M1 (4G based LTE-M) (not included)
COMPLIANCE	

#### COMPLIANCE

Compliance, Combiner	UL 1741, CAN/CSA C22.2 No. 107.1, 47 CFR, Part 15, Class B, ICES 003 Production metering: ANSI C12.20 accuracy class 0.5 (PV production)
Compliance, IQ Envoy	UL 60601-1/CANCSA 22.2 No. 61010-1

To learn more about Enphase offerings, visit enphase.com

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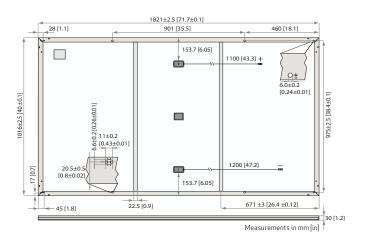




### REC ALPHA PURE SERIES PRODUCT SPECIFICATIONS



**GENERAL DATA** 132 half-cut REC heterojunction cells with lead-free, gapless technology, 6 strings of 22 cells in series Cell type: 3.2 mm solar glass with anti-reflective surface treatment in accordance with EN 12150 Backsheet Highly resistant polymer (black) Frame: Anodized aluminum (black) 3-part, 3 bypass diodes, lead-free Junction box Stäubli MC4 PV-KBT4/KST4 (4 mm²) in accordance with IEC 62852, IP68 only when connected Connectors: 4 mm<sup>2</sup> solar cable, 1.1 m + 1.2 m Cable: 1821 x 1016 x 30 mm (1.85 m<sup>2</sup>) Weight: 20.5 kg Origin: Made in Singapore



	ELECTRICAL DATA	Product Code*: RECxxxAA Pure							
	Power Output - P <sub>MAX</sub> (Wp)	385	390	395	400	405	410		
	Watt Class Sorting - (W)	0/+5	0/+5	0/+5	0/+5	0/+5	0/+5		
	Nominal Power Voltage - $V_{MPP}(V)$	41.2	41.5	41.8	42.1	42.4	42.7		
ر	Nominal Power Current - I <sub>MPP</sub> (A)	9.35	9.40	9.45	9.51	9.56	9.61		
้า	Open Circuit Voltage - $V_{OC}(V)$	48.5	48.6	48.7	48.8	48.9	49.0		
	Short Circuit Current - $I_{SC}(A)$	10.18	10.19	10.20	10.25	10.30	10.35		
	Power Density (W/m²)	208	211	214	216	219	222		
	Panel Efficiency (%)	20.8	21.1	21.4	21.6	21.9	22.2		
	Power Output - P <sub>MAX</sub> (Wp)	293	297	301	305	309	312		
	Nominal Power Voltage - $V_{MPP}(V)$	38.8	39.1	39.4	39.7	40.0	40.2		
	Nominal Power Current - I <sub>MPP</sub> (A)	7.55	7.59	7.63	7.68	7.72	7.76		
2	Open Circuit Voltage - V <sub>OC</sub> (V)	45.7	45.8	45.9	46.0	46.1	46.2		
	$ShortCircuitCurrent-I_{SC}(A)$	8.16	8.20	8.24	8.28	8.32	8.36		
	Values at standard test conditions (STC: air m tolerance of $P_{\text{MAV}}$ , $V_{\text{Oc}}$ & $I_{\text{Sc}}$ ±3% within one wa temperature 20°C, windspeed 1 m/s). * Where	tt class. Nomina	ıl module operat	ing temperature (	NMOT: air m				

RICAL DATA	Product Code*: RECxxxAA Pure CERTIFICATIONS						
Output - P <sub>MAY</sub> (Wp)	385	390	395	400	405	410	IEC 61215:2016, IEC 61730:2016, UL 61730
ass Sorting - (W)	0/+5	0/+5	0/+5	0/+5	0/+5	0/+5	IEC 62804 PID
I Power Voltage - V <sub>MDD</sub> (V)	41.2	41.5	41.8	42.1	42.4	42.7	IEC 61701 Salt Mist
l Power Current - I <sub>MPP</sub> (A)	9.35	9.40	9.45	9.51	9.56	9.61	IEC 62716 Ammonia Resistance ISO 11925-2 Ignitability (Class E)
par · ·					48.9		IEC 62782 Dynamic Mechanical Load
rcuit Voltage - V <sub>oc</sub> (V)	48.5	48.6	48.7	48.8		49.0	IEC 61215-2:2016 Hailstone (35mm)
ircuit Current - I <sub>sc</sub> (A)	10.18	10.19	10.20	10.25	10.30	10.35	IEC 62321 Lead-free acc. to RoHS EU 8
Density (W/m²)	208	211	214	216	219	222	ISO 14001, ISO 9001, IEC 45001, IEC 62941
fficiency (%)	20.8	21.1	21.4	21.6	21.9	22.2	take 🗽
Output - P <sub>MAX</sub> (Wp)	293	297	301	305	309	312	Take we take way Intertek  Intertek  Take We take way Intertek  Lead-Free  Take We take way Intertek
l Power Voltage - V <sub>MPP</sub> (V)	38.8	39.1	39.4	39.7	40.0	40.2	TEMPERATURE RATINGS*
l Power Current - I <sub>MPP</sub> (A)	7.55	7.59	7.63	7.68	7.72	7.76	Nominal Module Operating Temperature: 44°

See warranty documents for details. Conditions apply

MAXIMUM RATINGS		WARRANTY			
Operational temperature:	-40+85°C		Standard	REC	ProTrust
Maximum system voltage:	1000 V	Installed by an REC Certified Solar Professional	No	Yes	Yes
Maximum test load (front):	+7000 Pa (713 kg/m²)°	System Size	All	≤25 kW	25-500 kV
Maximum test load (rear):	-4000 Pa (407 kg/m²)°	Product Warranty (yrs)	20	25	25
Max series fuse rating:	25 A	Power Warranty (yrs)	25	25	25
Max reverse current:	25 A	Labor Warranty (yrs)	0	25	10
"See installation manual for mounting inst Design load = Test load / 1.5 (safe		Power in Year 1	98%	98%	98%
Design	load = Test load / 1.5 (safety factor)	Annual Degradation	0.25%	0.25%	0.25%
		Power in Year 25	92%	92%	92%

	DELIVERY INFORMATION	
I	Panels per pallet:	33
	Panels per 40 ft GP/high cube container:	792 (24 pallets
	Panels per 13.6 m truck:	924 (28 pallets
	Panels per 53 ft truck:	891 (27 pallets
	LOW LIGHT BEHAVIOUR	

\*The temperature coefficients stated are linear values

Temperature coefficient of  $P_{MAX}$ 

Temperature coefficient of  $V_{oc}$ :

Temperature coefficient of I<sub>cc</sub>:

OW LIGHT BEHAVIOUR										
pical low irradiance performance of module at STC:										
8	105									
Rel. Efficiency (%)	95	لر		-						
īcier				ļ						
#	15			ļ						
Rel										
	100	200			100 60		800	900	1000	
			Iri	adia	nce (	W/m <sup>2</sup>	')			

Founded in 1996, REC Group is an international pioneering solar energy company dedicated to empowering consumers with clean, affordable solar power. As Solar's Most Trusted, REC is committed to high quality, innovation, and a low carbon footprint in the solar materials and solar panels it manufactures. Headquartered in Norway with operational headquarters in Singapore, REC also has regional hubs in North America, Europe, and Asia-Pacific.



-0.26 %/°C

-0.24 %/°C

0.04 %/°C

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PV INSTALLATION **PROFESSIONAL** 

Scott Gurney #PV-011719-015866

CONTRACTOR: **BRS FIELD OPS** 385-498-6700

SHEET NAME:

SPEC SHEET

REVISION:

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PAGE NUMBER:

#### Product data sheet Characteristics

#### DU222RB

Safety switch, general duty, non fusible, 60A, 2 poles, 10 hp, 240 VAC, NEMA 3R, bolt-on provision

Product availability: Stock - Normally stocked in distribution facility

SQUARE 1



Price\*: 353.00 USD



RЛ	ain	
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TYTOTT		
Product	Single Throw Safety Switch	and the second s
Current Rating	60 A	
Certifications	UL listed file E2875	
Enclosure Rating	NEMA 3R	
Disconnect Type	Non-fusible disconnect switch	
Factory Installed Neutral	None	
Mounting Type	Surface	ie ie
Number of Poles	2	ia ia
Electrical Connection	Lugs	of b
Duty Rating	General duty	es
Voltage Rating	240 V AC	2
Wire Size	AWG 12AWG 3 aluminium AWG 14AWG 3 copper	is.

#### Complementary

o o i i i pi o i i i o i i i o i i o i i o i i o i i o i i o i i o i i o i i o i i o i i o i i o i i o i i o i		
Short-circuit withstand	200 kA	
Maximum Horse Power Rating	10 hp 240 V AC 60 Hz 1 phase NEC 430.52	
Tightening torque	35 lbf.in (3.95 N.m) 0.000.01 in <sup>2</sup> (2.085.26 mm <sup>2</sup> ) AWG 14AWG 10) 35 lbf.in (3.95 N.m) AWG 14AWG 10) 45 lbf.in (5.08 N.m) 0.01 in <sup>2</sup> (8.37 mm <sup>2</sup> ) AWG 8) 45 lbf.in (5.08 N.m) 0.020.03 in <sup>2</sup> (12.321.12 mm <sup>2</sup> ) AWG 6AWG 4) 50 lbf.in (5.65 N.m) 0.04 in <sup>2</sup> (26.67 mm <sup>2</sup> ) AWG 3)	
Height	9.63 in (244.60 mm)	
Width	7.75 in (196.85 mm)	
Depth	3.75 in (95.25 mm)	

<sup>\*</sup> Price is "List Price" and may be subject to a trade discount – check with your local distributor or retailer for actual price.

Apr 21, 2021

Life is On Schneider

Ordering and shipping details

Category	00106 - D & DU SW,NEMA3R, 30-200A
Discount Schedule	DE1A
GTIN	00785901491491
Nbr. of units in pkg.	1
Package weight(Lbs)	4.65 lb(US) (2.11 kg)
Returnability	Yes
Country of origin	MX

#### Packing Units

Unit Type of Package 1	PCE
Package 1 Height	5.30 in (13.462 cm)
Package 1 width	7.20 in (18.288 cm)
Package 1 Length	10.00 in (25.4 cm)
Unit Type of Package 2	CAR
Number of Units in Package 2	5
Package 2 Weight	24.60 lb(US) (11.158 kg)
Package 2 Height	10.70 in (27.178 cm)
Package 2 width	10.20 in (25.908 cm)
Package 2 Length	23.50 in (59.69 cm)
Unit Type of Package 3	PAL
Number of Units in Package 3	120
Package 3 Weight	610.00 lb(US) (276.691 kg)
Package 3 Height	36.50 in (92.71 cm)
Package 3 width	40.00 in (101.6 cm)
Package 3 Length	48.00 in (121.92 cm)

#### Offer Sustainability

Sustainable offer status	Green Premium product	
California proposition 65	WARNING: This product can expose you to chemicals including: Lead and lead compounds, which is known to the State of California to cause cancer and birth defects or other reproductive harm. For more information go to www.P65Warnings.ca.gov	
REACh Regulation	REACh Declaration	
REACh free of SVHC	Yes	
EU RoHS Directive	Compliant EU RoHS Declaration	
Toxic heavy metal free	Yes	
Mercury free	Yes	
RoHS exemption information	Yes	
China RoHS Regulation	China RoHS declaration Pro-active China RoHS declaration (out of China RoHS legal scope)	
Environmental Disclosure	Product Environmental Profile	
PVC free	Yes	

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#### Contractual warranty

Warranty 18 months



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PROFESSIONAL
Scott Gurney
#PV-011719-015866

CONTRACTOR: BRS FIELD OPS

385-498-6700

SHEET NAME:

SPEC SHEETS


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# SYSTEM BONDING & GROUNDING | SINSTALLATION GUIDE | PAGE



Star Washer is Single Use Only


TERMINAL TORQUE, Install Conductor and torque to the following:

4-6 AWG: 35in-lbs 8 AWG: 25 in-lbs 10-14 AWG: 20 in-lbs
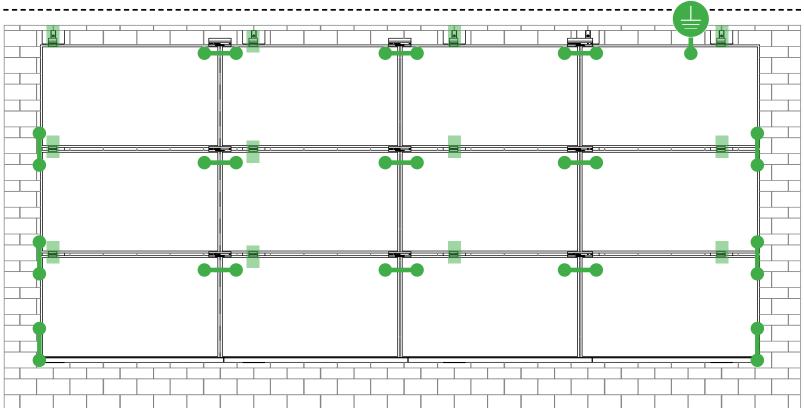
#### **LUG DETAIL & TORQUE INFO**

### Ilsco Lay-In Lug (GBL-4DBT)

- 10-32 mounting hardware
- Torque = 5 ft-lb
- AWG 4-14 Solid or Stranded

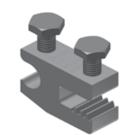

TERMINAL TORQUE, Install Conductor and torque to the following: 4-14 AWG: 35in-lbs

#### **LUG DETAIL & TORQUE INFO**

#### Ilsco Flange Lug(SGB-4)

- 1/4" mounting hardware
- Torque = 75 in-lb
- AWG 4-14 Solid or Stranded

## WEEBLUG Single Use Only



TERMINAL TORQUE, Install Conductor and torque to the following: 6-14 AWG: 7ft-lbs


#### **LUG DETAIL & TORQUE INFO**

#### Wiley WEEBLug (6.7)

- 1/4" mounting hardware
- Torque = 10 ft-lb
- AWG 6-14 Solid or Stranded


#### NOTE: ISOLATE COPPER FROM ALUMINUM CONTACT TO PREVENT CORROSION


System bonding is accomplished through modules. System grounding accomplished by attaching a ground lug to any module at a location on the module specified by the module manufacturer.

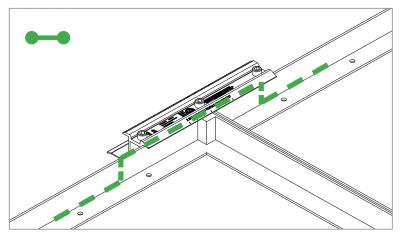

#### E-W BONDING PATH:


E-W module to module bonding is accomplished with 2 pre-installed bonding pins which engage on the secure side of the MicrorailTM and splice.

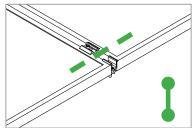

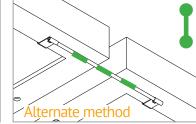

#### N-S BONDING PATH:

N-S module to module bonding is accomplished with bonding clamp with 2 integral bonding pins. (refer also to alternate method)

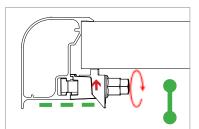



#### TRIMRAIL BONDING PATH:

Trimrail to module bonding is accomplished with bonding clamp with integral bonding pin and bonding T-bolt. (refer also to alternate method)



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#### SYSTEM LEVEL FIRE CLASSIFICATION

The system fire class rating requires installation in the manner specified in the SUNFRAME MICRORAIL (SFM) Installation Guide. SFM has been classified to the system level fire portion of UL 1703. This UL 1703 classification has been incorporated into the UL 2703 product certification. SFM has achieved Class A, B & C system level performance for low slope & steep sloped roofs when used in conjunction with type 1 and type 2 modules. Class A, B & C system level fire

performance is inherent in the SFM design, and no additional mitigation measures are required. The fire classification rating is valid for any roof pitch. There is no required minimum or maximum height limitation above the roof deck to maintain the Class A, B & C fire rating for SFM. SUNFRAME MICRORAIL™ components shall be mounted over a fire resistant roof covering rated for the application.

Module Type	Roof Slope	System Level Fire Rating	Microrail Direction	Module Orientation	Mitigation Required
Type 1 and Type 2	Steep Slope & Low Slope	Class A, B & C	East-West	Landscape OR Portrait	None Required

#### **UL2703 TEST MODULES**

See pages V and W for a list of modules that were electrically and mechanically tested or qualified with the SUNFRAME MICRORAIL (SFM) components outlined within this Installation Guide.

- Maximum Area of Module = 27.76 sqft
- UL2703 Design Load Ratings:
  - a) Downward Pressure - 113 PSF / 5400 Pa
  - b) Upward Pressure - 50 PSF / 2400 Pa
  - Down-Slope Load 21.6 PSF / 1034 Pa c)
- Tested Loads:
  - Downward Pressure 170 PSF / 8000 Pa a)
  - b) Upward Pressure - 75 PSF / 3500 Pa
  - Down-Slope Load 32.4 PSF / 1550 Pa c)
- Maximum Span = 6ft
- Use with a maximum over current protection device OCPD of 30A
- System conforms to UL Std 2703, certified to LTR AE-001-2012
- Rated for a design load of 2400 Pa / 5400 Pa with 24 inch span
- PV modules may have a reduced load rating, independent of the SFM load rating. Please consult the PV module manufacturer's installation guide for more information
- Down-Slope design load rating of 30 PSF/ 1400 Pa for module areas of 22.3 sq ft or less



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# TESTED / CERTIFIED MODULE LIST | V INSTALLATION GUIDE | PAGE

Manufacture	Module Model / Series
Aleo	P-Series
Astronergy	CHSM6612P, CHSM6612P/HV, CHSM6612M, CHSM6612M/HV, CHSM6610M (BL)(BF)/(HF), CHSM72M-HC
Auxin	AXN6M610T, AXN6P610T, AXN6M612T & AXN6P612T
Axitec	AXIblackpremium 60 (35mm), AXIpower 60 (35mm), AXIpower 72 (40mm), AXIpremium 60 (35mm), AXIpremium 72 (40mm).
Aptos	DNA-120-(BF/MF)26 DNA-144-(BF/MF)26
Boviet	BVM6610, BVM6612
BYD	P6K & MHK-36 Series
Canadian Solar	CS1(H/K/U/Y)-MS CS3(K/L/U), CS3K-MB-AG, CS3K-(MS/P) CS3N-MS, CS3U-MB-AG, CS3U-(MS/P), CS3W CS5A-M, CS6(K/U), CS6K-(M/P), CS6K-MS CS6P-(M/P), CS6U-(M/P), CS6V-M, CS6X-P
Centrosolar America	C-Series & E-Series
CertainTeed	CT2xxMxx-01, CT2xxPxx-01, CTxxxMxx-02, CTxxxM-03, CTxxxMxx-04, CTxxxHC11-04
Dehui	DH-60M

Manufacture	Module Model / Series
Eco Solargy	Orion 1000 & Apollo 1000
ET Solar	ET-M672BHxxxTW
FreeVolt	Mono PERC
GCL	GCL-P6 & GCL-M6 Series
Hansol	TD-AN3, TD-AN4, UB-AN1, UD-AN1
Heliene	36M, 60M, 60P, 72M & 72P Series
HT Solar	HT60-156(M) (NDV) (-F), HT 72-156(M/P)
Hyundai	KG, MG, TG, RI, RG, TI, MI, HI & KI Series HiA-SxxxHG
ITEK	iT, iT-HE & iT-SE Series
Japan Solar	JPS-60 & JPS-72 Series
JA Solar	JAP6 60-xxx, JAM6-60-xxx/SI, JAM6(K)-60/xxx, JAP6(k)-72-xxx/4BB, JAP72SYY-xxx/ZZ, JAP6(k)-60-xxx/4BB, JAP60SYY-xxx/ZZ, JAM6(k)-72-xxx/ZZ, JAM72SYY-xxx/ZZ, JAM6(k)-60-xxx/ZZ, JAM60SYY-xxx/ZZ. i. YY: 01, 02, 03, 09, 10 ii. ZZ: SC, PR, BP, HiT, IB, MW, MR
Jinko	JKM & JKMS Series Eagle JKMxxxM JKMxxxM-72HL-V
Kyocera	KU Series

Manufacture	Module Model / Series
	LGxxxN2T-A4
	LGxxx(A1C/E1C/E1K/N1C/N1K/N2T/N2W/
	Q1C/Q1K/S1C/S2W)-A5
	LGxxxN2T-B5
	LGxxxN1K-B6
	LGxxx(A1C/M1C/M1K/N1C/N1K/Q1C/Q1K/
LG Electronics	QAC/QAK)-A6
	LGxxx(N1C/N1K/N2T/N2W)-E6
	LGxxx(N1C/N1K/N2W/S1C/S2W)-G4
	LGxxxN2T-J5
	LGxxx(N1K/N1W/N2T/N2W)-L5
	LGxxx(N1C/Q1C/Q1K)-N5
	LGxxx (N1C/N1K/N2W/Q1C/Q1K)-V5
	LR4-60(HIB/HIH/HPB/HPH)-xxxM
	LR4-72(HIH/HPH)-xxxM
	LR6-60(BP/HBD/HIBD)-xxxM (30mm)
	LR6-60(BK)(PE)(HPB)(HPH)-xxxM (35mm)
LONGi	LR6-60(BK)(PE)(PB)(PH)-xxxM (40mm)
	LR6-72(BP)(HBD)(HIBD)-xxxM (30mm)
	LR6-72(HV)(BK)(PE)(PH)(PB)(HPH)-xxxM
	(35mm)
	LR6-72(BK)(HV)(PE)(PB)(PH)-xxxM (40mm)
Mission Solar Energy	MSE Series
Mitsubishi	MJE & MLE Series
Neo Solar Power Co.	D6M & D6P Series

- Unless otherwise noted, all modules listed above include all wattages and specific models within that series. Variable wattages are represented as "xxx"
- Items in parenthesis are those that may or may not be present in a compatible module's model ID
- Slashes "/" between one or more items indicates that either of those items may be the one that is present in a module's model ID
- Please see the SFM UL2703Construction Data Report at Unirac.com to ensure the exact solar module selected is approved for use with SFM
- SFM Infinity is not compatible with module frame height of less than 30mm and more than 40mm. See Module Mounting section, page L for further information



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# TESTED / CERTIFIED MODULE LIST | W INSTALLATION GUIDE | PAGE

Manufacture	Module Model / Series
	VBHNxxxSA15 & SA16,
	VBHNxxxSA17 & SA18,
Panasonic	VBHNxxxSA17(E/G) & SA18E,
Panasonic	VBHNxxxKA01 & KA03 & KA04,
	VBHNxxxZA01, VBHNxxxZA02,
	VBHNxxxZA03, VBHNxxxZA04
Peimar	SGxxxM (FB/BF)
Phono Solar	PS-60, PS-72
Prism Solar	P72 Series
	Plus, Pro, Peak, G3, G4, G5, G6(+), G7, G8(+)
	Pro, Peak L-G2, L-G4, L-G5, L-G6, L-G7
	Q.PEAK DUO BLK-G6+
	Q.PEAK DUO BLK-G6+/TS
Q.Cells	Q.PEAK DUO (BLK)-G8(+)
0.0013	Q.PEAK DUO L-G8.3/BFF
	Q.PEAK DUO (BLK) ML-G9(+)
	Q.PEAK DUO XL-G9/G9.2/G9.3
	Q.PEAK DUO (BLK) ML-G10(+)
	Q.PEAK DUO XL-G(10/10.2/10.3/10.c/10.d)
	Alpha (72) (Black) (Pure)
	N-Peak (Black)
RFC	N-Peak 2 (Black)
NEC	PEAK Energy Series
	PEAK Energy BLK2 Series
	PEAK Energy 72 Series

Manufacture	Module Model / Series
	TwinPeak Series
	TwinPeak 2 Series
REC (cont.)	TwinPeak 2 BLK2 Series
KLC (COIII.)	TwinPeak 2S(M)72(XV)
	TwinPeak 3 Series (38mm)
	TP4 (Black)
Renesola	Vitrus2 Series & 156 Series
Risen	RSM72-6 (MDG) (M), RSM60-6
S-Energy	SN72 & SN60 Series (40mm)
Seraphim	SEG-6 & SRP-6 Series
Sharp	NU-SA & NU-SC Series
CHEL	SLA, SLG, BC Series & SILxxx(BL/NL/NT/HL/
Silfab	ML/BK/NX/NU/HC)
	PowerXT-xxxR-(AC/PD/BD)
Solaria	PowerXT-xxxC-PD
	PowerXT-xxxR-PM (AC)
SolarWorld	Sunmodule Protect,
Solarworld	Sunmodule Plus
Sonali	SS 230 - 265
Suntech	STP
Suniva	MV Series & Optimus Series
Sun Edison/Flextronics	F-Series, R-Series & FLEX FXS Series
SunPower	X-Series, E-Series & P-Series
Talaana	TP572, TP596, TP654, TP660,
Talesun	TP672, Hipor M, Smart

Manufacture	Module Model / Series
Taala	SC, SC B, SC B1, SC B2
Tesla	TxxxS
	PA05, PD05, DD05, DE06, DD06, PE06,
Trina	PD14, PE14, DD14, DE09.05, DE14, DE15,
	PE15H
	UP-MxxxP(-B),
Upsolar	UP-MxxxM(-B)
	D7MxxxH7A, D7(M/K)xxxH8A
URE	FAKxxx(C8G/E8G), FAMxxxE7G-BB
	FAMxxxE8G(-BB)
	Eldora,
Vikram	Solivo,
	Somera
Waaree	AC & Adiya Series
Winaico	WST & WSP Series
Yingli	YGE & YLM Series
ZN Shine	ZXM6-72

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## intertek

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for L. Matthew Snyder, Certification Manager

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1411 Broadway Blvd NE Address: Address: Albuquerque, NM 87102

USA Country: Country:

Party Authorized To Apply Mark: Same as Manufacturer

**Report Issuing Office:** Intertek Testing Services NA, Inc., Lake Forest, CA wans

Control Number: *5003705* Authorized by: for L. Matthew Snyder, Certification Manager



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Mounting Systems, Mounting Devices, Clamping/Retention Devices, and Ground Lugs for Use with Flat-Plate Photovoltaic Modules and Panels [UL 2703:2015 Ed.1+R:29May2019] Standard(s): PV Module and Panel Racking Mounting System and Accessories [CSA TIL No. A-40:2020] Photovoltaic Mounting System, Sun Frame Microrail Installation Guide, PUB2021NOV29 Product: Brand Name: Unirac Models: Unirac SFM

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Standard(s):	Mounting Systems, Mounting Devices, Clamping/Retention Devices, and Ground Lugs for Use with Flat- Plate Photovoltaic Modules and Panels [UL 2703:2015 Ed.1+R:29May2019]
	PV Module and Panel Racking Mounting System and Accessories [CSA TIL No. A-40:2020]
Product:	Photovoltaic Mounting System, Sun Frame Microrail Installation Guide, PUB2021NOV29
Brand Name:	Unirac
Models:	Unirac SFM

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Scott Gurney #PV-011719-015866

CONTRACTOR: **BRS FIELD OPS** 385-498-6700

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PLOT DATE:

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SHEET NAME:

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REVISION:

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AGE NUMBER:

ATM Issued: 7-Jan-2022

ED 16.3.15 (16-Oct-2021) Mandatory



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for L! Matthew Snyder, Certification Manager

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1411 Broadway Blvd NE Address:


Address: Albuquerque, NM 87102

USA Country: Country:

Party Authorized To Apply Mark: Same as Manufacturer

**Report Issuing Office:** Intertek Testing Services NA, Inc., Lake Forest, CA

want. Control Number: 5019851 Authorized by:

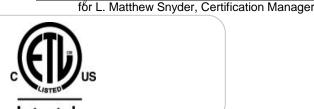

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Mounting Systems, Mounting Devices, Clamping/Retention Devices, and Ground Lugs for Use with Flat-Plate Photovoltaic Modules and Panels [UL 2703:2015 Ed.1+R:29May2019] Standard(s): PV Module and Panel Racking Mounting System and Accessories [CSA TIL No. A-40:2020] Photovoltaic Mounting System, Sun Frame Microrail Installation Guide, PUB2021NOV29 Product: Brand Name: Unirac Models: Unirac SFM

Page 3 of 4

This authorizes the application of the Certification Mark(s) shown below to the models described in the Product(s) Covered section when made in accordance with the conditions set forth in the Certification Agreement and Listing Report. This authorization also applies to multiple listee model(s) identified on the correlation page of the Listing Report.

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Applicant: Unirac, Inc Manufacturer:

1411 Broadway Blvd NE Address: Address: Albuquerque, NM 87102

USA Country: Country:

Party Authorized To Apply Mark: Same as Manufacturer

Report Issuing Office: Intertek Testing Services NA, Inc., Lake Forest, CA

Movary **Control Number:** *5021866* Authorized by:



This document supersedes all previous Authorizations to Mark for the noted Report Number.

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Standard(s):	Mounting Systems, Mounting Devices, Clamping/Retention Devices, and Ground Lugs for Use with Flat- Plate Photovoltaic Modules and Panels [UL 2703:2015 Ed.1+R:29May2019]	
	PV Module and Panel Racking Mounting System and Accessories [CSA TIL No. A-40:2020]	
Product:	Photovoltaic Mounting System, Sun Frame Microrail Installation Guide, PUB2021NOV29	
Brand Name:	Unirac	
Models:	Unirac SFM	

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PV INSTALLATION **PROFESSIONAL** 

Scott Gurney #PV-011719-015866

CONTRACTOR: **BRS FIELD OPS** 385-498-6700

DRAWING BY

PLOT DATE:

PROJECT NUMBER:

SHEET NAME:

SPEC SHEET

REVISION:

AGE NUMBER: SS

ATM Issued: 7-Jan-2022

ED 16.3.15 (16-Oct-2021) Mandatory

ATM for Report 102393982LAX-002



## Listing Constructional Data Report (CDR)

otal Quality. Assure		List	ing Constru	ictional Data Report (CDF
1.0 Reference a	nd Address			
	102393982LAX-002	Original	11-Apr-2016	Revised: 2-Jan-2022
Standard(s)	Mounting Systems, Mo with Flat-Plate Photovo	unting Devices, oltaic Modules ar	Clamping/Retention Id Panels [UL 270	on Devices, and Ground Lugs for Use 3:2015 Ed.1+R:29May2019] cessories [CSA TIL No. A-40:2020]
Applicant	Unirac, Inc		Manufacturer 2	
Address	1411 Broadway Blvd N Albuquerque, NM 8710		Address	
Country	USA		Country	
Contact	Klaus Nicolaedis Todd Ganshaw		Contact	
Phone	505-462-2190 505-843-1418		Phone	
FAX	NA		FAX	
Email	klaus.nicolaedis@unira toddg@unirac.com	ac.com	Email	
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Manufacturer 5

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#### **Listing Constructional Data Report (CDR)**

1.0 Reference and Address				
Report Number	102393982LAX-002	Original 11-Apr-	2016	Revised: 2-Jan-2022
Email				

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Scott Gurney #PV-011719-015866

CONTRACTOR: BRS FIELD OPS 385-498-6700

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Report No. 102393982LAX-002 Unirac, Inc

Unirac

document.

engage cable.

2.0 Product Description

Product

Brand name

Description

Page 3 of 136 Issued: 11-Apr-2016

Photovoltaic Mounting System, Sun Frame Microrail Installation Guide, PUB2021NOV29

The product covered by this report is the Sun Frame Micro Rail roof mounted Photovoltaic

that are roof mounted using the slider, outlined in section 4 of this report. There are no rails

The Micro Rails are installed onto the module frame by using a stainless steel bolt anodized with black oxide with a stainless type 300 bonding pin, torqued to 20 ft-lbs, retaining the modules to the bracket. The bonding pin of the Micro Rail when bolted and torqued, penetrate

the anodized coating of the photovoltaic module frame (at bottom flange) to contact the metal,

The grounding of the entire system is intended to be in accordance with the latest edition of the

Photovoltaic Systems or the Canadian Electrical Code, CSA C22.1 Part 1 in accordance to the

revision in effect in the jurisdiction in which the project resides. Any local electrical codes must

be adhered in addition to the national electrical codes. The Grounding Lug is secured to the

Other optional grounding includes the use of the Enphase UL2703 certified grounding system, which requires a minimum of 2 micro-inverters mounted to the same rail, and using the same

photovoltaic module, torqued in accordance with the installation manual provided in this

National Electrical Code, including NEC 250: Grounding and Bonding, and NEC 690: Solar

photovoltaic modules. The mounting system employs anodized or mill finish aluminum brackets

Rack Mounting System. This system is designed to provide bonding and grounding to

within this product, whereas the 3" Micro Rail, Floating Splice, and 9" Attached Splice

electrically bond the modules together forming the path to ground.

creating a bonded connection from module to module.

Issued: 11-Apr-2016 Report No. 102393982LAX-002 Revised: 2-Jan-2022 Unirac, Inc

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Issued: 11-Apr-2016 Revised: 2-Jan-2022



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Other Ratings

NA

Report No. 102393982LAX-002 Unirac, Inc

Illustration 1 - Approved PV Modules

Module Model / Series

AXN6M610T, AXN6P610T,

CHSM6612P, CHSM6612P/HV, CHSM6612M,

CHSM6612M/HV, CHSM6610M (BL)(BF)/(HF),

P-Series

CHSM72M-HC

BVM6610,

BVM6612

DH-60M

7.0 Illustrations

Manufacture

Astronergy

Aleo

Auxin

Axitec

Aptos

Boviet

BYD

Canadian Solar

CertainTeed

Centrosolar America

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Manufacture

Eco Solargy

ET Solar

FreeVolt

GCL

Issued: 11-Apr-2016 Revised: 2-Jan-2022

Module Model / Series

Mono PERC

TD-AN3, TD-AN4,

Orion 1000 & Apollo 1000 ET-M672BHxxxTW

GCL-P6 & GCL-M6 Series

Report No. 102393982LAX-002 Page 43 of 136 Unirac, Inc

Issued: 11-Apr-2016 Revised: 2-Jan-2022

#### 7.0 Illustrations

#### Illustration 1a - Approved PV Modules Continue

Manufacture	Module Model / Series	Manufacture	Module Model / Series
LG Electronics	LGxxxN2T-A4 LGxxx(A1C/E1C/E1K/N1C/N1K/N2T/N2W/ Q1C/Q1K/S1C/S2W)-A5 LGxxxN2T-B5 LGxxxN1K-B6 LGxxx(A1C/M1C/M1K/N1C/N1K/Q1C/Q1K/ QAC/QAK)-A6 LGxxx(N1C/N1K/N2T/N2W)-E6	Panasonic	VBHNXXXSA15 & SA16, VBHNXXXSA17 & SA18, VBHNXXXSA17(E/G) & SA18E, VBHNXXXKA01 & KA03 & KA04, VBHNXXXXA01, VBHNXXXZA02, VBHNXXXZA03, VBHNXXXZA04 SGXXM (FB/BF)
	LGxxx(N1C/N1K/N2W/S1C/S2W)-G4	Phono Solar	PS-60, PS-72
	LGxxxN2T-J5 LGxxx(N1K/N1W/N2T/N2W)-L5 LGxxx(N1C/Q1C/Q1K)-N5 LGxxx(N1C/N1K/N2W/Q1C/Q1K)-V5 LR4-60(HIB/HH/HPB/HPH)-xxxM LR4-72(HIH/HPH)-xxxM LR6-60(BP/HBD/HIBD)-xxxM (30mm) LR6-60(BK)(PE)(HPB)(HPH)-xxxM (40mm) LR6-72(BP)(HBD)(HIBD)-xxxM (30mm) LR6-72(BP)(HBD)(HIBD)-xxxM (30mm) LR6-72(BP)(HBD)(HIBD)-xxxM (30mm)	Prism Solar	P72 Series
LONGi		Q.Cells	Pro, Peak L-G2, L-G4, L-G5, L-G6, L-G7  Q.PEAK DUO BLK-G6+  Q.PEAK DUO BLK-G6+/TS  Q.PEAK DUO (BLK)-G8(+)  O.PEAK DUO L-G8.3/BFF
			Q.PEAK DUO (BLK) ML-G9(+) Q.PEAK DUO XL-G9/G9.2/G9.3 Q.PEAK DUO (BLK) ML-G10(+) Q.PEAK DUO XL-G(10/10.2/10.3/10.c/10.
	(35mm) LR6-72(BK)(HV)(PE)(PB)(PH)-xxxM (40mm)		Alpha (72) (Black) (Pure) N-Peak (Black)
Mission Solar Energy	MSE Series		N-Peak 2 (Black)
Mitsubishi	MJE & MLE Series	REC PEAK Energy Series	
Neo Solar Power Co.	D6M & D6P Series	]	PEAK Energy BLK2 Series
			PEAK Energy 72 Series

<b>BLUE</b>	RAVE
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Hansol AXN6M612T & AXN6P612T UB-AN1, UD-AN1 AXIblackpremium 60 (35mm), Heliene 36M, 60M, 60P, 72M & 72P Series AXIpower 60 (35mm), HT60-156(M) (NDV) (-F), HT Solar HT 72-156(M/P) AXIpower 72 (40mm), AXIpremium 60 (35mm), KG, MG, TG, RI, RG, TI, MI, HI & KI Series Hyundai AXIpremium 72 (40mm). HiA-SxxxHG DNA-120-(BF/MF)26 ITEK iT, iT-HE & iT-SE Series DNA-144-(BF/MF)26 Japan Solar JPS-60 & JPS-72 Series JAP6 60-xxx, JAM6-60-xxx/SI, JAM6(K)-60/ xxx, JAP6(k)-72-xxx/4BB, JAP72SYY-xxx/ZZ, P6K & MHK-36 Series JAP6(k)-60-xxx/4BB, JAP60SYY-xxx/ZZ, CS1(H/K/U/Y)-MS JAM6(k)-72-xxx/ZZ, JAM72SYY-xxx/ZZ, JA Solar CS3(K/L/U), CS3K-MB-AG, CS3K-(MS/P) JAM6(k)-60-xxx/ZZ, JAM60SYY-xxx/ZZ. CS3N-MS, CS3U-MB-AG, CS3U-(MS/P), CS3W i. YY: 01, 02, 03, 09, 10 CSSA-M, CS6(K/U), CS6K-(M/P), CS6K-MS ii. ZZ: SC, PR, BP, HiT, IB, MW, MR CS6P-(M/P), CS6U-(M/P), CS6V-M, CS6X-P JKM & JKMS Series C-Series & E-Series Eagle JKMxxxM Jinko CT2xxMxx-01, CT2xxPxx-01, JKMxxxM-72HL-V CTxxxMxx-02, CTxxxM-03, KU Series Kyocera CTxxxMxx-04, CTxxxHC11-04

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Report No. 102393982LAX-002 Unirac, Inc Page 44 of 136

Issued: 11-Apr-2016 Revised: 2-Jan-2022

#### 7.0 Illustrations

#### Illustration 1b - Approved PV Modules Continue

Manufacture	Module Model / Series
	TwinPeak Series
	TwinPeak 2 Series
REC (cont.)	TwinPeak 2 BLK2 Series
REC (CONC.)	TwinPeak 2S(M)72(XV)
	TwinPeak 3 Series (38mm)
	TP4 (Black)
Renesola	Vitrus2 Series & 156 Series
Risen	RSM72-6 (MDG) (M), RSM60-6
S-Energy	SN72 & SN60 Series (40mm)
Seraphim	SEG-6 & SRP-6 Series
Sharp	NU-SA & NU-SC Series
Silfab	SLA, SLG, BC Series & SILxxx(BL/NL/NT/HL/
Silfab	ML/BK/NX/NU/HC)
	PowerXT-xxxR-(AC/PD/BD)
Solaria	PowerXT-xxxC-PD
	PowerXT-xxxR-PM (AC)
SolarWorld	Sunmodule Protect,
Solarworld	Sunmodule Plus
Sonali	SS 230 - 265
Suntech	STP
Suniva	MV Series & Optimus Series
Sun Edison/Flextronics	F-Series, R-Series & FLEX FXS Series
SunPower	X-Series, E-Series & P-Series
T.	TP572, TP596, TP654, TP660,
Talesun	TP672, Hipor M, Smart

Manufacture	Module Model / Series
Tesla	SC, SC B, SC B1, SC B2 TxxxS
Trina	PA05, PD05, DD05, DE06, DD06, PE06, PD14, PE14, DD14, DE09.05, DE14, DE15, PE15H
Upsolar	UP-MxxxP(-B), UP-MxxxM(-B)
URE	D7MxxxH7A, D7(M/K)xxxH8A FAKxxx(C8G/E8G), FAMxxxE7G-BB FAMxxxE8G(-BB)
Vikram	Eldora, Solivo, Somera
Waaree	AC & Adiya Series
Winaico	WST & WSP Series
Yingli	YGE & YLM Series
ZN Shine	ZXM6-72



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PV INSTALLATION PROFESSIONAL

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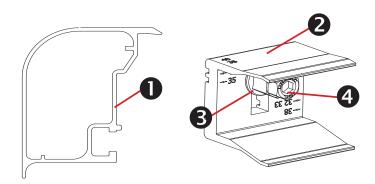
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#### Trimrail™ and Module Clips

#### **Sub-Components:**

- 1. Trim Rail
- Module Clip
- 3. T-Bolt
- Tri-Drive Nut

#### Trimrail™

#### **Functions:**

- Required front row structural support (with module clips)
- Module mounting
- Installation aid
- Aesthetic trim

#### **Features:**

- Mounts directly to L-feet
- Aligns and captures module leading edge
  - Supports discrete module thicknesses from 32, 33, 35, 38, and 40mm


#### **Module Clips**

#### **Functions:**

- Required front row structural support (with trimrail)
- Module mounting

#### **Features:**

- Mounts to Trimrail™ with T-bolt and tri-drive nut
- Manually adjustable to fit module thicknesses 32, 33, 35, 38, and 40mm.

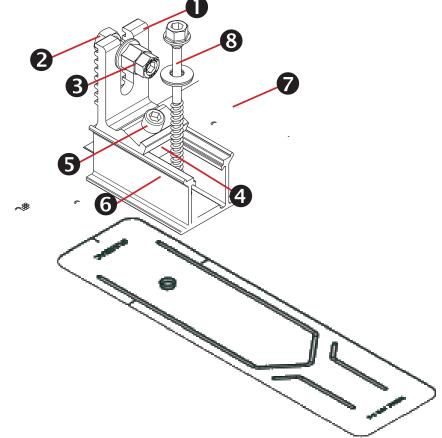

#### Trimrail<sup>™</sup> Flashkit

#### **Sub-Components:**

L-Foot

Hex bolt

Tri-drive nut

Channel Nut

Scocket Head Cap Screw

3"Channel/Slider w/grommet

3" Wide Flashing

Structural Screw & SS EPDM Washer

#### **Functions:**

- Attach Trimrail™ to roof attachment / flashing
- Patented roof sealing technology at roof attachment point

#### **Features:**

- Slot provides vertical adjustments to level array
- Slider provides north/south adjustment along the slope of the roof
- Shed and Seal Technology

### Trimrail™ Splice

#### **Sub-Components:**

- 1. Structural Splice Extrusion
- 2. Bonding Clip

#### **Functions:**

- Front row structural support
- Installation aid
- Structurally connects 2 pieces of Trimrail™
- Electrically bonds 2 pieces of Trimrail™

#### **Features:**

- Aligns and connects Trimrail™ pieces
- Tool-less installation

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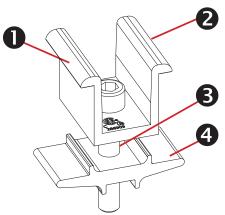
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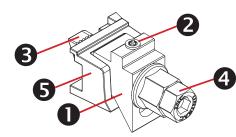
#### Module-to-Module N-S Bonding

#### **Sub-Components:**

- 1. Clamp
- 2. Bonding Pins (2)
- 3. 5/16" Socket Head Cap Screw
- 4. Clamp Base

#### **Functions/ Features:**

- Row to row bonding
- Single Use Only
- Fits module sizes 32-40mm




# Trim -to- Module Bonding Clamp and Floating Trim Clamp

#### **Sub-Components:**

- 1. Wedge
- 2. Bonding Pin
- 3. T-Bolt
- 4. Nut
- . Cast Base

#### **Functions/ Features:**

- Module to Trimrail™ bonding single use only
- Attaches Trimrail<sup>™</sup> to module when fewer than
   2 rafter attachment points are available
- Fits module sizes 32-40mm
- Fits module sizes 32-40mm

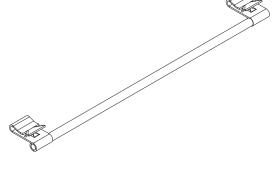


### Wire Bonding Clip w/ 8AWG

#### **Functions:**

- Row to row bonding
- Module to Trimrail<sup>™</sup> bonding
- Single Use Only

#### **Features:**

Tool-less installation

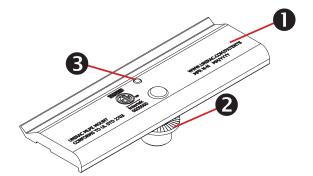

### **MLPE Mounting Assembly**

#### **Sub-Components:**

- 1. MLPE Mount Base
- 2. 5/16 Socket Head Cap Screw
- 3. Bonding Pin

#### **Functions:**

- Securely mounts MLPE to module frames
- MLPE to module bonding

#### Features:


- Mounts easily to typical module flange
- UL2703 Recognized


MLPE = Module Level Power Electronics, e.g. microinverter or power optimizer

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#### SFM Slider Flashkit

#### **Sub-Components:**

- 1. Slider w/grommet
- 2. Structural Screw & SS EPDM washer
- 3. 3" Wide Flashing
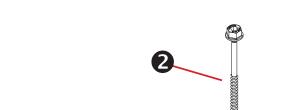
#### **Functions:**

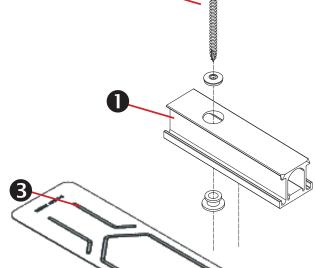- Patented Shed & Seal roof sealing technology at roof attachment point
- For use with compatible 2" Microrail or 8" Attached Splices

#### **Features:**

- Slider provides north/south adjustment along the slope of the roof
- Shed and Seal Technology



# 3" FLASHING & SLIDERS | GINSTALLATION GUIDE | PAGE




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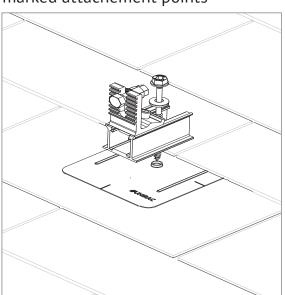
CONFIDENTIAL - THE INFORMATION HEREIN CONTAINED SHALL NOT BE USED FOR THE BENEFIT OF ANYONE EXCEPT BLUE RAVEN SOLAR NOR SHALL IT BE DISCLOSED IN WHOLE OR IN PART TO OTHERS OUTSIDE RECIPIENTS ORGANIZATION, EXCEPT IN CONNECTION WITH THE SALE AND USE OF THE RESPECTIVE EQUIPMENT, WITHOUT THE WRITTEN PERMISSION OF BLUE







#### **PILOT HOLES:**

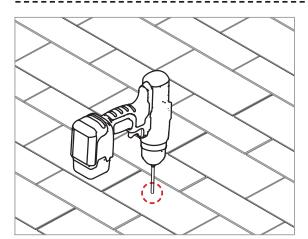Drill pilot holes for lag screws or structural screws (as necessary) at marked attachement points



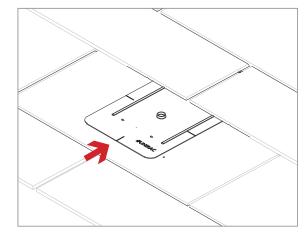

**FLASHINGS:** Place flashings

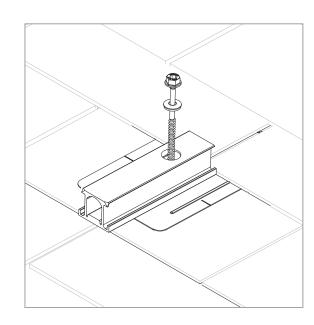


#### **INSTALL SLIDERS AND TRIMRAIL ROOF ATTACHMENTS:**

Insert flashings per manufacturer instructions

NOTE: Use Lag screw or structural fastener with a maximum diameter of 5/16"

- Attach sliders to rafters
- Verify proper row to row spacing for module size (Mod NS + 1")
- Ensure that TrimrailTM roof attachments in each row have sufficient engagement with slider dovetails for proper attachment.

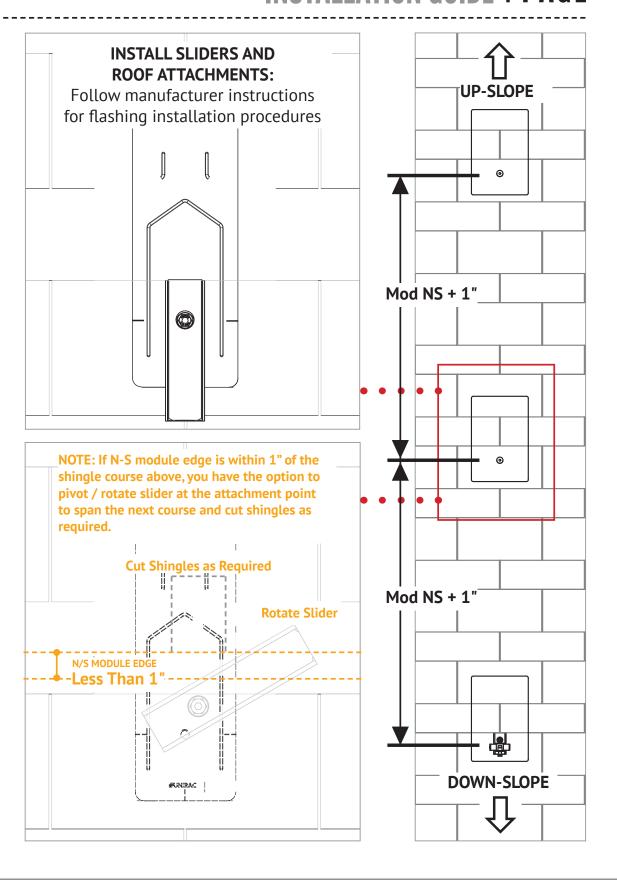

SPEC SHEET

AGE NUMBER SS

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