# 

01 SITE SKETCH G-01 SCALE: N/A

# 232 Village Bend Dr, Fuquay-Varina, NC... Village Bend Dr

G-01 COCATION MAP
SCALE: N/A

### **SHEET SCHEDULE**

SHEET NO.	SHEET TITLE
G-01	COVER
S-01	ARRAY A LAYOUT
S-02	ASSEMBLY DETAILS
E-01	LINE DIAGRAM
R-01	RESOURCES
R-02	RESOURCES
R-03	RESOURCES
R-04	RESOURCES
R-05	RESOURCES
R-06	RESOURCES
R-07	RESOURCES

### **PROJECT INFORMATION**

CONTRACTOR

NAME: CAPE FEAR SOLAR SYSTEMS, LLC

PHONE: (910) 409-5533

PROJECT MANAGER: ROBERT PARKER

PHONE: (910) 232-6288

**AUTHORITIES HAVING JURISDICTION** 

BUILDING: WAKE COUNTY

ZONING: WAKE COUNTY

ELECTRICAL: WAKE COUNTY UTILITY: DEP

**APPLICABLE CODES & STANDARDS** 

BUILDING: IRC WITH NORTH CAROLINA AMENDMENTS 2018

ELECTRICAL: NEC 2017

FIRE: IFC WITH NORTH CAROLINA AMENDMENTS 2018,

STATEWIDE UNIFORM REQUIREMENTS OF INSPECTION PROCEDURES FOR SOLAR PHOTOVOLTAIC SYSTEMS INSTALLED ON RESIDENTIAL

ROOFTOPS

STRUCTURAL REVIEW PROVIDED BY: RONALD P. BITTLER, PE RB ENGINEERING, INC. (C-2499) 168 QUADE DRIVE CARY, NC 27513 919-677-9662 PROJECT #RB-217049

# CAPE FEAR SOLAR SYSTEMS


901 Martin Street, Unit A Wilmington, NC 28401 910-409-5533



GC LIC. NO.: 65677 ELEC. LIC. NO.: U-33321

8.69KW PV SYSTEM
VALENTIN RESIDENCE
232 Village Bend Dr, FuquayVarina, NC 27526

COVER

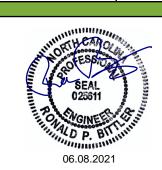

REVISION LIST $\triangle$			
DESC.	REV. DATE	#	
June 7, 2021	DATE:		
ZJP	RAWN BY:	D	

Sheet No.

G-01

# **STRUCTURAL NOTES DESIGN SPECIFICATIONS GROUND SNOW LOAD: 15 PSF** 1. ROOF MOUNT RACKING SYSTEM & PV ARRAY TO DESIGN WIND SPEED: 117 MPH (ASCE 7-10) BE INSTALLED IN STRICT ACCORDANCE WITH DESIGN EXPOSURE CATEGORY: B THESE DRAWINGS & MFG'S RECOMMENDATIONS. DEAD LOAD: 2.31 PSF MINOR SPACING MODIFICATIONS ARE ACCEPTABLE TO ACCOMODATE EXISTING ROOF STRUCTURE MEMBERS 20'-10" 2. EXISTING ROOF STRUCTURE HAS BEEN INCLUDED IN THE STRUCTURAL EVALUATION AND FOUND SUITABLE FOR THIS INSTALLATION 3. ALL ATTACHMENT BOLTS SHALL BE INSTALLED IN THE MIDDLE THIRD OF THE RAFTER (OR TRUSS) THICKNESS 6'-0" 17'-3" TYP 4'-0" TYP 2'-4" 1'-11 5/8" 3'-3 1/2" 2'-1 3/4" 34'-9 1/8" 01 PLAN - ARRAY A LAYOUT S-01 SCALE: 1/4" = 1'

CAPE FEAR SOLAR SYSTEMS

901 Martin Street, Unit A Wilmington, NC 28401 910-409-5533



GC LIC. NO.: 65677

ELEC. LIC. NO. : U-33321

232 Village Bend Dr, Fuquay Varina, NC 27526 ARRAY A LAYOUT

**VALENTIN RESIDENCE** 

8.69KW PV SYSTEM

SEAL 025611


OG.08.2021

# REVISION LIST # REV. DATE DESC.

DATE: June 7, 2021

Sheet No.

**S-01** 

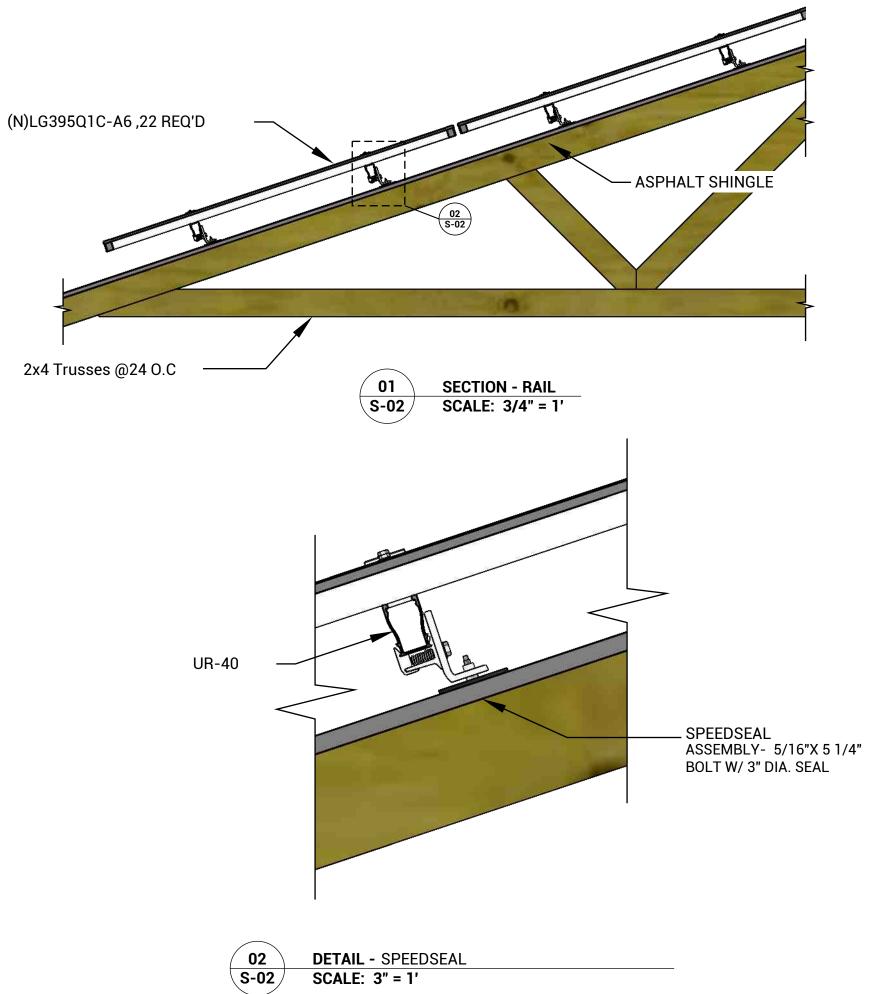



SOLAR SYSTEMS
901 Martin Street, Unit A
Wilmington, NC 28401
910-409-5533




GC LIC. NO.: 65677

ELEC. LIC. NO.: U-33321

# **ASSEMBLY DETAILS**

232 Village Bend Dr, Fuquay-Varina, NC 27526 **VALENTIN RESIDENCE** 8.69KW PV SYSTEM

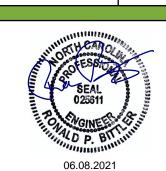

	REVISION LIST <u></u>						
#	REV. DATE	DESC.					
	DATF.	June 7, 2021					


DRAWN BY: Sheet No.


**S-02** 

### **GENERAL ELECTRICAL NOTES**

- 1. Equipment shall be new unless otherwise noted.
- 2. Equipment shall be listed unless otherwise noted.
- 3. Equipment shall be installed providing adequate working space in compliance with NEC.
- 4. Copper conductors shall be used and shall have insulation rating 600v, 90°C unless otherwise noted.
- 5. Conductors shall be sized in accordance with the NEC and ampacity shall be derated for temperature increase, conduit fill & voltage drop.
- 6. All conductors shall be installed in approved conduits. Conduits shall be adequately supported in accordance with
- 7. AC Disconnect is optional, however it may be required by the utility.
- 8. Exposed non-current carrying metal parts shall be grounded in accordance with the NEC.
- 9. All work shall comply with the NEC and all applicable local electrical code requirements.
- 10. Contractor will provide labeling in accordance with the NEC, Article 110, 225, 690, and 705.

LEGE	ND
N)	NEW
E)	EXISTING
0)	NEW BY OTHERS
	NEUTRAL
	GROUND

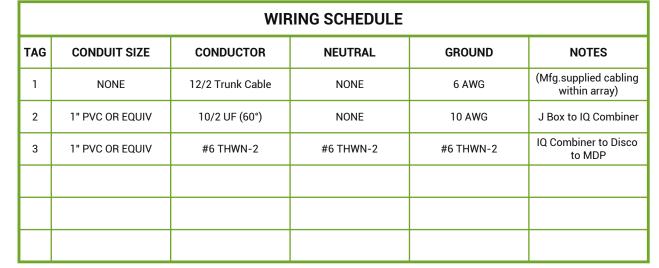

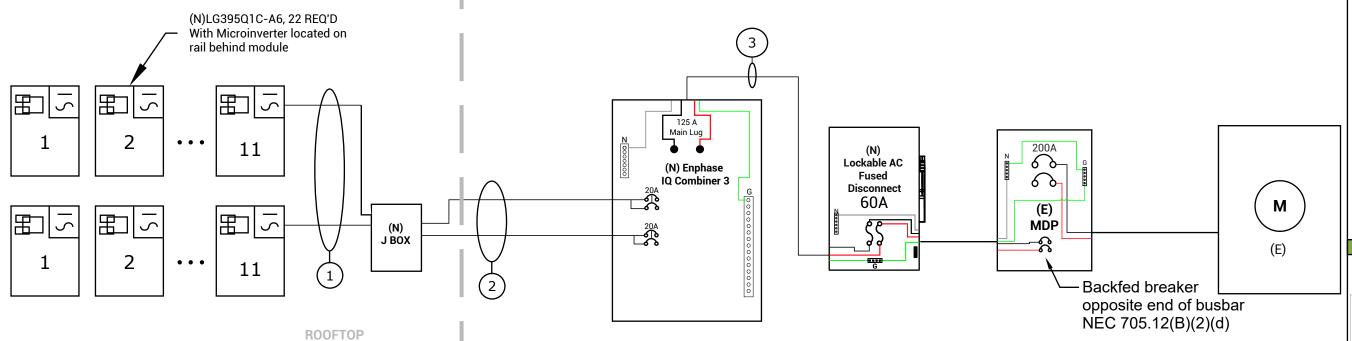

PANEL MODEL: LG395Q1C-A6. 22REQ'D, 395W INVERTER TYPE: Enphase IQ7A-72-2-US 22 REQ'D 349W, 240V 7.678 kW-AC/8.69 kW-DC/

### **AWARNING** TURN OFF PHOTOVOLTAIC AC DISCONNECT PRIOR TO **WORKING INSIDE PANEL**

Location: Combiner box

SOLAR PV SYSTEM EQUIPPED

690.56 (c)(1)(a) Location: Disconnect

PHOTOVOLTAIC SYSTEM AC DISCONNECT RATED AC OPERATING CURRENT 34.8 AMPS AC AC NOMINAL OPERATING VOLTAGE 240 VAC

> 690.54 Location: MDP



690.56 (c)(3) Location: Disconnect

**PV SOLAR BEAKER** DO NOT RELOCATE THIS **OVERCURRENT DEVICE** 705.12 (B)(2)(3)(b)

**Location: PV Breakers** 

### **△ WARNING** PHOTOVOLTAIC SYSTEM

COMBINER PANEL DO NOT ADD LOADS

705.12

Location: Combiner box

# **WARNING**

705.10 Location: Disconnect

### **SOLAR DISCONNECT**

690.13 (B) Location: Disconnect

### CAPE E FEAR SOLAR SYSTEMS

901 Martin Street, Unit A Wilmington, NC 28401 910-409-5533



GC LIC. NO.: 65677 ELEC. LIC. NO.: U-33321

DIAGRAM

INE

ıllage Bend Dr, Fuquay Varina, NC 27526 **VALENTIN RESIDENCE** 8.69KW PV SYSTEM 232 Village

**SUNPOWER®** 

Elite Dealer

ION LIST A	REVIS	
DESC.	REV. DATE	#
June 7, 2021	DATE:	

DRAWN BY: Sheet No.

E-01

# LG NeON®R

LG395Q1C-A6

### 395W

LG NeON® R is powerful solar module that provides world-class performance. A new cell structure that eliminates electrodes on the front maximizes the utilization of light and enhances reliability.

LG NeON® R is a result of LG's efforts to increase customer's values beyond efficiency. LG NeON® R features enhanced durability, performance under real-world conditions, an enhanced warranty and aesthetic design suitable for roofs.







### Features



### Roof Aesthetics

LG NeON® R has been designed with aesthetics in mind: the lack of any electrodes on the front creates an improved, modern aesthetic.



### 25-Year Limited Product Warranty

The NeON® R is covered by a 25-year limited product warranty. In addition, up to \$450 of labor costs will be covered in the rare case that a module needs to be repaired or replaced.



### Enhanced Performance Warranty

The LG NeON® R has an enhanced performance warranty. After 25 years, LG NeON® R is guaranteed at least 92.5% of initial performance.



### More generation per square meter

The LG NeON® R has been designed to significantly enhance its output, making it efficient even in limited space.

### When you go solar, ask for the brand you can trust: LG Solar

### About LG Electronics USA, Inc.

LG Electronics is a global leader in electronic products in the clean energy markets by offering solar PV panels and energy storage systems. The company first embarked on a solar energy source research program in 1985, supported by LG Group's wast experience in the semi-conductor, LCD, chemistry and materials industries. In 2010, LG Solar successfully released its Tist MonoxiV energy to the total conductor, which is now available in 32 countries. The NoNOV (previous MonoxiV NeON), NeON\*2, NeON\*2, Bifacial won the "Intersolar AWARO" in 2013, 2015, and 2016, which demonstrates LG's leadership and invovation in the solar industry.



### LG NeON®R

### LG395Q1C-A6

### General Data

Cell Properties (Material/Type)	Monocrystalline / N-type	
Cell Maker	LG	
Cell Configuration	60 Cells (6 x 10)	
Module Dimensions (L.x.W.x.H)	1,740mm x 1,042mm x 40mm	
Veight	18.5 kg	
Glass (Material)	Tempered Glass with AR Coating	
Backsheet (Color)	White	
rame (Material)	Anodized Aluminium	
lunction Box (Protection Degree)	IP 68 with 3 Bypass Diodes	
Cables (Length)	1,250mm x 2EA	
Connector (Type/Maker)	MC 4 / MC	

### Certifications and Warranty

	IEC 61215-1/-1-1/2 : 2016, IEC 61730-1/2: 2016 UL 61730-1 : 2017, UL 61730-2 : 2017
Cartifications"	ISO 9001, ISO 14001, ISO 50001
	OHSAS 18001
Salt Mist Corrosion Test	IEC 61701:2012 Severity 6
Ammonia Corrosion Test	IEC 62716 : 2013
Module Fire Performance	Type 1 (UL 61730)
Fire Rating	Class C (UL 790, ULC / ORD C 1703)
Solar Module Product Warranty	25 Years
Solar Module Output Warranty	Linear Warranty*

\*Improved: 1= year 98.5%, from 2-24th year: -0.25%/year down, 92.5% at year 2

### Temperature Characteristics


NMOT*	[*c]	44±3	
Pmax	[%/*c]	-0.29	
Voc	[96/*0]	-0.24	
fsc	[%/°C]	0.04	

\*NMOT (Norminal Module Operating Temperature). Irradiance 800 W/m², Ambient temperature 20°C, Wind speed 1 m/s, Spectrum AM 1.5

### Electrical Properties (NMOT)

Model		LG395Q1C-A6	
Maximum Power (Pmax)	[W]	299	
MPP Voltage (Vmpp)	[V]	34.9	
MPP Current (Impp)	[A]	8.57	
Open Circuit Voltage (Voc)	[V]	41.6	
Short Circuit Current (Isc)	[A]	910	

### I-V Curves

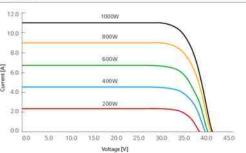

# LG Electronics USA Inc. Solar Business Division 2000 Millbrook Drive Lincolnshire, IL 60069

© 2021 LG Electronics USA, Inc. All rights reserved.

LG395Q1C-A6.pdf

011821

### Electrical Properties (STC\*)

Model		LG395Q1C-A6
Maximum Power (Pmax)	[W]	395
MPP Voltage (Vmpp)	[V]	37.0
MPP Current (Impp)	[A]	10.69
Open Circuit Voltage (Voc.† 5%)	[V]	43.6
Short Circuit Current (isc,±5%)	[A]	11.29
Module Efficiency	[%]	21.8
Power Tolerance	[96]	0 ~ +3

\*STC (Standard Test Condition): Irradiance 1000 W/m², Cell temperature 25°C, AM 1.5 Measure Tolerance: 13%

### **Operating Conditions**

Operating Temperature	[°C]	-40 -+85
Maximum System Voltage	[V]	1,000
Maximum Series Fuse Rating	[A]	20
Mechanical Test Load** (Front)	[Pa/psf]	5,400
Mechanical Test Load" (Rear)	[Pa/psf]	4,000

"The operating ambient temperature of these devices may exceed 40°C at full load for all wire sizes if is determined suitable in the field use application.


suitable in the field use application.

\*\*Based on IEC 61215-2: 2016 (Test Load = Design Load x Safety Factor (1.5))

### Packaging Configuration

Number of Modules per Pallet	[EA]	25
Number of Modules per 40' Container	(EA)	650
Number of Modules per 53' Container	[EA]	850
Packaging Box Dimensions (L x W x H)	[enen]	1,790 x 1,120 x 1,227
Packaging Box Dimensions (L x W x H)	[in]	70.5 × 44.1 × 48.3
Packaging Box Gross Weight	[kg]	498
Packaging Box Gross Weight	[lb]	1,098

### Dimensions (mm/inch)

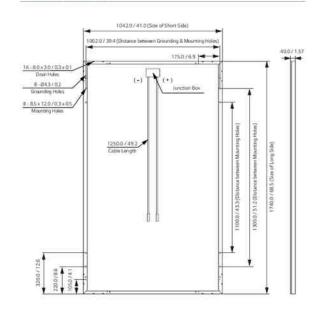

DRAWN BY:

DATE:

# REV. DATE

Sheet No.

R-01

CAPE FEAR SOLAR SYSTEMS 901 Martin Street, Unit A Wilmington, NC 28401

910-409-5533

GC LIC. NO.: 65677

ELEC. LIC. NO.: U-33321

d Dr, Fuquay 27526

Village Bend I Varina, NC 2

232

SUNPOWER°

Elite Dealer

REVISION LIST  $\wedge$ 

DESC.

June 7, 2021

ZJP

ESOURCE

**VALENTIN RESIDENCE** 

**SYSTEM** 

8.69KW PV

Data Sheet Enphase Microinverters Region: AMERICAS

## **Enphase IQ 7A Microinverter**

The high-powered smart grid-ready

Enphase IQ 7A Micro™ dramatically simplifies the installation process while achieving the highest system efficiency for systems with 60-cell and 72-cell modules.

Part of the Enphase IQ System, the IQ 7A Micro integrates with the Enphase IQ Envoy™, Enphase IQ Battery™, and the Enphase Enlighten™ monitoring and analysis software.

The IQ Series Microinverters extend the reliability standards set forth by previous generations and undergo over a million hours of power-on testing, enabling Enphase to provide an industry-leading warranty of up to 25 years.



Peak output power 366 VA @ 240 VAC and 295 VA @ 208 VAC

### Easy to Install

- · Lightweight and simple
- · Faster installation with improved, lighter two-wire cabling
- · Built-in rapid shutdown compliant (NEC 2014 & 2017)

### Efficient and Reliable

- Optimized for high powered 60-cell and 72-cell modules
- · Highest CEC efficiency of 97%
- · More than a million hours of testing
- · Class II double-insulated enclosure
- UL listed

### Smart Grid Ready

- · Complies with advanced grid support, voltage and frequency ridethrough requirements
- · Envoy and Internet connection required
- · Configurable for varying grid profiles
- Meets CA Rule 21 (UL 1741-SA)



### Enphase IQ 7A Microinverter

INPUT (DC)	IQ7A-72-2-US		
Commonly used module pairings1	295 W-460 W+		
Module compatibility	60-cell, 66-cell, and 72-cell PV modules		
Maximum input DC voltage	58 V		
Power point tracking voltage range <sup>2</sup>	18 V-58 V		
Min/Max start voltage	30 V / 58 V		
Max DC short circuit current (module Isc)3	15 A		
Overvoltage class DC port	II		
DC port backfeed current	0 A		
PV array configuration	1 x 1 ungrounded array. No additional DC side protection required; AC side protection requires max 20A per branch circuit		
OUTPUT (AC)	@ 240 VAC		@ 208 VAC
Peak output power	366 VA		295 VA
Maximum continuous output power	349 VA		290 VA
Nominal (L-L) voltage/range <sup>4</sup>	240 V / 211-264	4 V	208 V / 183-229 V
Maximum continuous output current	1.45 A (240 VAC	2)-	1.39 A (208 VAC)
Nominal frequency	60 Hz		
Extended frequency range	47-68 Hz		
AC short circuit fault current over 3 cycles	5.8 Arms		
Maximum units per 20 A (L-L) branch circuit <sup>5</sup>	11 (240 VAC)		11 (208 VAC)
Overvoltage class AC port	m		
AC port backfeed current	18 mA		
Power factor setting	1.0		
Power factor (adjustable)	0.85 leading	0.85 lagging	
EFFICIENCY	@240 VAC		@208 VAC
CEC weighted efficiency	97.0 %		96.5%
MECHANICAL			
Ambient temperature range	-40°C to +60°C		
Relative humidity range	4% to 100% (cor	ndensing)	
Connector type: DC (IQ7A-72-2-US)	MC4		
Dimensions (WxHxD)	212 mm x 175 mm x 30.2 mm (without bracket)		
Weight	1.08 kg (2.38 lbs)		
Cooling	Natural convection — No fans		
Approved for wet locations	Yes		
Pollution degree	PD3		
Enclosure	Class II double-	insulated, corrosion re	esistant polymeric enclosure
Environmental category / UV exposure rating	NEMA Type 6 / outdoor		
FEATURES			
Communication	Power Line Con	nmunication (PLC)	
Monitoring	Enlighten Manager and MyEnlighten monitoring options Compatible with Enphase IQ Envoy		
Disconnecting means	The AC and DC connectors have been evaluated and approved by UL for use as the load-break disconnect required by NEC 690.		
Compliance	CA Rule 21 (UL 1741-SA) UL 62109-1, UL1741/IEEE1547, FCC Part 15 Class B, ICES-0003 Class B, CAN/CSA-C22.2 NO. 107.1-01 This product is UL Listed as PV Rapid Shut Down Equipment and conforms with NEC-2014 and NEC-2017 section 690.12 and C22.1-2015 Rule 64-218 Rapid Shutdown of PV Systems, for AC and DC conductors, when installed according manufacturer's instructions.		

- 1. No enforced DC/AC ratio. See the compatibility calculator at https://enphase.com/en-us/support/module-compatibility.
- CEC peak power tracking voltage range is 38 V to 43 V.
   Maximum continuous input DC current is 10.2A.
   Voltage range can be extended beyond nominal if required by the utility.
- 5. Limits may vary. Refer to local requirements to define the number of microinverters per branch in your area.

### To learn more about Enphase offerings, visit enphase.com

© 2019 Enphase Energy. All rights reserved. Enphase, the Enphase logo, Enphase IQ 7A, Enphase IQ Battery, Enphase Enlighten, Enphase IQ Envoy, and other trademarks or service names are the trademarks of Enphase Energy, Inc. Data subject to change.



### CAPE FEAR SOLAR SYSTEMS

901 Martin Street, Unit A Wilmington, NC 28401 910-409-5533



GC LIC. NO.: 65677 ELEC. LIC. NO.: U-33321

d Dr, Fuquay 27526 **VALENTIN RESIDENCE SYSTEM** Village Bend Varina, NC Bend 8.69KW PV

ESOURCE



232

Elite Dealer

	REVISION LIST $\wedge$		
#	REV. DATE	DESC.	

June 7, 2021 DATE: DRAWN BY: ZJP

Sheet No.

**R-02** 

To learn more about Enphase offerings, visit enphase.com


(II) CERTIFIED

Data Sheet Enphase Networking

# Enphase IQ Combiner 3

(X-IQ-AM1-240-3)

The Enphase IQ Combiner 3™ with Enphase IQ Envoy™ consolidates interconnection equipment into a single enclosure and streamlines PV and storage installations by providing a consistent, pre-wired solution for residential applications. It offers up to four 2-pole input circuits and Eaton BR series busbar assembly.

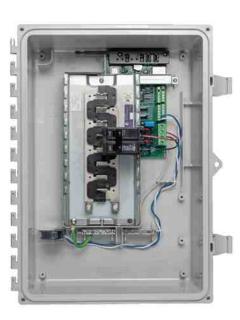

To learn more about Enphase offerings, visit enphase.com

### Smart

- Includes IQ Envoy for communication and control
- Flexible networking supports Wi-Fi, Ethernet, or cellular
- Optional AC receptacle available for PLC bridge
- Provides production metering and optional consumption monitoring

### Simple

- · Reduced size from previous combiner
- Centered mounting brackets support single stud mounting
- · Supports back and side conduit entry
- Up to four 2-pole branch circuits for 240 VAC plug-in breakers (not included)
- · 80 A total PV or storage branch circuits

### Reliable

- Durable NRTL-certified NEMA type 3R enclosure
- · Five-year limited warranty
- UL listed



### **Enphase IQ Combiner 3**

### MODEL NUMBER

IQ Combiner 3	IQ Combiner 3 with Enphase IQ Envoy™ printed circuit board for integrated revenue grade PV
X-IQ-AM1-240-3	production metering (ANSI C12.20 +/- 0.5%) and optional* consumption monitoring (+/- 2.5%).

### ACCESSORIES and REPLACEMENT PARTS (not included, order separately)

Enphase Mobile Connect™  CELLMODEM-03 (4G/12-year data plan)  CELLMODEM-01 (3G/5-year data plan)  CELLMODEM-M1 (4G based LTE-M/5-year data plan)	Plug and play industrial grade cellular modern with data plan for systems up to 60 microinverters. (Available in the US, Canada, Mexico, Puerto Rico, and the US Virgin Islands, where there is adequate cellular service in the installation area.)
Consumption Monitoring* CT CT-200-SPLIT	Split core current transformers enable whole home consumption metering (+/- 2.5%).
* Consumption monitoring is required for Enphase Storage Systems	
Wireless USB adapter COMMS-KIT-01	Installed at the IQ Envoy. For communications with Enphase Encharge™ storage and Enphase Enpower™ smart switch, Includes USB cable for connection to IQ Envoy or Enphase IQ Combiner™ and allows redundant wireless communication with Encharge and Enpower.
Circuit Breakers BRK-10A-2-240 BRK-15A-2-240 BRK-20A-2P-240	Supports Eaton BR210, BR215, BR220, BR230, BR240, BR250, and BR260 circuit breakers. Circuit breaker, 2 pole, 10A, Eaton BR210 Circuit breaker, 2 pole, 15A, Eaton BR215 Circuit breaker, 2 pole, 20A, Eaton BR220
EPLC-01	Power line carrier (communication bridge pair), quantity - one pair
XA-PLUG-120-3	Accessory receptacle for Power Line Carrier in IQ Combiner 3 (required for EPLC-01)
XA-ENV-PCBA-3	Replacement IQ Envoy printed circuit board (PCB) for Combiner 3

Continuous duty

### **ELECTRICAL SPECIFICATIONS**

	Will have been
INTERNET CONNECTION OPTIONS	
Altitude	To 2000 meters (6,560 feet)
Wire sizes	<ul> <li>20 A to 50 A breaker inputs: 14 to 4 AWG copper conductors</li> <li>60 A breaker branch input: 4 to 1/0 AWG copper conductors</li> <li>Main lug combined output: 10 to 2/0 AWG copper conductors</li> <li>Neutral and ground: 14 to 1/0 copper conductors</li> <li>Always follow local code requirements for conductor sizing.</li> </ul>
Enclosure environmental rating	Outdoor, NRTL-certified, NEMA type 3R, polycarbonate construction
Cooling	Natural convection, plus heat shield
Ambient temperature range	-40° C to +46° C (-40° to 115° F)
Weight	7.5 kg (16.5 lbs)
Dimensions (WxHxD)	49.5 x 37.5 x 16.8 cm (19.5" x 14.75" x 6.63"). Height is 21.06" (53.5 cm with mounting brackets
MECHANICAL DATA	
Production Metering CT	200 A solid core pre-installed and wired to IQ Envoy
Max. total branch circuit breaker rating (input)	80A of distributed generation / 90A with IQ Envoy breaker included
Max. continuous current rating (input from PV)	64 A
Branch circuits (solar and/or storage)	Up to four 2-pole Eaton BR series Distributed Generation (DG) breakers only (not included)
Max. fuse/circuit rating (output)	90 A
Max. continuous current rating (output to grid)	65 A
Eaton BR series busbar rating	125 A
System voltage	120/240 VAC, 60 Hz
nating	Continuous duty

Integrated Wi-Fi	i-Fi 802.11b/g/n	
Ethernet	Optional, 802.3, Cat5E (or Cat 6) UTP Ethernet cable (not included)	
Cellular	Optional, CELLMODEM-01 (3G) or CELLMODEM-03 (4G) or CELLMODEM-M1 (4G based LTE-M) (not included)	
COMPLIANCE		
Compliance, Combiner	UL 1741, CAN/CSA C22.2 No. 107.1, 47 CFR, Part 15, Class B, ICES 003	

Compliance, Combiner	UL 1741, CAN/CSA C22.2 No. 107.1, 47 CFR, Part 15, Class B, ICES 003 Production metering: ANSI C12.20 accuracy class 0.5 (PV production)
Compliance, IQ Envoy	UL 60601-1/CANCSA 22.2 No. 61010-1

### To learn more about Enphase offerings, visit enphase.com

© 2018 Enphase Energy. All rights reserved. Enphase, the Enphase logo, IQ Combiner 3, and other trademarks or service names are the trademarks of Enphase Energy, Inc. 2010. 1.10.



# CAPE FEAR SOLAR SYSTEMS

901 Martin Street, Unit A Wilmington, NC 28401 910-409-5533



GC LIC. NO.: 65677 ELEC. LIC. NO.: U-33321

8.69KW PV SYSTEM
VALENTIN RESIDENCE
232 Village Bend Dr, Fuquay-Varina, NC 27526

RESOURCES

SUNPOWER®

Elite Dealer

REVISION LIST  $\triangle$ 

# REV. DATE DESC.

 DATE:
 June 7, 2021

 DRAWN BY:
 ZJP

Sheet No.

### pe.eaton.com

# Eaton general duty cartridge fuse safety switch

DG222NRB

UPC:782113144221

### Dimensions:

Height: 14.37 INLength: 7.35 INWidth: 8.4 IN

Weight: 10 LB

**Notes:**Maximum hp ratings apply only when dual element fuses are used. 3-Phase hp rating shown is a grounded B phase rating, UL listed.

### Warranties:

 Eaton Selling Policy 25-000, one (1) year from the date of installation of the Product or eighteen (18) months from the date of shipment of the Product, whichever occurs first.

### Specifications:

- Type: General duty, cartridge fused
- Amperage Rating: 60A
- Enclosure: NEMA 3R
- Enclosure Material: Painted galvanized steel
- Fuse Class Provision: Class H fuses
- Fuse Configuration: Fusible with neutral
- Number Of Poles: Two-pole
- Number Of Wires: Three-wire
- Product Category: General duty safety switch
- Voltage Rating: 240V

### Supporting documents:

- Eatons Volume 2-Commercial Distribution
- Eaton Specification Sheet DG222NRB

### Certifications:

UL Listed

Product compliance: No Data



CAPE FEAR

901 Martin Street, Unit A Wilmington, NC 28401 910-409-5533



GC LIC. NO.: 65677 ELEC. LIC. NO.: U-33321

8.69KW PV SYSTEM VALENTIN RESIDENCE 232 Village Bend Dr, Fuquay-Varina, NC 27526

RESOURCES



Elite Dealer

REVISION LIST $\wedge$		
#	REV. DATE	DESC.

DATE:	June 7, 2021
DRAWN BY:	ZJP

Sheet No.

### SnapNrack SpeedSeal™ Foot

Patent Pending Lag Driven Sealant Solution for Ultra Rail



### A New Generation of Roof Attachments

- Innovative design incorporates flashing reliability into a single roof attachment
- 100% waterproof solution
- Sealing cavity with compressible barrier secures sealant in place & fills voids

### Maintain the Integrity of the Roof by Eliminating Disruption


- · Zero prying of shingles
- · Zero removal of nails leaving holes in the roof
- · Roof remains installed the way manufacturer meant it to be

### Lag Driven Sealant Waterproofing

- · Time Tested Roof Sealant provides lasting seal
- Sealant is compressed into cavity and lag hole as attachment is secured to rafter
- Active sealant solidifies bond if ever touched by liquid
- Technology passes UL 2582 Wind Driven Rain Test and ASTM E2140 Water Column Testing standards. Patent Pending.

### Single Tool Installation

 SnapNrack was the first in the industry to develop a complete system that only requires a single tool. That tradition is continued as a ½" socket is still the only tool necessary to secure the mount as well as all other parts of the system.

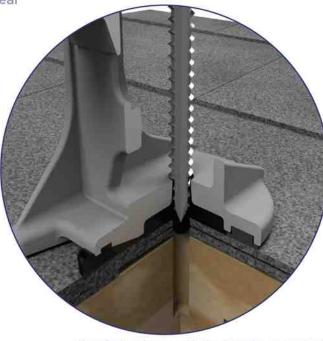

Note: Sealant shown in white for illustration purposes only.

### SnapNrack SpeedSeal™ Foot

Fastest Roof Attachment in Solar

- Lag straight to a structural member, no in-between components such as flashings or bases.
- Simply locate rafter, fill sealant cavity & secure to roof. It's that simple!

### Integrated Flashings. No Questions.

- Sealant fills around lag screw keeping roof and structure sealed and intact
- No added holes from ripping up nails, staples and screws holding shingles on roof

### Less Time. Less Parts. Less Tools.

- No more need for a pry bar to rip up shingles
- No more proprietary lag screws
- Single Tool installation with ½" socket

### Total System Solution One Tool. One Warranty.

- SnapNrack Ultra Rail is a
   straightforward intuitive install
   experience on the roof without
   compromising quality, aesthetics & safety, all supported by a 25 year warranty.
- Built-in Wire Management & Aesthetically pleasing features designed for Ultra Rail result in a long-lasting quality install that installers and homeowners love.

### Certifications

SnapNrack Ultra Rail System has been evaluated by Underwriters Laboratories (UL) and Listed to UL/ANSI Standard 2703 for Mechanical Loading and Fire. Additionally it is listed to UL 2582 for wind-driven rain and ASTM 2140.



877-732-2860

www.snapnrack.com

contact@snapnrack.com

© 2020 by SnapNrack Solar Mounting Solutions. All rights reserved



CAPE FEAR SOLAR SYSTEMS

901 Martin Street, Unit A Wilmington, NC 28401 910-409-5533



GC LIC. NO.: 65677 ELEC. LIC. NO.: U-33321

8.69KW PV SYSTEM
VALENTIN RESIDENCE
32 Village Bend Dr, Fuquay
Varina, NC 27526

**ESOURCES** 

SUNPOWER®

Elite Dealer

	REVISION LIST $\wedge$		
#	REV. DATE	DESC.	
	DATE.	lune 7 2021	

Sheet No.

R-05




UR-40 UR-60

### **SnapNrack Ultra Rail System**

A sleek, straightforward rail solution for mounting solar modules on all roof types. Ultra Rail features two rail profiles; UR-40 is a lightweight rail profile that is suitable for most geographic regions and maintains all the great features of SnapNrack rail, while UR-60 is a heavier duty rail profile that provides a larger rail channel and increased span capabilities. Both are compatible with all existing mounts, module clamps, and accessories for ease of install.

# **Ultra Rail**

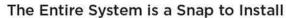

- New Ultra Rail Mounts include snap-in brackets for attaching rail
- Compatible with all the SnapNrack Mid Clamps and End Clamps customers love
- Universal End Clamps and snap-in End Caps provide a clean look to the array edge







### Unparalleled Wire Management

- Open rail channel provides room for running wires resulting in a long-lasting quality install
- Industry best wire management offering includes Junction Boxes, Universal Wire Clamps, MLPE Attachment Kits, and Conduit Clamps
- System is fully bonded and listed to UL 2703 Standard

# The Ultimate Value in Rooftop Solar



Industry leading Wire Management Solutions

Single Tool Installation



Mounts available for all roof types



All SnapNrack Module Clamps & Accessories are compatible with both rail profiles

# • UR-60 rail profile provides increased span capabilities for high wind speeds and snow

loads

• Taller, stronger rail profile includes profile-

Heavy Duty UR-60 Rail

- Ialler, stronger rail profile includes profilespecific rail splice and end cap
- All existing mounts, module clamps, and accessories are retained for the same great install experience



# Start Installing Ultra Rail Today

RESOURCES DESIGN WHERE TO BUY snapnrack.com/resources snapnrack.com/configurator snapnrack.com/where-to-buy

# Quality. Innovative. Superior.

SnapNrack Solar Mounting Solutions are engineered to optimize material use and labor resources and improve overall installation quality and safety.

877-732-2860 v

www.snapnrack.com

contact@snapnrack.com

© 2019 by SnapNrack Solar Mounting Solutions. All rights reserved

# CAPE FEAR SOLAR SYSTEMS

901 Martin Street, Unit A Wilmington, NC 28401 910-409-5533



GC LIC. NO.: 65677 ELEC. LIC. NO.: U-33321

8.69KW PV SYSTEM
VALENTIN RESIDENCE
232 Village Bend Dr, FuquayVarina, NC 27526

RESOURCES

SUNPOWER®

Elite Dealer

REVISION LIST $\triangle$			
#	REV. DATE	DESC.	

 DATE:
 June 7, 2021

 DRAWN BY:
 ZJP

Sheet No.




# Snap Vrack

### **Junction Box R for Rail Installation Manual**


### **Materials Included**


- (1) SnapNrack Junction Box Body
- (1) SnapNrack Junction Box Lid w/Gasket
- 6 (1) 5/16"-18 X 1-1/4" SS HCS Bolt
- (1) SnapNrack Channel Nut
- (1) 5/16"-18 X 1" SS HCS Bolt
- 6 (1) 5/16"-18 Self-Retaining Washer

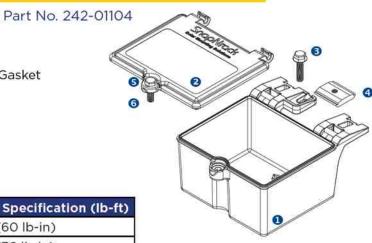



Hardware Description	Torque Specification (Ib-ft)
Junction Box Channel Nut	5 lb-ft (60 lb-in)
Junction Box Lid	3 lb-ft (36 lb-in)

Technical Specifications		
Internal Dimensions	al Dimensions 5.5" x 4.5" x 3.2" (inner box area)	
Material	Box: Polycarbonate Gasket: Rubber	
UL Environmental Rating	Type 4X (NEMA 4X)	
Certifications	UL50	
Temperature Range	-40°F - 185°F (-40°C - 85°C)	
Compatibility	Box Mount: Ultra Rail, S100 Standard Rail, S200 Ground Rail Internal Mount: Type O DIN Rail	

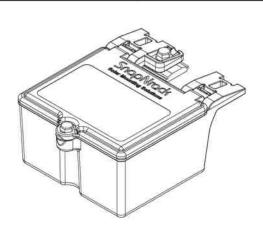

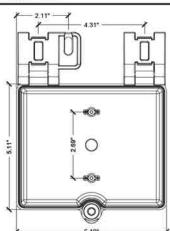

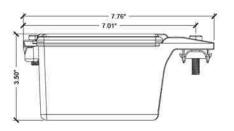

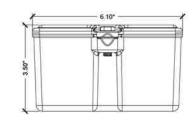

### **Required Tools**


- Socket Wrench
- Torque Wrench
- 1/2" Socket


### Step-by-Step Instructions


- 1. Mount the junction box at the edge of the array where the conduit will terminate. Junction box access after installation should not require the removal of more than one module.
- 2. Tilt bolt and channel nut so one side of channel nut can easily fall into top rail channel. Press junction box until both clips snap into top rail channel.
- 3. Pull up on the head of the bolt to snap the channel nut into the top rail channel. Torque mount bolt to 5 lb-ft (60 lb-in).
- 4. Install outdoor-rated, sealed conduit fitting or sealed strain relief to side wall of junction box and complete wiring installation.

CAUTION: Nonmetallic enclosure does not provide grounding between conduit connections. Use grounding bushings and jumper wires.

5. Once wiring is complete, close lid and tighten bolt until the front lid tab makes contact with the tab on the box, then torque to 3 lb-ft (36 lb-in) minimum.

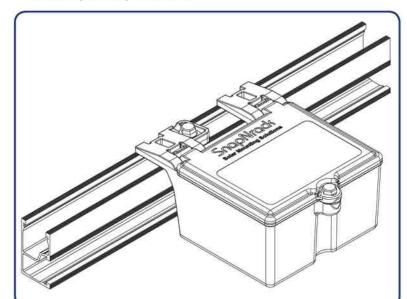

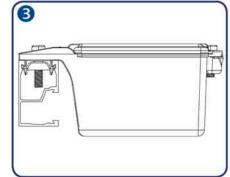

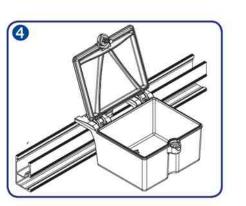

### Installation Note:

To avoid the accumulation of water as a result of condensation inside junction boxes it is acceptable to add drainage openings with a minimum diameter of 1/8 inch and a maximum diameter of 1/4 inch. (Per NEC, 314.15)

877-732-2860

www.snapnrack.com

contact@snapnrack.com

© 2018 by SnapNrack Solar Mounting Solutions. All rights reserved

901 Martin Street, Unit A Wilmington, NC 28401 910-409-5533

SOLAR SYSTEMS



GC LIC. NO.: 65677 ELEC. LIC. NO.: U-33321

8.69KW PV SYSTEM **ESOURCES** 

232 Village Bend Dr, Fuquay Varina, NC 27526 **VALENTIN RESIDENCE** 

**SUNPOWER®** 

Elite Dealer

	REVISION LIST $\triangle$		
#	REV. DATE	DESC.	
	DATE:	June 7, 2021	
D	RAWN BY:	ZJP	

Sheet No.