FIELD WRAPPER 18.00" HIGH FRONT, LEFT, RIGHT.

FIELD WRAPPER 18.00" HIGH FRONT, LEFT, RIGHT.

|BACKSPLASH 80.00" HIGH X 156.00" LONG 430 SS VERTICAL

BACKSPLASH 80.00" HIGH X 156.00" LONG 430 SS VERTICAL

MUA |

RIGHT VERTICAL END PANEL 27" TOP WIDTH, 21" BOTTOM WIDTH, 80" HIGH

RIGHT VERTICAL END PANEL 27" TOP WIDTH, 21" BOTTOM WIDTH, 80" HIGH

LEFT VERTICAL END PANEL 27" TOP WIDTH, 21" BOTTOM WIDTH, 80" HIGH

MUA | 8" | 36"

FOR QUESTIONS, CALL THE Eastern North Carolina REGION 36 PHONE: (919) 825 - 3566

STRUCTURAL FRONT PANEL

STRUCTURAL FRONT PANEL

156*"*

INSULATION FOR BACK OF HOOD.

|LENGTH| WIDTH |HEIGHT|

14"

6"

INSULATION FOR BACK OF HOOD.

PATENT NUMBERS

AC-PSP (UNITED STATES) - US PATENT 7963830 B2. AC-PSP WALL (CANADA) - CA PATENT 2820509. AC-PSP ISLAND (CANADA) - CA PATENT 2520330.

OPTION

LEFT VERTICAL END PANEL 27" TOP WIDTH, 21" BOTTOM WIDTH, 80" HIGH INSULATED 430

| TYPE | WIDTH | LENG | DIA | CFM | SP

8" | 36"

8" | 36"

8" | 36" |

640 | 0.183"

640 0.183"

640 | 0.183"

640 | 0.183"

640 0.183"

HOOD INTODIATION IOD #2404240

EMAIL: reg36@captiveaire.com

HOOD OPTIONS

FRONT COOK LINE

BACK COOK LINE

PERFORATED SUPPLY PLENUM(S)

FRONT COOK LINE | Front

BACK COOK LINE | Front | 156"

<u>H001</u>	<u>) INFORMATION</u>	<u>√ </u>	<u>7404748 </u>				_	_												
HOOD	TAG	″ M□DEL	MANUFACTURER	LENGTH	MAX COOKING	TYPE	APPLIANCE	DESIGN	TOTAL			F	PISER(LENUM S>			TOTAL SUPPLY	HOOD	HOOD C	
ND	THG	MODEL	MANOPACTORER	LLINGIII	TEMP	1116	DUTY	CFM/FT	EXH CFM	WIDTH	LENG	HEIGHT	DIA	CFM	VEL	SP	CFM	CONSTRUCTION	END	RDW
1	FRONT COOK LINE	5424 ND-2-PSP-F	CAPTIVEAIRE	12′ 0″	600 DEG	I	HEAVY	200	2400			4″	16″	2400	1719	-1.062"	1920	430 SS WHERE EXPOSED	ALONE	ALONE
2	BACK COOK LINE	5424 ND-2-PSP-F	CAPTIVEAIRE	12′ 0″	600 DEG	I	HEAVY	200	2400			4″	16″	2400	1719	-1.062"	1920	430 SS WHERE EXPOSED	ALONE	ALONE

					DLG							WF	IERE EXPUSED				•
HOOD	INFORMATION	V															
				FILTER	2)			LIGHT(S)					UTILITY CABINET(S)			CIDE	HOOD
HOOD	TAG					EFFICIENCY @ 7			WIRE			FI	RE SYSTEM	ELECTRICAL	SWITCHES	FIRE SYSTEM	HUUU
NΠ	TAG	TYPE	QTY	HEIGHT	LENGTH	MICRONS	QTY	TYPE	GUARD	LOCATION	SIZE	TYPE	SIZE	MODEL #	QUANTITY	PIPING	
1	FRONT COOK	CAPTRATE SOLO FILTER	9	16″	16"	85% SEE FILTER	6	RECESSED ROUND	ND	RIGHT	12"×54"×24"	TANK FS	4.0/4.0	SC-311110MA	1 LIGHT	YES	1086
•	LINE	OTH TRATE GODES TIETER			10	SPEC		KEGEGGED KEGND		RIGITI	IE XOT XET		1107 110	GG GIIIIO(III)	1 FAN		LBS
م	DACK CHEK LINE	CARTRATE COLO EN TER		16#	1.5 #	85% SEE FILTER		DECESSED DELIND	NE		10% 54% 04%	TANK FO	40/40	66 01111044	1 LIGHT	VEC	1086
ے	BACK COOK LINE	CAPTRATE SOLO FILTER	9	16"	16"	SPEC	6	RECESSED ROUND	ND	LEFT	12"×54"×24"	TANK FS	4.0/4.0	SC-311110MA	1 FAN	YES	LBS

PARTICLES FIVE MICRONS IN SIZE, AND 85% GREASE PARTICLES SEVEN MICRONS IN SIZE AND LARGER, WITH A CORRESPONDING PRESSURE DROP NOT TO EXCEED 1.0 INCHES OF WATER GAUGE. THE CAPTRATE GREASE-STOP SOLO WAS TESTED TO ASTM STANDARD ASTM F2519-05. MANUFACTURER APPROVED FOR USE IN SOLID FUEL APPLICATIONS AS A SPARK ARRESTER, PARTICLE DIAMETER (UM)

2-INCH DEEP HOOD CHANNEL(S).

COMPONENTS WHEN ASSEMBLED.

PRESSURE DROP VS. FLOW RATE FLOW RATE (CFM)

CAPTRATE FILTERS ARE BUILT IN COMPLIANCE WITH: NFPA #96. NSF STANDARD #2. UL STANDARD #1046.

SPECIFICATION: CAPTRATE GREASE-STOP SOLO FILTER

TO DELIVER EXCEPTIONAL FILTRATION EFFICIENCY.

THE CAPTRATE GREASE-STOP SOLO FILTER IS A SINGLE-STAGE FILTER FEATURING

FILTER IS STAINLESS STEEL CONSTRUCTION, AND SIZED TO FIT INTO STANDARD

A UNIQUE S-BAFFLE DESIGN IN CONJUNCTION WITH A SLOTTED REAR BAFFLE DESIGN,

GREASE EXTRACTION EFFICIENCY PERFORMANCE SHALL REMOVE AT LEAST 75% OF GREASE

UNITS SHALL INCLUDE STAINLESS STEEL HANDLES AND A FASTENING DEVICE TO SECURE THE TWO

INT. MECH. CODE (IMC). ULC-S649. GREASE DUCT & CHIMNEY SPECIFICATIONS:

PROVIDE GREASE DUCT EQUAL TO CAPTIVEAIRE SYSTEMS MODEL "DW" ROUND 20 GAUGE 430 STAINLESS STEEL DUCTWORK, INSULATED 430 CONNECTIONS SEALED WITH 3M FIRE BARRIER 2000 PLUS. MODEL "DW" DOES NOT REQUIRE WELDING PROVIDING IT HAS BEEN INSTALLED PER THE MANUFACTURES INSTALLATION GUIDE

PROVIDE RATED ACCESS DOORS AT EVERY CHANGE IN DIRECTION AND EVERY 12' ON CENTER, PER MANUFACTURES LISTING MODEL "DW" HORIZONTAL RUNS LESS THAN 75 FT. CAN BE 1/16" PER 12", HORIZONTAL RUNS MORE THAN 75 FT. CAN BE SLOPED 3/16" PER 12". SHOULD BE SLOPED AS MUCH AS POSSIBLE TO REDUCE THE CHANCE OF GREASE ACCUMULATION IN HORIZONTAL RUNS.

IF THE DUCT OR CHIMNEY IS WITHIN 18 INCHES OF COMBUSTIBLE MATERIAL, PROVIDE UL-2221 OR UL-103 HT LISTED DOUBLE WALL GREASE DUCT OR DOUBLE WALL CHIMNEY EQUAL TO CAPTIVEAIRE SYSTEMS MODEL "DW- 2R, 2R TYPE HT, 3R, OR 3Z" ROUND 20 GAUGE 430 STAINLESS INNER DUCT INSULATED WITH A 24 GAUGE 430 STAINLESS DUTER SHELL,

CAPTIVEAIRE SYSTEMS RECOMMENDS THE USE OF LISTED, PRE-FABRICATED ROUND GREASE EXHAUST DUCT TO REDUCE STATIC PRESSURE IN THE SYSTEM, MINIMIZE INSTALLATION AND INSPECTION TIMES, AND ENSURE DUCT IS LIQUID TIGHT

HVAC DISTRIBUTION NOTE

HIGH VELOCITY DIFFUSERS OR HVAC RETURNS SHOULD NOT BE PLACED WITHIN TEN (10) FEET OF THE EXHAUST HOOD, PERFORATED DIFFUSERS ARE RECOMMENDED.

VERIFY CEILING HEIGHT

HEIGHT REQUIRED TO VERIFY THAT HOOD FITS SPACE AND TO SIZE THE ENCLOSURE PANELS

CUSTOMER APPROVAL TO MANUFACTURE:

APPROVED WITH NO EXCEPTION TAKEN REVISE AND RESUBMIT SIGNATURE YOUR TITLE _

REVISIONS

 \mathcal{M} \bigcap ANGIE

DATE: 3/14/2025

7404748

DWG.#:


DRAWN REG 36


SCALE: 3/4" = 1'-0"

MASTER DRAWING

1" LAYER OF INSULATION FACTORY INSTALLED IN INTERNAL BACK STANDOFF. _ MEETS 0 INCH REQUIREMENTS FOR CLEARANCE TO COMBUSTIBLE SURFACES.

<u>PLAN VIEW - HOOD #1 (FRONT COOK LINE)</u> 12' 0.00" LONG 5424ND-2-PSP-F
NOTE: ADDITIONAL HANGING ANGLES PROVIDED FOR HOODS 12' AND LONGER.

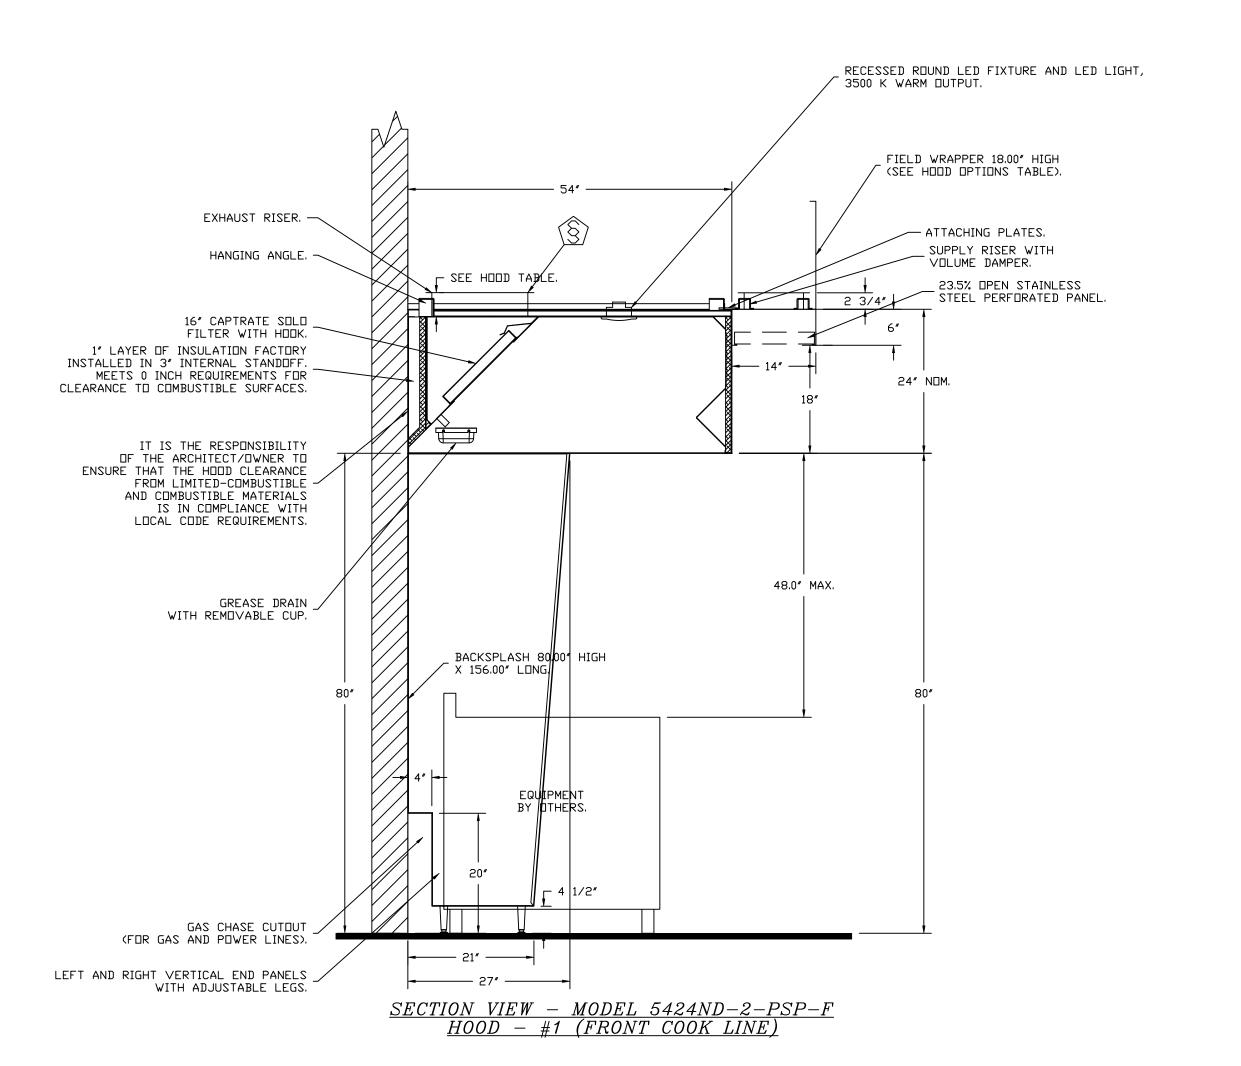

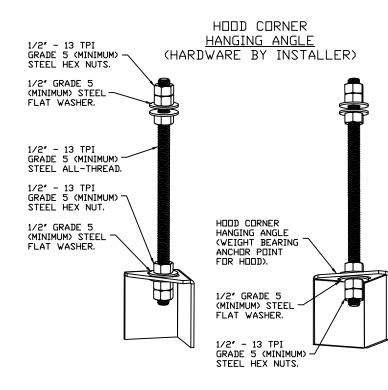

ASSEMBLY INSTRUCTIONS

HANGING ANGLE MUST BE SUPPORTED WITH 1/2" - 13 TPI GRADE 5 (MINIMUM) ALL-THREAD, SANDWICH HANGING ANGLES AND CEILING ANCHOR POINTS WITH 1/2" GRADE 5 (MINIMUM) STEEL FLAT WASHERS AND 1/2" - 13 TPI GRADE 5 (MINIMUM) HEX NUTS AS SHOWN, MUST USE DOUBLED HEX NUT CONFIGURATION BENEATH HODD HANGING ANGLES AND ABOVE CEILING ANCHORS, MAINTAIN 1/4" OF EXPOSED THREADS BENEATH BOTTOM HEX NUT. TORQUE ALL HEX NUTS TO 57 FT-LBS.

REVISIONS DESCRIPTION DATE:


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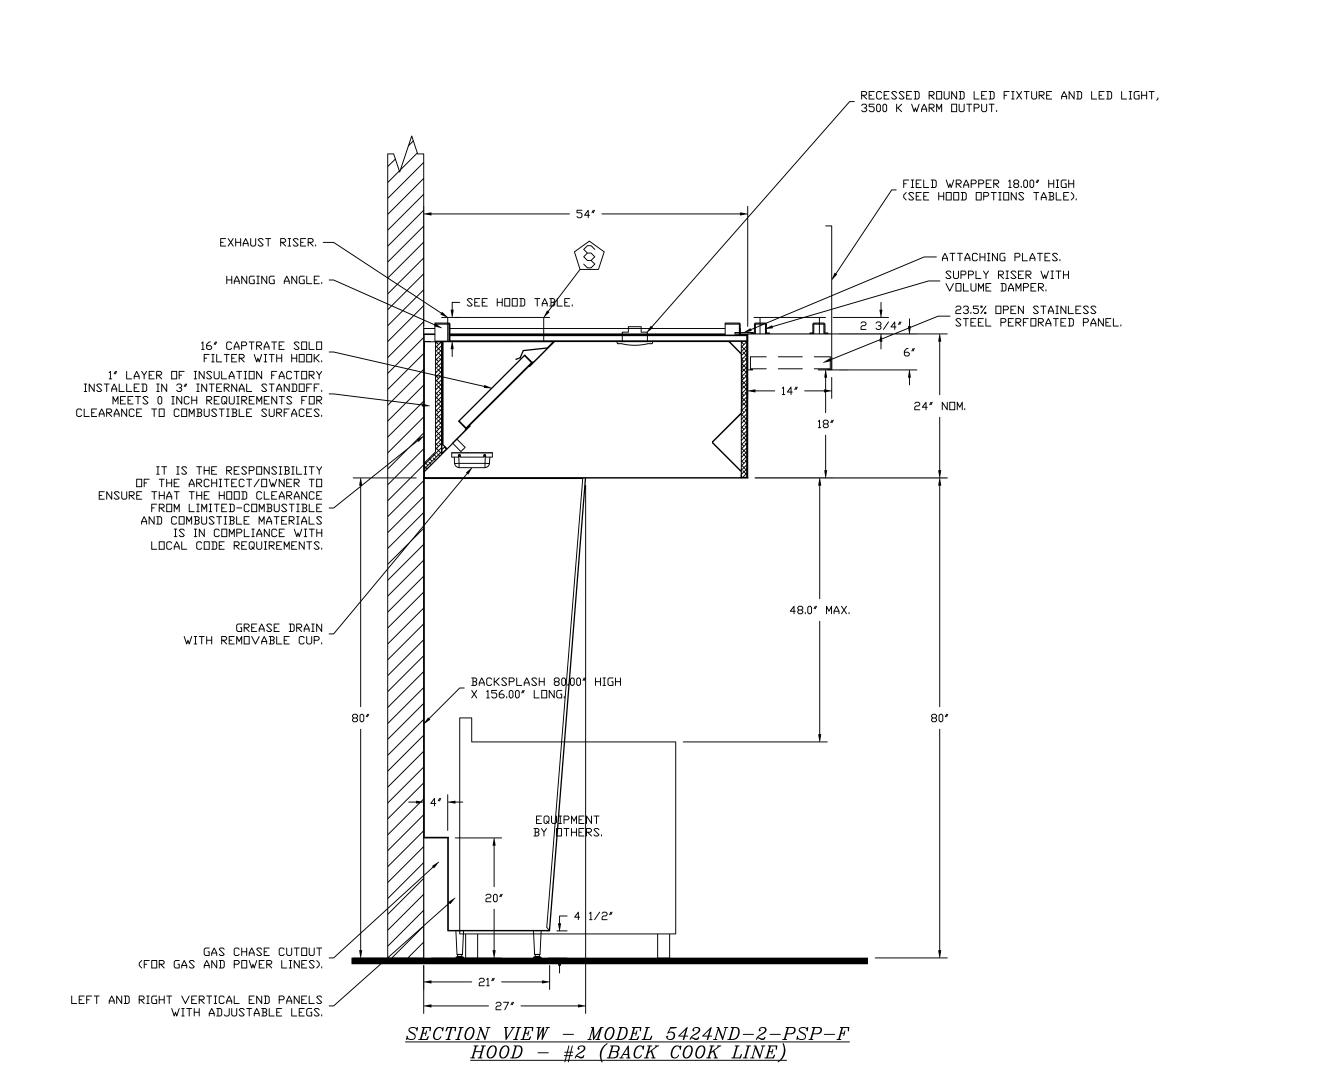
DATE: 3/14/2025 DWG.#:

7404748 DRAWN BY: REG 36

SCALE: 3/4" = 1'-0"

MASTER DRAWING



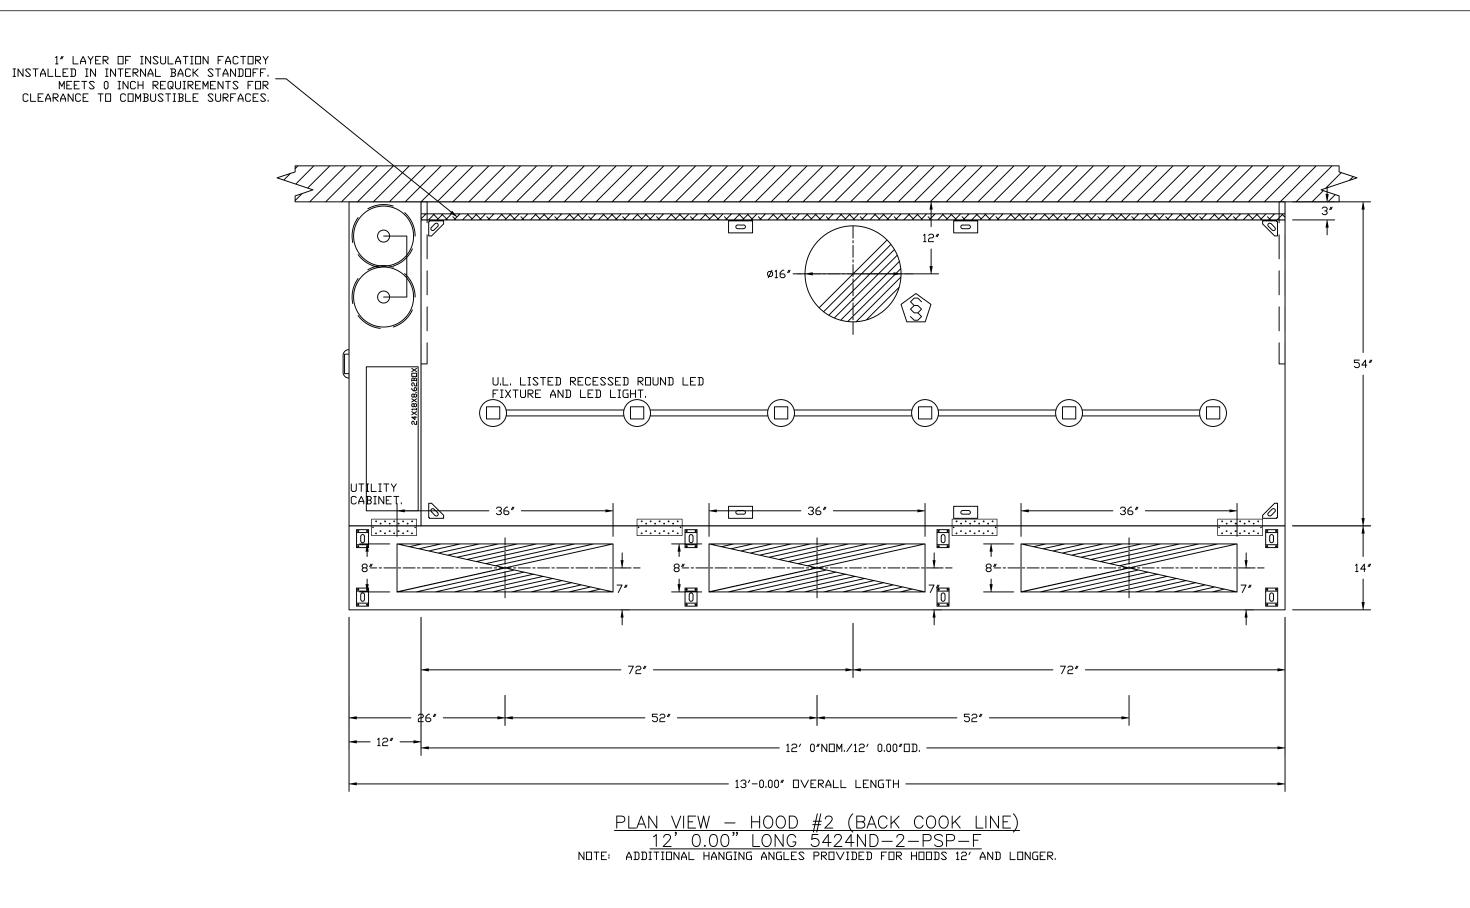

Eastern North Carolina

4641 Paragon Park Rd., Raleigh, NC, 27616 PHONE: (919) 825 - 3566 FAX: 9192275917 EMAIL: reg36@captiveaire.com

REVISIONS
DESCRIPTION DATE:

Daddy D's BBQ – Angier ANGIER, NC, 27501


DWG.#: 7404748

DATE: 3/14/2025

DRAWN REG 36

SCALE: 3/4" = 1'-0"

MASTER DRAWING

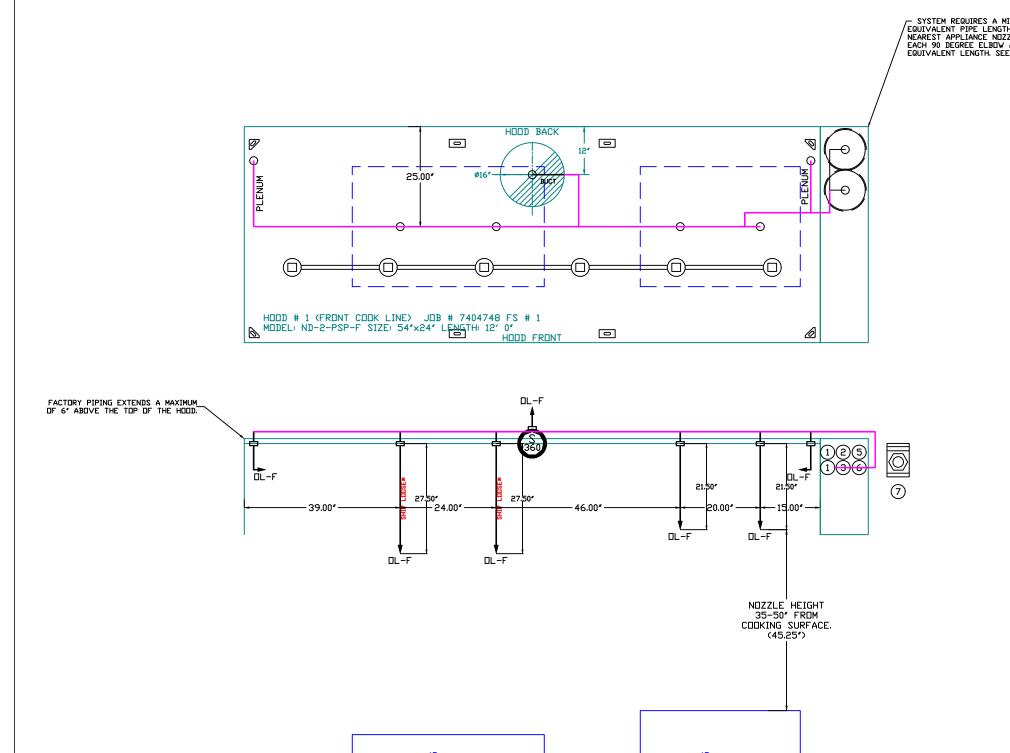

NOTES
- FIELD PIPE DROPS AS SHOWN
PIPING, ELBOWS, TEES, AND NOZZLES SUPPLIED BY CAS.
- FIELD INSTALLED DROP: FACTORY WILL PROVIDE QTY 2 60IN LONG PIECES OF CHROME
PLATED PIPING SHIPPED LODSE TO BE FIELD-INSTALLED.
- SHIP LODSE DROP: FACTORY WILL PROVIDE THE EXACT CHROME PIPE LENGTH NEEDED
SHIPPED LODSE TO BE FIELD-INSTALLED.
- RELOCATE NOZZLES IF FLOW PATTERN IS BLOCKED BY SHELVING,
SALAMANDERS, ETC.
- OVERLAPPING COVERAGE SHALL NOT BE USED ON ANY APPLIANCE WITH AN OBSTRUCTION.
- IF APPLICABLE, EXTENDED PRE-PIPED DROPS ARE SHIPPED LODSE.
- FACTORY PIPING EXTENDS A MAXIMUM OF 6" ABOVE THE TOP OF THE HOOD.

- APPLIANCE DIMENSIONS LISTED REPRESENT THE COOKING SURFACE SIZE, NOT THE OVERALL APPLIANCE SIZE.

- THIS PRE-ENGINEERED FIRE SYSTEM COMPLIES WITH U.L. 300 REQUIREMENTS.

- DL-F NDZZLE PART NUMBER REPLACES 3070-3/8H-10-SS

JOB #: 7404748. JOB NAME: DADDY D'S BBQ - ANGIER.

SYSTEM SIZE: TANK-SP-2 DESIGN FP: 32. MAXIMUM FP: 40. HODD # 1 12' 0.00" LONG × 54" WIDE × 24" HIGH. RISER # 1 SIZE: 16" DIA. HODD # 1 METAL BLOW-OFF CAPS INCLUDED.

- HEAVY-DUTY APPLIANCES (RATED 600°F) WILL REQUIRE AN ADDITIONAL DOWNSTREAM FIRESTAT IN THE EVENT THAT THE DUCTWORK CONTAINS ANY HORIZONTAL RUNS OVER 25 FT IN LENGTH. - MEDIUM TO LIGHT-DUTY APPLIANCES (RATED 450°F) WILL NOT REQUIRE ANY ADDITIONAL DOWNSTREAM DETECTION.

AGENT DISTRIBUTION PIPING LIMIT	ATIONS
PIPE SECTION	MAX PIPE LENGTH (FT)
MAX SUPPLY LINE TO FIRST OVERLAPPING NOZZLE	42
OVERLAPPING NOZZLE APPLIANCE BRANCH	10
DEDICATED NOZZLE APPLIANCE BRANCH	10

<u>LEGEND - FIRE CABINET TANK SYSTEM</u>

4 GALLON TANK.

PRIMARY ACTUATOR RELEASE. SECONDARY ACTUATOR RELEASE.

PRESSURE SUPERVISION SWITCH. PRIMARY HOSE ASSEMBLY.

REMOTE MANUAL ACTUATION DEVICE.

SECONDARY HOSE ASSEMBLY.

UL 300 HOOD FIRE SUPPRESSION SYSTEM TANK/CAS ELECTRIC WET CHEMICAL

The TANK / CAS-EWC Fire Suppression System has been tested and certified to the UL 1254 Standard for Pre-Engineered Chemical Extinguishing System Units and UL/ULC 300 Standard for Fire Extinguishing Systems for Protection of Commercial Cooking Equipment and is listed with Underwriters Laboratories (UL) under file number EX3559.

SEQUENCE OF OPERATIONS
The TANK / CAS-EWC fire system is a self-contained pressurized fire suppression system. TANK / CAS-EWC is activated when the electric firestat contacts close (at determined firestat setting and/or temperature rate-of-rise of 40°F per minute) and/or the manual activation station is pushed, an electric signal is sent to the release solenoid of the fire system. When the release solenoid is opened, it allows stored pressure from the primary tank to travel through the primary actuator kit opening a pneumatic actuator. The pneumatic actuator forces the plunger in the tank valve body to open, allowing the liquid fire suppressant to be distributed throughout the fire system piping network over the protected hazard area.

CAPTIVE-AIRE HOODS ARE BUILT IN COMPLIANCE WITH:



UL 710 & ULC710 STANDARDS E.T.L. LISTED 3054804-001

FOR QUESTIONS EASTERN NORTH CAROLINA PHONE: (919) 825-3566 EMAIL: REG36@CAPTIVEAIRE.COM

REVISIONS DESCRIPTION DATE:


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DATE: 3/14/2025 DWG.#:

7404748 DRAWN BY: REG 36

SCALE:

1/2" = 1'-0" **MASTER DRAWING**

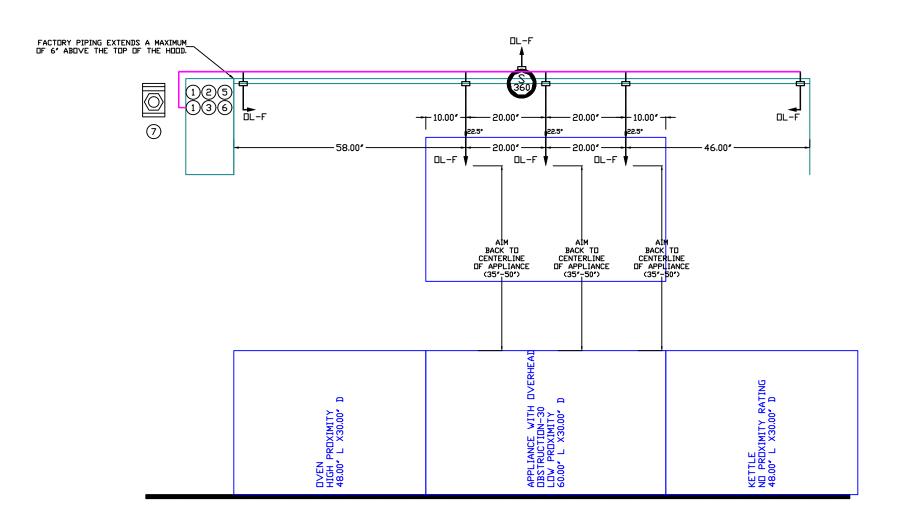

- NOTES
 FIELD PIPE DROPS AS SHOWN
 PIPING, ELBOWS, TEES, AND NOZZLES SUPPLIED BY CAS.
 FIELD INSTALLED DROP: FACTORY WILL PROVIDE QTY 2 60IN LONG PIECES OF CHROME
 PLATED PIPING SHIPPED LOOSE TO BE FIELD-INSTALLED.
 SHIP LOOSE DROP: FACTORY WILL PROVIDE THE EXACT CHROME PIPE LENGTH NEEDED
 SHIPPED LOOSE TO BE FIELD-INSTALLED.
 RELOCATE NOZZLES IF FLOW PATTERN IS BLOCKED BY SHELVING,
 SALAMANDERS, ETC.
 OVERLAPPING COVERAGE SHALL NOT BE USED ON ANY APPLIANCE WITH AN OBSTRUCTION.
 IF APPLICABLE, EXTENDED PRE-PIPED DROPS ARE SHIPPED LOOSE.
 FACTORY PIPING EXTENDS A MAXIMUM OF 6" ABOVE THE TOP OF THE HOOD.

- APPLIANCE DIMENSIONS LISTED REPRESENT THE COOKING SURFACE SIZE, NOT THE OVERALL APPLIANCE SIZE.
- THIS PRE-ENGINEERED FIRE SYSTEM COMPLIES WITH U.L. 300 REQUIREMENTS.
- DL-F NDZZLE PART NUMBER REPLACES 3070-3/8H-10-SS

JOB #: 7404748. JOB NAME: DADDY D'S BBQ - ANGIER.

SYSTEM SIZE: TANK-SP-2 DESIGN FP: 24. MAXIMUM FP: 40. HDDD # 2 12' 0.00" LDNG × 54" WIDE × 24" HIGH. RISER # 1 SIZE: 16" DIA.

HOOD # 2 METAL BLOW-OFF CAPS INCLUDED.

- HEAVY-DUTY APPLIANCES (RATED 600°F) WILL REQUIRE AN ADDITIONAL DOWNSTREAM FIRESTAT IN THE EVENT THAT THE DUCTWORK CONTAINS ANY HORIZONTAL RUNS OVER 25 FT IN LENGTH.

- MEDIUM TO LIGHT-DUTY APPLIANCES (RATED 450°F) WILL NOT REQUIRE ANY ADDITIONAL DOWNSTREAM DETECTION.

AGENT DISTRIBUTION PIPING LIMIT	ZNOITA
PIPE SECTION	MAX PIPE LENGTH (FT)
MAX SUPPLY LINE TO FIRST OVERLAPPING NOZZLE	42
OVERLAPPING NOZZLE APPLIANCE BRANCH	10
DEDICATED NOZZLE APPLIANCE BRANCH	10

<u>LEGEND - FIRE CABINET TANK SYSTEM</u>

- 4 GALLON TANK. PRIMARY ACTUATOR RELEASE.
 SECONDARY ACTUATOR RELEASE.
- PRESSURE SUPERVISION SWITCH, PRIMARY HOSE ASSEMBLY.
- SECONDARY HOSE ASSEMBLY. REM□TE MANUAL ACTUATION DEVICE.

UL 300 HOOD FIRE SUPPRESSION SYSTEM TANK/CAS ELECTRIC WET CHEMICAL

The TANK / CAS-EWC Fire Suppression System has been tested and certified to the UL 1254 Standard for Pre-Engineered Chemical Extinguishing System Units and UL/ULC 300 Standard for Fire Extinguishing Systems for Protection of Commercial Cooking Equipment and is listed with Underwriters Laboratories (UL) under file number EX3559.

- SYSTEM REQUIRES A MINIMUM DF 7 FT DF EQUIVALENT PIPE LENGTH BETWEEN TANK AND NEAREST APPLIANCE NDIZLE FOR MOST APPLIANCES. EACH 90 DEGREE ELBOW ADDS 1.3 FT DF EQUIVALENT LENGTH. SEE MANUAL FOR DETAILS

SEQUENCE OF OPERATIONS
The TANK / CAS-EWC fire system is a self-contained pressurized fire suppression system. TANK / CAS-EWC is activated when the electric firestat contacts close (at determined firestat setting and/or temperature rate-of-rise of 40°F per minute) and/or the manual activation station is pushed, an electric signal is sent to the release solenoid of the fire system. When the release solenoid is opened, it allows stored pressure from the primary tank to travel through the primary actuator kit opening a pneumatic actuator. The pneumatic actuator forces the plunger in the tank valve body to open, allowing the liquid fire suppressant to be distributed throughout the fire system piping network over the protected hazard area.

CAPTIVE-AIRE HOODS ARE BUILT IN COMPLIANCE WITH:



FOR QUESTIONS
CONTACT: REGION 36 EASTERN NORTH CAROLINA PHONE: (919) 825-3566 EMAIL: REG36@CAPTIVEAIRE.COM

REVISIONS

DESCRIPTION DATE:

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DATE: 3/14/2025

7404748

DRAWN BY: REG 36

SCALE: 1/2" = 1'-0"

MASTER DRAWING

EXH.	AUST	FAN	INFORMATION - JOB#74	04748												
FAN UNIT NO	TAG	QTY	FAN UNIT MODEL #	MANUFACTURER	CFM	ESP	RPM	MOTOR ENCL	HP	BHP	PHASE	VOLT	FLA	DISCHARGE VELOCITY	WEIGHT (LBS)	SONE:
1	KEF-1	1	DU180HFA	CAPTIVEAIRE	2400	1.300	1156	DDP,PREMIUM	2.000	1.0790	3	208	6.1	554 FPM	159	13.8
2	KEF-2	1	DU180HFA	CAPTIVEAIRE	2400	1.300	1156	DDP,PREMIUM	2.000	1.0790	3	208	6.1	554 FPM	159	13.8

MUA	FAN	INFO	RMATION	_	J0B#7404748	
FAN						

FAN UNIT ND	TAG Q	YTÇ	FAN UNIT MODEL #	BLOWER	HDUSING	MIN CFM	DESIGN CFM	ESP	RPM	MOTOR ENCL	HP	BHP	PHASE	VOLT	FLA	MCA	МПСР	WEIGHT (LBS)	SONES
3	KMUA-1	1	A1-15D	15MF-1-MDD	A1	-	1920	0.500	1788	DDP,PREMIUM	1.500	0.9080	3	208	4.4	5.5A	15A	287	22.8
4	KMUA-2	1	A1-15D	15MF-1-MDD	A1	-	1920	0.500	1788	DDP,PREMIUM	1.500	0.9080	3	208	4.4	5.5A	15A	287	22.8

FAN OPTIONS

FAN UNIT NO	TAG	QTY	DESCRIPTION
1	KEF-1	1	GREASE BOX
1	KEr -1	1	2 YEAR PARTS WARRANTY
٥	KEF-2	1	GREASE BOX
	KEF-E	1	2 YEAR PARTS WARRANTY
3	KMUA-1	1	SIZE 1 UNTEMPERED COMMERCIAL DOWN DISCHARGE FOR DIRECT DRIVE AHUS
3	KMOH-1	1	2 YEAR PARTS WARRANTY
4	KMUA-2	1	SIZE 1 UNTEMPERED COMMERCIAL DOWN DISCHARGE FOR DIRECT DRIVE AHUS
4	NMUA-Z	1	2 YEAR PARTS WARRANTY


FAN ACCESSORIES


FAN UNIT	TAC		EXHAUST		SUPF	°LY	
ND	TAG	GREASE CUP	GRAVITY DAMPER	SIDE DISCHARGE	GRAVITY DAMPER	MOTORIZED DAMPER	WALL MOUNT
1	KEF-1	YES					
2	KEF-2	YES					
3	KMUA-1						
4	KMUA-2						

CURB ASSEMBLIES

ND	□N FAN	TAG	WEIGHT	ITEM	SIZE
1	# 1	KEF-1	43 LBS	CURB	26.500"W X 26.500"L X 20.000"H VENTED HINGED.
2	# 2	KEF-2	43 LBS	CURB	26.500"W X 26.500"L X 20.000"H VENTED HINGED.
3	# 3	KMUA-1	29 LBS	CURB	21.000"W X 21.000"L X 14.000"H.
4	# 4	KMUA-2	29 LBS	CURB	21.000"W X 21.000"L X 14.000"H.

FANS #1 (KEF-1), #2 (KEF-2) - DU180HFA EXHAUST FAN

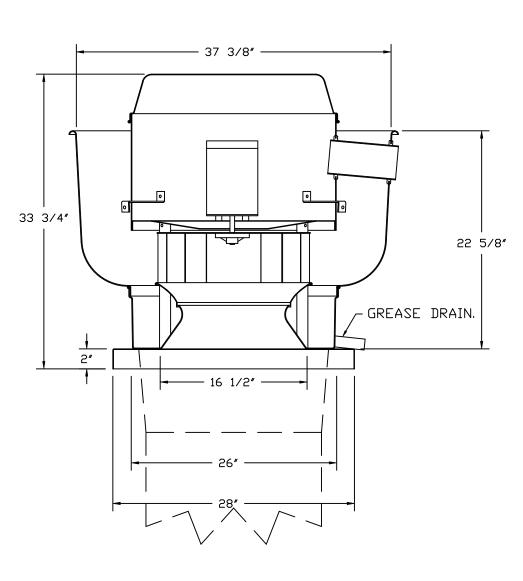

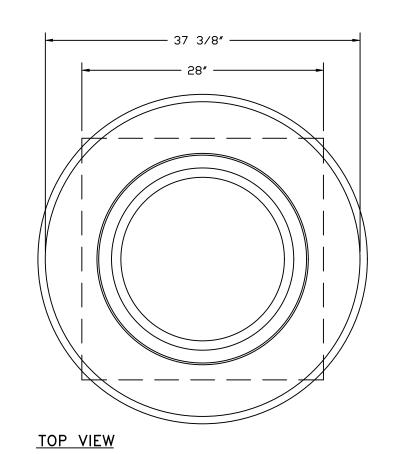

FEATURES:

- DIRECT DRIVE CONSTRUCTION (NO BELTS/PULLEYS).
- ROOF MOUNTED FANS. - RESTAURANT MODEL.
- UL705 AND UL762 AND ULC-S645
- VARIABLE SPEED CONTROL.
- INTERNAL WIRING. - THERMAL OVERLOAD PROTECTION (SINGLE PHASE).
- HIGH HEAT OPERATION 300°F (149°C). - GREASE CLASSIFICATION TESTING.
- NEMA 3R SAFETY DISCONNECT SWITCH.

NORMAL TEMPERATURE TEST


- EXHAUST FAN MUST OPERATE CONTINUOUSLY WHILE EXHAUSTING AIR AT 300°F (149°C) UNTIL ALL FAN PARTS HAVE REACHED
- THERMAL EQUILIBRIUM, AND WITHOUT ANY DETERIORATING EFFECTS TO THE FAN WHICH WOULD CAUSE UNSAFE OPERATION.

ABNORMAL FLARE-UP TEST EXHAUST FAN MUST OPERATE CONTINUOUSLY WHILE EXHAUSTING BURNING GREASE VAPORS

AT 600°F (316°C) FOR A PERIOD OF 15 MINUTES WITHOUT THE FAN BECOMING DAMAGED TO ANY EXTENT THAT COULD CAUSE AN UNSAFE CONDITION.

<u>OPTIONS</u>

- GREASE BOX. - 2 YEAR PARTS WARRANTY.

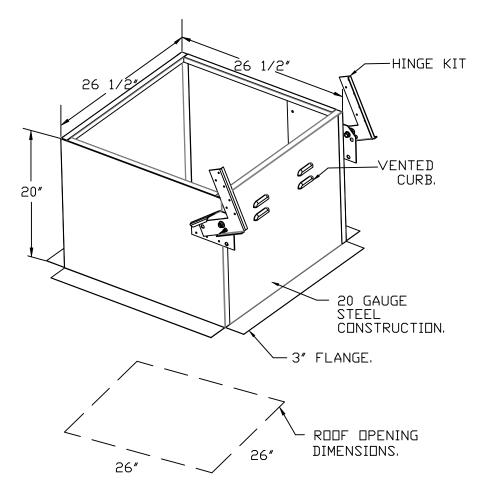

REVISIONS

Angier 27501 BBQ), S ANGIER, Daddy

DATE: 3/14/2025 **DWG.#:** 7404748

DRAWN BY: REG 36

SCALE: 3/4" = 1'-0"

MASTER DRAWING

FANS #3 (KMUA-1), #4 (KMUA-2) - A1-15D SUPPLY FAN

1. UNTEMPERED SUPPLY UNIT WITH 15" MIXED FLOW DIRECT DRIVE FAN IN SIZE #1 HOUSING.

2. INTAKE HOOD WITH EZ FILTERS.

3. DOWN DISCHARGE - AIR FLOW RIGHT -> LEFT.


4. DOWN DISCHARGE CONSTRUCTION FOR SIZE 1 UNTEMPERED DIRECT DRIVE AHUS.


5. HINGED DOUBLE WALL INSULATED DOOR ASSEMBLY (BURNER/BLOWER SECTION).


6. 2 YEAR PARTS WARRANTY.


*NOTE: SUPPLY DUCT MUST BE INSTALLED TO MEET SMACNA STANDARDS. A MINIMUM STRAIGHT DUCT LENGTH MUST BE MAINTAINED DOWNSTREAM OF UNIT DISCHARGE AS OUTLINED IN AMCA PUBLICATION 201. WHEN USING RECTANGULAR DUCTWORK, ELBOWS MUST BE RADIUS THROAT, RADIUS BACK WITH TURNING VANES. FLEXIBLE DUCTWORK AND SQUARE THROAT/SQUARE BACK ELBOWS SHOULD NOT BE USED. ANY TRANSITION AND/OR TURNS IN THE DUCTWORK WILL CAUSE SYSTEM EFFECT. SYSTEM EFFECT WILL DRASTICALLY INCREASE STATIC PRESSURE AND REDUCE AIRFLOW. DO NOT RELY ON UNIT TO SUPPORT DUCT IN ANY WAY. FAILURE TO PROPERLY SIZE DUCTWORK MAY CAUSE SYSTEM EFFECTS AND REDUCE PERFORMANCE OF THE EQUIPMENT. SUGGESTED STRAIGHT DUCT SIZE IS 14" × 14".



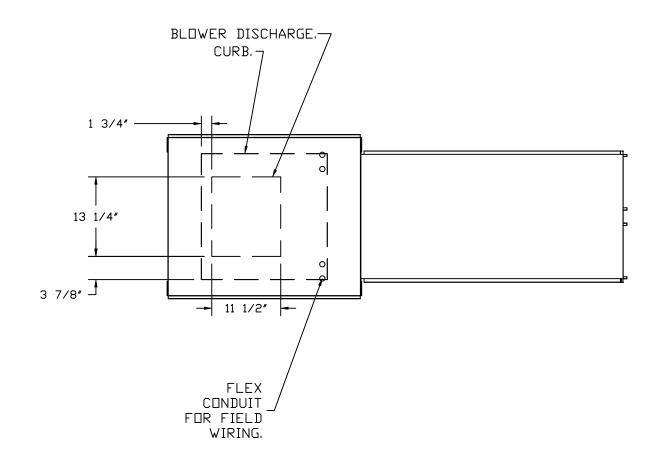

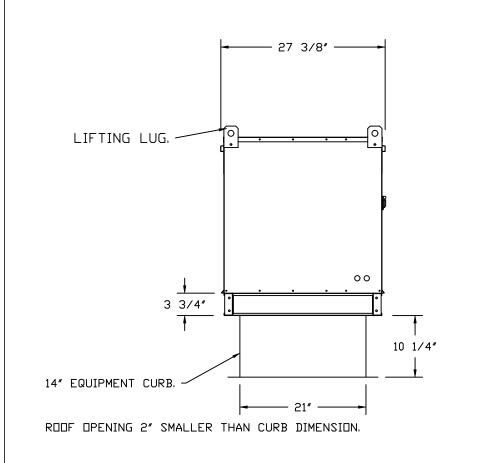

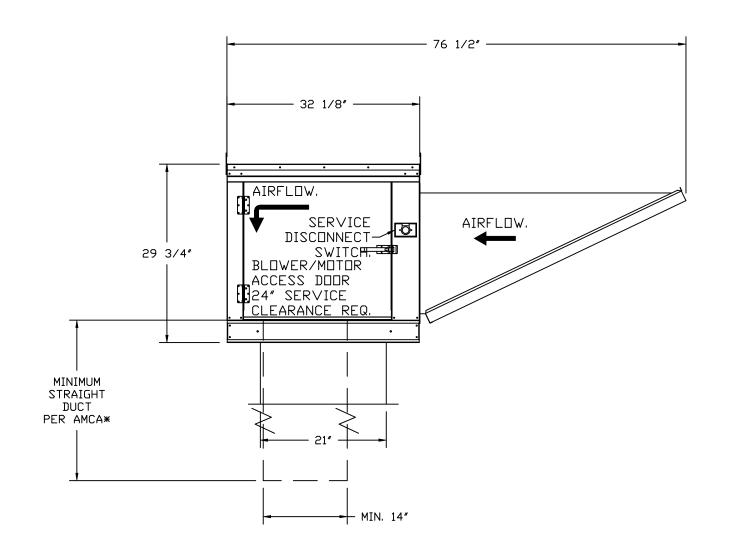

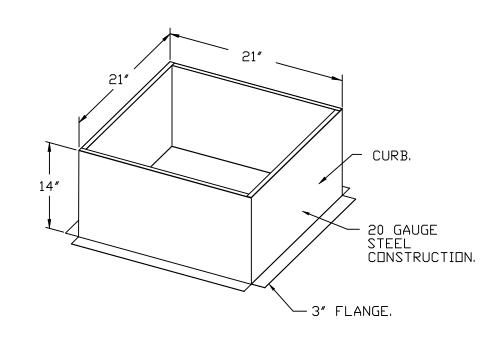

Q - Angier 7501 Easte

REVISIONS
DESCRIPTION DATE:


Daddy D's BBQ – Angler ANGIER, NC, 27501


DATE: 3/14/2025
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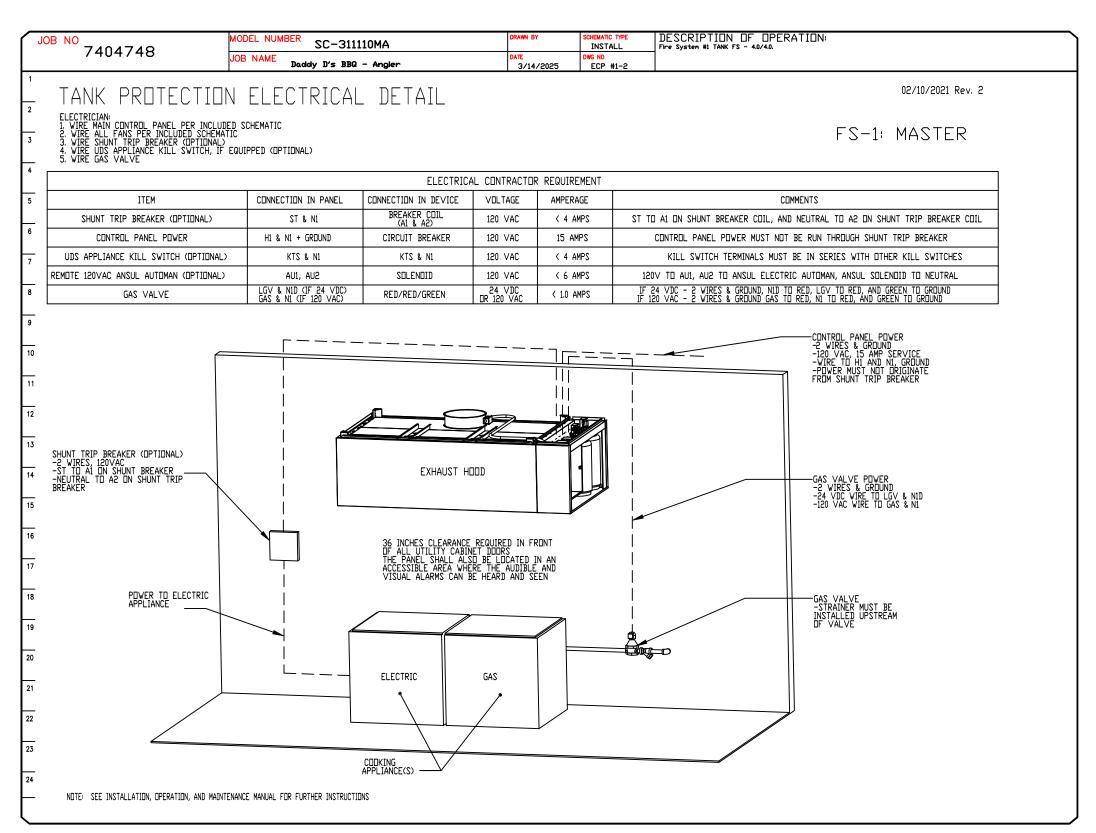
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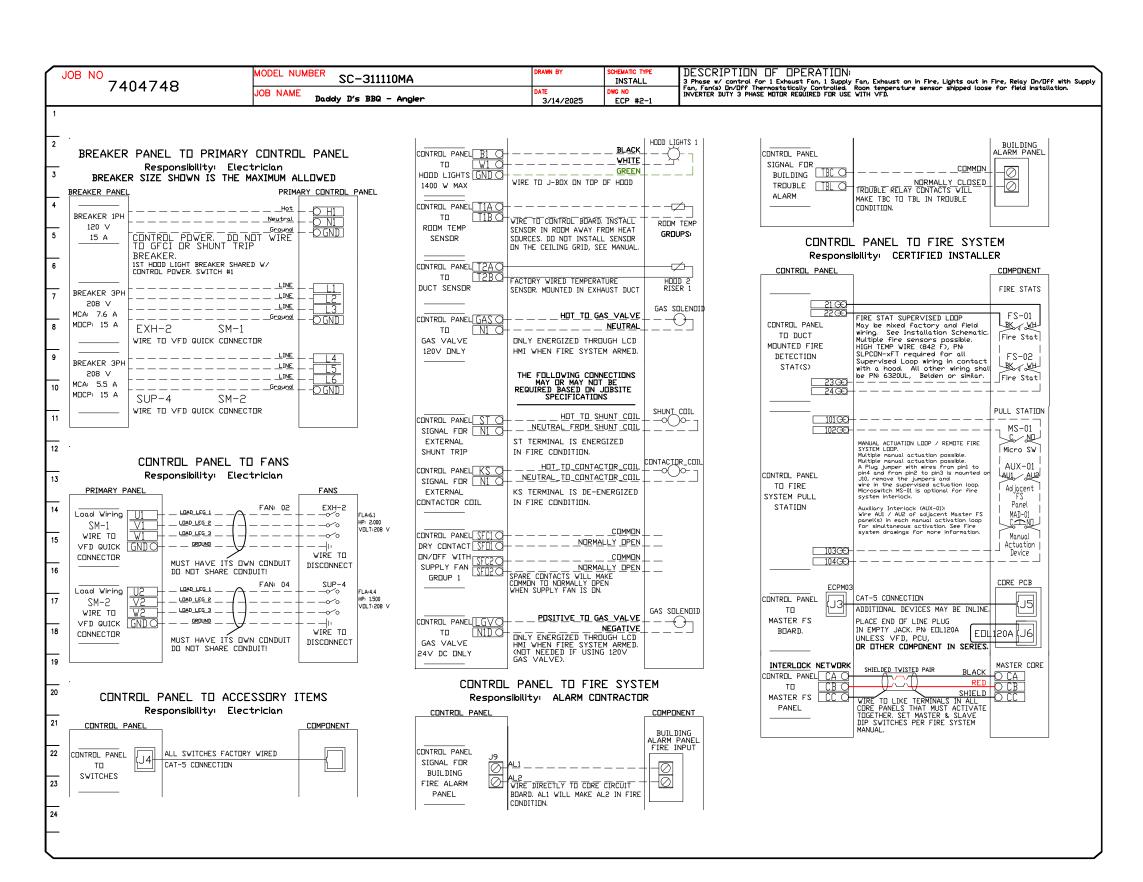
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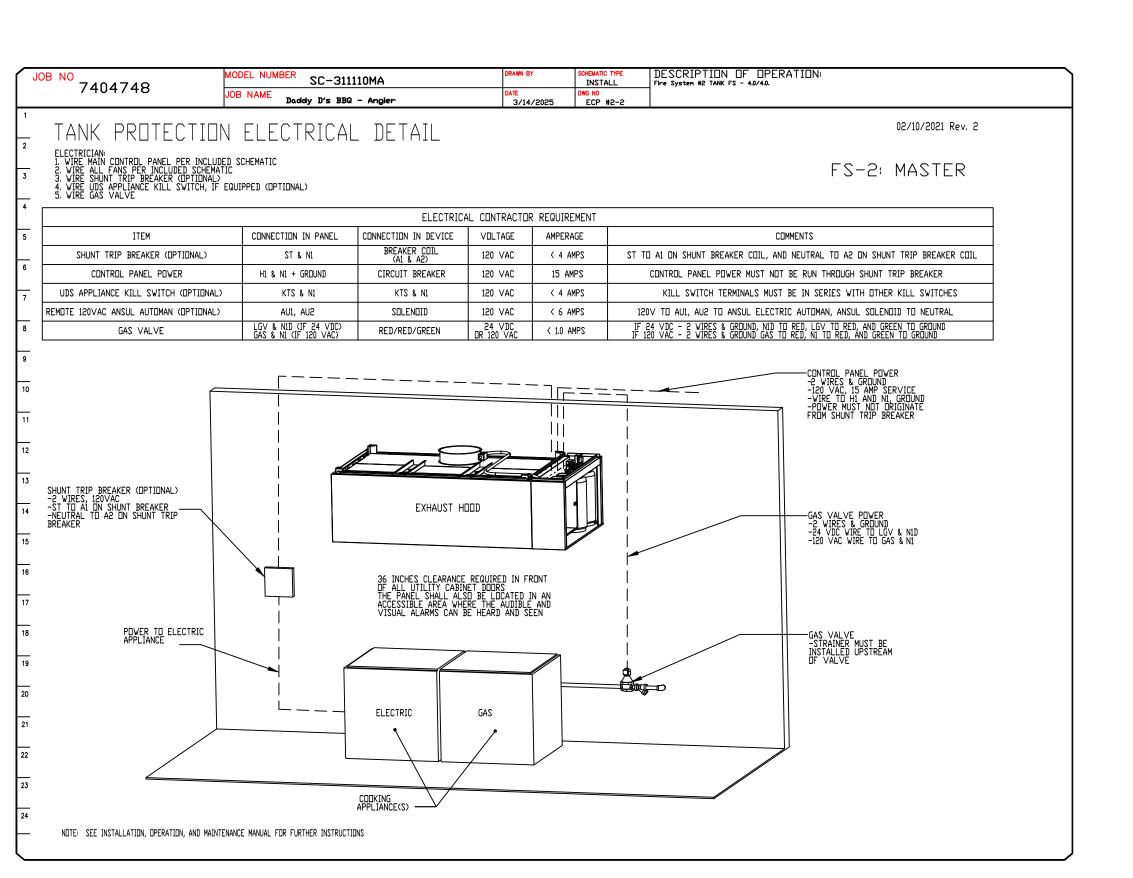
SCALE: 3/4" = 1'-0"MASTER DRAWING







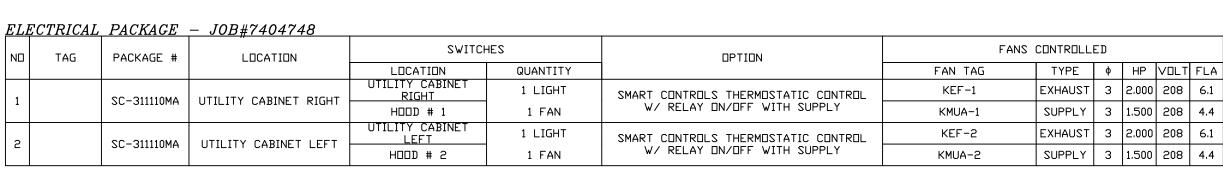

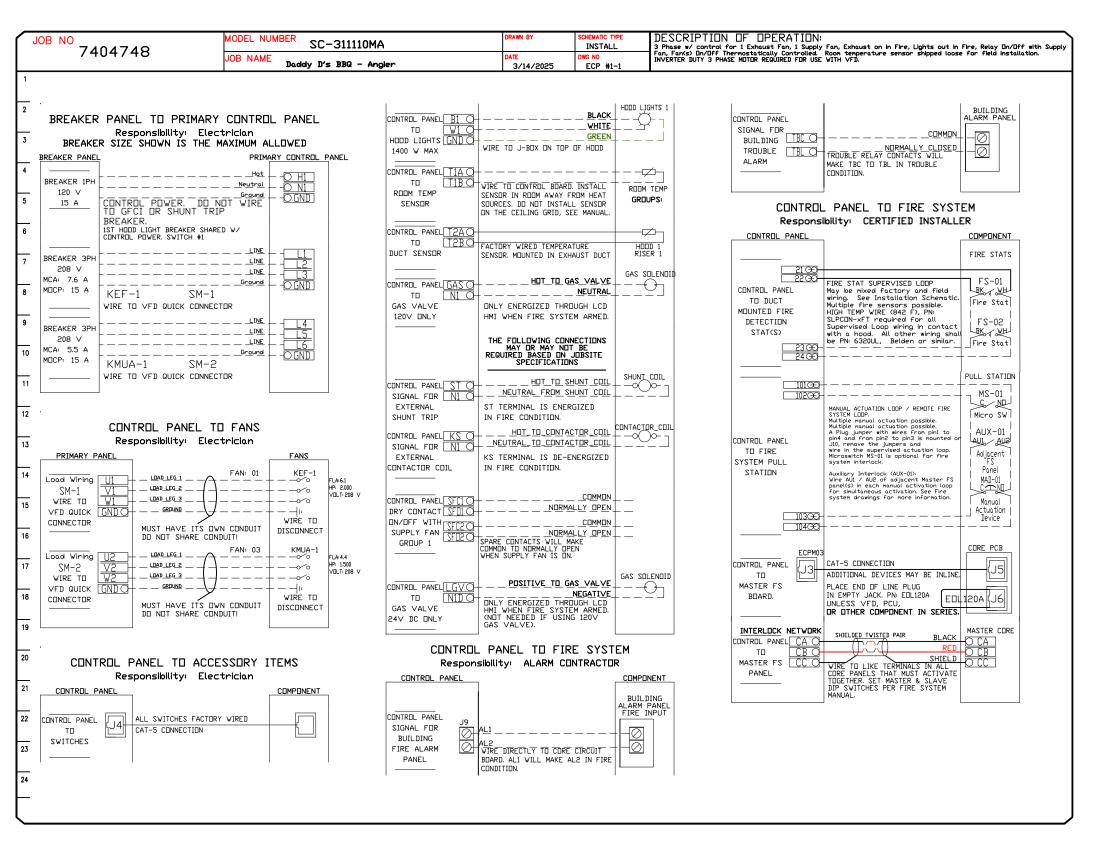



REVISIONS

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DATE: 3/14/2025

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SCALE: 3/4" = 1'-0"

MASTER DRAWING

DUCTWORK	#1	PARTS	_	J0B#7404748	
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						DUCTW	ORK #1	PARTS	- ,	J0B#7404748
TAG	PART #	CFM	GPM	ZONE (COVEREDBY	SP	WEIGHT	VELOCITY	QTY	Y DESCRIPTION
P1	DW1647LT	2400				-0.0181	24.89	1718.87	1	SINGLE WALL DUCT 16" DIAMETER, 47" LONG, FLANGE AT BOTH ENDS. STAINLESS STEEL.
P2	DW1645ASY	2400				-0.0331	7.22	1718.87	1	SINGLE WALL DUCT 45 DEGREE ELBOW, 16" DUCT, ASSEMBLY.
P3	DW1607LT	2400				-0.0027	4.14	1718.87	1	SINGLE WALL DUCT 16" DIAMETER, 7" LONG, FLANGE AT BOTH ENDS. STAINLESS STEEL.
P4	DW1618AJDKIT	2400				-0.0042	13.19	1718.87	1	SINGLE WALL DUCT ADJUSTABLE, 16" DIAMETER, 17.5" LONG, FLANGE AT ONE END WITH A 16" ADJUSTABLE COLLAR - STAINLESS STEEL.
P5	DW16SUBRASY						3.18		1	DUCT SUPPORT BRACKET KIT, 16" DUCT, USED FOR HANGING DUCT. 12 GA STEEL, CLEAR ZINC COATING 2 RINGS, 4 BRACKETS, & HARDWARE BAG 2.
P6	DW1645ASY	2400				-0.069	7.22	1718.87	1	SINGLE WALL DUCT 45 DEGREE ELBOW, 16" DUCT, ASSEMBLY.
P7 ASSEMBLED W/P8	DW1648AJDKIT	2400				-0.0141	30.39	1718.87	1	SINGLE WALL DUCT ADJUSTABLE, 16" DIAMETER, 47.5" LONG, FLANGE AT ONE END WITH A 16" ADJUSTABLE COLLAR - STAINLESS STEEL.
P8 ASSEMBLED W/P7 □=B	DW2616TP	2400					11.62	1718.87	1	DUCT TO CURB TRANSITION, 26-1/2" CURB TO 16" DUCT, 16 GA ALUMINIZED. USED ON BDU18.
SYSTEM AT P8						-1.2032	0.00			
	3M-2000PLUS						0.80		2	DUCT - 3M FIRE BARRIER 2000 PLUS SILICONE - USED AS SEALANT TO SEAL DUCT JOINTS.
	DW16CLASY						1.18		6	DUCT "V" CLAMP WITH NEW DESIGN 14 GA BRACKETS, 16" DUCT, ASSEMBLY.
TOTAL WEIGHT							110.53			

DUCTWORK #1 FRONT VIEW

P7

50″MAX 45″ 12.5″MIN



Angier 27501 ANGIER, DATE: 3/14/2025

BBQ 5,0 Daddy

DW**©.#** 7404748

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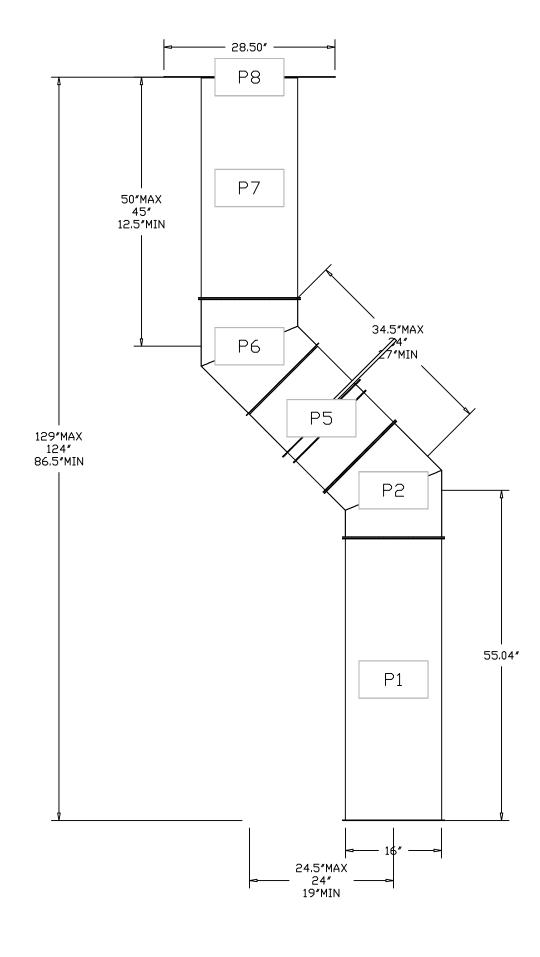
SCALE: 3/4" = 1'-0"

MASTER DRAWING

DUCTWORK #2 PARTS - JOB#7404748

TAG	PART #	CFM	GPM	ZONE COVEREDBY	SP	WEIGHT	VELOCITY	QTY	DESCRIPTION
P1	DW1647LT	2400			-0.0181	24.89	1718.87	1	SINGLE WALL DUCT 16" DIAMETER, 47" LONG, FLANGE AT BOTH ENDS. STAINLESS STEEL.
P2	DW1645ASY	2400			-0.0331	7.22	1718.87	1	SINGLE WALL DUCT 45 DEGREE ELBOW, 16" DUCT, ASSEMBLY.
P3	DW1607LT	2400			-0.0027	4.14	1718.87	1	SINGLE WALL DUCT 16" DIAMETER, 7" LONG, FLANGE AT BOTH ENDS. STAINLESS STEEL.
P4	DW1618AJDKIT	2400			-0.0042	13.19	1718.87		SINGLE WALL DUCT ADJUSTABLE, 16" DIAMETER, 17.5" LONG, FLANGE AT ONE END WITH A 16" ADJUSTABLE COLLAR - STAINLESS STEEL.
P5	DW16SUBRASY					3.18			DUCT SUPPORT BRACKET KIT, 16" DUCT, USED FOR HANGING DUCT. 12 GA STEEL, CLEAR ZINC COATING 2 RINGS, 4 BRACKETS, & HARDWARE BAG 2.
P6	DW1645ASY	2400			-0.069	7.22	1718.87	1	SINGLE WALL DUCT 45 DEGREE ELBOW, 16" DUCT, ASSEMBLY.
P7 ASSEMBLED W/P8	DW1648AJDKIT	2400			-0.0141	30.39	1718.87		SINGLE WALL DUCT ADJUSTABLE, 16" DIAMETER, 47.5" LONG, FLANGE AT ONE END WITH A 16" ADJUSTABLE COLLAR - STAINLESS STEEL.
P8 ASSEMBLED W/P7 □=B	DW2616TP	2400				11.62	1718.87	1	DUCT TO CURB TRANSITION, 26-1/2" CURB TO 16" DUCT, 16 GA ALUMINIZED. USED ON BDU18.
SYSTEM AT P8					-1.2032	0.00			
	3M-2000PLUS					0.80		2	DUCT - 3M FIRE BARRIER 2000 PLUS SILICONE - USED AS SEALANT TO SEAL DUCT JOINTS.
	DW16CLASY					1.18		6	DUCT "V" CLAMP WITH NEW DESIGN 14 GA BRACKETS, 16" DUCT, ASSEMBLY.
TOTAL WEIGHT						110.53			

DUCTWORK #2 FRONT VIEW





REVISIONS
DESCRIPTION DATE:

Daddy D's BBQ – Angier ANGIER, NC, 27501

DATE: 3/14/2025

DWG## 7404748

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SCALE:

3/4" = 1'-0"

MASTER DRAWING

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