

		OOL EQUIT MENT	SCITED	OLL
	MARK	DESCRIPTION	MANUFACTURER	MODEL
	P-1	MAIN POOL WATER PUMP - VARIABLE SPEED INTEGRATED STRAINER W/BASKET W/SPARE BASKET PROVIDED.	HAYWARD	TRISTAR VS 950 2.7 HP / 230V 1PH
	P-2	36" NOMINAL DIAMETER FIBERGLASS SAND FILTER, 141 GPM FLOW RATE, 7.2 FILTER AREA, 900lb SAND	HAYWARD	HCF236
	P-3	CHLORINE / BROMINE FEEDER, WITH FLOW INDICATOR, 10-1/4" DIA. x 40" HIGH	PENTAIR	300-29X
	P-4	HORIZ. FLOW RATE INDICATOR, 45 – 240 GPM, SURFACE MOUNTED TO 3" SCH-40 PVC RETURN LINE	BLUE WHITE	F-30300P
	P-5	OMNILOGIC 4 RELAY BASE PANEL, SURFACE MOUNTED, 15.5"W x 21H x 5"D	HAYWARD	HLBASE
<u>/1</u> \	(P-6)	SKIMMER, w/ 2" x 1-1/2" SLIP REDUCERS EQUALIZER HOLES TO BE PLUGGED CLOSED	AQUASTAR	FLOWSTAR SKR-101
	P-7	AUTOFILL VALVE	POOLMISER	PM-101
	P-8	MULTIPORT PREPLUMBED VALVE KIT FOR FILTERS 2" UNION CONNECTION, 125 GPM	HAYWARD	HCV275
	P-9	EYEBALL BULKHEAD, 2" x 1-1/2" SLIP BODY, WITH EYEBALL INLET FITTING, 1-1/2" MPT, 3/4" ORIFICE	Custom Molded Products & PENTAIR	25524-200-000 & 540021
	P-10	4" WHITE, ADJUSTABLE FLOOR RETURN	AQUASTAR	API-25-1106
	P-11	SAFETY VACUUM LOCK WALL FITTING FOR HOSE ATTACHMENT	AQUASTAR	API-201-0001
	P-12	711 SERIES BUTTERFLY VALVE KIT w/ GALV. BOLTS	LASCO	LAS-56-3149
	P-13	BALL VALVE SCH 40 PVC (see plan for sizes req'd.)	CHARLOTTE PIPE	xxxxx
	P-14	12x12x12 FIBERGLASS SUMP DRAIN w/ 4" PORT, WITH 16"x16" OUTLET COVER, ANTI-ENTRAPMENT	A.S.A. MFG. INC. AQUASTAR	FPK-50-812-4 1216101
	P-15	SAFETY LIFE HOOK & 12' LONG ALUMINUM POLE, LOCATED ON SITE WITHIN FENCED AREA OF POOL	PENTAIR	R221026 & R191106
	P-16	Coast Guard Approved Life Ring & 60' Long Rope, LOCATED ON SITE WITHIN FENCED AREA OF POOL	POOLSTYLE MAINTENANCE	361 & 374
	P-17	DIAMOND BRITE, EXPOSED AGGREGATE POOL FINISH SLIP RESISTANT	SGM Inc. OR EQUAL	BLUE QUARTZ
^	P-18	2" HYDRO RELIEF VALVE	CUSTOM MOLDED PRODUCTS, INC.	25620-000-00
<u></u>	P-19	2" COLLECTOR TUBE	HAYWARD	HAY-25-1516
	R-1	STAIR RAIL, 60" MARINE GRADE ADA 3-BEND STAINLESS STEEL, RATED FOR SALTWATER	S.R. SMITH	3HR5ADA-MG
	R-2	STAIR RAIL, 84" MARINE GRADE ADA 3-BEND STAINLESS STEEL, RATED FOR SALTWATER	S.R. SMITH	7HR4ADA-MG
	R-3	POOL LADDER, 3 TREADS, STAINLESS STEEL, RATED FOR SALTWATER	S.R. SMITH	VLLS-103S-MG
	ADA-1	POOL LIFT, 350 lb. CAPACITY, BATTERY OPERATED, ADA COMPLIANT	S.R. SMITH	ML-300
	L-1	UNIVERSAL COLOR LOGIC, 12V LED LIGHT, MOUNTED 4" MIN. BELOW WATER LINE	HAYWARD	LPCUS1110

		POC	L & DEC	CK AR	EA CA	LCULA	ATIONS:						
ر	OULE	160	0'-0"	LINEA	L FEE	T POC	L PERI	METER	₹				
_		5,	5,440 SF DECK AREA INCLUDING POOL (total impervious surface)										
	MODEL						E AREA	_					
	TDIOTADAGO	3,	940	SF DE	CK AF	REA (a	ctual wa	lking s	urface))			
	TRISTAR VS 950 2.7 HP / 230V 1PH		4.40	a=					٥.				
	HCF236						CLUDIN			N /in a	م ممالمیا	۱۵۵۱	
											luding po e below		
	300-29X	۷,۰	000	01 DL	.01\ \	\L\ (10	л оссир	aricy c	aiculati	on, se	e below	,	
	F-30300P	-											
	HLBASE	SQUARE FOOTAGE NOTE: DECK AREA SQUARE FOOTAGE CALCULATIONS HAVE BEEN DERIVED FROM COMBINATION											
_	FLOWSTAR	_											
	SKR-101		OF CIVIL AND ARCHITECTURAL DESIGN DRAWINGS PROVIDED BY CLIENT, OF THE PROPOSED SITE WORK AND BUILDING(S). ONLY WALKING DECKS AND COVERED PORCH										
	PM-101		A OF STRI THERS. S										
	HCV275												
	25524-200-000 & 540021	Occup	pancy Calcu	lation pe	r 2018	NCBC:							
	API-25-1106	Deck	Surface Are Area 2,836				30 190						
	API-201-0001	Total	people =			:	220						
_	711 1 201 0001		PL	UMBIN	NG FIX	TURE B	REQUIRE	MENTS	PER 20	018 NC	BC & 2018	8 NCPC	
	LAS-56-3149		USE	WA	TER CLOS	ETS	URINALS	L	AVATORIE	S		DRINKING	FOUNTAINS
	XXXXX		Assembly ure count only)		FEMALE	FAMILY	Sub. for 67% max of MALE	1		FAMILY	SHOWERS		ACCESSIBLE
_	FPK-50-812-4		EXISTING	1/125	1/65 0	0	Water Closets	1/200	1/200	0	N/A O	1/500	1/500
	1216101	Occupant Load	NEW	1	2	0	1	1	2	0	1	1	1
	R221026 & R191106	220	REQUIRED 20 total o	1	1	0 110 1	0	1	1	0	0	1	1
	361 & 374	1. 2	.20 (0(4) 0	ccupant	5 / 2 -	- 110 N	nen oc in	women	ı				
	BLUE QUARTZ												
•	25620-000-00		oancy Calcu Surface Are						= 100				

1. 100 total occupants / 2 = 50 Men & 50 Wome	11	
POOL	DATA	
DESCRIPTION	VALUE	UNIT TYPE
POOL DIMENSIONS	30'-0" x 50'-0"	FEET
POOL DEPTHS	0'-5" TO 4'-0"	FEET
POOL SURFACE AREA	1,500	SQUARE FEET
POOL PERIMETER	160'-0"	LINEAR FEET
POOL VOLUME	35,000	GALLONS
MINIMUM TURNOVER RATE	6	HOURS
MINIMUM FLOW RATE REQUIRED	98	GALLONS PER MINUTE
DESIGN FLOW RATE PROVIDED	126	GALLONS PER MINUTE
DESIGN PUMP HEAD	65 min.	FEET
FILTER TYPE	SAND	
FILTER COUNT (PLUMBED IN PARALLEL)	1	
FILTER AREA (PER FILTER)	7.06	SQUARE FEET
TOTAL FILTER AREA	7.06	SQUARE FEET
FILTER FLOW RATE REQUIRED @ 20GPM/FT² (PER FILTER)	98	GALLONS PER MINUTE
MAXIMUM FILTER FLOW RATE PROVIDED @ 20GPM/FT² (PER FILTER)	143	GALLONS PER MINUTE
REQUIRED MINIMUM REQ'D FILTER TURNOVER CAPACITY @ 20GPM/FT ² @ EVERY 6 HOURS	35,000	GALLONS (PER FILTER)
PROVIDED DESIGN FILTER TURNOVER CAPACITY @ 20GPM/FT ² @ EVERY 6 HOURS	45,360	GALLONS (PER FILTER)
SKIMMER COUNT (MIN. 1 PER 400 SF SURFACE AREA)	6	
FLOW PER SKIMMER (MIN. 20 GPM EACH PER DESIGN FLOW RATE)	21	GALLONS PER MINUTE
RETURN COUNT (MIN. 1 PER 20 GPM DESIGN FLOW RATE)	7	
FLOW PER RETURN (PER DESIGN FLOW RATE)	18	GALLONS PER MINUTE
NUMBER OF BATHERS PER ENVIRONMENTAL HEALTH DEPT. RULES.	100	PEOPLE
CHEMICAL STORAGE ROOM REQUIRED	13.3	SQUARE FEET
CHEMICAL STORAGE ROOM PROVIDED	17.9	SQUARE FEET

HOURS OF OPERATION: POOL HAS MULTI-COLORED L.E.D. LIGHTING SYSTEM, AND POOL WILL NOT BE OPEN

	3'-6" STAIR RUI 1'-2" TYP. TREAD	DEPTH +	SUN DECK WIDTH VARIES, S	EE PLAN	 ⊁
	PACE OF RIGHT	FACE OF TOP RISER			EDGE OF POOL @ SUN DECK
11 1/2" TOP OF DECK TO SUN DECK		10" 10-17-2	WATER LINE AT CENTER OF TILE	5" WATER DEPTH	
3'-1" TOTAL STAIR RISE 1" 9 1/4" 9 1/4" 2'-10"	1" 2"BAN			, 0 ,	
10 0 V V O V V V O	8"	2" WIDE CERAMIC CONTRASTING CONTRASTING CO	DLOR, 1" FROM		

SCALE: 1/2" = 1'-0" Sheet:

Issue Date:

PLAN

AREA

POOL


Pool


Project Number: SP-1

2-12-202

Drawn by: Mac Morga

Pools, L s, Project | 319] 610-6658 Raleigh Matthew Nuss,
mobile (91
matthew.raleig

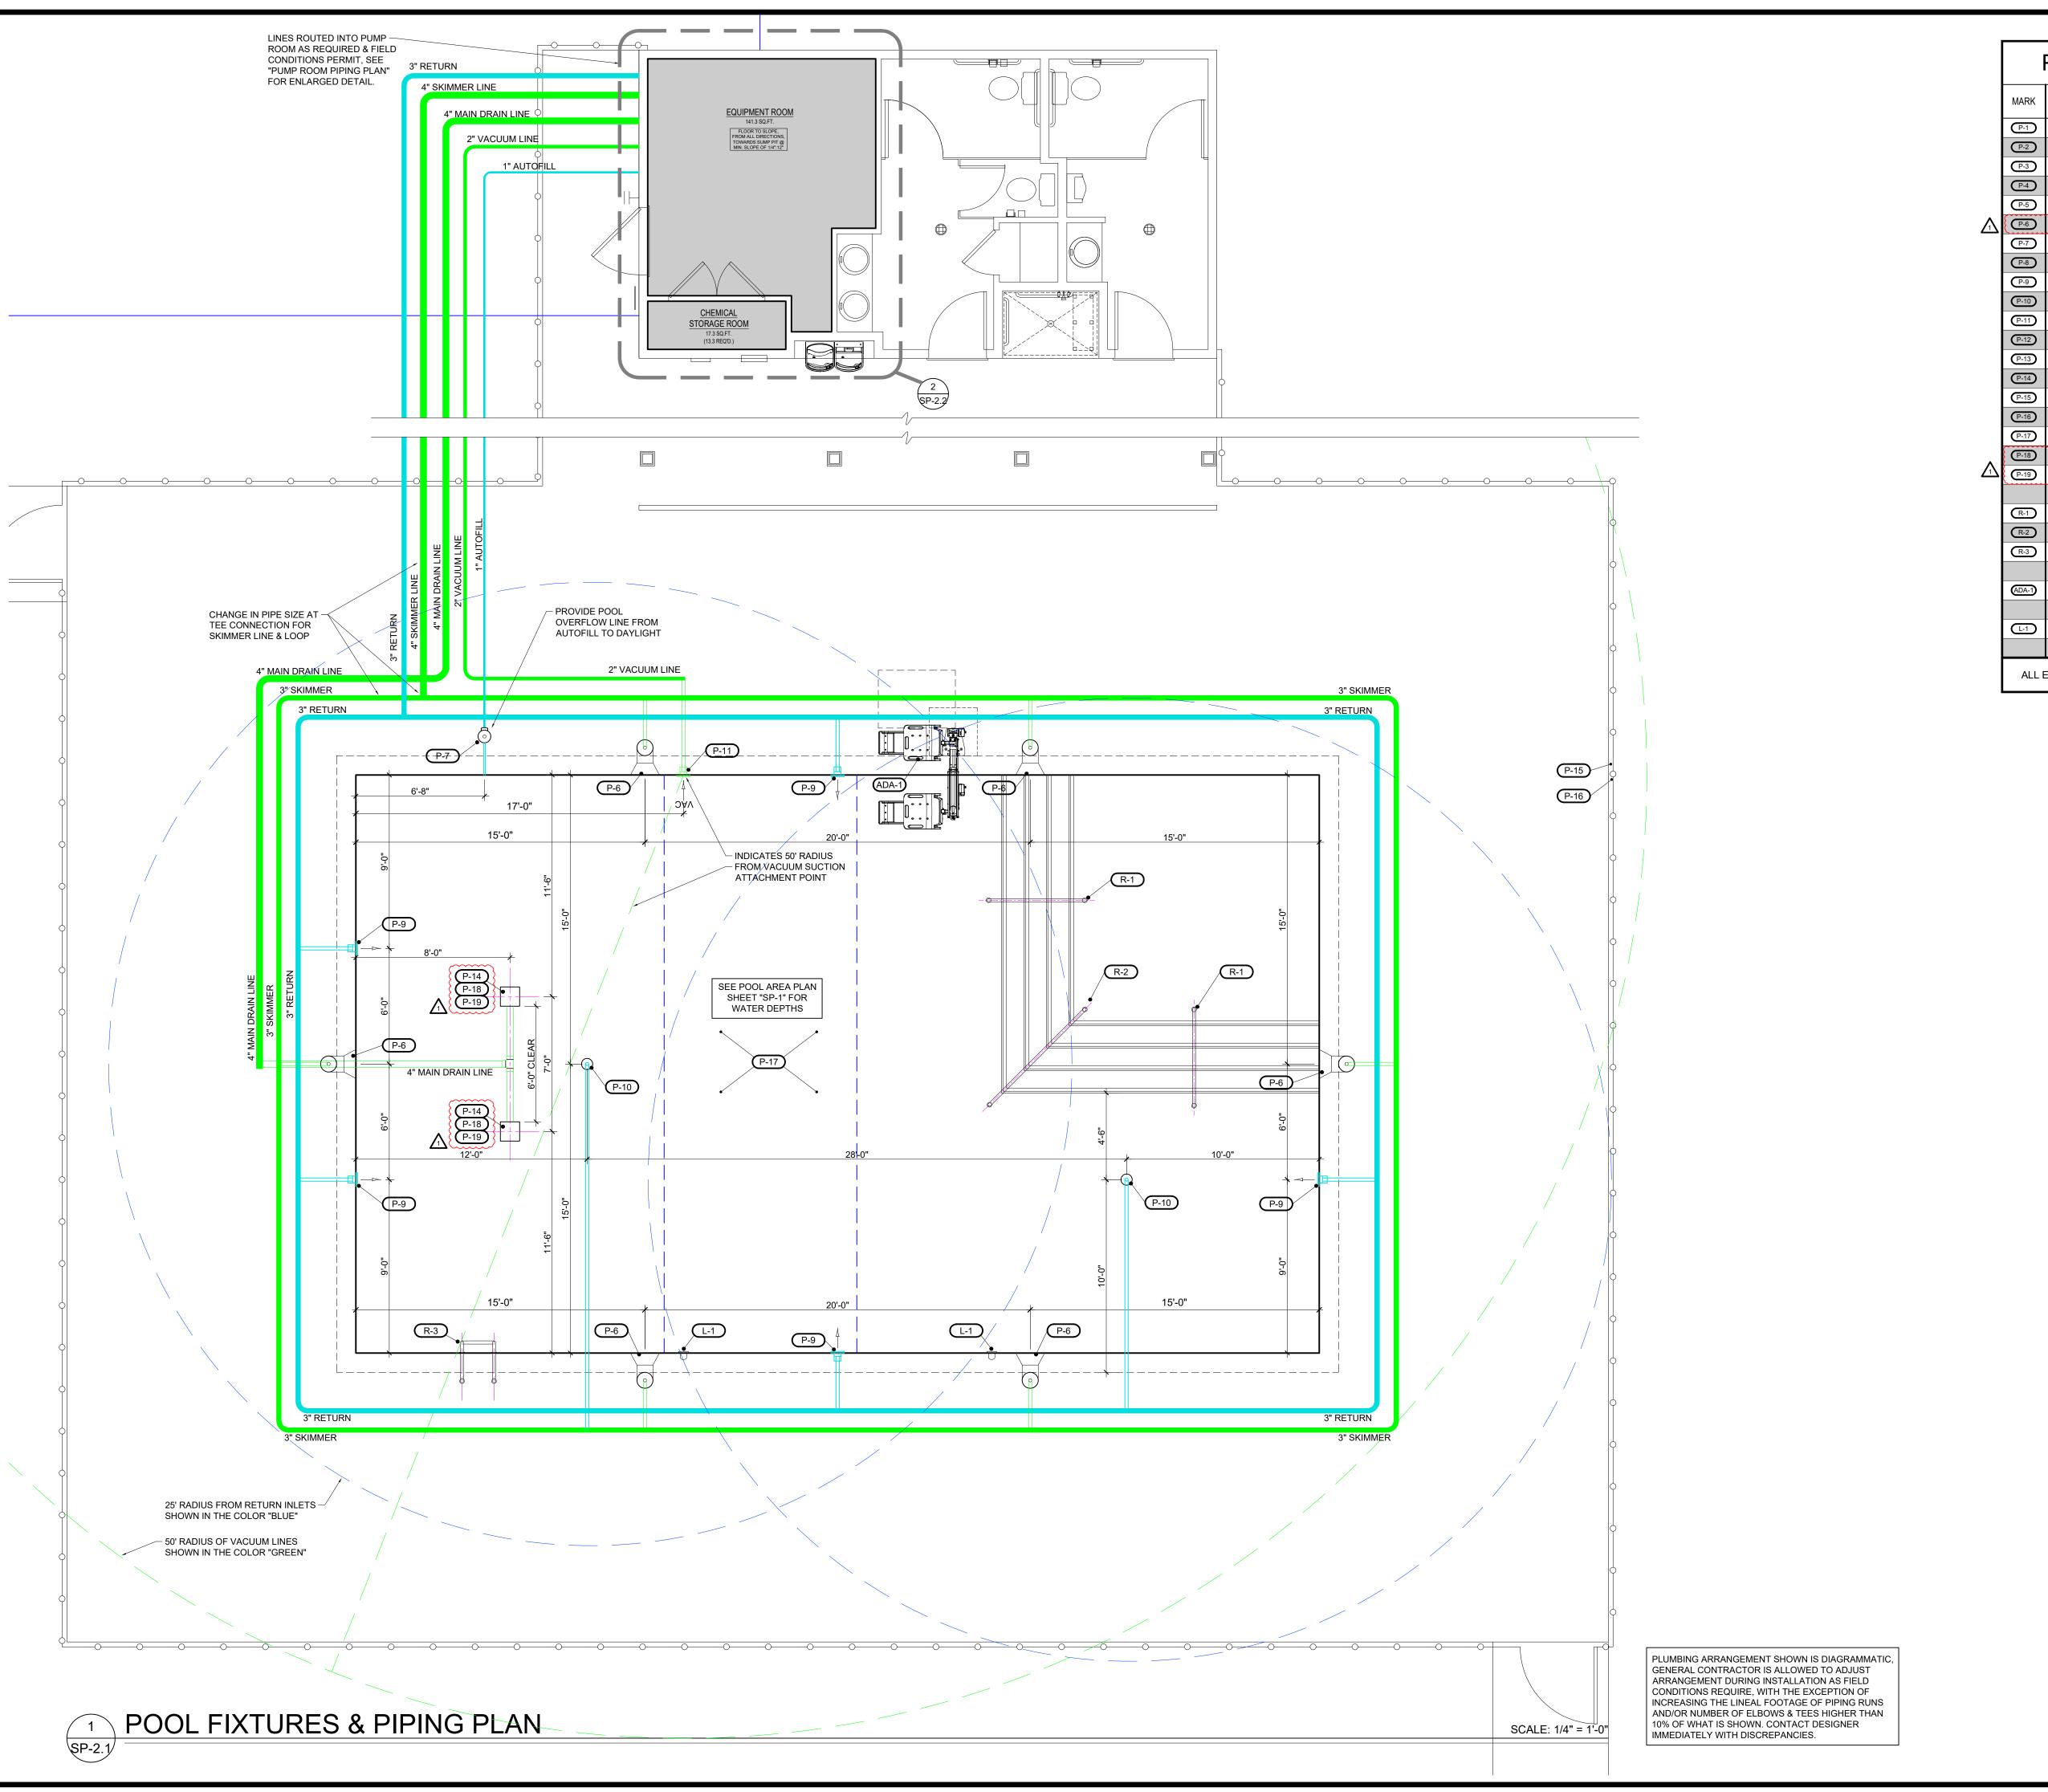

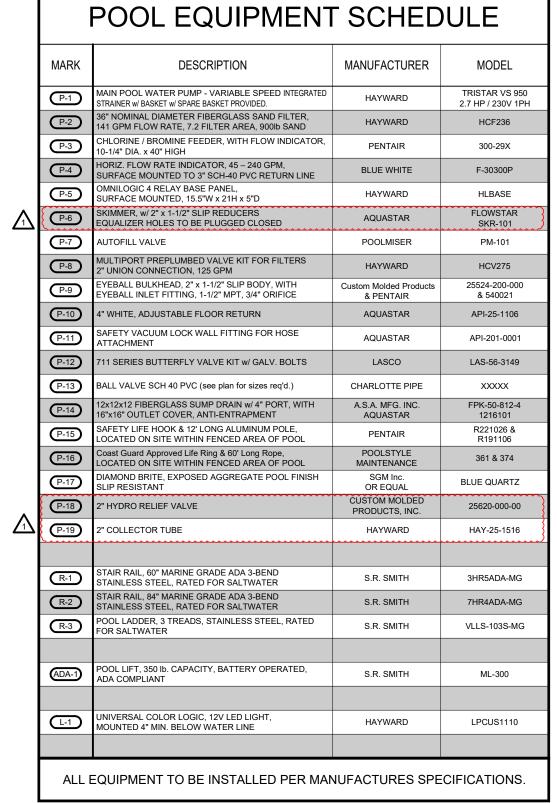


PIPING FIXTURES POOL Drawn by: Mac Morga Issue Date: 2-12-202 Project Number:


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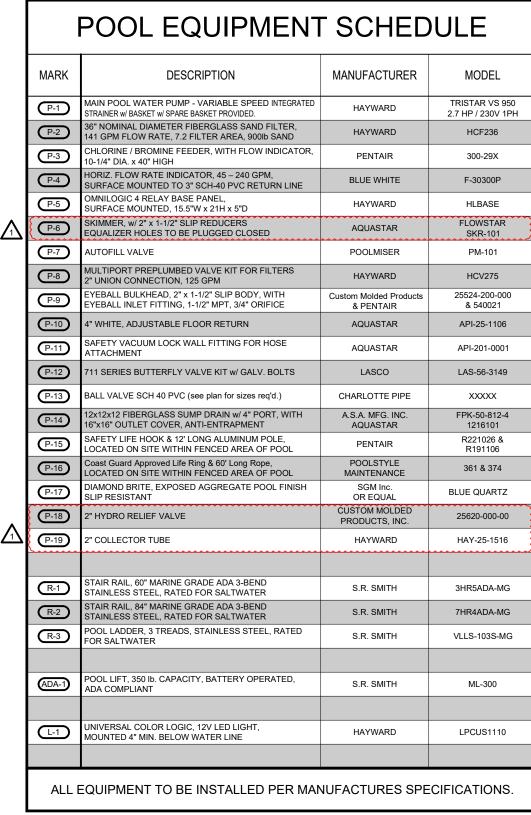
Pools, L s, Project | 319] 610-6658


SP-2.1

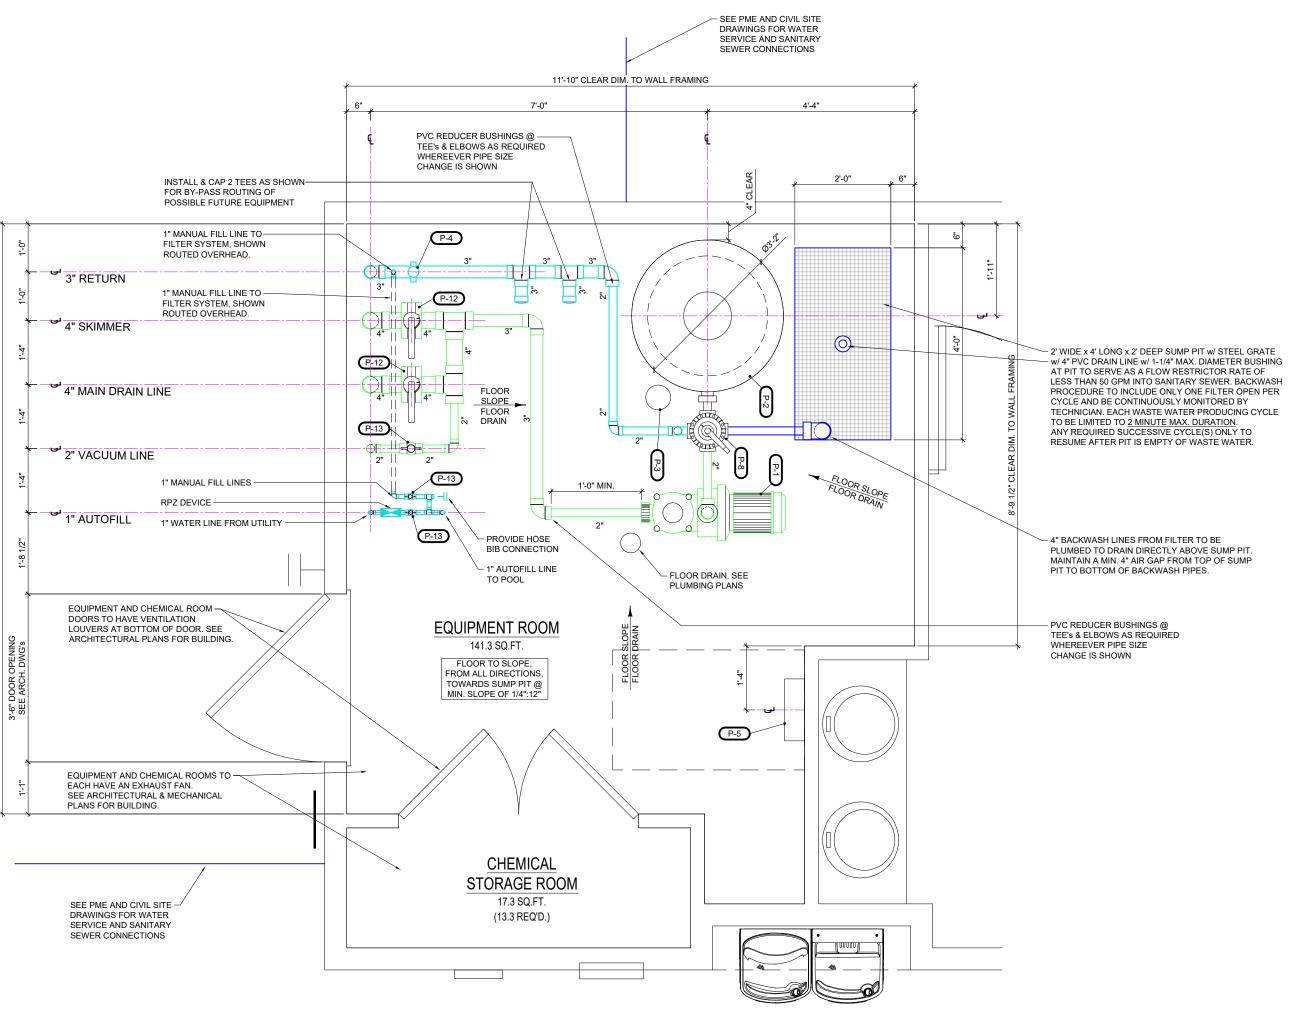


PUMP ROOM PIPING PLAN



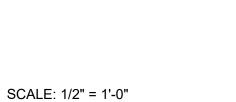


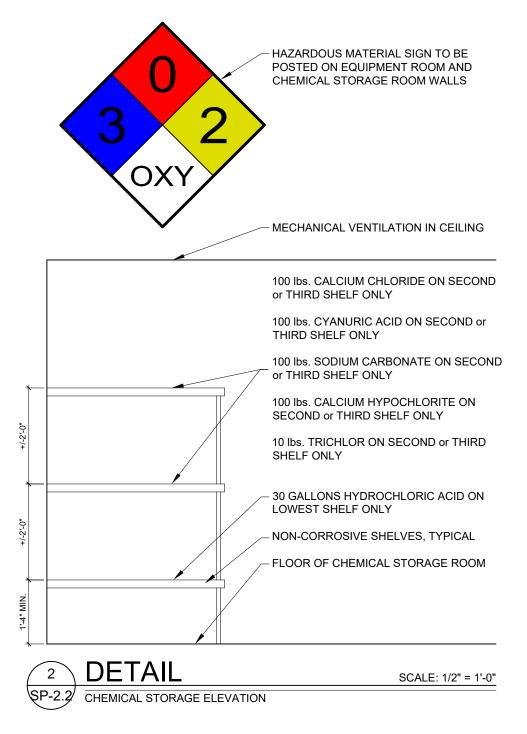


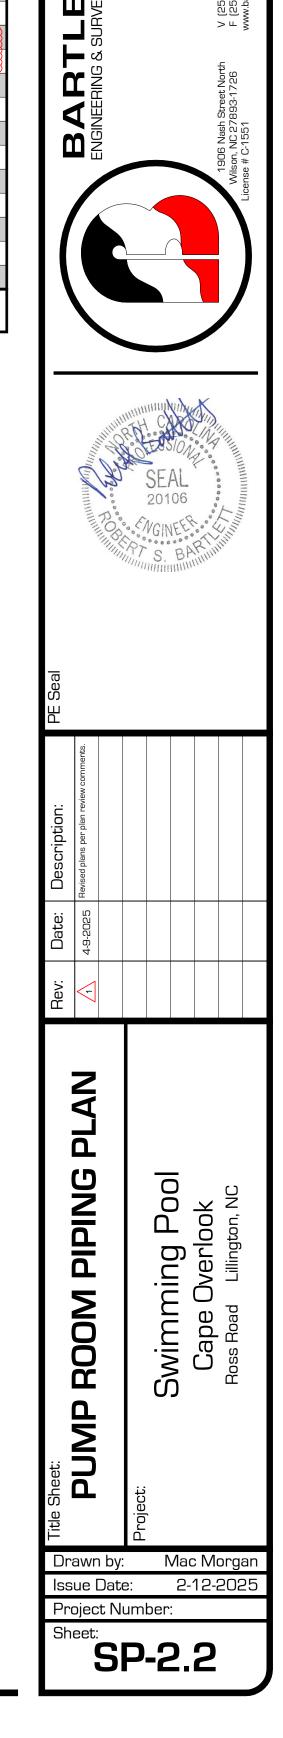


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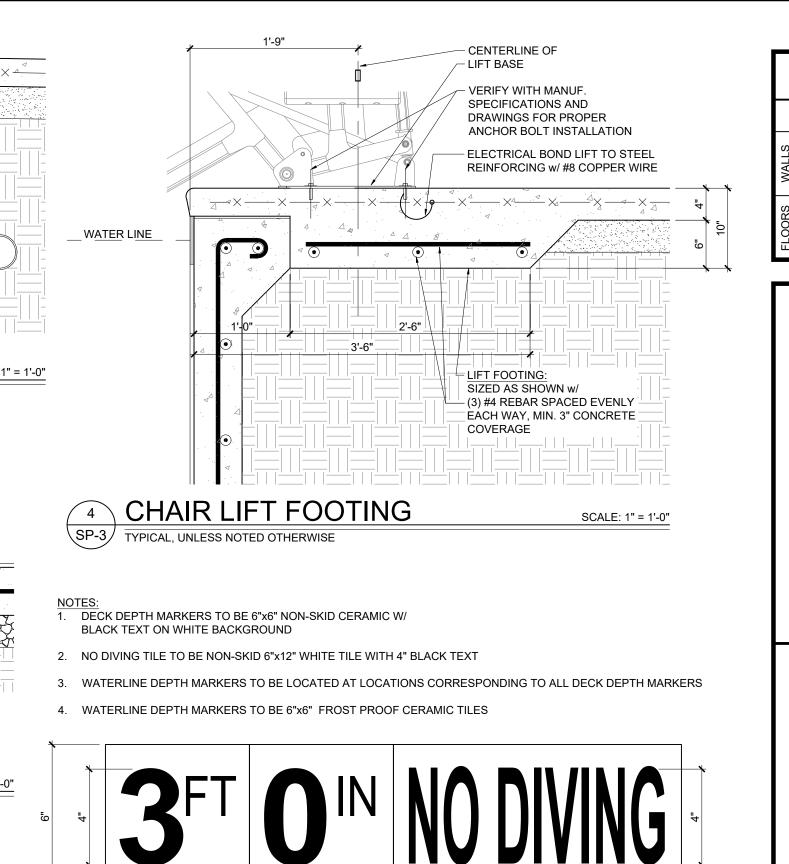
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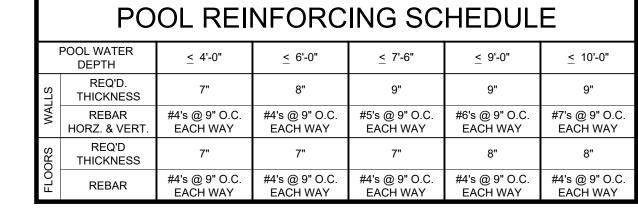




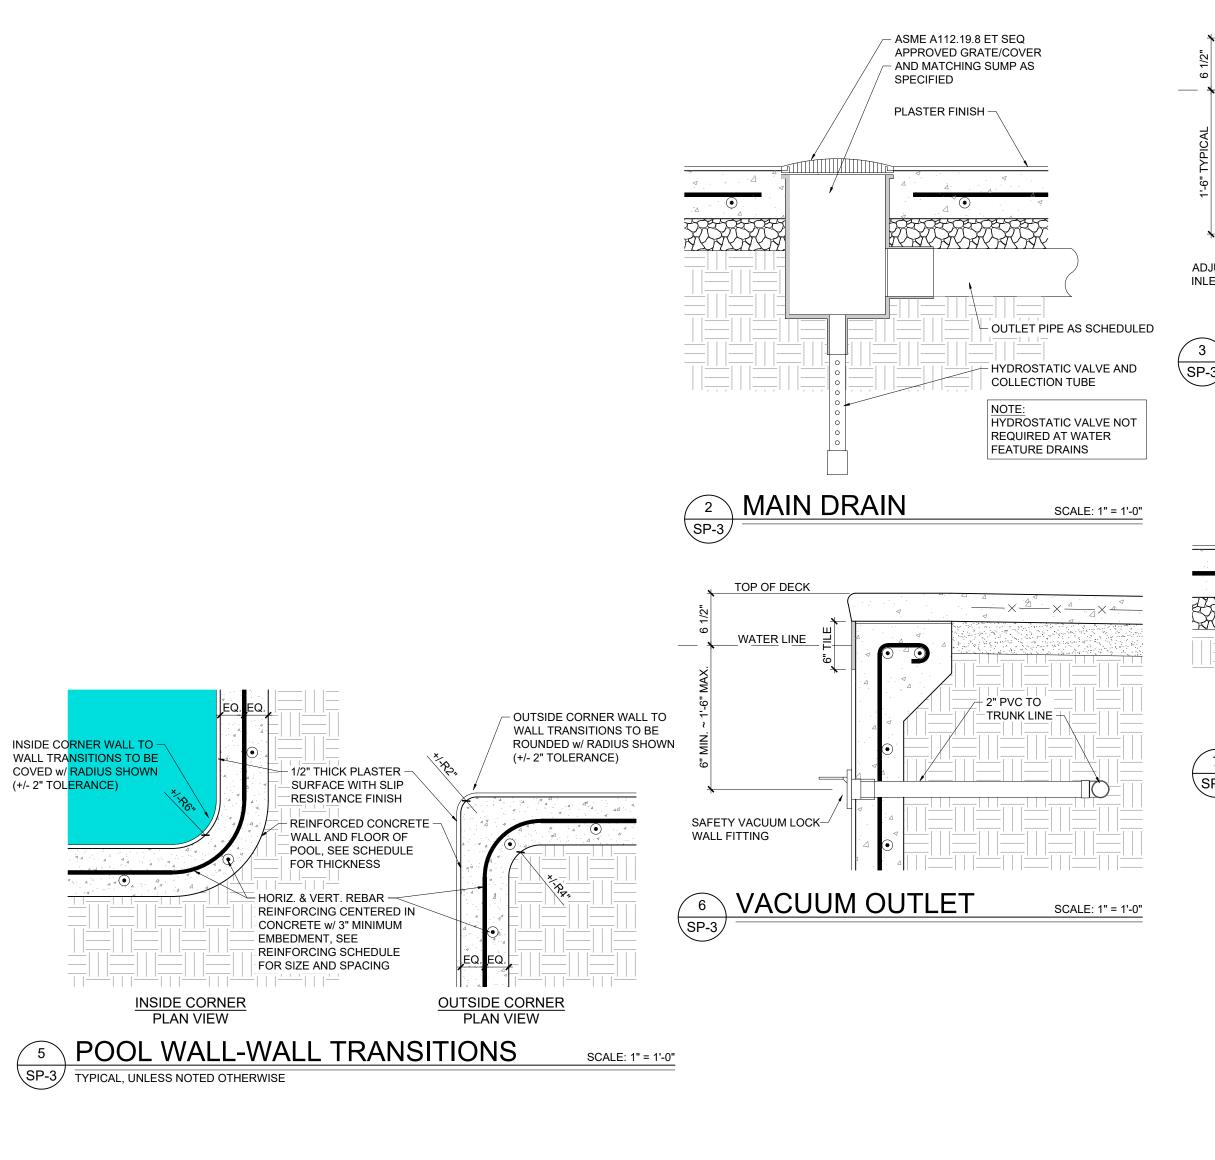

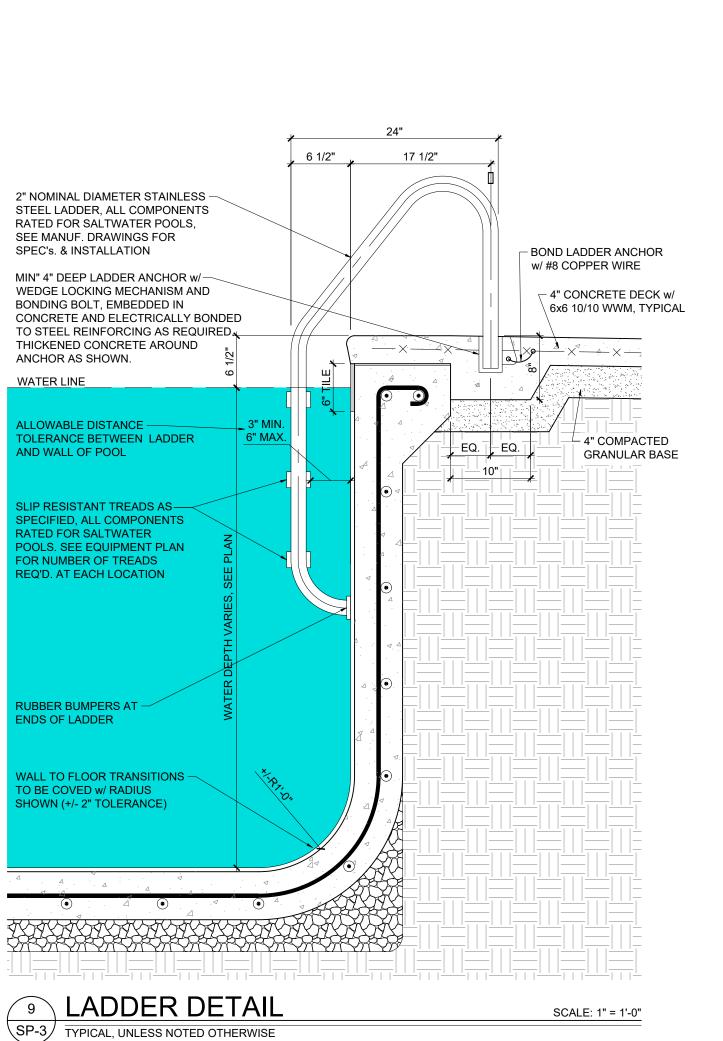SP-3/ TYPICAL, UNLESS NOTED OTHERWISE

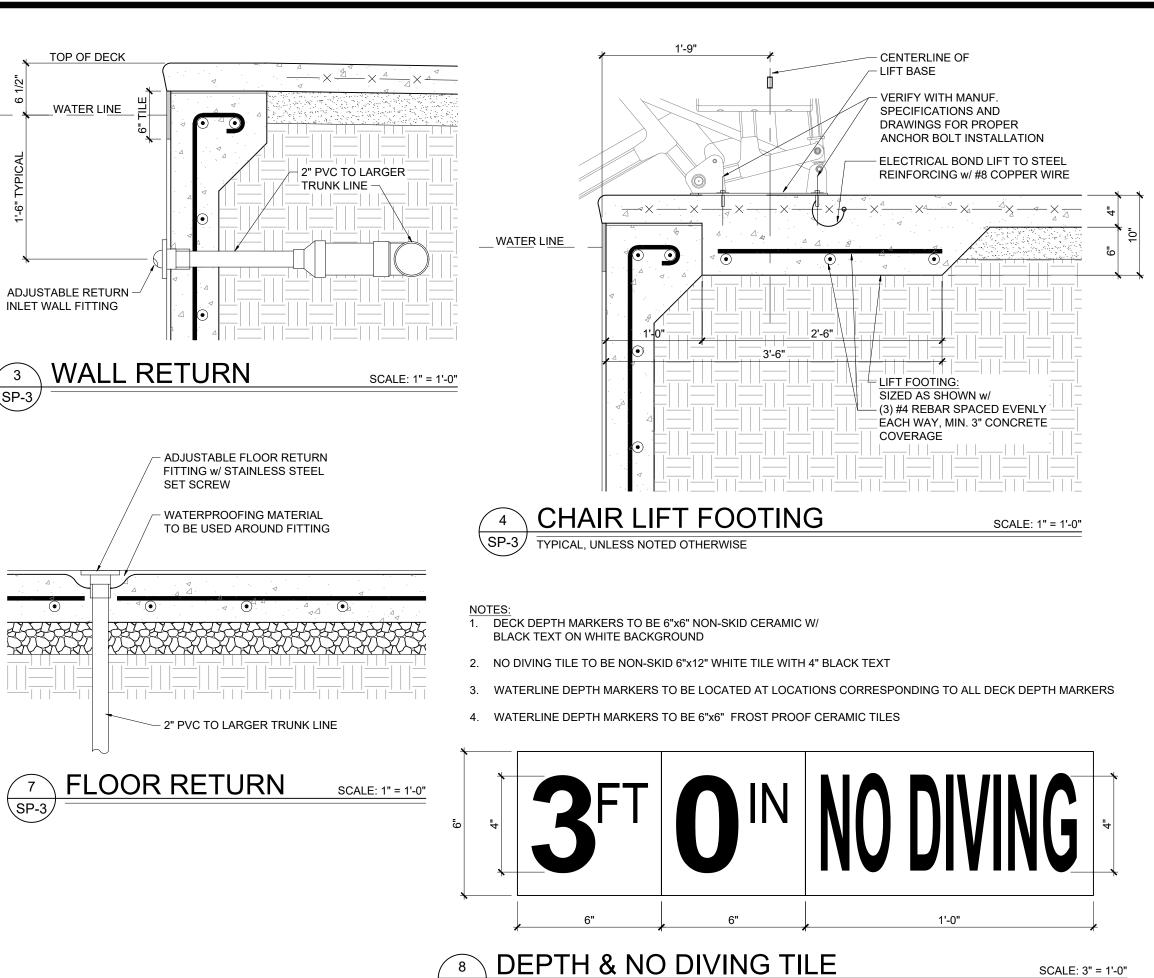



GENERAL STRUCTURAL NOTES

- ALL CONSTRUCTION MATERIALS AND METHODS SHALL CONFORM TO THE STATEWIDE BUILDING CODE AND TO THE SPECIFICATIONS AND STANDARDS OF THE LOCAL BUILDING INSPECTIONS OFFICE.
- CONTRACTOR SHALL COORDINATE AND VERIFY ALL DIMENSIONS PRIOR TO BEGINNING
- WORK, WITH ANY DISCREPANCY BROUGHT TO THE ATTENTION OF THE DESIGNER. CONTRACTOR SHALL BE RESPONSIBLE FOR VERIFICATION OF SUBGRADE CONDITIONS.
- ASSUMED MINIMUM SOIL BEARING CAPACITY 2000 P.S.F.

SLOPE OF 1/4" TO 1/2" RISE PER 12" RUN

- ALL "POOL WALKING DECK" CONCRETE TO BE NORMAL WEIGHT CONCRETE WITH 4000 P.S.I. MINIMUM @ 28 DAY STRENGTH.
- ALL "POOL SHELL" CONCRETE TO BE SHOTCRETE WITH 4000 P.S.I. MINIMUM @ 28 DAY STRENGTH, WITH NON-SLIP PLASTER FINISH COAT.
- WELDED WIRE FABRIC TO CONFORM TO ASTM A-185 MATERIAL AND HAVE 12" LAPS.
- ALL DECKS TO SLOPE AWAY FROM THE POOL AND TOWARDS METHOD OF DRAINAGE AT A

REINFORCING BARS SHALL BE DEFORMED BILLET STEEL BARS CONFORMING TO ASTM A - 615 SPECIFICATIONS. MINIMUM YIELD STRENGTH (FY): REINFORCING BARS 40,000 PSI

UNLESS OTHERWISE DETAILED, PROTECTIVE CONCRETE COVER FOR REINFORCING STEEL SHALL NOT BE LESS THAN: (A) CONCRETE CAST AGAINST AND PERMANENTLY EXPOSED TO EARTH 3" (B) CONCRETE EXPOSED TO EARTH OR WEATHER #5 & SMALLER 1-1/2", #6 & LARGER 2".

MINIMUM TENSION LAP SPLICE LENGTHS (F'C = 3,000PSI #3 = 16"


#4 = 22" #5 = 27"

#6 = 32" #8 = 42"


SCALE: 3" = 1'-0"


NOT TO SCALE

ALL REINFORCING INTERSECTIONS TO BE JOINED WITH WIRE TIES.

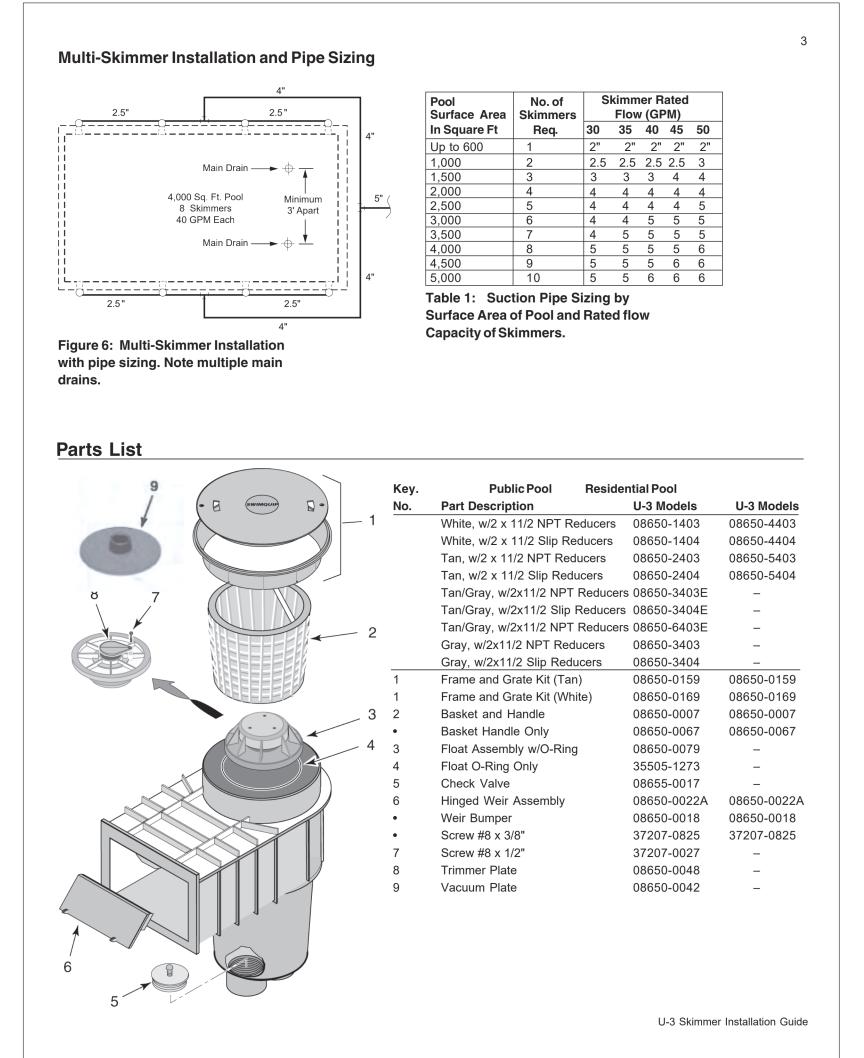

SP-3 SKIMMER

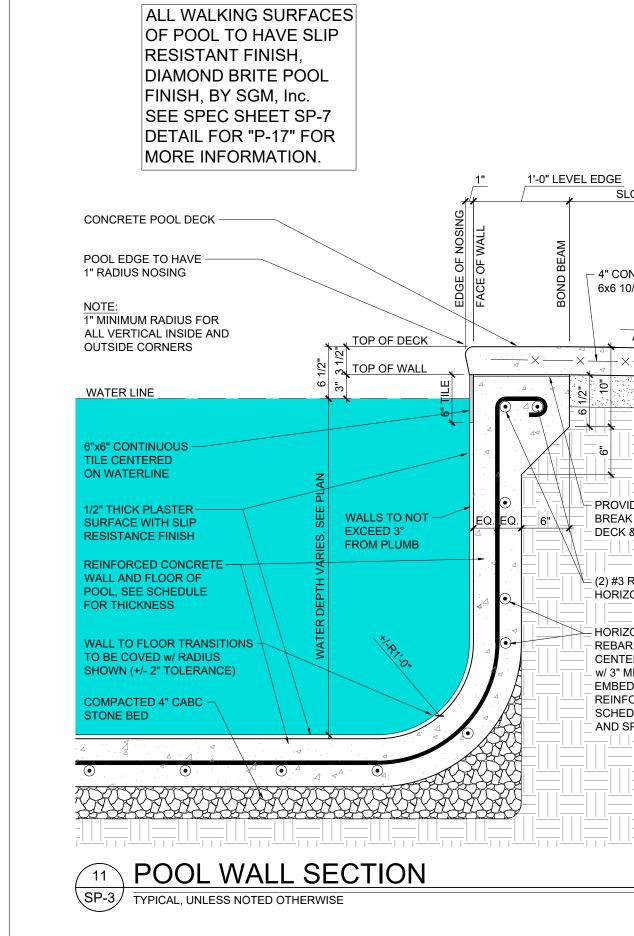

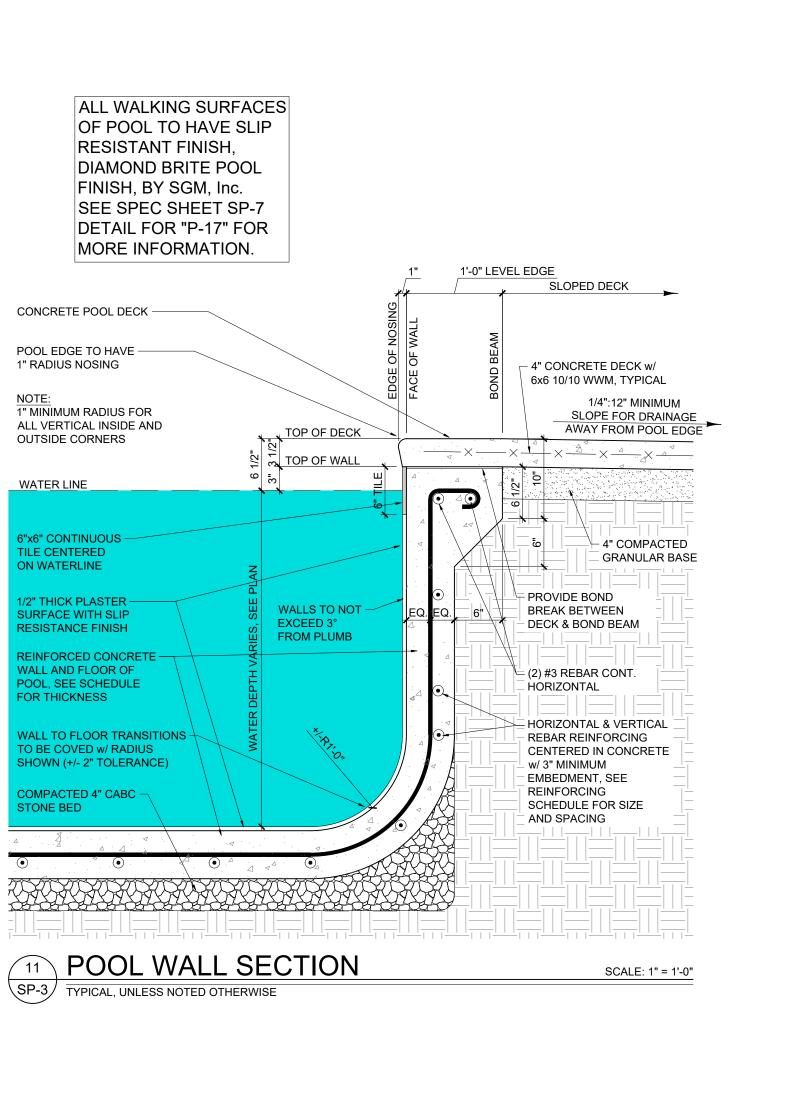

Pools, Raleigh hew Nuss,

SECTIONS Pool ook Wimming | Cape Overlo

TAIL Ś

Mac Morga Drawn by: 2-12-202 Issue Date:

Project Number: Sheet:

SP-3

SP-4/ PERIMETER FENCE & GATE

Children under the age of 14 should not use pool or spa without an adult in attendance

4 SIGNAGE NOT TO SCALE \SP-4/ POSTED AS REQUIRED WHEN THERE IS NO LIFEGUARD IS ON DUTY.


EXAMPLE SIGN, ACTUAL SIGN MAY VARY.



SIGNAGE NOT TO SCALE $\$ EXAMPLE SIGN, ACTUAL SIGN MAY VARY.



6 SIGNAGE NOT TO SCALE SP-4/ POSTED AS REQUIRED NEAR SHOWERS OR RESTROOM.

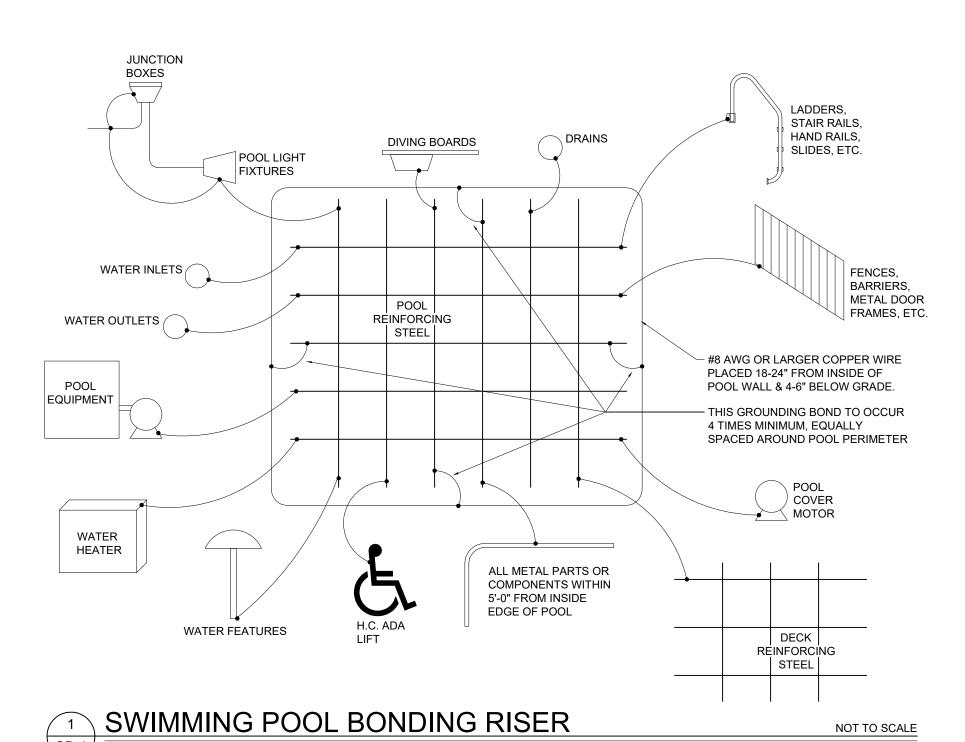

SCALE: 1/2" = 1'-0"

- ALL CONNECTIONS WILL BE MADE BY A PRESSURE CONNECTOR OR CLAMPS THAT ARE SUITABLE FOR THE REQUIRED PURPOSE AND ARE MADE OF STAINLESS STEEL, BRASS, OR COPPER.
- 2. ALL BONDING CONNECTIONS WILL BE WITH #8 AWG SIZED COPPER WIRE
- 3. WHERE AS STEEL REINFORCEMENT IS NOT INSTALLED THEN ALL ITEMS WILL BE BONDED TOGETHER WITH #8 AWG SIZED COPPER WIRE.

GENERAL PLUMBING NOTES:

- WATER SUPPLY SERVING THE SWIMMING POOL AND ALL PLUMBING FIXTURES INCLUDING DRINKING FOUNTAINS, LAVATORIES, TOILETS, AND SHOWERS, IS AN APPROVED PUBLIC SYSTEM IN ACCORDANCE WITH 15A NCAC 18C BY PLUMBING CONTRACTOR.
- THE WATER DISTRIBUTION SYSTEM SERVING THE SWIMMING POOL AND AUXILIARY FACILITIES WILL BE PROTECTED AGAINST BACKFLOW. WATER INTRODUCED INTO THE POOL THROUGH A REDUCED PRESSURE PRINCIPLE BACKFLOW PREVENTER MODEL 009M3 QT (OR EQUAL)
- . SUPPLIED AND INSTALLED BY PLUMBING CONTRACTOR
- SEWAGE WILL BE DISPOSED OF IN AN APPROVED PUBLIC SEWER SYSTEM BY PLUMBING CONTRACTOR.
- THERE WILL BE NO DIRECT PHYSICAL CONNECTION BETWEEN THE SEWER SYSTEM AND ANY DRAIN FROM THE SWIMMING POOL OR CIRCULATION SYSTEM. OVERFLOW FROM THE SWIMMING POOL, AND DISCHARGES FROM THE CIRCULATION SYSTEM, WILL BE DISCHARGED THROUGH A SUITABLE AIR GAP SO AS TO PRECLUDE THE POSSIBILITY OF BACKFLOW INTO THE SWIMMING POOL OR THE SWIMMING POOL PIPING SYSTEM.
- 6. HYDROSTATIC RELIEF VALVE TO BE PROVIDED AT THE DEEPEST POINT OF THE POOL
- SWIMMING POOL PIPING IS DESIGNED TO REDUCE FRICTION LOSSES TO A MINIMUM AND CARRY THE REQUIRED QUANTITY OF WATER AT A MAXIMUM VELOCITY NOT TO EXCEED 6 FEET PER SECOND FOR SUCTION PIPING AND 10 FEET PER SECOND FOR DISCHARGE
- 3. ALL SWIMMING POOL PLUMBING PIPING SHALL BE NSF APPROVED SCHEDULE 40 PRESSURE RATED RIGID PVC.
- 9. ALL PIPE TO BE PRESSURE TESTED PRIOR TO CONCRETE PLACEMENT
- 10. FLEXIBLE PIPING WILL NOT BE USED
- 11. ALL EXPOSED PLUMBING AND VALVES WILL BE LABELED ACCORDING TO USE

POOL RULES

- NO BOISTEROUS OR ROUGH PLAY.
- 3. NO DIVING ALLOWED IN AREAS OF THE POOL LESS THAN 5 FEET DEEP OR IN POOLS NOT APPROVED FOR DIVING. 4. CHILDREN SHOULD NOT USE THE SWIMMING POOL WITHOUT
- ADULT SUPERVISION. 5. ADULTS SHOULD NOT SWIM ALONE.
- s. NO PERSON UNDER THE INFLUENCE OF ALCOHOL OR DRUGS
- 7. NO PERSON WITH SKIN, EYE, EAR OR NASAL INFECTIONS ALLOWED IN THE POOL.

- POOL IS FOR PRIVATE USE. MEMBERS AND GUESTS ONLY
- 13. MANAGEMENT RESERVES THE RIGHT TO DENY USE OF THE POOL
- 14. THIS POOL IS OPEN FROM A.M. TO P.M.
- 15. THE MAXIMUM NUMBER OF SWIMMERS ALLOWED IN THE
- 16. A FIRST AID KIT IS LOCATED
- : EMERGENCY TELEPHONE (OR OTHER NOTIFICATION DEVICE) IS LOCATED

SIGNAGE NOT TO SCALE SP-4/ POSTED AT ALL BATHER POOL ENTRANCES.

EXAMPLE SIGN, ACTUAL SIGN MAY VARY

POOL SIGNAGE NOTES:

- NON-SKID NO DIVING AND DEPTH MARKER TILES WILL BE LOCATED AT THE DECK NO GREATER THAN 25' ON CENTER AS MEASURED AT THE PERIMETER OF THE POOL
- FROST PROOF DEPTH MARKER TILE WILL BE LOCATED AT THE WATERLINE AT EACH DECK DEPTH MARKER LOCATION
- ALL SIGNAGE REQUIRED TO MEET 15A NCAC 18A, AND ANY CITY AND/OR COUNTY CODES
- WILL BE PROVIDED.
- COLORS CHOSEN FOR TEXT TO BE OF HIGH CONTRAST WITH BACKGROUND.
- SWIMMING POOLS THAT DO NOT HAVE AT LEAST ONE LIFEGUARD ON DUTY, SHALL HAVE A SIGN POSTED WITH LEGIBLE LETTERS OF AT LEAST FOUR INCHES IN HEIGHT STATING: "WARNING-NO LIFEGUARD ON DUTY", SEE DETAIL "4/SP-4".
- WADING POOLS THAT DO NOT HAVE AT LEAST ONE LIFEGUARD ON DUTY INSIDE THE WADING POOL ENCLOSURE SHALL HAVE A SIGN SHALL POSTED WITH LEGIBLE LETTERS OF AT LEAST FOUR INCHES IN HEIGHT STATING: "WARNING-NO LIFEGUARD ON DUTY", SEE DETAIL "4/SP-4".
- ALL BATHER ENTRANCES SHALL HAVE SIGNS POSTED WITH A MINIMUM LETTER SIZE OF ONE INCH STATING: "CHILDREN SHOULD NOT USE THE SWIMMING POOL WITHOUT ADULT SUPERVISION", AND: "ADULTS SHOULD NOT SWIM ALONE". SEE DETAIL "7/SP-4".
- ALL SIGNS SHALL BE MOUNTED PERMANENTLY.

BARRIER NOTES:

- GROUND LEVEL DOORS AND WINDOW OPENINGS FROM OCCUPIED BUILDINGS TO INSIDE THE POOL ENCLOSURE SHALL BE SELF-CLOSING OR CHILD PROTECTED BY MEANS OF A BARRIER OR AUDIBLE ALARM.
- ALL ACCESS GATES SHALL OPEN AWAY FROM THE POOL. RELEASE ON THE LATCH OF THE LATCH ON THE SELF CLOSING LATCH SHALL BE ACTIVATED: a. AT A HEIGHT NO LESS THAN 54 INCHES ABOVE GRADE FOR WIRE MESH ACCESS GATES AND AT A HEIGHT NO LESS THAN 54 INCHES ABOVE THE HORIZONTAL BOTTOM RAIL OF A PICKET/ORNAMENTAL ACCESS GATE OR
- b. ON THE POOL SIDE OF THE GATE AT A DISTANCE OF NO LESS THAN THREE INCHES BELOW THE TOP OF THE GATE PROVIDED. c. THERE SHALL BE NO OPENING GREATER THAN 1/2" WITHIN 18 INCHES OF WHERE THE LATCH RELEASE IS ACTIVATED WHEN THE GATE IS CLOSED.

- THE CHEMICAL STORAGE ROOM AND EQUIPMENT ROOMS SHALL BE DRY WEATHERPROOF STRUCTURES WITH A MINIMUM CEILING HEIGHT OF 7'.

CHEMICAL STORAGE ROOM & CHEMICAL ROOM NOTES:

- THE CHEMICAL STORAGE ROOM SHALL HOUSE A DRY SHELVING AREA MINIMUM OF 6" ABOVE THE FLOOR.
- ADEQUATE LIGHTING SHALL BE PROVIDED IN BOTH THE CHEMICAL STORAGE AND EQUIPMENT ROOMS SO THAT ALL VALVES, PIPES, EQUIPMENT, AND SHELVING ARE WELL


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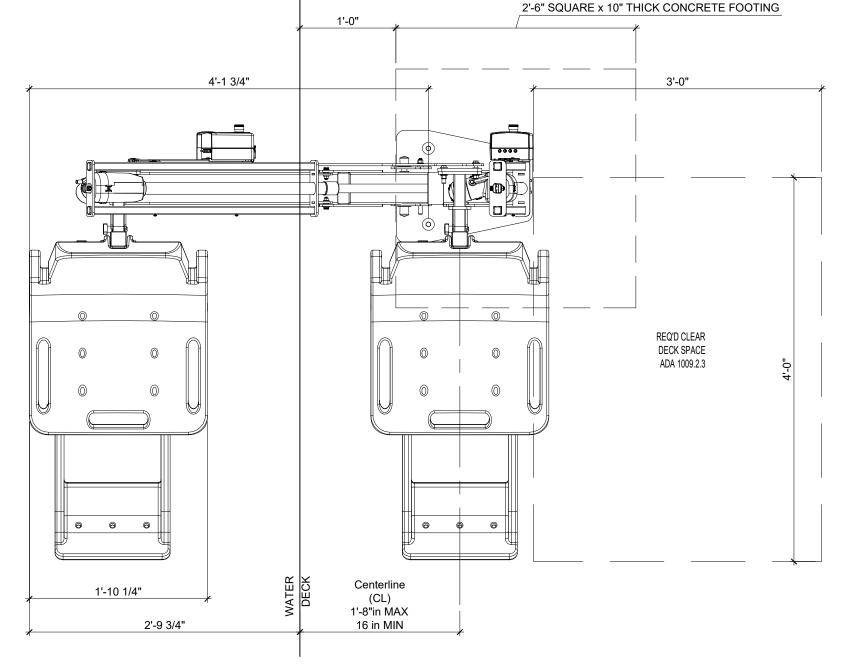
- CONTINUOUS FORCED VENTILATION WHICH DIRECTS THE DISCHARGE AIR AWAY FROM THE POOL IS REQUIRED. THE SWITCH FOR THE FORCED VENTILATION SHALL NOT BE WIRED INTO THE LIGHT SWITCH AND SHALL BE WIRED FOR CONTINUOUS OPERATION.
- THE DOOR TO THE EQUIPMENT ROOM SHALL BE PROVIDED WITH A DOOR WITH A PERMANENT LOCK WHICH MUST BE KEPT LOCKED WHEN NOT IN USE BY THE POOL
- 6. ALL VALVES, AND CONTROL DEVICES SHALL BE CLEARLY LABELED AND VISIBLE.
- A MINIMUM OF 3' OF CLEAR WALKING SPACE SHALL BE PROVIDED TO ALLOW ACCESS TO
- THE EQUIPMENT ROOM FLOOR SHALL SLOPE TOWARDS THE FLOOR DRAIN / BACKWASH PIT A MINIMUM OF 1/4" PER 1'.
- A HOSE BIB WITH APPROVED BACKFLOW PREVENTION DEVICE WILL BE PROVIDED WITHIN THE EQUIPMENT ROOM.


POOL SAFETY NOTES:

- SAFETY EQUIPMENT WILL BE STORED IN A LOCATION CLOSE TO THE POOL WITH EASY ACCESS FOR PATRONS AND STAFF INSIDE THE POOL BARRIER.
- PROVIDE AN EMERGENCY TELEPHONE WITH AN INDEPENDENT LANDLINE BASED PHONE SERVICE, WITH NO LINE EXTENSIONS OR SWITCHBOARD OPERATOR. AND PERMANENTLY MOUNTED ON THE POOL DECK AREA. SEE POOL AREA PLAN FOR SUGGESTED LOCATION. NO DIRECT DIAL 911 PHONES WILL BE ALLOWED (PHONES WHICH HAVE NO DIAL PAD). A SIGN SHALL BE POSTED AT THE PHONE STATING, "EMERGENCY DIAL 911" ALONG WITH THE PHONE NUMBER AND PHYSICAL ADDRESS OF THE POOL.THE EMERGENCY PHONE SHALL BE CAPABLE OF RECEIVING CALLS WITH AN AUDIBLE RINGER.



8 SIGNAGE SP-4/ POSTED AT ALL BATHER POOL ENTRANCES. EXAMPLE SIGN, ACTUAL SIGN MAY VARY.

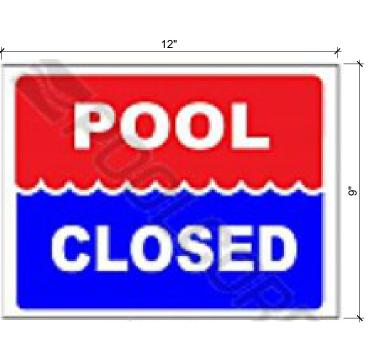

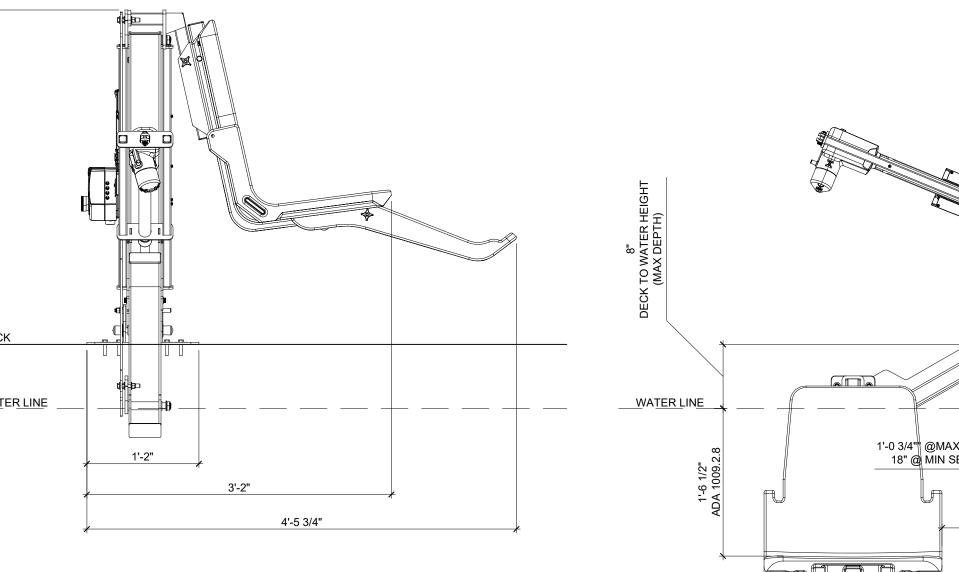

PLAN VIEW 1'-3" 1'-0 3/4" @MAX SB 18" @ MIN SB Centerline 17 in MAX 12.5 in MIN

FRONT ELEVATION VIEW

SCALE: 1" = 1'-0"

SP-4

SECTIONS

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DETAILS

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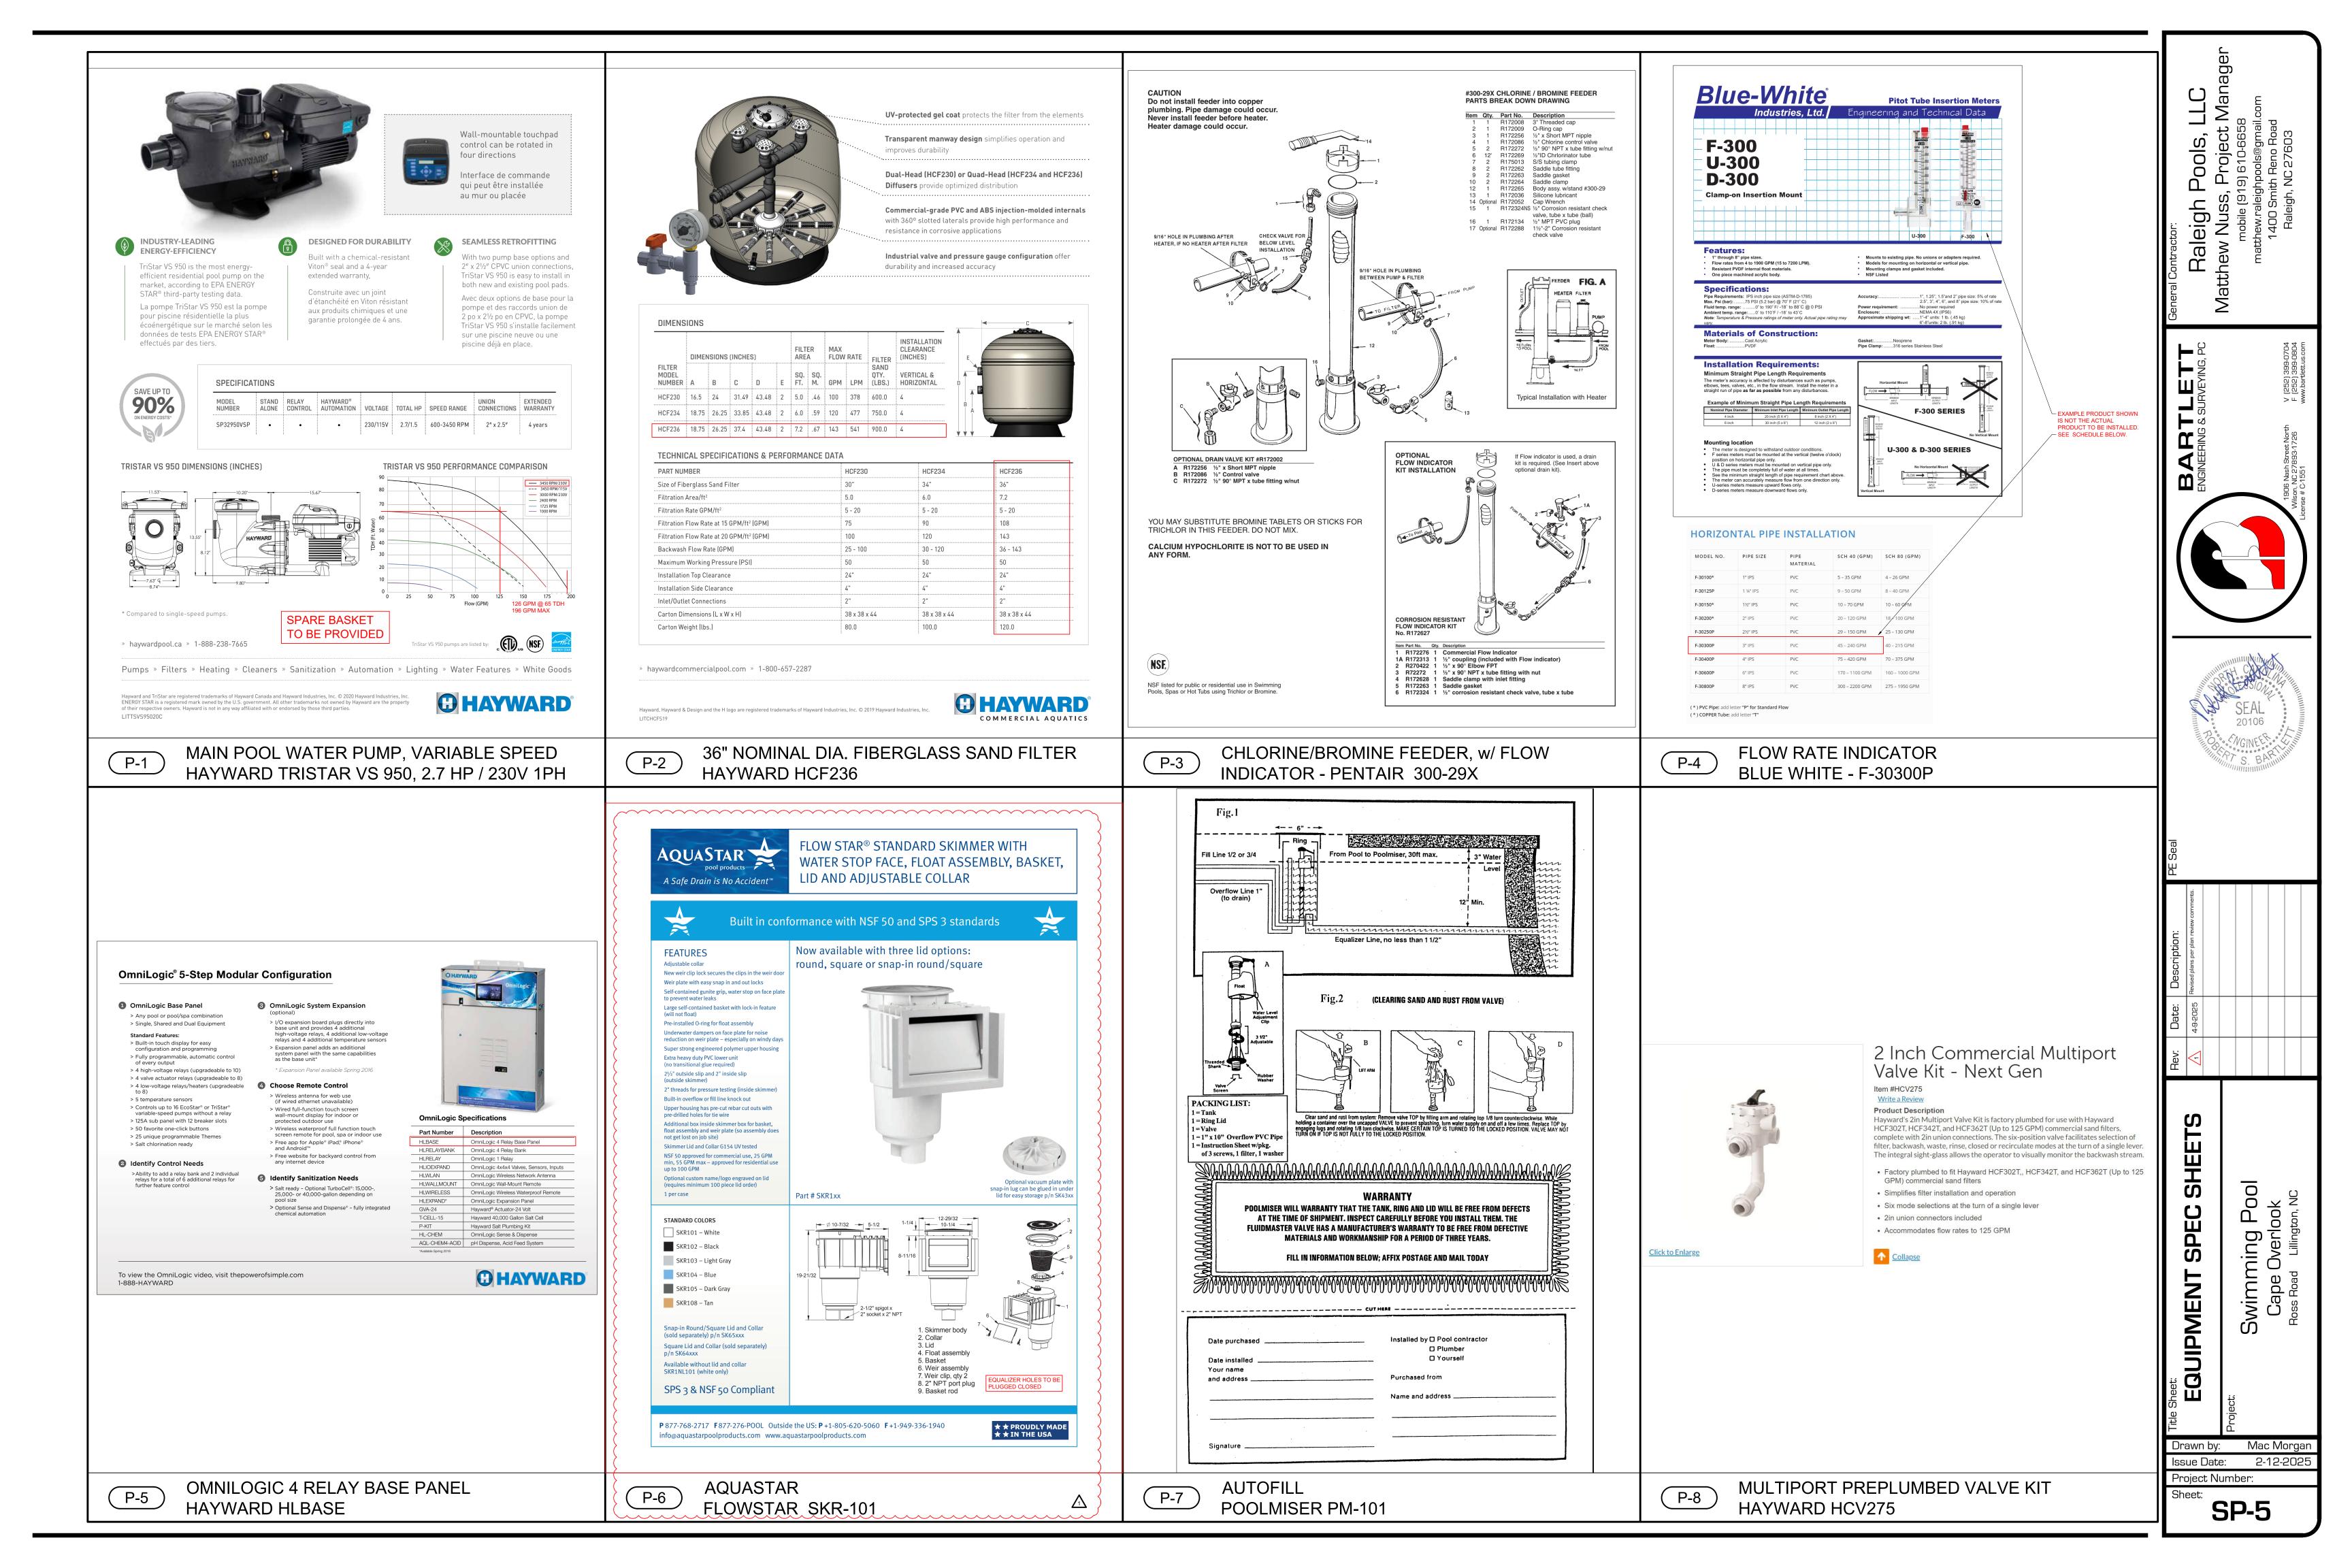
2-12-202 Issue Date: Project Number:


Drawn by: Mac Morga

WATER LINE

SIDE ELEVATION VIEW

POOL WALL SECTION SP-4/ S.R. SMITH, LLC. - MODEL # ML300 OR EQUAL



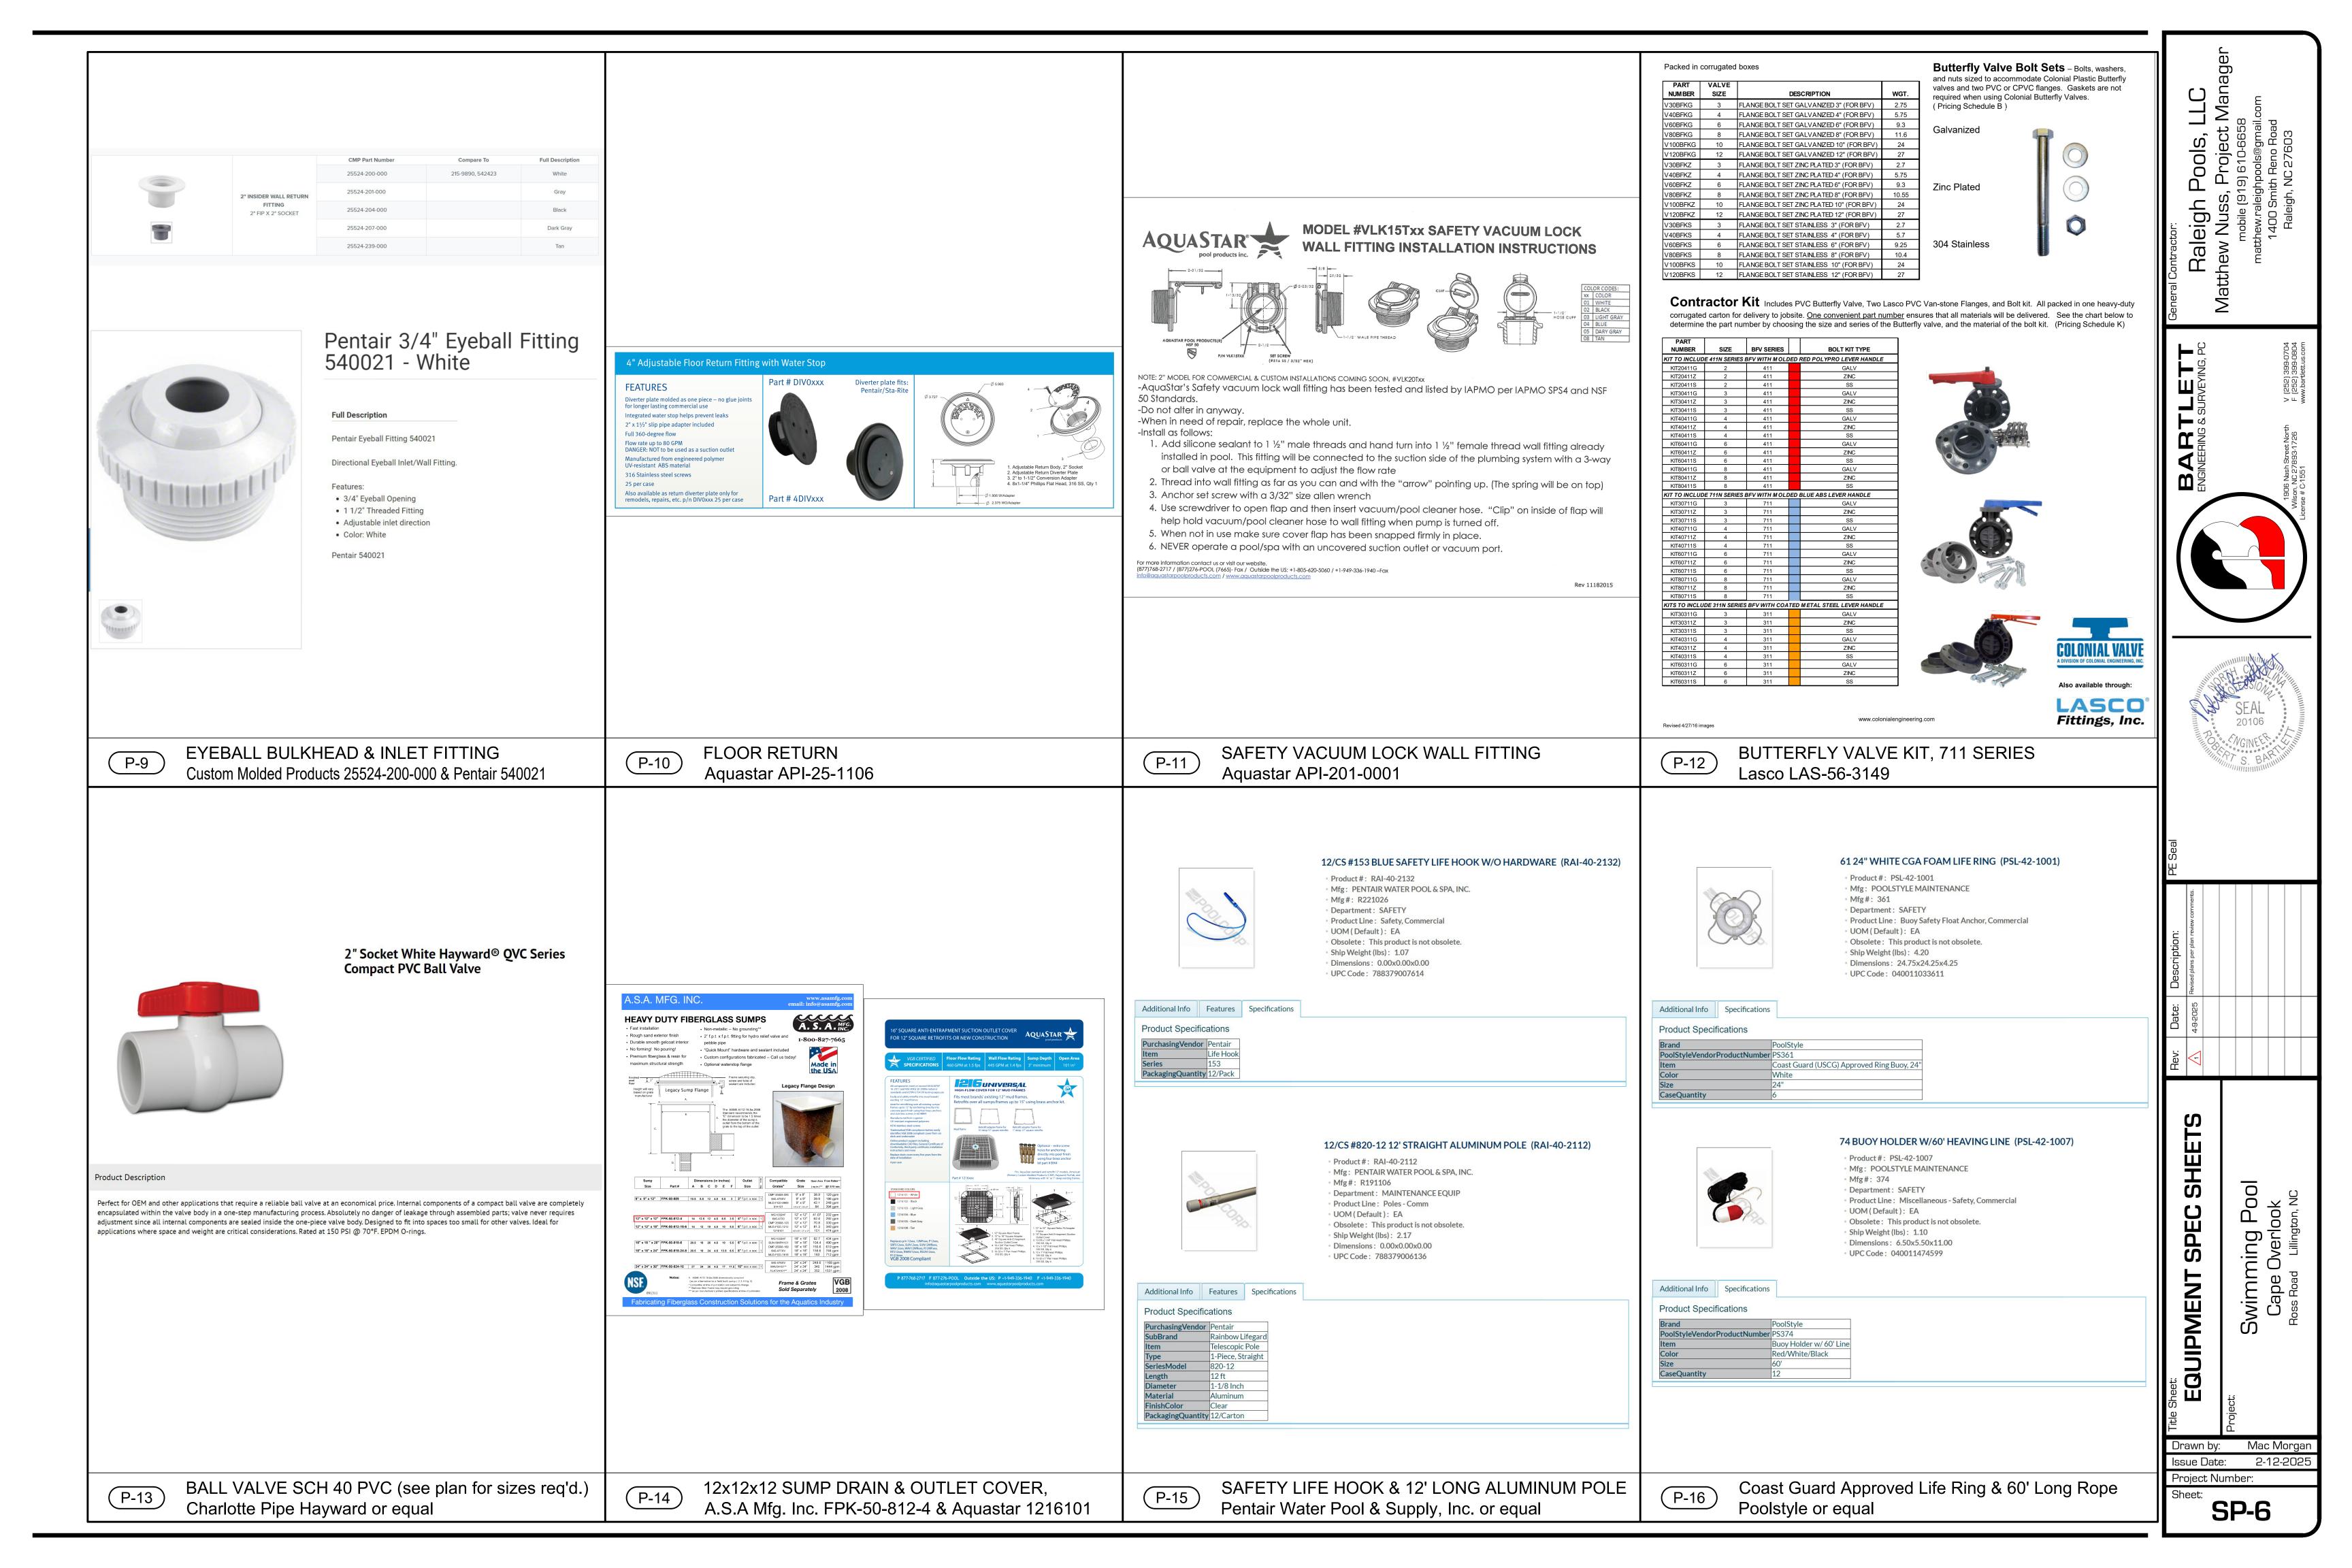

DIAMOND BRITE

Exposed Aggregate Pool Finish

TECHNICAL DATA

most reflective. Please see the recorded test values in the table below.*

ASTM International (ASTM) ANSI American National Standard Institute (ANSI)

ASTM D 4086, ASTM E1477, ASTM E 1347

Many building departments and health departments require commercial swimming pool and spa finish coatings shall be comprised of a non-pigmented white cementitious binder and shall have a dry Lightness level (CIE L value) of 80.0 or greater and a wet Luminous Reflectance Value (CIE Y value) of 50.0 or greater. The Reflectance Value wet test shows the reflective value of a finish with "0" being the least relective and "100" being the

"Pool finish, including bottom and sides, shall be of white or light colored material determined visually to contrast least with a value of gray whiter than 50 percent black on an artist's gray scale, or shown by reflectance testing to reflect more than 50 percent of visible light." Please see the recorded test values in the table.** Please consult your state's compliance requirements for commercial pool and spa finishes.

	Diamond Brite Color	CIE L Value DRY	CIE Y Value WET	Reflectance Value WET 0 - 100
	PREMIUM WHITE	88.28	65.67	81
al Compliant	SUPER BLUE	81.09	52.3	73
	BLUE	82.65	53.79	74
	COOL BLUE	84.43	54.33	76
	BLUE QUARTZ	84.09	54.1	67
***Commercial	IVORY	86.03	58.49	78
me	OYSTER QUARTZ	82.22	57.55	77
ШO	AQUA QUARTZ	84.08	54	66
Ÿ	PEARL	85.34	56.25	68
*	MARLIN BLUE	81.89	52.98	72
	AQUA BLUE	83.83	54.06	75
	CLASSIC	82.19	53.33	74
	ONYX	44.54	7.71	39
	FRENCH GRAY	64.2	21.5	48
	TAHOE BLUE	65.13	25.07	49
	MIDNIGHT BLUE	56.04	16.89	41

***Highlighted finishes comply with Florida Building Code 454.1.2.4 for commercial use.

26.27

* Refers to Florida building and health requirements ** North Carolina rules governing public swimming pools 15A NCAC 18A .2514

Our material is tested and certified by independent laboratories. All data is given in good faith, however, we reserve the right to change products and specifications without notice. SGM advises interested parties to satisfy themselves as to the accuracy of any data and seek

1502 SW 2nd Place Pompano Beach, FL 33069 954.943.2288 Fax 954.943.2402

Pool, Spa & Fountain Finishes

ANSI 118.7 standard test method for flexural

Standard test method for linear shrinkage (%)

Standard test method for tensile adhesion to

Reading as psi.

720

Reading as %

Reading as

[N/mm2]

1.40

0.80

strength (psi) modified.

(smooth trowel)

concrete [N/mm2] Diamond Brite

NaCL 60° C Cycle

Dry Finish (exposed)

DIAMOND BRITE

Exposed Aggregate Pool Finish

TECHNICAL DATA APPLICABLE STANDARDS ASTM International (ASTM) ANSI American National Standard Institute (ANSI)

ASTM C 1028-07 standard test method for slip resistance.

Diamond Brite	Diamond Brite Color	Reading as I
Dry Slip Resistance (Rough Finish)	Pearl Marlin Blue Classic Midnight Blue French Gray Tahoe Blue Onyx Super Blue Cool Blue Verde Mohave Beige Ivory Aqua Blue Blue Premium Quartz Commercial White	0.86
Dry Slip Resistance (Smoother Finish)	Oyster Quartz Blue Quartz Aqua Quartz	0.73

ASTM C 109 standard test method for
compressive strength (psi) of hydraulic
cement mortars.

Diamond Brite	Reading as psi
24 hours	2950
7 days	5750
14 days	5970
28 days	6640

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www.sgm.cc 800.641.9247



107cm 10cm

www.srsmith.com / 800.824.4387

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ML300

The ML300 is a flanged mounted pool lift that is ideal for a wide range

of pool applications. Third party tested & verified ADA compliant

State of California compliant

300 lb/I36kg lifting capacity Retrofit anchor jig is standard

Flange mounted with 4 anchor bolts LiftOperator® Intelligent Controller

Powder-coated stainless steel and aluminum construction

575-3000 ML300 200 lbs 50" 24" 28" 90kg 127cm 61cm 71cm 575-3000N ML300, no anchor

Parts & Accessories 1001495 Battery • 300-6800A Anchor Bolts, set of 4 • 900-1000 Seat Belt • 300-6900 ML300 Anchor Kit

for existing deck • 970-5000 Seat Saver Cover • 900-6000 Stability Strap • 500-5200 Cover 170-3000A Armrest Replacement (pair) • 300-6700A Anchors, set of 4

New Construction Guidelines Order pool lift and 575-3000 500-5000 (no anchors) jig ahead of pool lift

A completed Deck Profile form is required with your pool lift order.

SR Smith.

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CMP 25620-000-000 1.5"/2" Hydrostat Valve

• The CMP 25620-000-000 is Custom Molded Products Cyc Hydro Relief Valve

• Part Number: 25620-000-000

· Size: 1.5 inch or 2 inch

Type: Hydrostat Valve
 Color: White

1.5"/2" MPT Slotted Collector Tube

Product #: HAY-25-1516 | Mfg. Part #: SP1055PAK2

ADA-1

Lift Color

Due to printing technolog actual color may differ.

New Construction Jig with Anchors

ADA POOL LIFT S.R. SMITH ML-300

DIAMOND BRITE, Exposed Aggregate Pool Finish Color: "BLUE QUARTZ" by SGM Inc.

ADA 3-Bend Stair Rails

• Tubing: 1.90" OD

Wall Thickness: .065"

- Stainless Steel: 304 or 316L Marine Grade* (add –MG to part number) • Bends: 6" Radius
- Options: Powder-coating and SealedSteel Salt Friendly available
- Recommended anchors: AS-100B (order separately)
- Recommended escutcheon: EP-100F (order separately) * Minimum requirement for salt pools is 316L Marine Grade

Model No.	Description			С	D		Weight	Length	Width	Height
3HR-4ADA	4' Rail	26"	48"	34"	34"	20.38"	20 lbs 10kg	60" 152cm	42" 107cm	4" 10cm
3HR-5ADA	5' Rail	36"	60"	34"	34"	20.32"	22 lbs 10kg	72" 178cm	42" 107cm	4" 10cm
3HR-5.5ADA	5'6" Rail	32"	66"	34"	34"	19.88"	24 lbs 11kg	78" 198cm	42" 107cm	4" 10cm
3HR-6ADA	6' Rail	46"	72"	34"	34"	20.28"	26 lbs 12kg	84" 213cm	42" 107cm	4" 10cm
3HR-6.5ADA	6'6" Rail	32"	78"	34"	34"	35"	28 lbs 13kg	90" 229cm	42" 107cm	4" 10cm

32 lbs 108" 42" 4"

www.srsmith.com / 800.824.4387

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ADA 3-Bend Stair Rails

- Tubing: 1.90" OD Wall Thickness: .065"
- Stainless Steel: 304 or 316L Marine Grade* (add –MG to part number) • Bends: 6" Radius
- Options: Powder-coating and SealedSteel Salt Friendly available Recommended anchors: AS-100B (order separately)
- Recommended escutcheon: EP-100F (order separately)
- * Minimum requirement for salt pools is 316L Marine Grade

			'					
Model No.	Description			С	D		Weight	Length
3HR-4ADA	4' Rail	26"	48"	34"	34"	20.38"		60" 152cm
OLID EADA	D "	00"	00"			00.00"	00 !!	70"

OTH CONDIT	O Haii	00	00	04	04	20.02	10kg	178cm	107cm	10cm
3HR-5.5ADA	5'6" Rail	32"	66"	34"	34"	19.88"	24 lbs 11kg	78" 198cm	42" 107cm	4" 10cm
3HR-6ADA	6' Rail	46"	72"	34"	34"	20.28"	26 lbs 12kg	84" 213cm	42" 107cm	4" 10cm
3HR-6.5ADA	6'6" Rail	32"	78"	34"	34"	35"	28 lbs 13kg	90" 229cm	42" 107cm	4" 10cm
3HR-7ADA	7' Rail	36"	84"	34"	34"	40"	30 lbs 14kg	96" 244cm	42" 107cm	4" 10cm
3HR-8ADA	8' Rail	30"	96"	34"	34"	53"	32 lbs	108"	42"	4"


Economy Ladder

2" HYDRO RELIEF VALVE, CMD 25620-000-00


2" COLLECTOR TUBE, HAYWARD HAY-25-1516 🛆

- Tubing: 1.90" OD
- Stainless Steel: 304 or 316L Marine Grade* (add -MG to part number)
- Treads: LTDF-101 Plastic (Econoline) or LTDF-103 Stainless Steel (Elite)
- Bends: 6" Radius
- Options: Powder-coating and SealedSteel Salt Friendly available
- Recommended anchors: AS-100B (order separately) Recommended escutcheon: EP-100F (order separately)
- * Minimum requirement for salt pools is 316L Marine Grade

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• For stock powder-coated products, see page 72. For stock SealedSteel Salt Friendly products, see page 73. . Frames extend 6%" from the pool wall Frame is secured to the pool deck with two anchor sockets on 20" centers (Elite model) or 19" centers (Econoline model). The lower end of the frame is bent to meet the pool wall and fitted with two white rubber bumpers (WR8-100A) • For safety steps substitute the letterT at end of part number. For example, VLLS-102T for a two-step safety ladder.

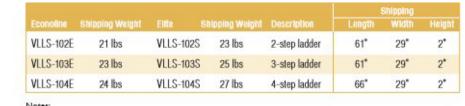

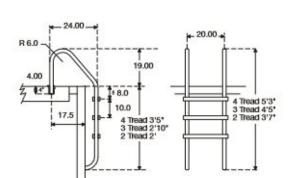

- Use up to 86% less energy than incandescent lights and last 10x longer
- 10 fixed colors and seven color-changing shows • Can be installed in a little as 4 inches below the waterline, and on the wall or the
- floor without a rock guard • 12V, 2-wire, all plastic design with no exposed metal and an unbreakable lens
- requires no bond, no ground and no GFCI for safe installation

- Low-profile UCL Niche provides incredible installation savings for new
- Ships with smooth white and silver luster starburst trim rings. Additional rings are

101 colors and 11 color-changing shows available in Network mode when used with Pro Logic[®]

R-1


SR.Smith.

STAIR RAIL, 60" MARINE GRADE ADA 3-BEND S.R. SMITH 3HR5ADA-MG

R-2

SR Smith.

STAIR RAIL, 84" MARINE GRADE ADA 3-BEND S.R. SMITH 7HR4ADA-MG

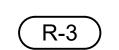

POOL LADDER S.R. SMITH VLLS-103S-MG (L-1

Click to Enlarge

UNIVERSAL COLOR LOGIC, 12V LED HAYWARD LPCUS1110

UCL Pool LED Color 12V/100 ft. (Expert Line) Item #LPCUS11100 Write a Review EXPERT LINE[™] products are only available through your local pool professional. Universal ColorLogic® color LED lighting will transform your outdoor environments They're the only, UL-Listed lights to retrofit virtually any existing pool and spa with vibrant color - even those with just one light. 100% brighter* than any on the market, these energy-efficient, lights deliver spectacular color to pools with a single incandescent light or pools with colored finishes, and breakthrough cost savings and installation versatility for new pools, spas and fountains. All-plastic, low-voltage design, combined with all-plastic thin UCL Niche eliminates the need for bonding, grounding and GFCI. The thin UCL Niche also reduces cost for dig, steel and gunite because it is only 2.75 inches front-to-back and mounts to the face of the rebar grid. Pool and spa lights are UL-Listed for wall or floor installs without a rock guard and can be positioned just 4 inches from lens to water

level - perfect for steps, beach entries and fountains. UL-Listed for installation in virtually any pool or spa niche

100% brighter* than any color LED light on the market

Programmable to match ColorLogic 4.0 or Pentair[®] SAm[®] light shows

 Available in 30, 50, 100 and 150-foot cord lengths Available in Stand-Alone or Network

• Retrofit transformer kits available for easy high-to-low-voltage J-Box conversion

300-watt transformer available for multi-light installations

also available in faux chrome, black, beige, and gray

Ø

SHEE

Pool

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Mac Morga Issue Date: 2-12-202

Project Number:

Sheet:

SP-7