



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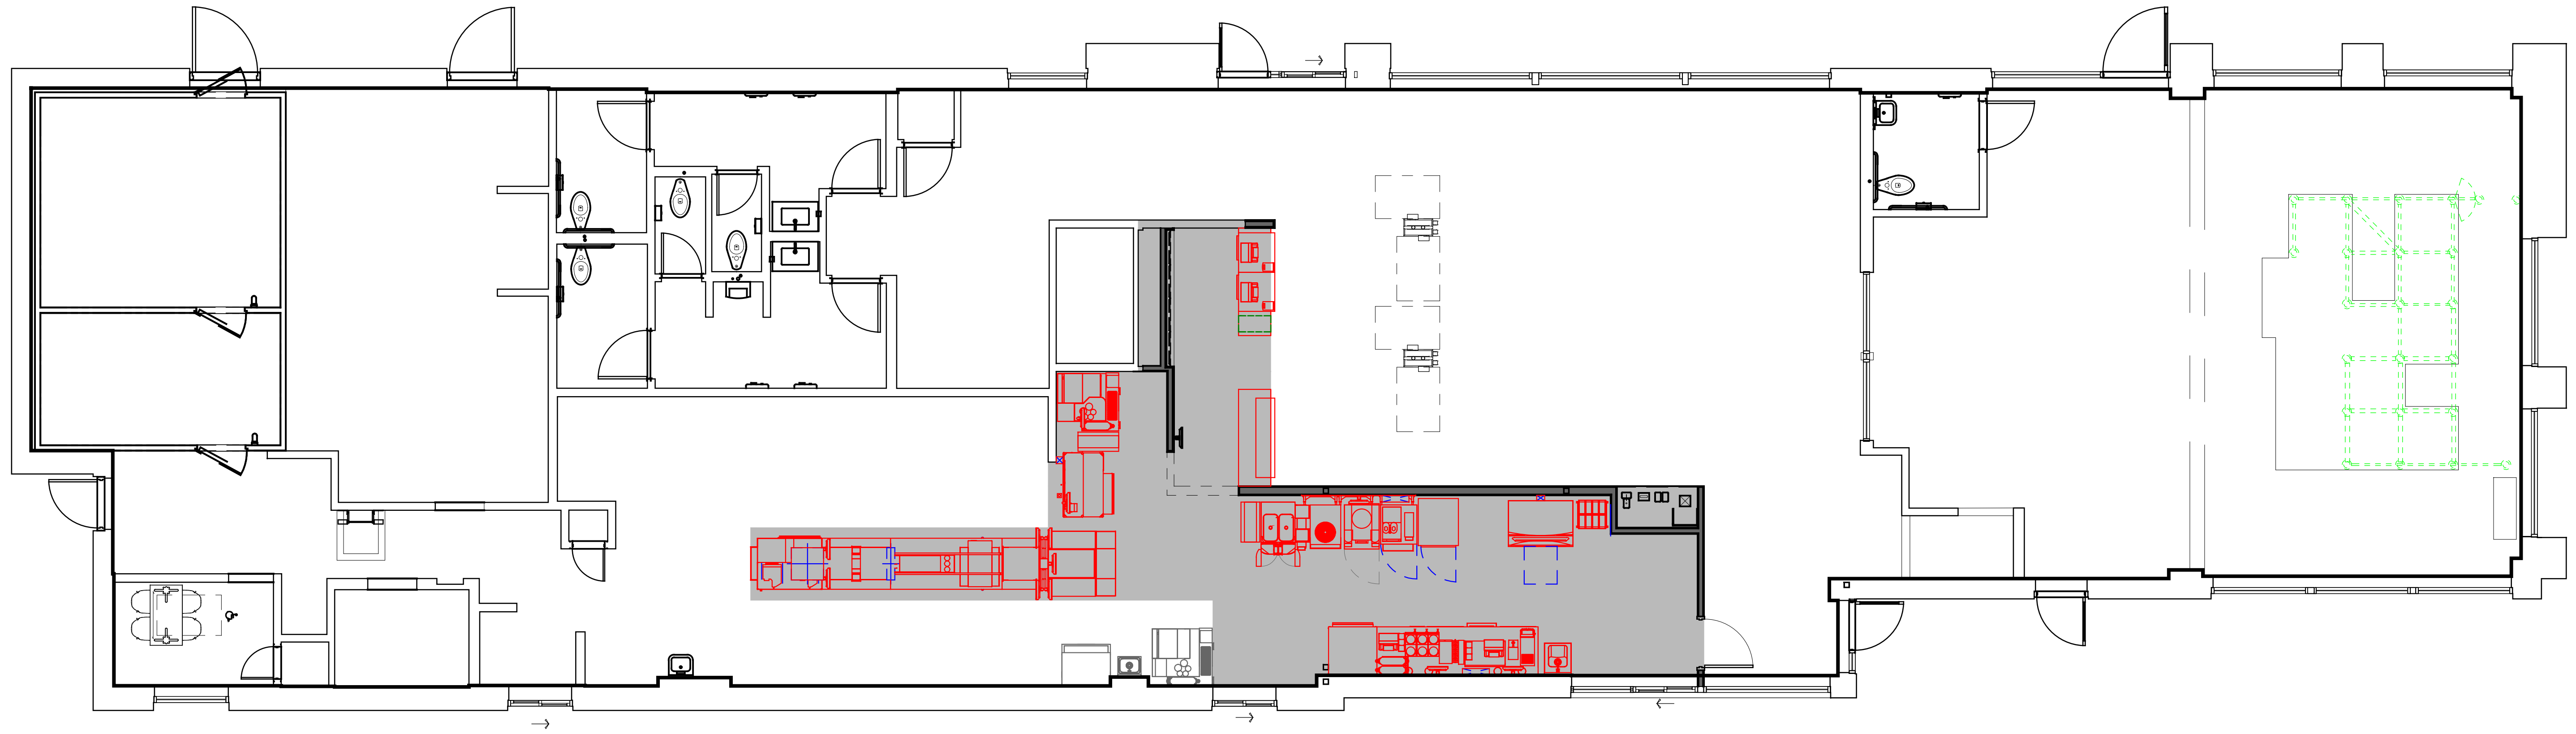
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NOTE:  
OVERALL SQUARE FOOTAGE = 5,320  
WORK AREA (RECONFIGURED SPACE) = 690 SQUARE FEET OR 13%.

 WORK AREA (RECONFIGURED SPACE)

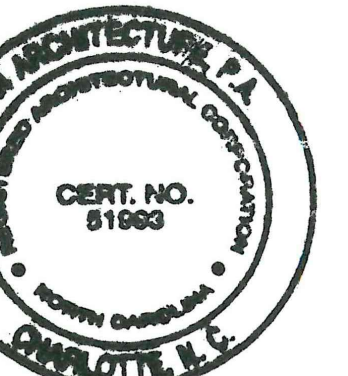

Rev	Date	Description

**McDonald's**  
McDonald's Store - Site ID# 32-0051  
NSN # 2550  
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Drawn By JAM  
Checked By MJR  
Issue Date 6/6/2023  
Project No 220681

Sheet Title  
Work Area Plan

Sheet Number  
**G-004**

 Work Area Plan  
3/16" = 1'-0"






**DEMOLITION PLAN NOTES:**


- COORDINATE ALL DEMOLITION SHOWN W/ THE ARCH DRAWINGS PRIOR TO CONSTRUCTION.
- FIELD VERIFY ALL EXISTING CONDITIONS SHOWN PRIOR TO DEMOLITION. THE ENGINEER SHALL BE NOTIFIED WHEN EXISTING CONDITIONS VARY FROM WHAT IS ANTICIPATED.
- VERIFY SUPPORT OF EXISTING HEADERS, BEAMS, JOISTS, WALLS, AND ROOF FRAMING PRIOR TO THE START OF DEMOLITION.
- WHERE EXISTING LOAD BEARING WALLS AND/OR FRAMING IS TO BE REMOVED, PROVIDE SHORING AND/OR TEMPORARY SUPPORT AS REQUIRED PRIOR TO ANY DEMOLITION. GC TO EMPLOY ENGINEER TO SUBMIT SHORING PLAN FOR EOR APPROVAL BEFORE DEMOTION WORK MAY BEGIN.
- DO NOT OVERCUT SAW JOINTS IN SLAB PAST PORTION TO BE REMOVED.

**FOUNDATION & SLAB ON GRADE NOTES:**

- FOR DESIGN CRITERIA AND GENERAL NOTES, SEE SHEET S0.1
- FOR DIMENSIONS, SECTIONS AND ELEVATIONS NOT SHOWN, SEE ARCH.
- ELEVATIONS ARE BASED ON A T/GROUND FLOOR SLAB DATUM OF 100'-0". SEE CIVIL AND ARCH DWGS FOR ACTUAL ELEVATIONS.
- T/ISOLATED FTG EL = 1'-4" BELOW TOP OF SOG, TYP UON.
- T/WALL FTG EL = 1'-4" BELOW TOP OF SOG, TYP UON.
- ▨ DENOTES EXISTING 8" CMU WALL.
- SEE 6/S3.1 FOR SOG CRACK CONTROL JOINT.
- CONTRACTOR TO COORDINATE WITH EXISTING STRUCTURES, ALL PRECAUTIONS SHALL BE TAKEN TO AVOID UNDERMINING OF EXISTING FOUNDATIONS INCLUDING SHEET PILING, SOIL STABILIZATION, ETC.
- BOTTOM OF NEW FOOTINGS SHALL MATCH BOTTOM OF EXISTING FOOTINGS.
- NEW SLAB ON GRADE INFILL. NEW SLAB SHALL CONSIST OF 5" THICK CONCRETE SLAB ON VAPOR RETARDER & COMPACTED FILL. REINFORCE W/ FIBERMESH OR WWF66-W14XW14. PROVIDE DOWELS AROUND ENTIRE PERIMETER INTO EXISTING SLAB PER 2/S3.1.

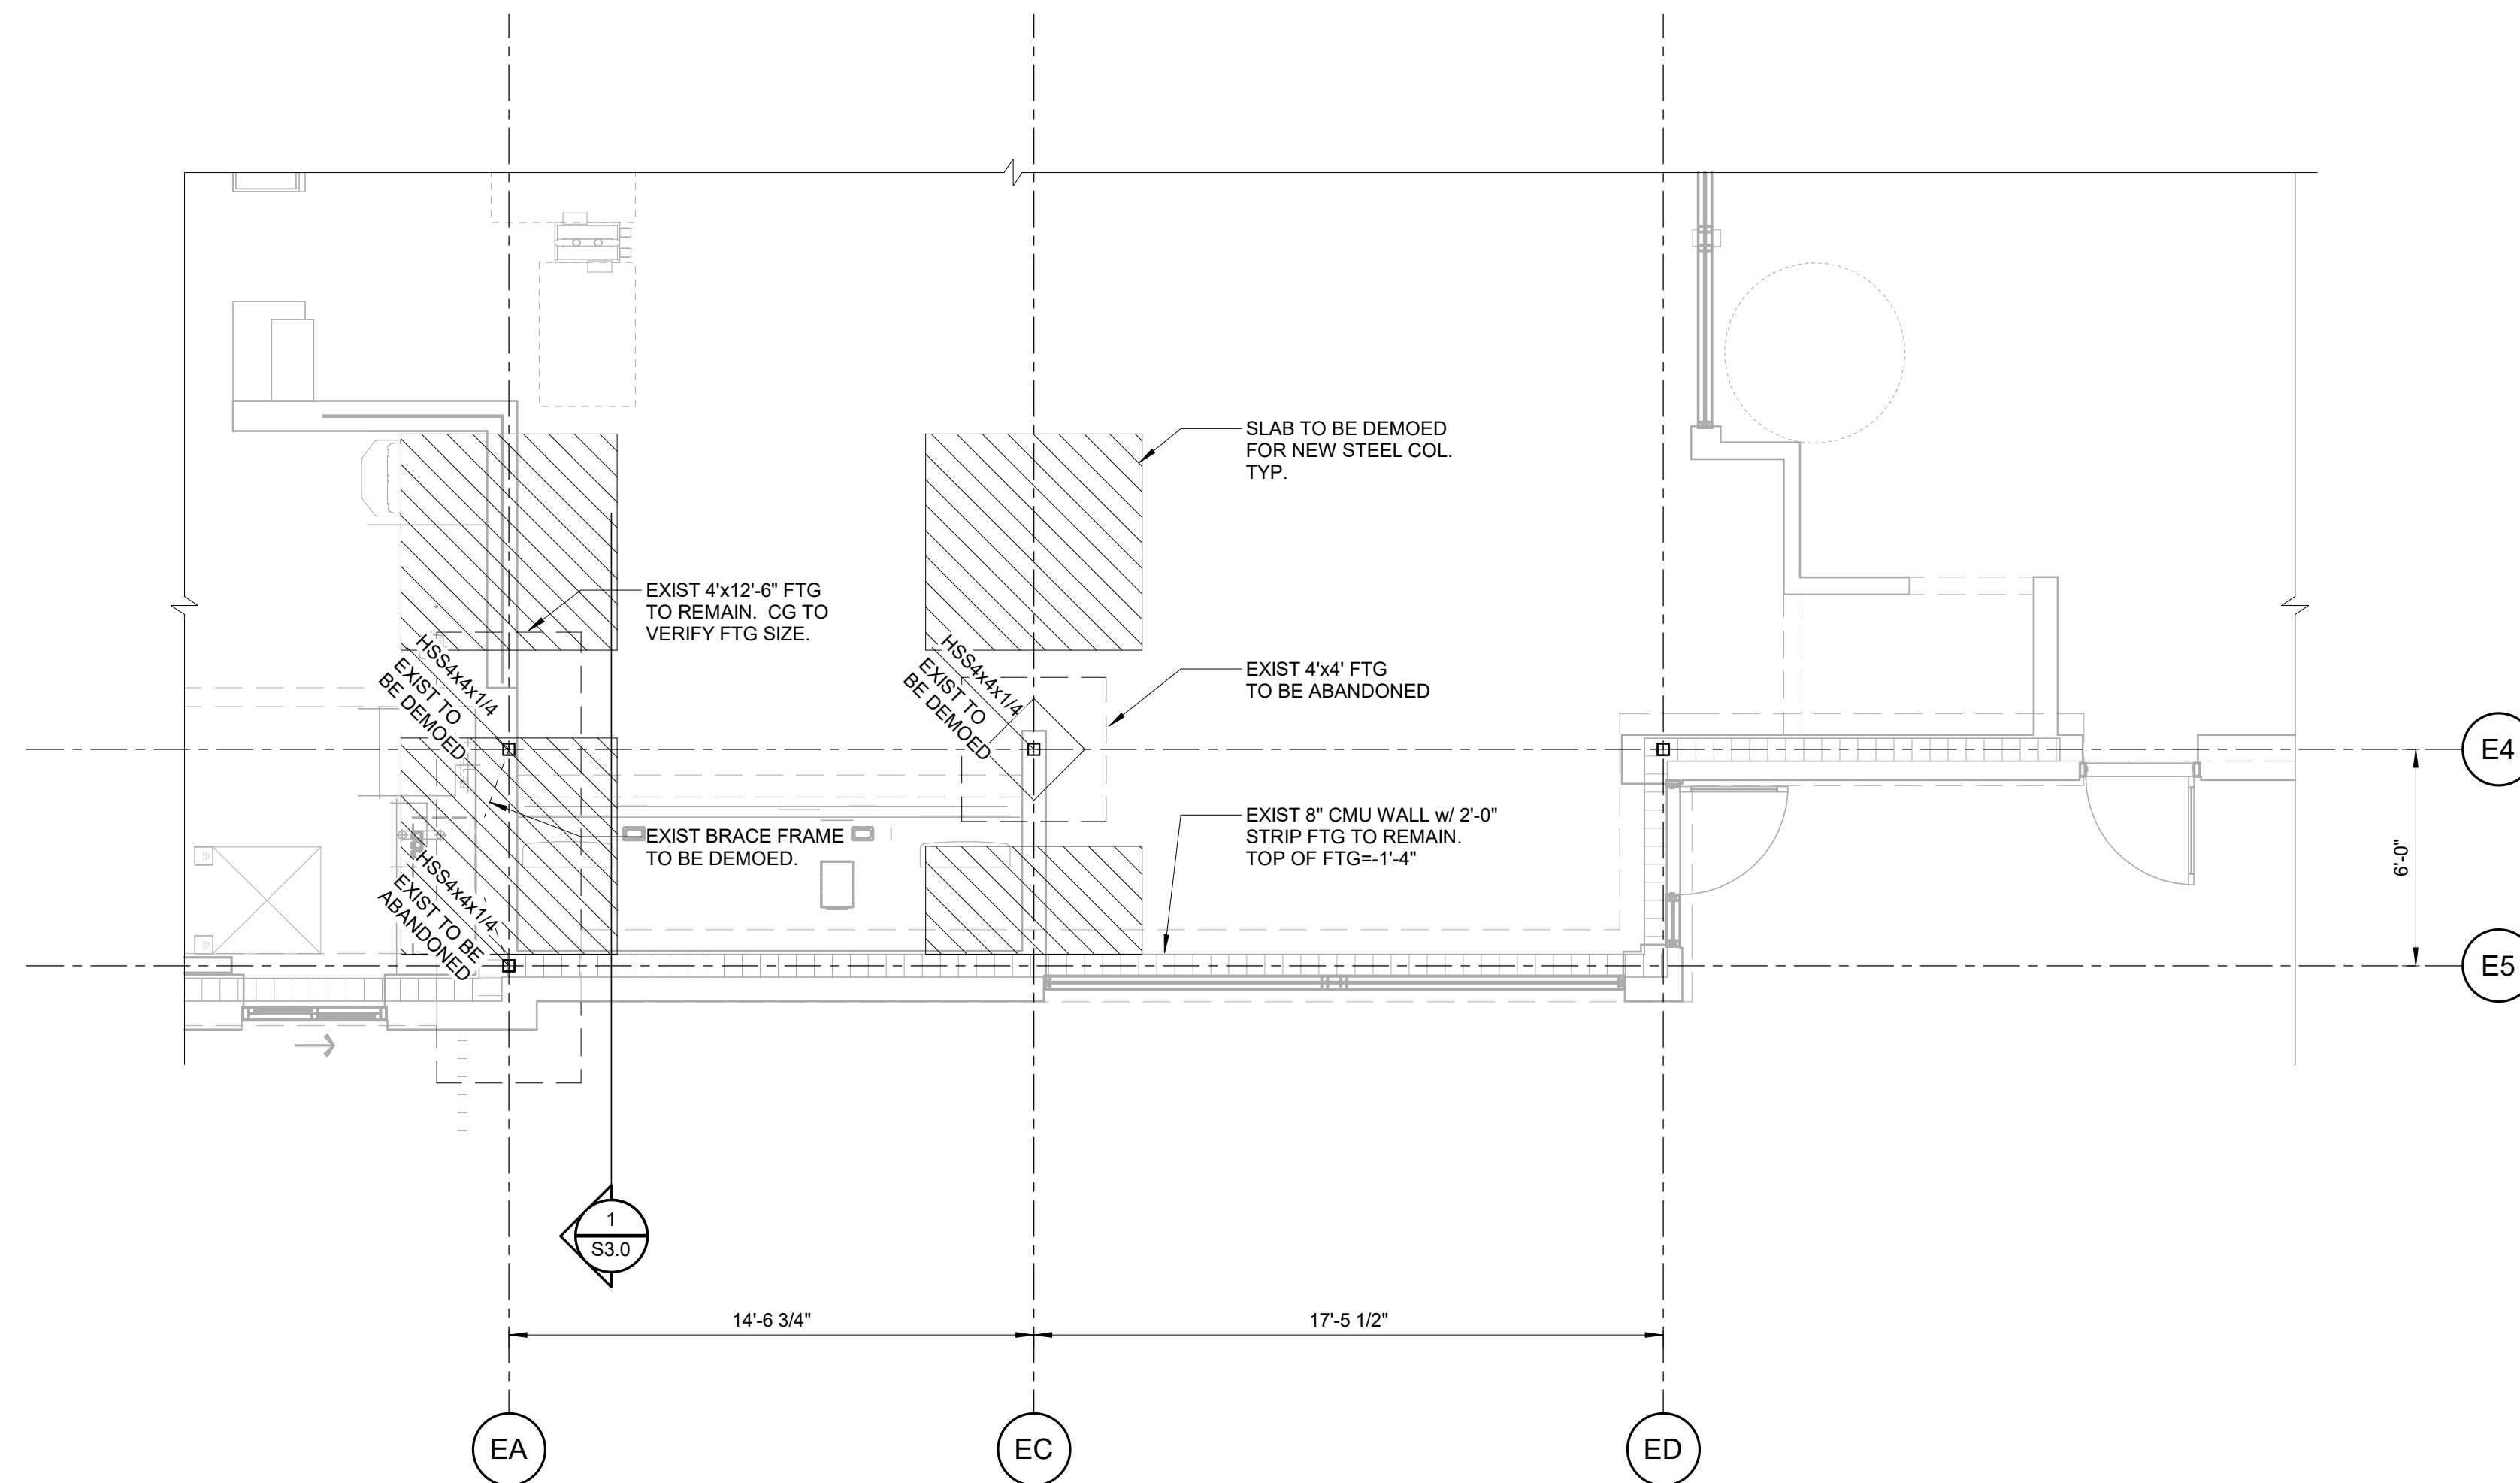

**1**  
S1.0  
**DEMOLITION FOUNDATION PLAN**  
SCALE: 1/4" = 1'-0"

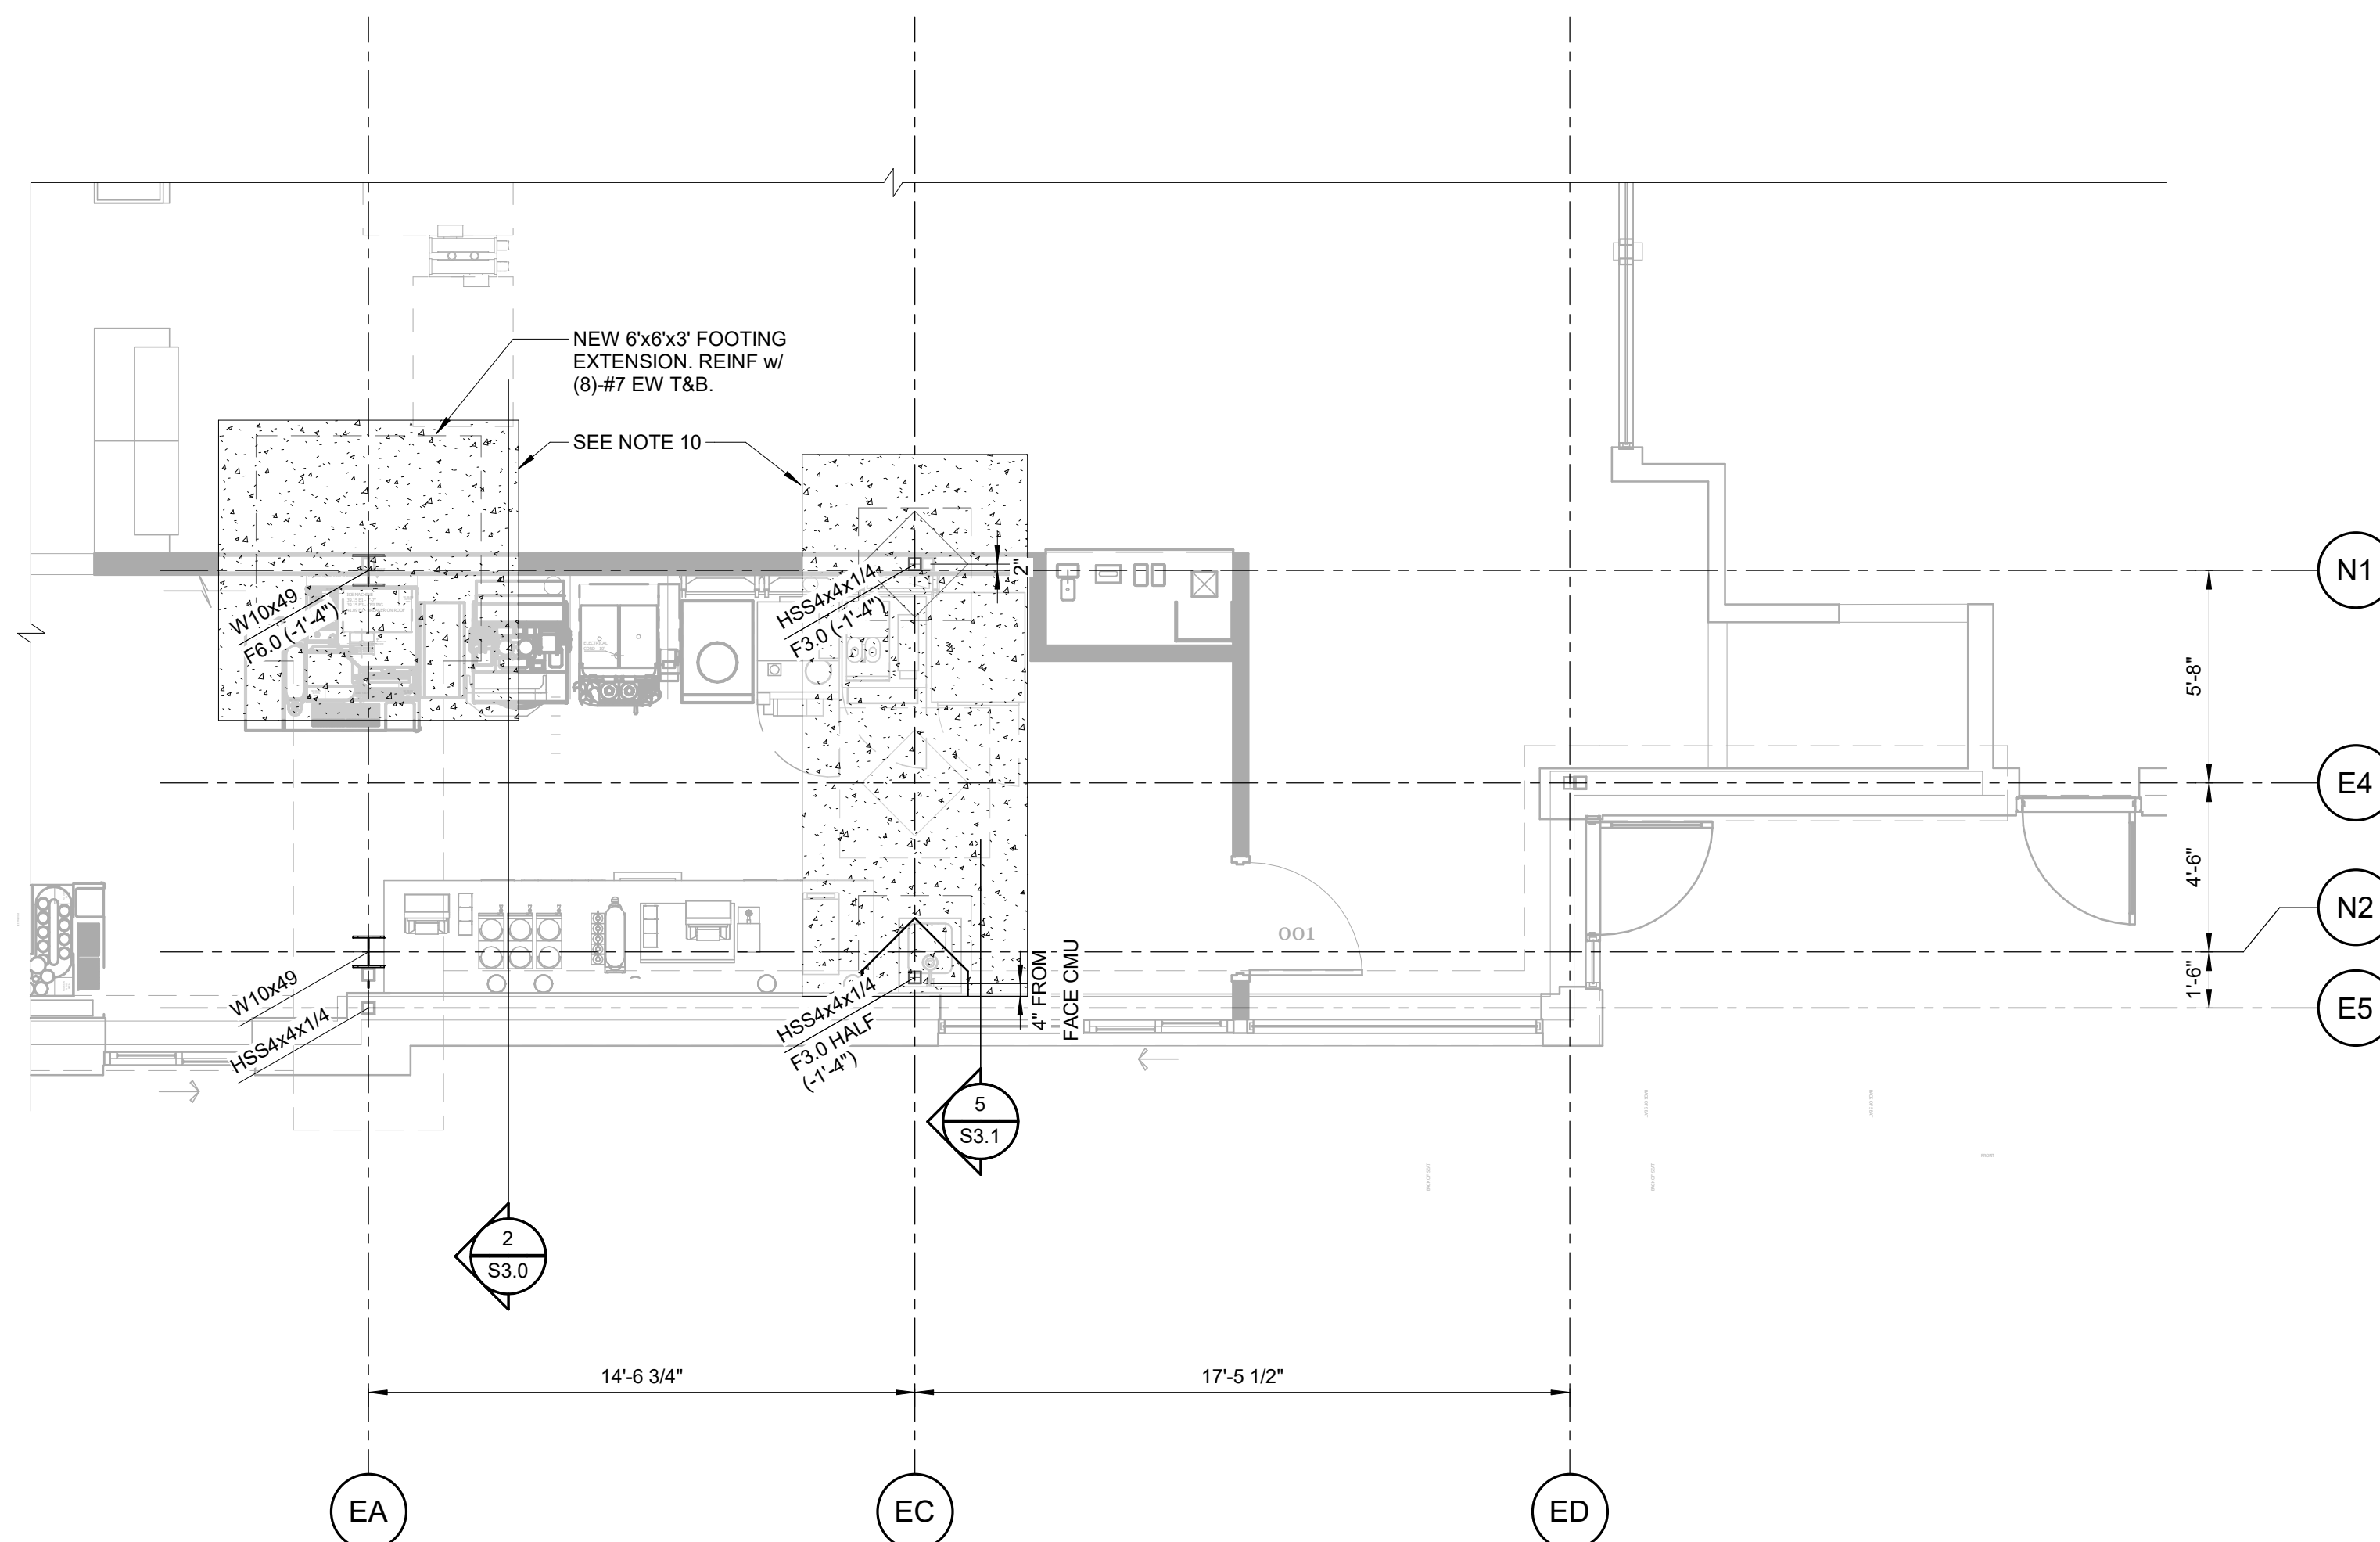

**2**  
S1.0  
**NEW WORK FOUNDATION PLAN**  
SCALE: 1/4" = 1'-0"

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Checked By AB  
Issue Date 05/23/2023  
Project No 220679

Sheet Title  
**FOUNDATION PLANS**

Sheet Number  
**S1.0**









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**1** EXISTING BRACED FRAME  
S3.0 SCALE: NTS



**2** NEW BRACED FRAME  
S3.0 SCALE: NTS
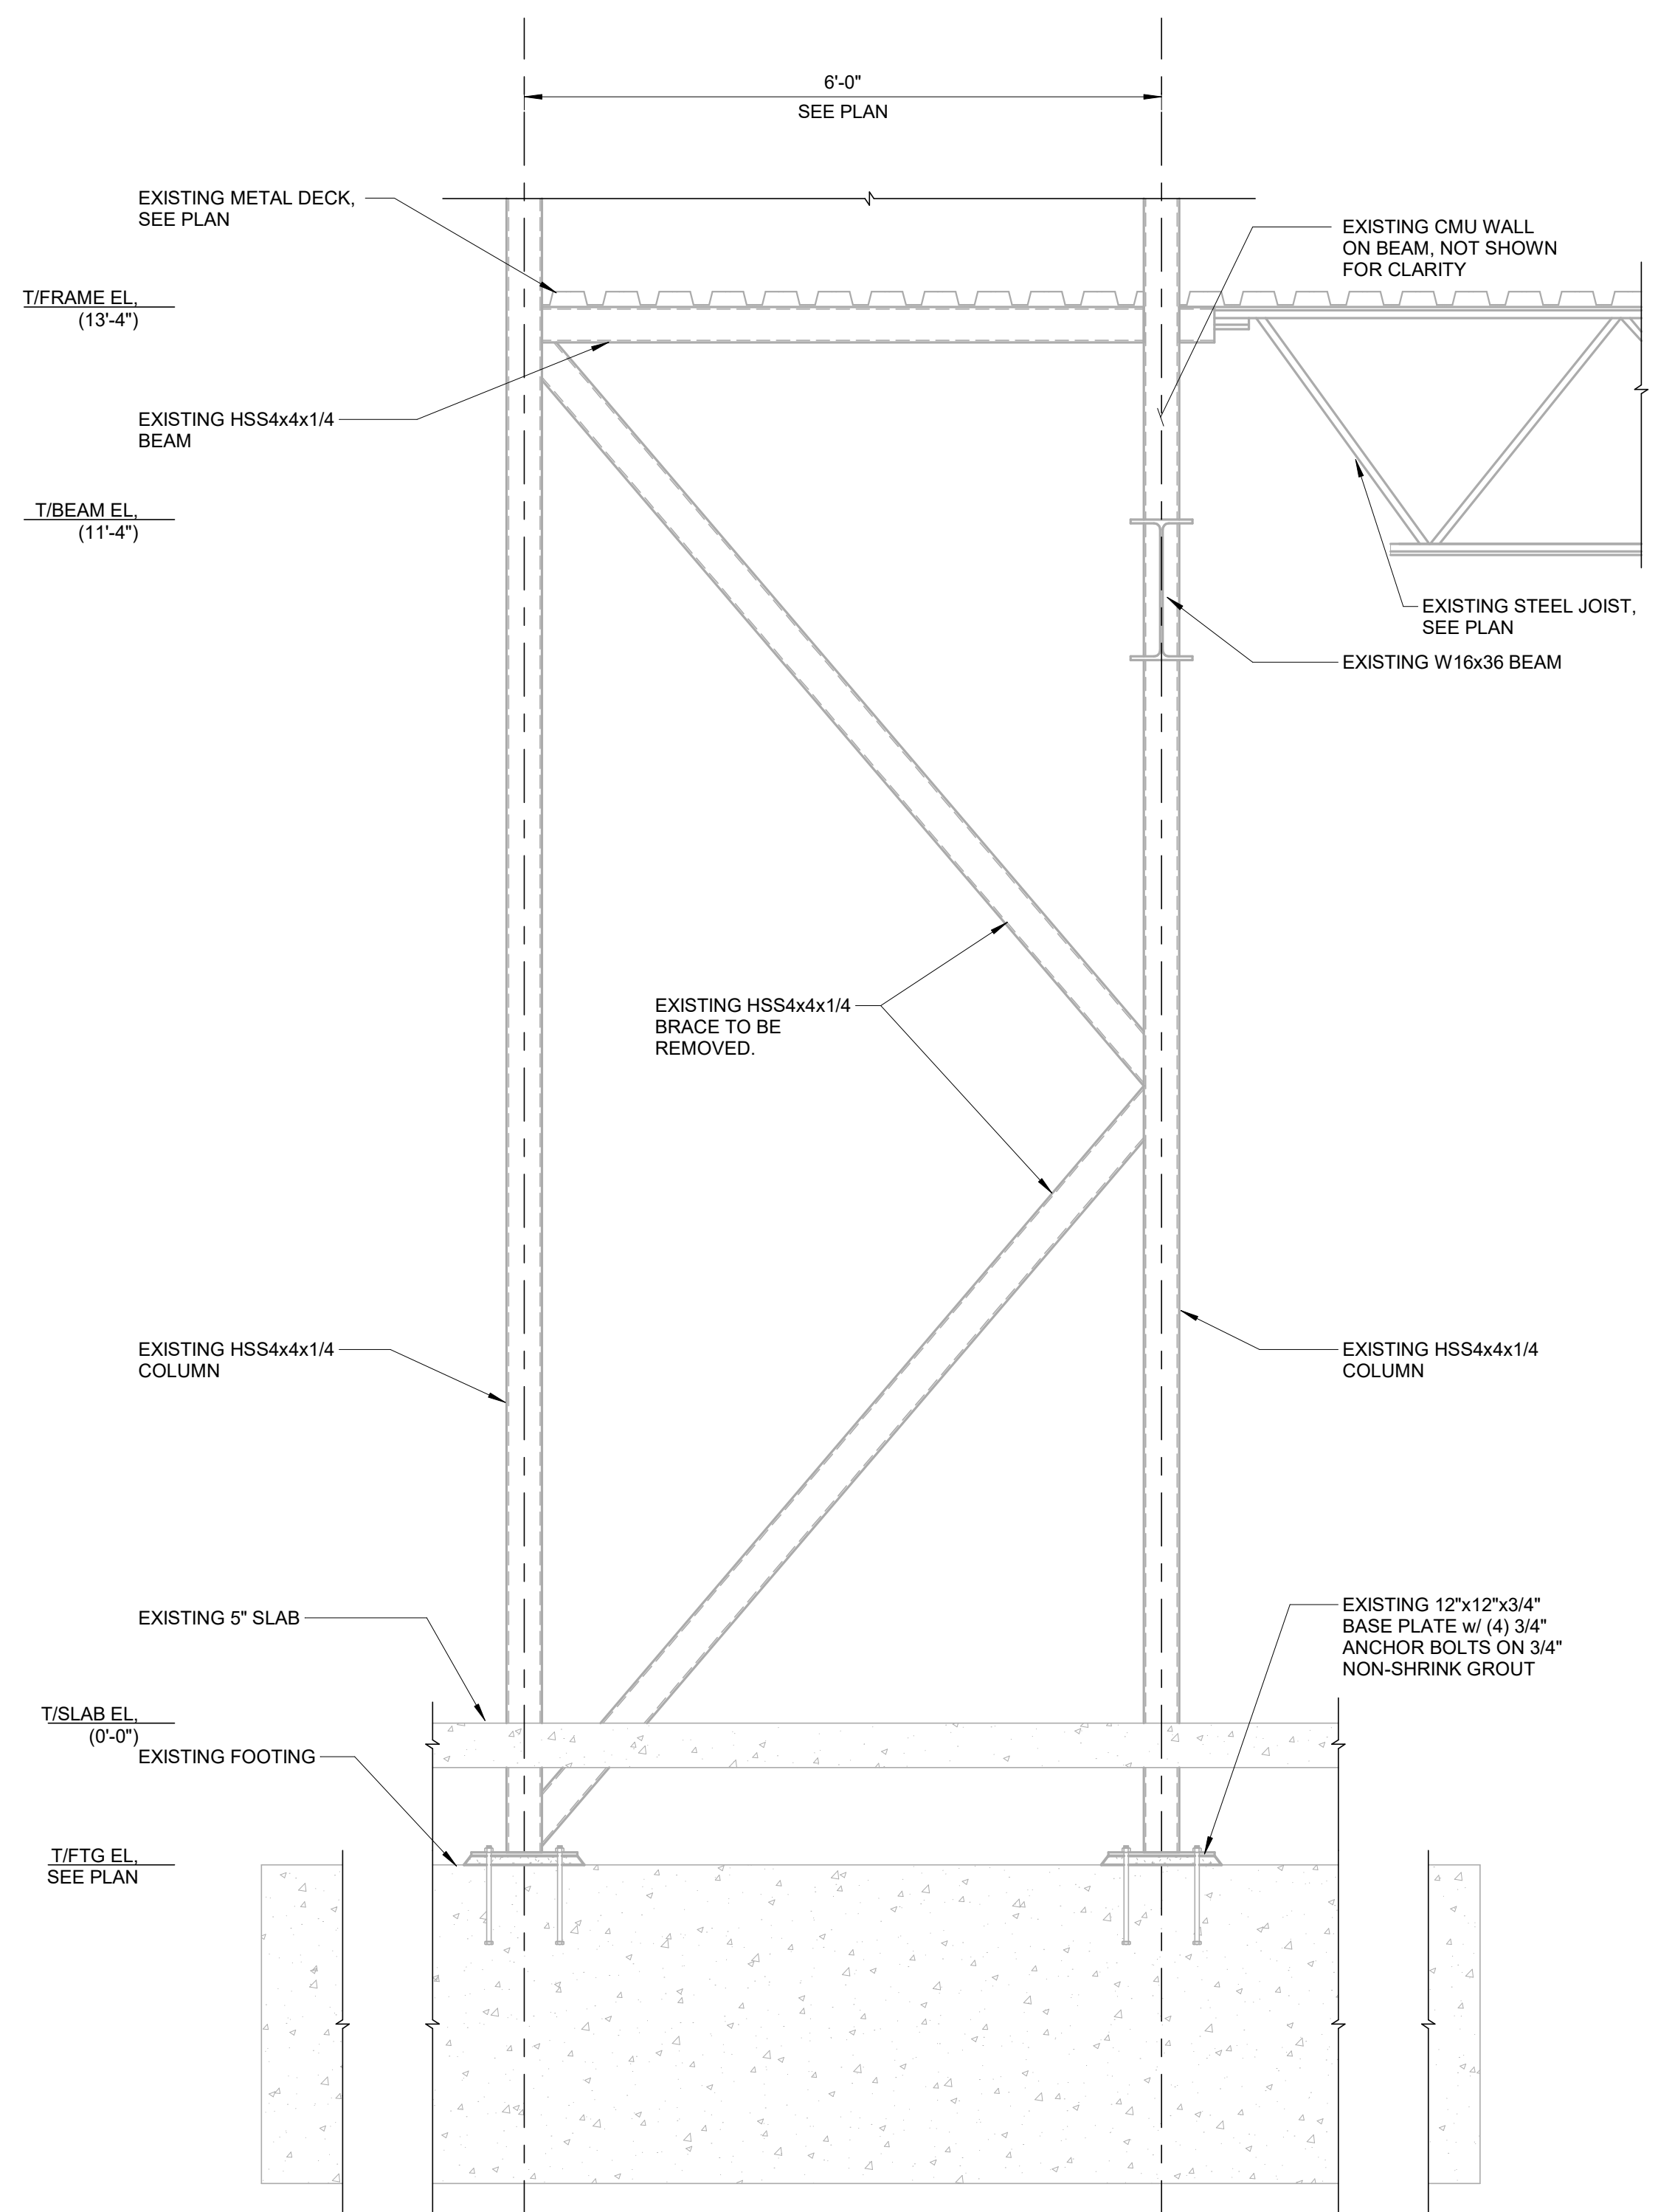
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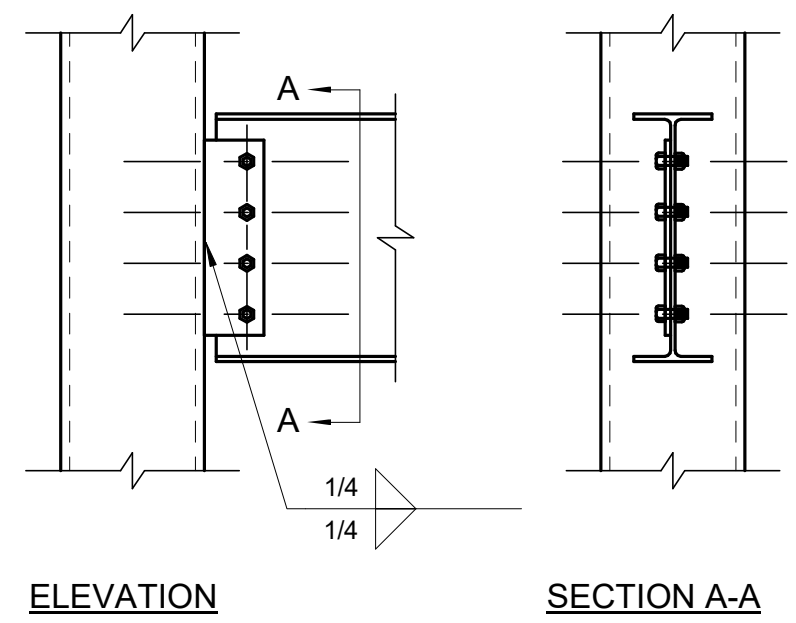
Sheet Title  
BRACED  
FRAME  
ELEVATIONS

Sheet Number  
**S3.0**

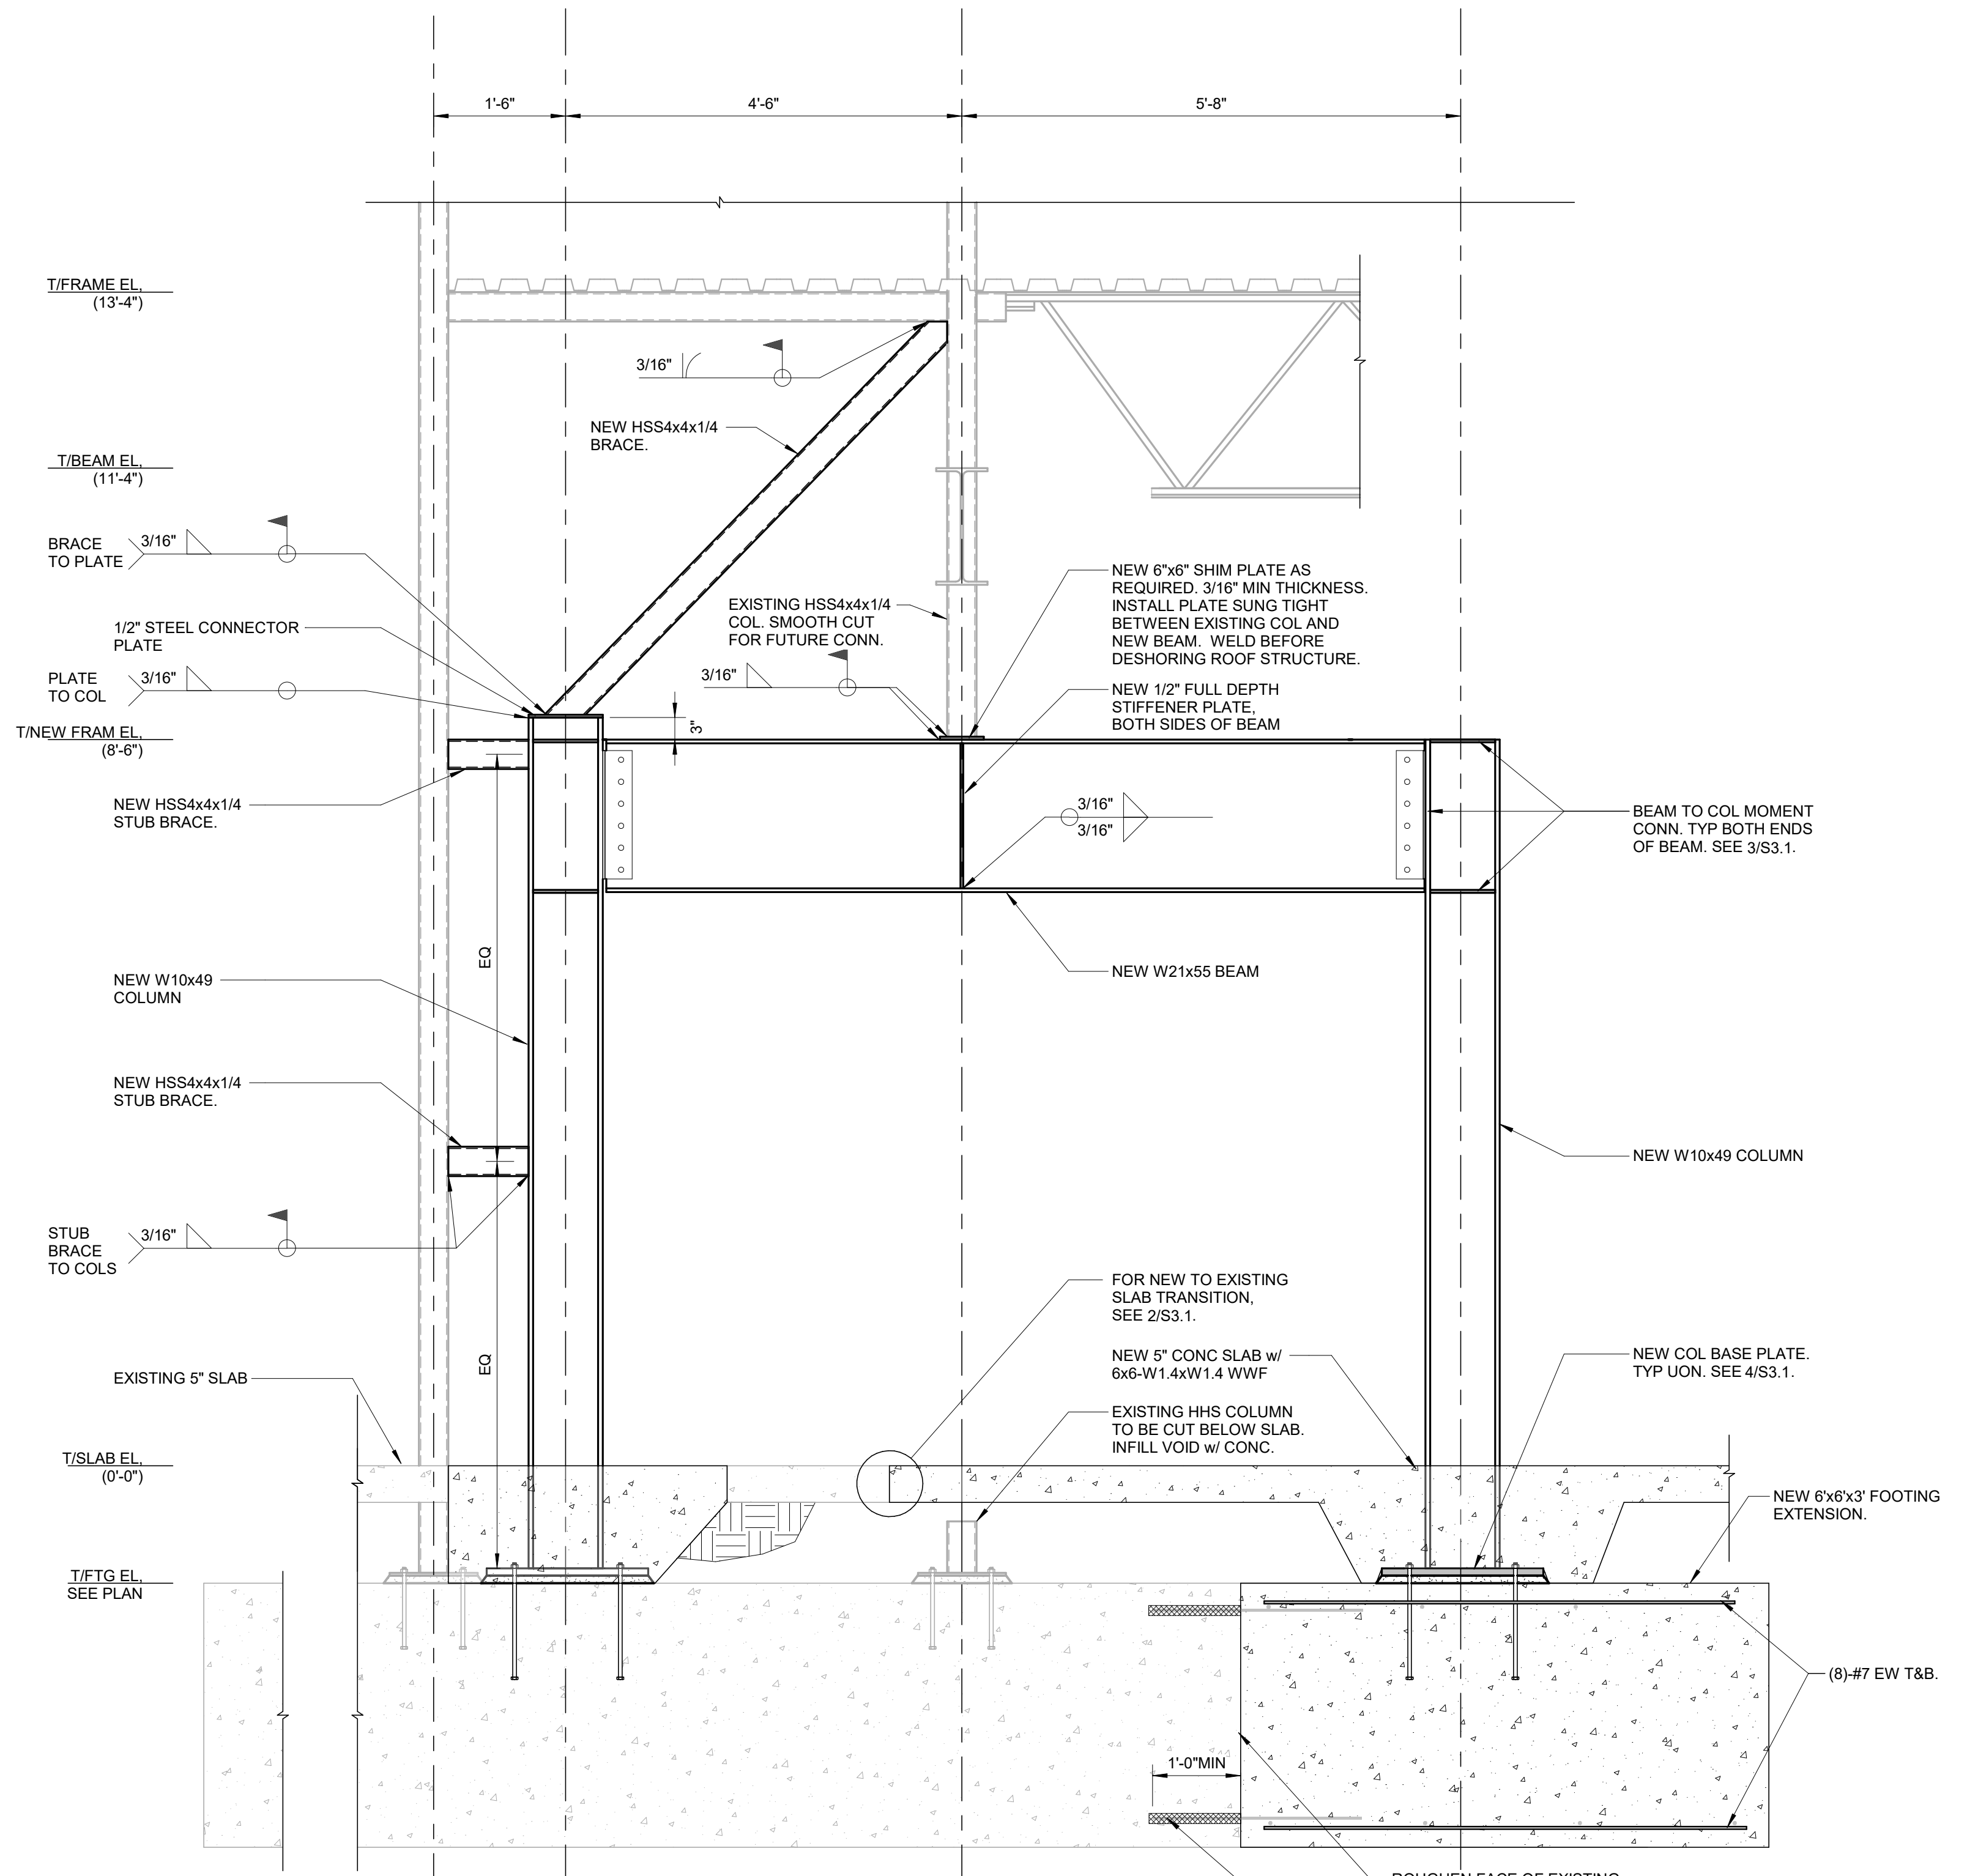


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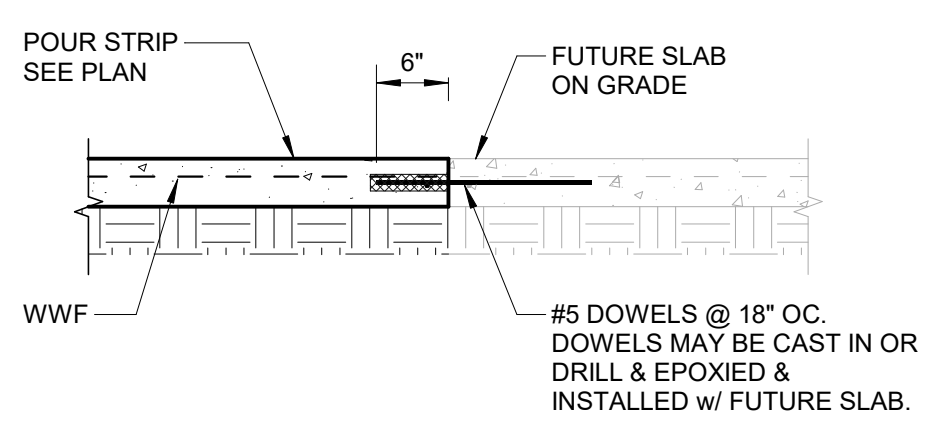


COLUMN SIZE	MINIMUM WALL THICKNESS
HSS 4x4	1/4"
HSS 5x5	1/4"
HSS 6x6	1/4"
HSS 7x7	1/4"
HSS 8x8	1/4"
HSS 9x9	5/16"
HSS 10x10	5/16"
HSS 12x12	3/8"
HSS 14x14	1/2"
HSS 16x16	1/2"




CONNECTION SCHEDULE			
CONN TYPE	FACTORED LOAD CAPACITY	SINGLE PLATE SIZE	MINIMUM BEAM SIZE
7	108K	PL5/16"x4"x20 1/2"	W36, W33
6	89K	PL5/16"x4"x17 1/2"	W30, W27
5	81K	PL5/16"x4"x14 1/2"	W24, W21
4	62K	PL5/16"x4"x11 1/2"	W18, W16
3	43K	PL5/16"x4"x8 1/2"	W14, C15, W12, C12
2	24K	PL5/16"x4"x5 1/2"	W10, C10, W8, C8

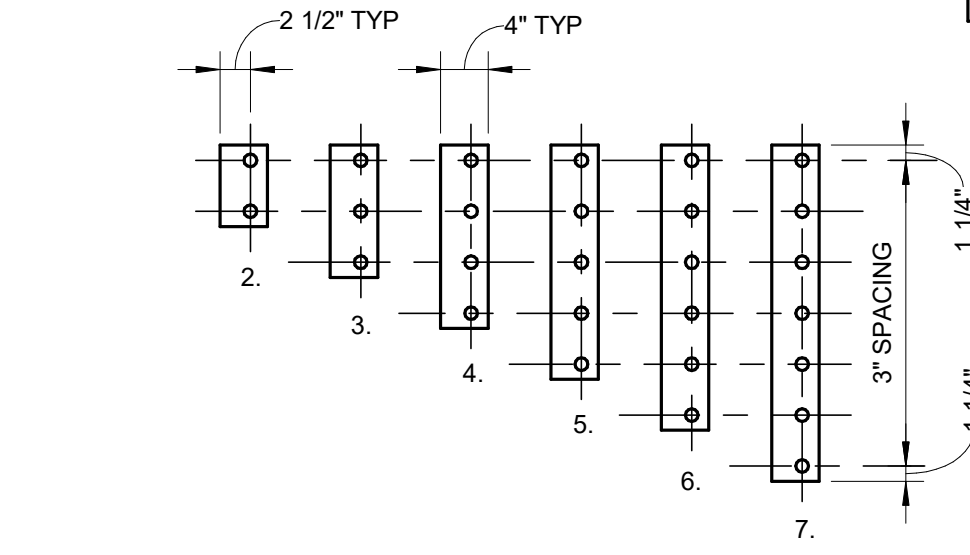- NOTES:
- BOLTS SHALL BE 3/4"Ø A325-N BEARING TYPE. BOLT LIMIT STATE IN SINGLE SHEAR = 17.9 KIPS.
  - WELDING MAY BE USED IN LIEU OF BOLTING. WELDS SHALL BE CAPABLE OF RESISTING LOADS SHOWN ABOVE FOR THIS SCHEDULE TO BE VALID.
  - COLUMN THICKNESS SHALL BE THE MINIMUM TABULATED ABOVE FOR THIS SCHEDULE TO BE VALID.
  - TABLE VALUES ARE FOR UNCOUPED BEAMS.




2 SECTION AT NEW SLAB  
SCALE: NTS

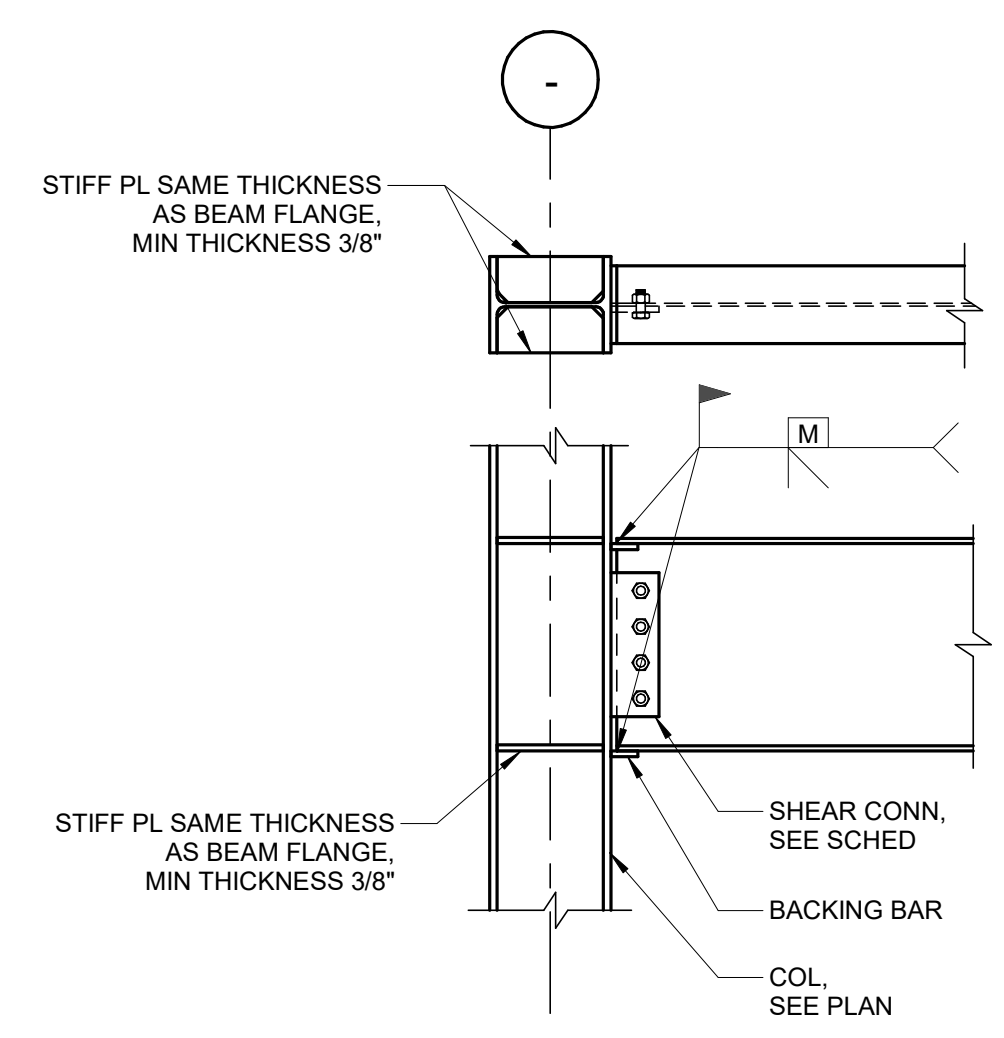

NOTE:  
MOMENT CONNECTIONS SHOWN ARE FULL PENETRATION WELDS. IF ALTERNATE MOMENT CONNECTION DETAILS ARE DESIRED THEY SHALL BE DESIGNED BY A REGISTERED PROFESSIONAL ENGINEER LICENSED IN THE STATE OF THE PROJECT AND SHALL BE SUBMITTED FOR REVIEW AS SIGNED/SEALED SHOP DRAWINGS & CALCULATIONS.


3 FIELD WELD MOMENT CONN  
SCALE: NTS

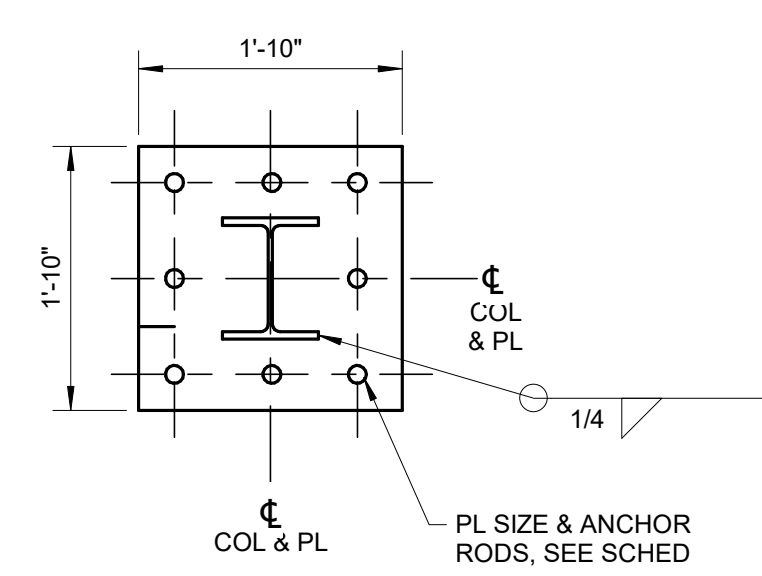


BASE PLATE SCHEDULE			
COLUMN	PLATE (L x N x B)	ANCHOR RODS	EMBED (MIN)
W10	1"x22"x22"	(8) 1"	12"

NOTE:  
ANCHOR RODS SHALL BE GRADE 36 ASTM F1554 w/ HEADED NUT & WASHER & SET w/ SET-3G BY SIMPSON.


4 NEW BASE PLATE DETAIL  
SCALE: NTS

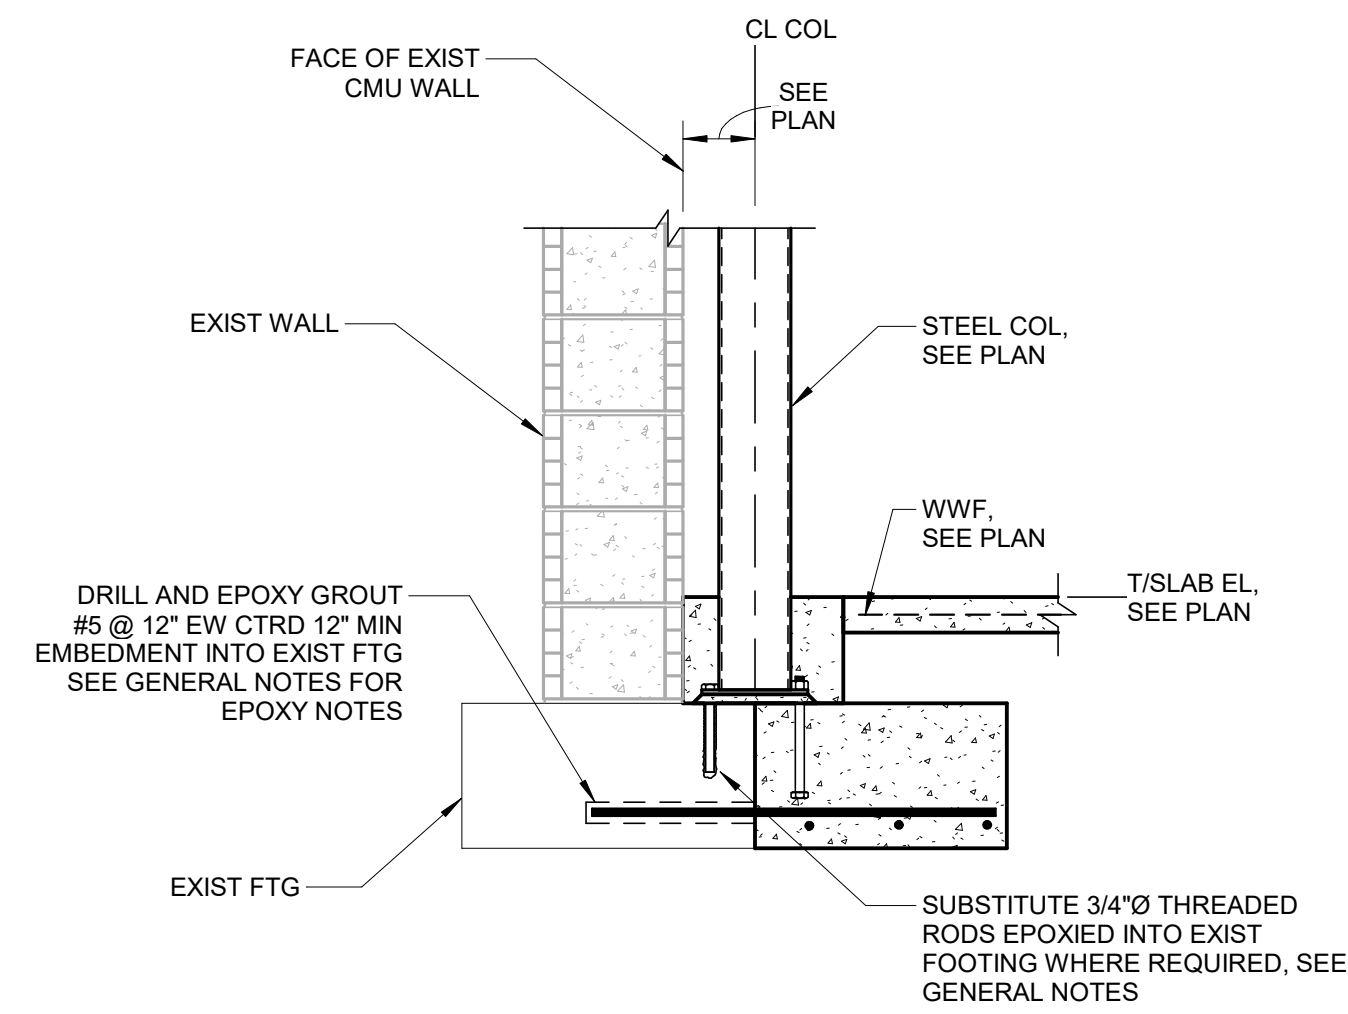


5 NEW FOOTING TO EXISTING WALL  
SCALE: NTS

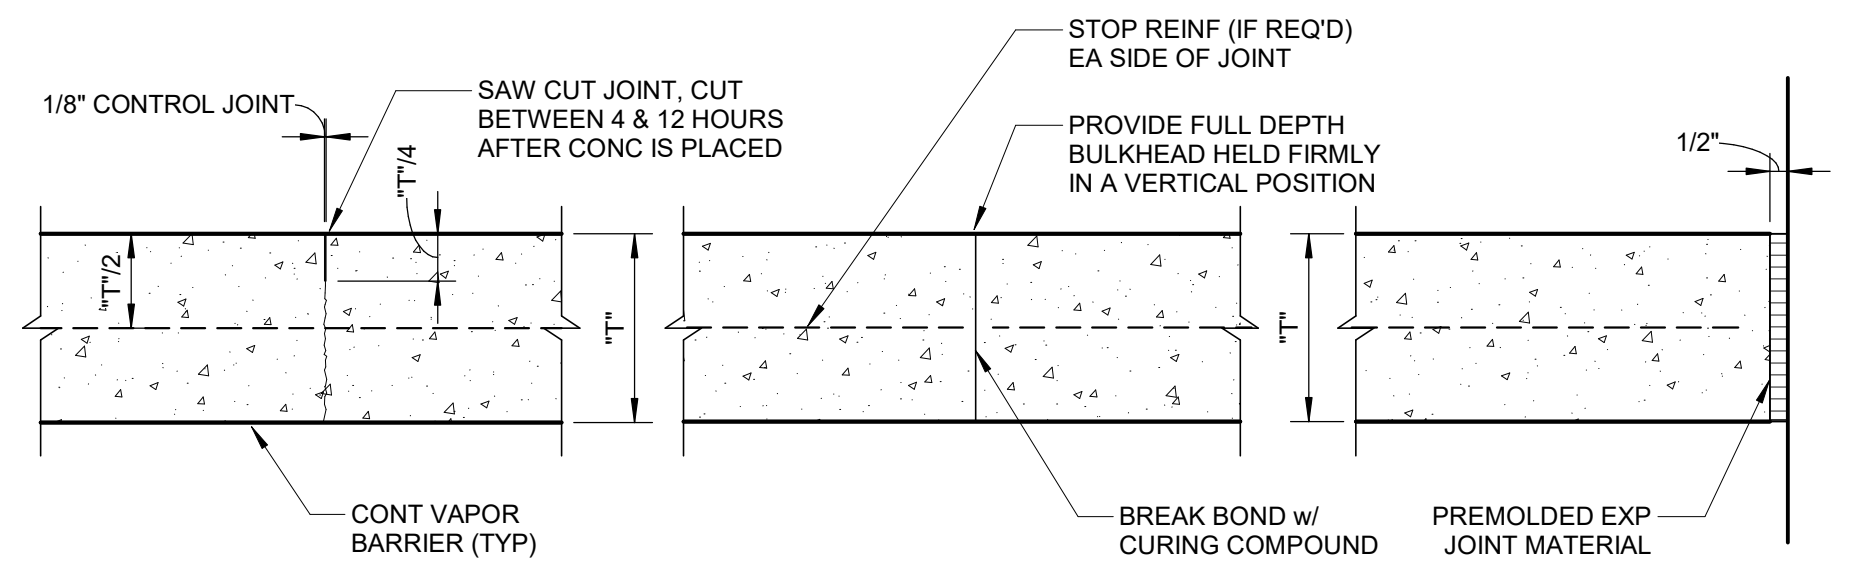

6 TYP SLAB ON GRADE JOINTS  
SCALE: NTS

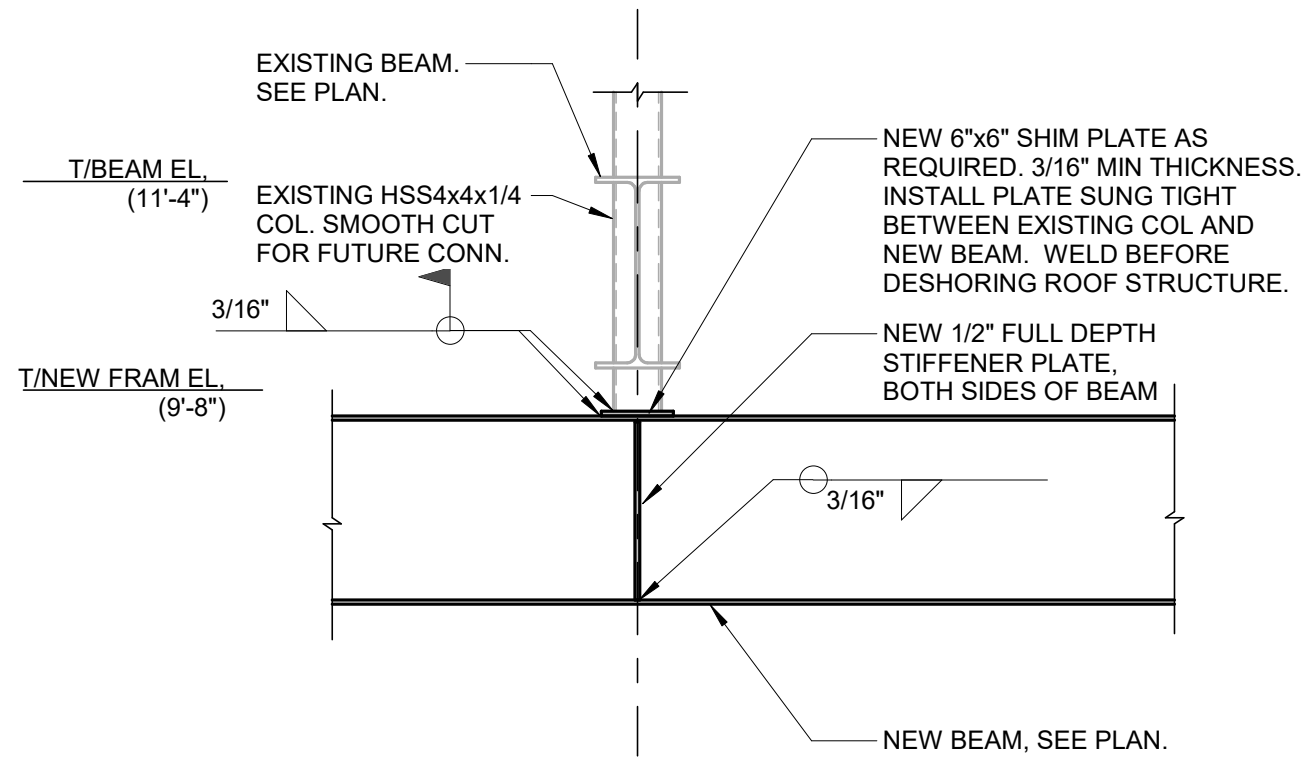

7 TRANSFER BEAM TO COL CONN  
SCALE: NTS

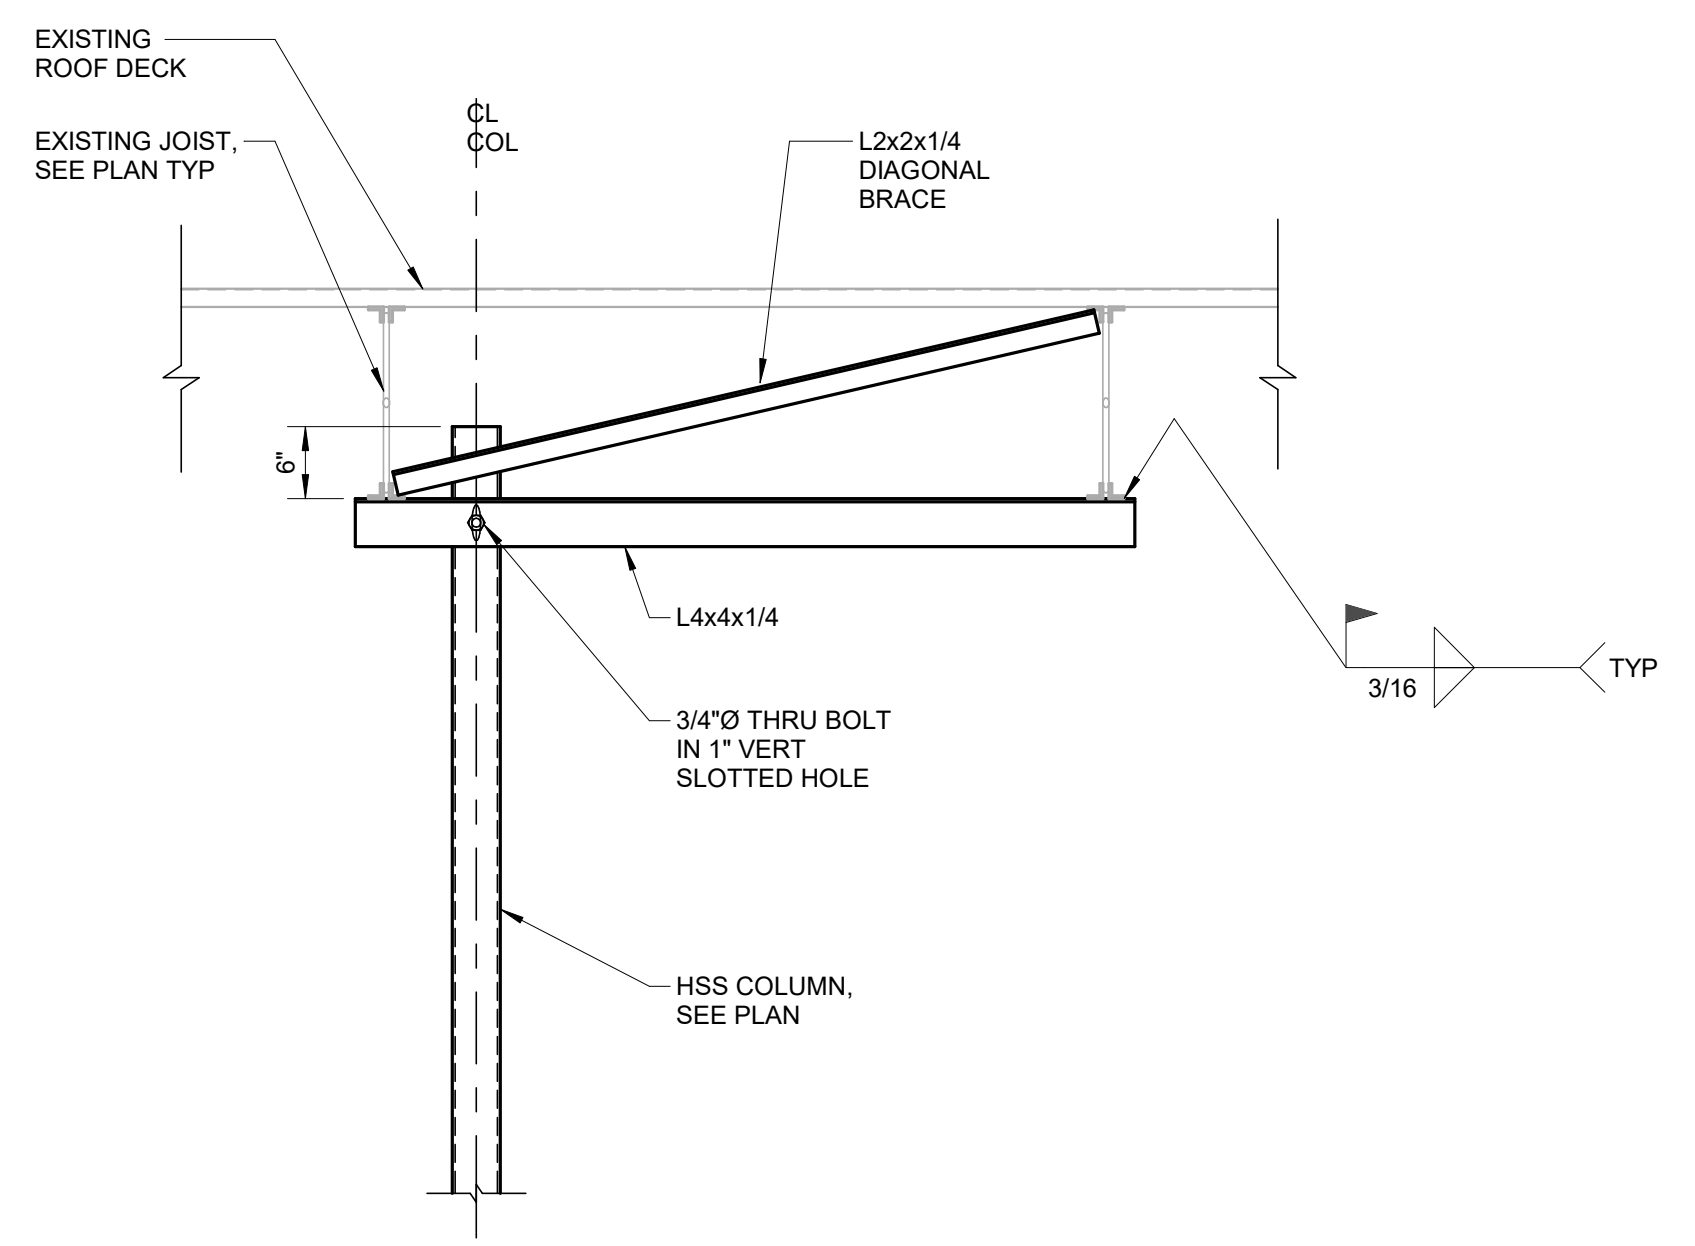

8 NEW COL BRACE  
SCALE: NTS

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Checked By AB  
Issue Date 05/23/2023  
Project No 220679

Sheet Title  
SECTIONS & DETAILS

Sheet Number  
**S3.1**



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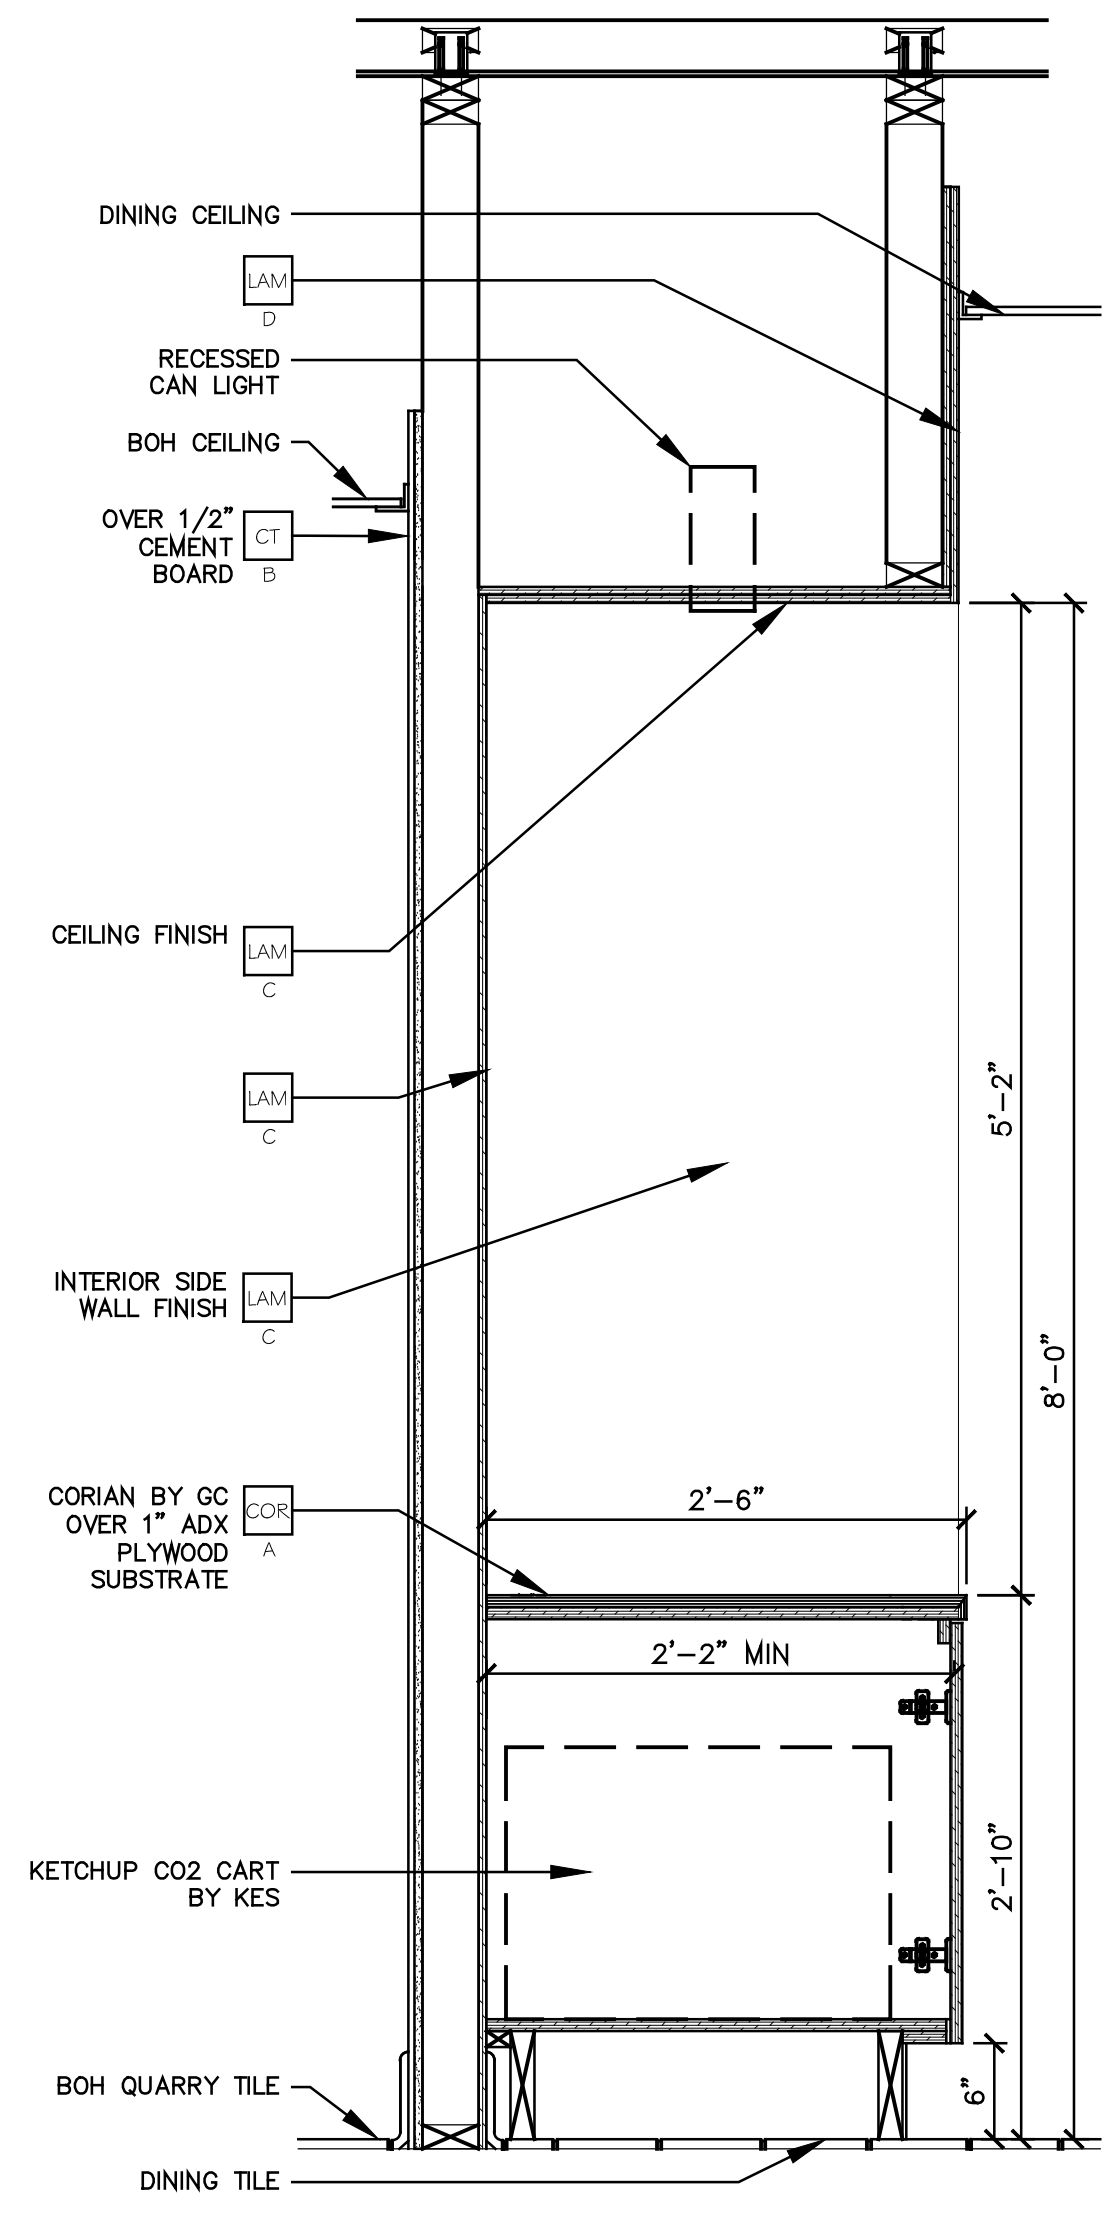
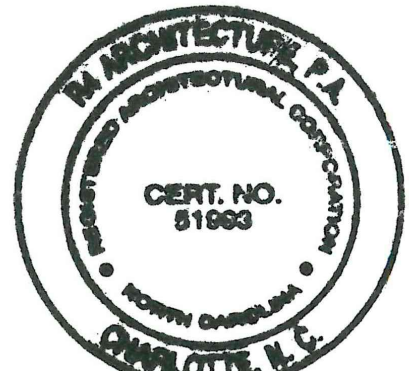















**5 SECTION DETAIL @ CABINET**  
1" = 1'-0"

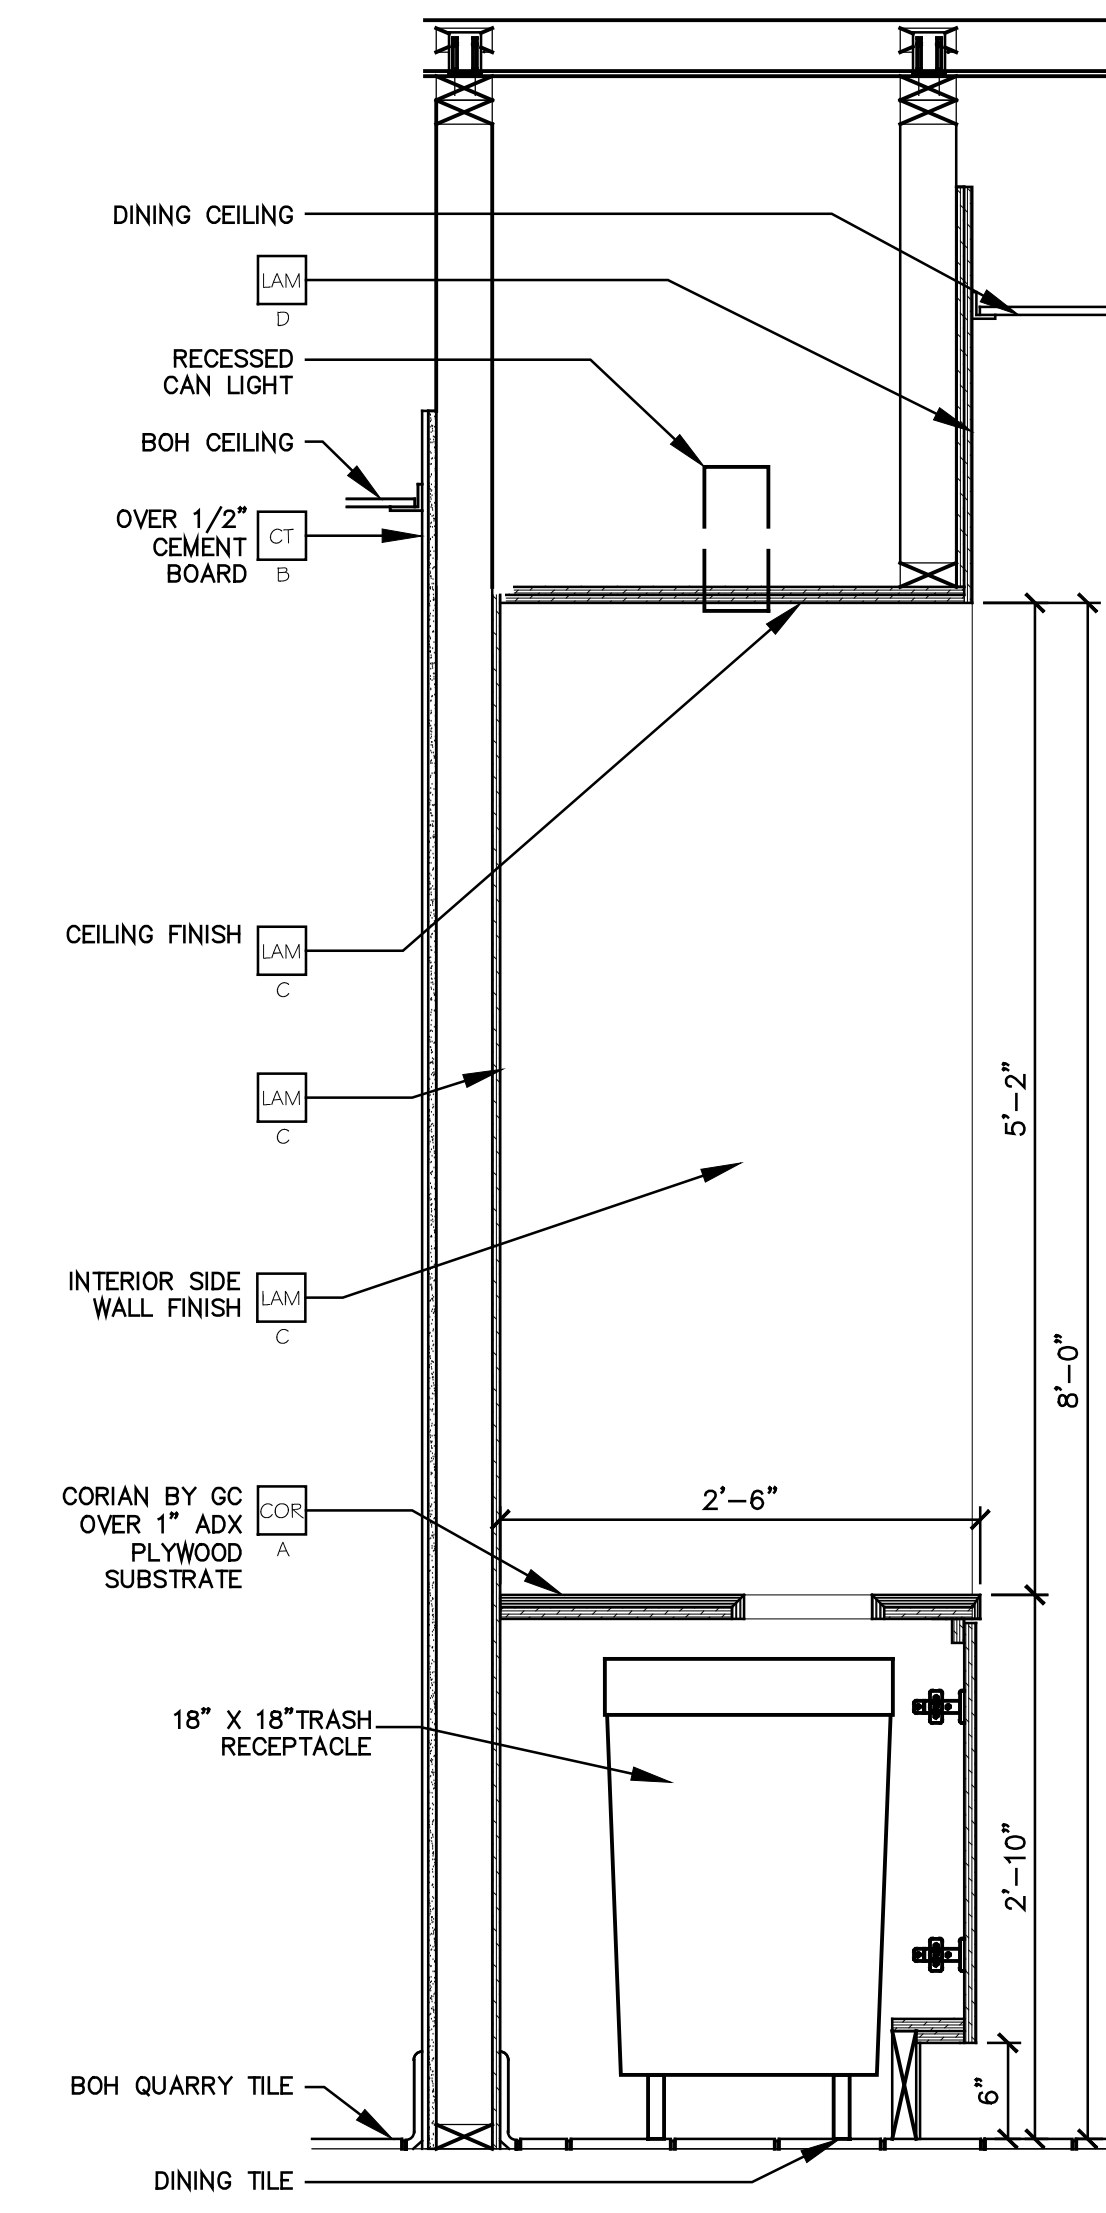


**4 SECTION DETAIL @ TRASH**  
1" = 1'-0"

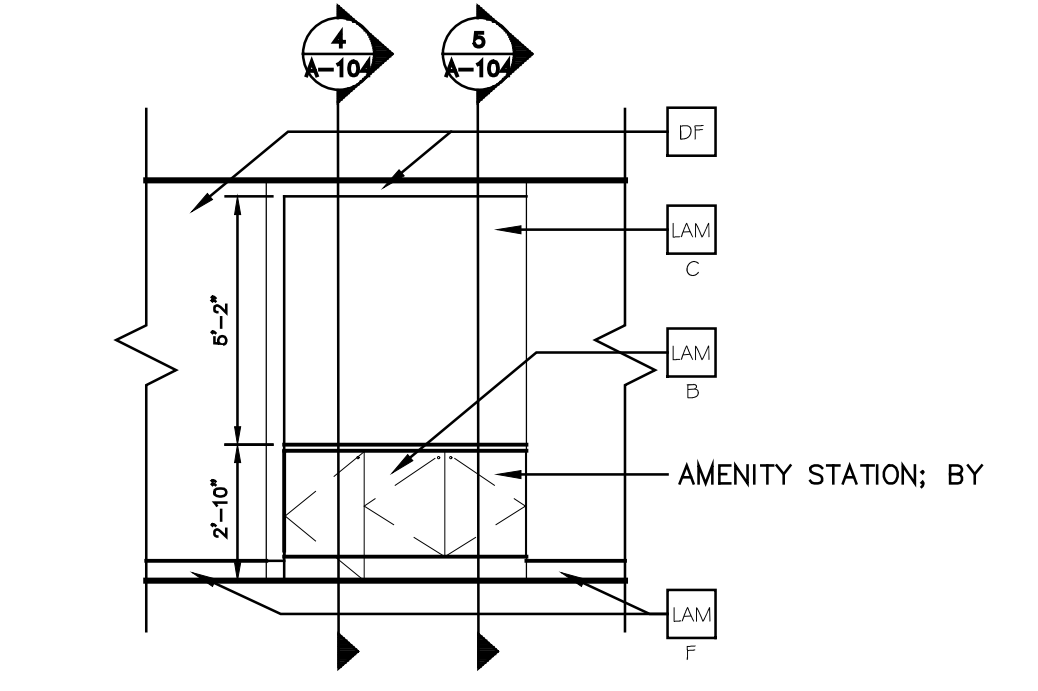

**3 AMENITY STATION ELEVATION**  
1/4" = 1'-0"

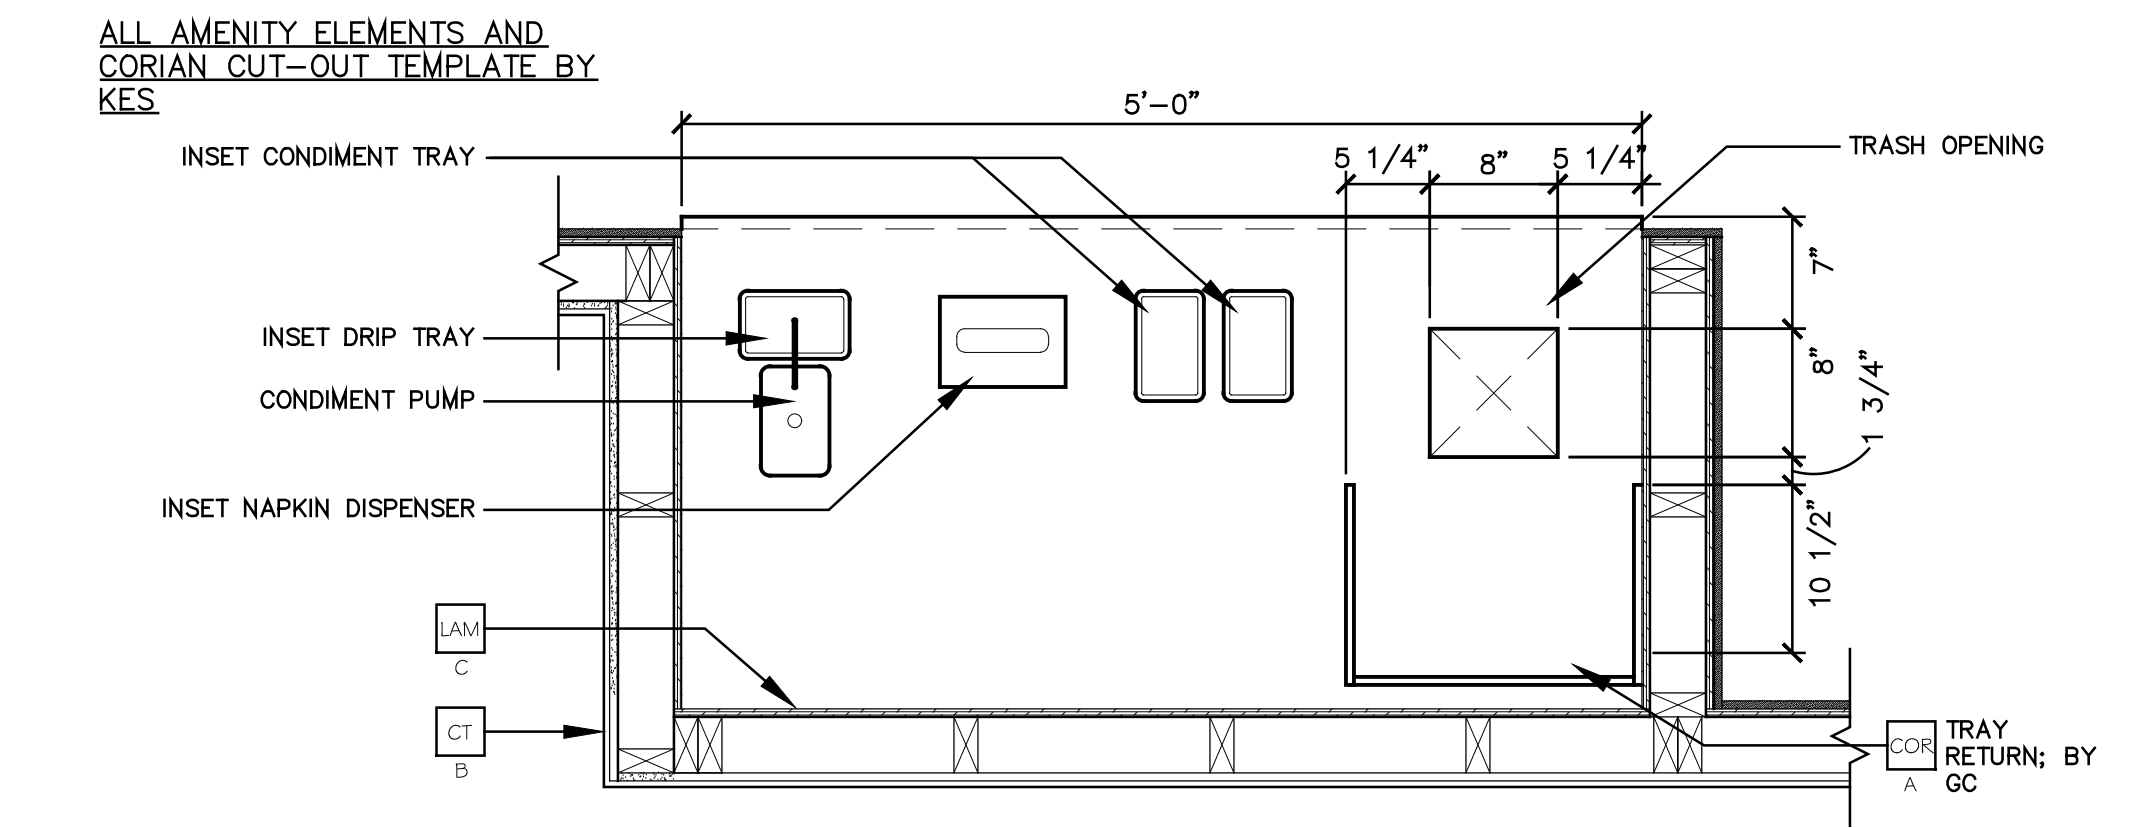

**2 AMENITY TOWER PLAN**  
1" = 1'-0"

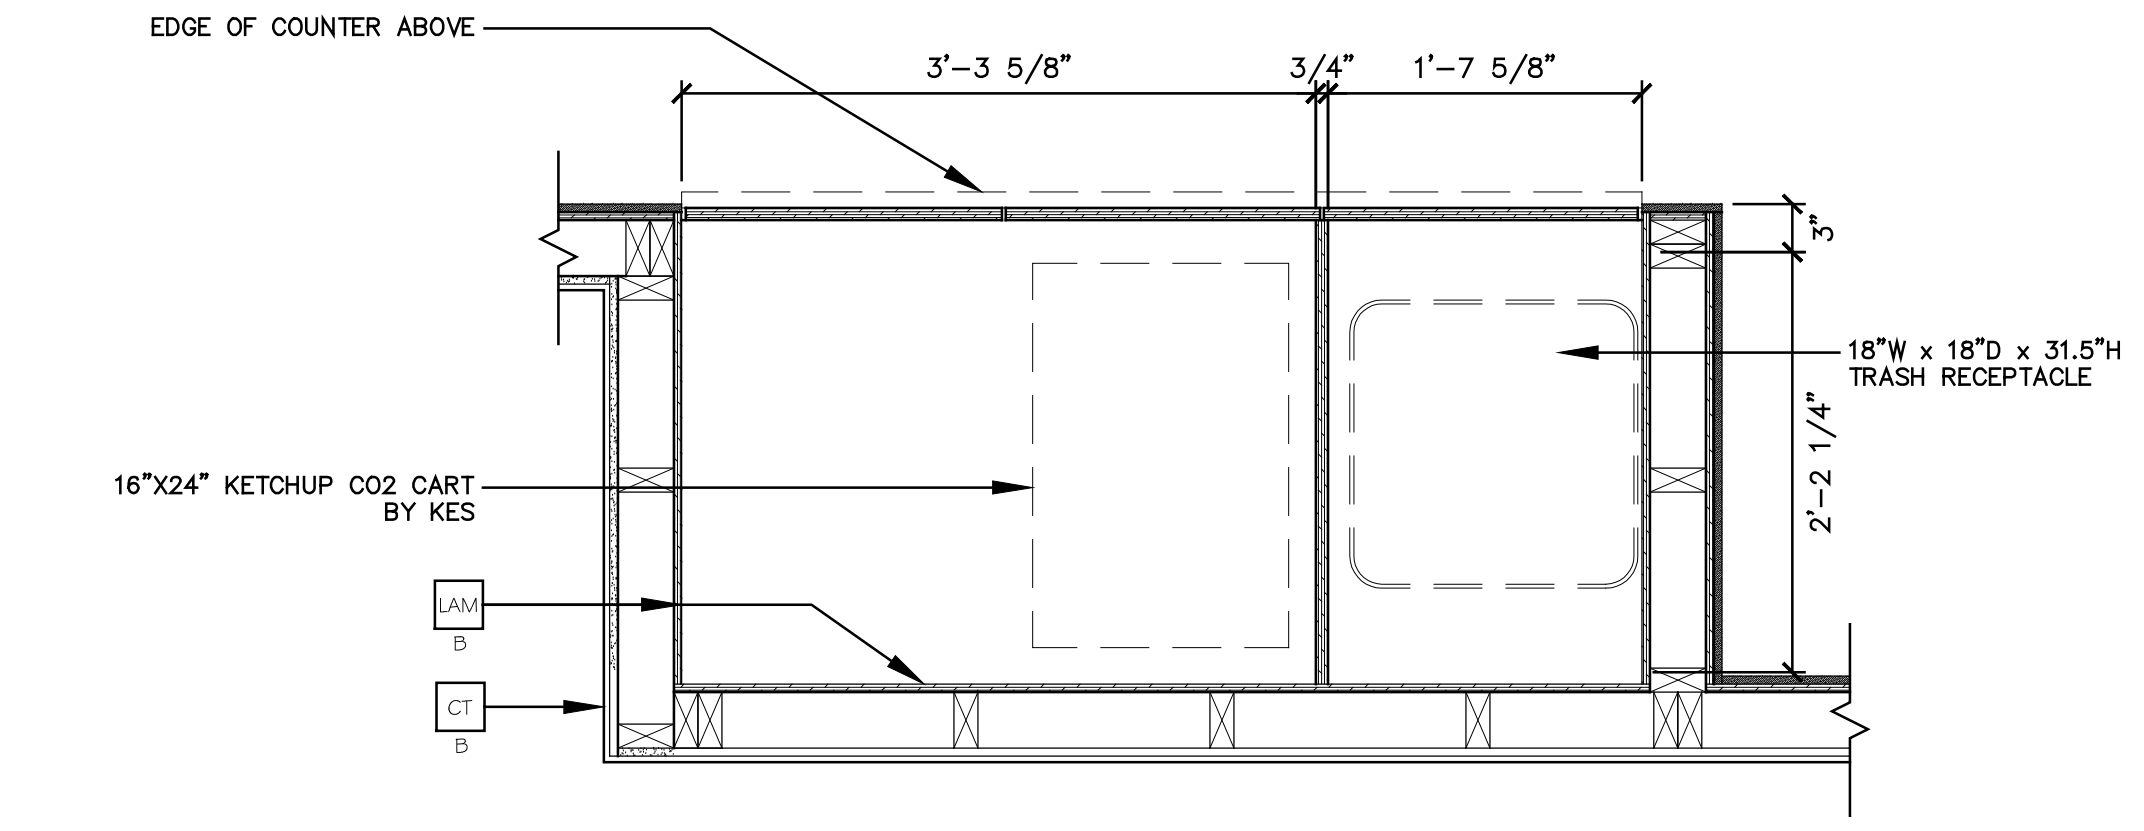

**1 AMENITY TOWER PLAN**  
1" = 1'-0"

**KEY NOTES**

- CG** CORNER GUARD: 3/4" ANGLE BY DECOR
- A** = BLACK
- COR** CORIAN:
  - X** = 1/2" CORIAN CAMEO WHITE
  - B** = 1/2" CORIAN DEEP TITANIUM

- CT** CERAMIC WALL TILE: CROSSVILLE - COLOR BY NUMBERS  
COLOR: INTUITIVE GRAY; SIZE: 4"x12", PATTERN: RUNNING BOND  
GROUT: MAPEI O2 PEWTER - JOINT TO BE 1/8" MAX.  
USE THIS TILE WHEN HIGH LRV IS REQUIRED  
COORDINATE WITH THE McDONALD'S AREA CONSTRUCTION MANAGER
- DF** DECOR FINISH TO BE ORDERED/INSTALLED BY GC AND  
MANUFACTURED BY DECOR; REFER TO PORTFOLIO.
- FRP** FIBERGLASS REINFORCED PLASTIC - PANOLAM, GRAY SMOOTH,  
CLASS C, .075. FOR ORDERING, CONTACT KIMBERLY LAWSON  
Kimberly\_Lawson@panolam.com 1-866-925-4377

- LAM** LAMINATE:  
COLOR:  
A = IDMB / DIG. MERCH., SMOOTH BLACK PLASTIC LAMINATE BY GC  
B = TRASH/ COND., WHITE PLASTIC LAMINATE BY GC  
C = TRASH/ COND., LAMITECH GRAPHITE K MATTE FINISH  
D = SEE DECOR DRAWINGS. MFR BY DECOR. PURCHASE AND INSTALL BY GC  
E = MCDelivery UNDERSCORE, LAMITECH GOLDEN  
F = BASE BOARD, FORMICA COMPACT LAMINATE MATTE BLACK BY GC

**GENERAL NOTES**

- ALL WALL LAMINATE PANELING MANUFACTURED BY DECOR PURCHASE AND INSTALL BY GC, UNO.
- ALL ELEMENTS "BY CP" TO BE ORDERED BY CENTRAL PURCHASING AND INSTALLED BY GC, UNO.
- A&E TO VERIFY LOCATION AND QUANTITY OF LIGHTS AND DIFFUSERS AFTER SERVICE AREA WALL ADDITION.

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Checked By MJR  
Issue Date 6/6/2023  
Project No 220681

Sheet Title  
S.A.O.  
DETAILS

Sheet Number  
**A-104**



**1 DOUBLE SIDED KIOSK ELEVATION**  
SCALE: NOT TO SCALE

**2 SINGLE SIDED KIOSK ELEVATION**  
SCALE: NOT TO SCALE

**3 DOUBLE SIDED PLAN VIEW**  
SCALE: NOT TO SCALE

**4 SINGLE SIDED PLAN VIEW**  
SCALE: NOT TO SCALE

**5 IT CLOSET (TYPICAL)**  
SCALE: NOT TO SCALE

**6 PARTIAL FLOOR PLAN (TYPICAL)**  
SCALE: NOT TO SCALE

**SHEET NOTES**

- TYPICAL KIOSK QUANTITY IS 2-4 FACES, FINAL QUANTITY PER RESTAURANT TO BE DETERMINED BY MCDONALDS.
- 12' CLEAR DIMENSION HIGHLY RECOMMENDED BETWEEN FRONT COUNTER AND KIOSK
- STANDARD KIOSK IS DESIGNED FOR A MAXIMUM CEILING HEIGHT OF 10'-0". IF CEILING HEIGHT EXCEEDS 10'-6" CONTACT USRD PROJECT MANAGER
- CIRCUIT NUMBERS SHOWN ARE FOR DESIGN INTENT ONLY. ACTUAL CONDITIONS WILL AFFECT CIRCUITRY.
- ALL NEW CIRCUIT BREAKERS FOR EXISTING PANELBOARDS SHALL MATCH EXISTING CIRCUIT BREAKER TYPE. AIC RATINGS OF NEW BREAKER SHALL MATCH RATING OF PANELBOARD IN WHICH INSTALLED. WHERE SERIES RATING SYSTEMS ARE USED, THE NEW BREAKER SHALL BE INSTALLED AS TO MAINTAIN THE SERIES RATING OF THE SYSTEM.

**KEYED NOTES**

- VERIFY IF OPTIONAL ELECTRONIC TABLE TRACKER SYSTEM IS TO BE USED. IF USED, PROVIDE 213.00E8 AND 213.00E9 AS INDICATED.

**PROJECT INFORMATION:**  
PROJECT: KIOSK AND TABLE LOCATOR (RADUS)  
REVISION: NEW CONSTRUCTION/MRP  
DATE ISSUED: 1/31/2017  
BY: TJD  
DOCUMENT: CONSTRUCTION DOCUMENT SLIP SHEET

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**1 KITCHEN COVER SHEET**  
N.T.S.

**2 KITCHEN EQUIPMENT LAYOUT**  
N.T.S.

**3 ELECTRICAL ROUGH-IN PLAN**  
N.T.S.

**EOTF MODULAR FRONT COUNTER SLIP-SHEET NON-FFDT WITH DELIVERY SYSTEM & FUTURE READY FOR BAKED GOODS**

**EQUIPMENT SCHEDULE**

ITEM	QTY	DESCRIPTION	MANUFACTURER	MODEL #	SL	INF	FINISHED	GENERAL REMARKS	SPECIAL REQUIREMENTS
101	1	MODULAR FRONT COUNTER 80" X 20"	USRD	MP-100					
102	1	MODULAR FRONT COUNTER 80" X 20"	USRD	MP-100					
103	1	MODULAR FRONT COUNTER 80" X 20"	USRD	MP-100					
104	1	MODULAR FRONT COUNTER 80" X 20"	USRD	MP-100					
105	1	MODULAR FRONT COUNTER 80" X 20"	USRD	MP-100					
106	1	MODULAR FRONT COUNTER 80" X 20"	USRD	MP-100					
107	1	MODULAR FRONT COUNTER 80" X 20"	USRD	MP-100					
108	1	MODULAR FRONT COUNTER 80" X 20"	USRD	MP-100					
109	1	MODULAR FRONT COUNTER 80" X 20"	USRD	MP-100					
110	1	MODULAR FRONT COUNTER 80" X 20"	USRD	MP-100					
111	1	MODULAR FRONT COUNTER 80" X 20"	USRD	MP-100					
112	1	MODULAR FRONT COUNTER 80" X 20"	USRD	MP-100					
113	1	MODULAR FRONT COUNTER 80" X 20"	USRD	MP-100					
114	1	MODULAR FRONT COUNTER 80" X 20"	USRD	MP-100					
115	1	MODULAR FRONT COUNTER 80" X 20"	USRD	MP-100					
116	1	MODULAR FRONT COUNTER 80" X 20"	USRD	MP-100					
117	1	MODULAR FRONT COUNTER 80" X 20"	USRD	MP-100					
118	1	MODULAR FRONT COUNTER 80" X 20"	USRD	MP-100					
119	1	MODULAR FRONT COUNTER 80" X 20"	USRD	MP-100					
120	1	MODULAR FRONT COUNTER 80" X 20"	USRD	MP-100					

**PROJECT INFORMATION:**  
PROJECT: MODULAR FRONT COUNTER - NON FFD  
REVISION: NEW CONSTRUCTION/MRP  
DATE ISSUED: 5/10/2017  
BY: USRD  
DOCUMENT: CONSTRUCTION DOCUMENT SLIP SHEET

**ELECTRICAL RACEWAY NOTES:**

- RACEWAY AND RECEPTABLES TO BE PROVIDED WITH MODULAR FRONT COUNTER, INSTALLED BY CONTRACTOR. DETAIL SHOWN IS A TYPICAL CONFIGURATION ONLY. SITE SPECIFICS MIGHT CAUSE DEVIATIONS.

Modular Front Counter 1.5 Specifications

Preferred Double Pod, Secondary Double Pod, Tertiary Double Pod

**7-0-3 (9'-10")**  
3'-0" x 9'-10" (ORDER AREA)  
3'-0" OPENING REQUIRED  
14" BAKED GOODS CASE  
NO CENTER CUT  
NO SIDE EGRESS REQUIRED

**8-0-3 (10'-10")**  
3'-0" x 10'-10" (ORDER AREA)  
3'-0" OPENING REQUIRED  
NO CENTER CUT  
NO SIDE EGRESS REQUIRED

**5.6-2.3-3 (11'-1")**  
3'-0" x 11'-1" (ORDER AREA)  
3'-0" OPENING REQUIRED  
NO CENTER CUT  
NO SIDE EGRESS REQUIRED

**7-2.2-3 (12'-2")**  
3'-0" x 12'-2" (ORDER AREA)  
3'-0" OPENING REQUIRED  
14" BAKED GOODS CASE  
NO CENTER CUT  
NO SIDE EGRESS REQUIRED

**7-3-3 (13'-0")**  
3'-0" x 13'-0" (ORDER AREA)  
3'-0" OPENING REQUIRED  
14" BAKED GOODS CASE  
NO CENTER CUT  
NO SIDE EGRESS REQUIRED

**7-3-4 (14'-0")**  
3'-0" x 14'-0" (ORDER AREA)  
3'-0" OPENING REQUIRED  
14" BAKED GOODS CASE  
NO CENTER CUT  
NO SIDE EGRESS REQUIRED

**8-2.3-4 (14'-3")**  
3'-0" x 14'-3" (ORDER AREA)  
3'-0" OPENING REQUIRED  
NO CENTER CUT  
NO SIDE EGRESS REQUIRED

**8-3-4 (15'-0")**  
3'-0" x 15'-0" (ORDER AREA)  
3'-0" OPENING REQUIRED  
NO CENTER CUT  
NO SIDE EGRESS REQUIRED

**9-3-3.5 (15'-6")**  
3'-0" x 15'-6" (ORDER AREA)  
3'-0" OPENING REQUIRED  
NO CENTER CUT  
NO SIDE EGRESS REQUIRED

**9-3-4 (16'-0")**  
3'-0" x 16'-0" (ORDER AREA)  
3'-0" OPENING REQUIRED  
NO CENTER CUT  
NO SIDE EGRESS REQUIRED

**9-3-4.5 (16'-6")**  
3'-0" x 16'-6" (ORDER AREA)  
3'-0" OPENING REQUIRED  
NO CENTER CUT  
NO SIDE EGRESS REQUIRED

**9-3-5 (17'-0")**  
3'-0" x 17'-0" (ORDER AREA)  
3'-0" OPENING REQUIRED  
NO CENTER CUT  
NO SIDE EGRESS REQUIRED

**9-3-6 (18'-0")**  
3'-0" x 18'-0" (ORDER AREA)  
3'-0" OPENING REQUIRED  
NO CENTER CUT  
NO SIDE EGRESS REQUIRED

**9-3-7 (19'-0")**  
3'-0" x 19'-0" (ORDER AREA)  
3'-0" OPENING REQUIRED  
NO CENTER CUT  
NO SIDE EGRESS REQUIRED

**9-3-8 (20'-0")**  
3'-0" x 20'-0" (ORDER AREA)  
3'-0" OPENING REQUIRED  
NO CENTER CUT  
NO SIDE EGRESS REQUIRED

NOTES:  
Only use single pod with 3 P.O.S.  
Any even number of P.O.S. should use preferred double pods  
Secondary double pods can only be used on counter less than 8' width

Last Updated: 09/30/19

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Checked By: MJR  
Issue Date: 6/6/2023  
Project No: 220681

Sheet Title  
Front Counter & Kiosk Details

Sheet Number  
**A-401**










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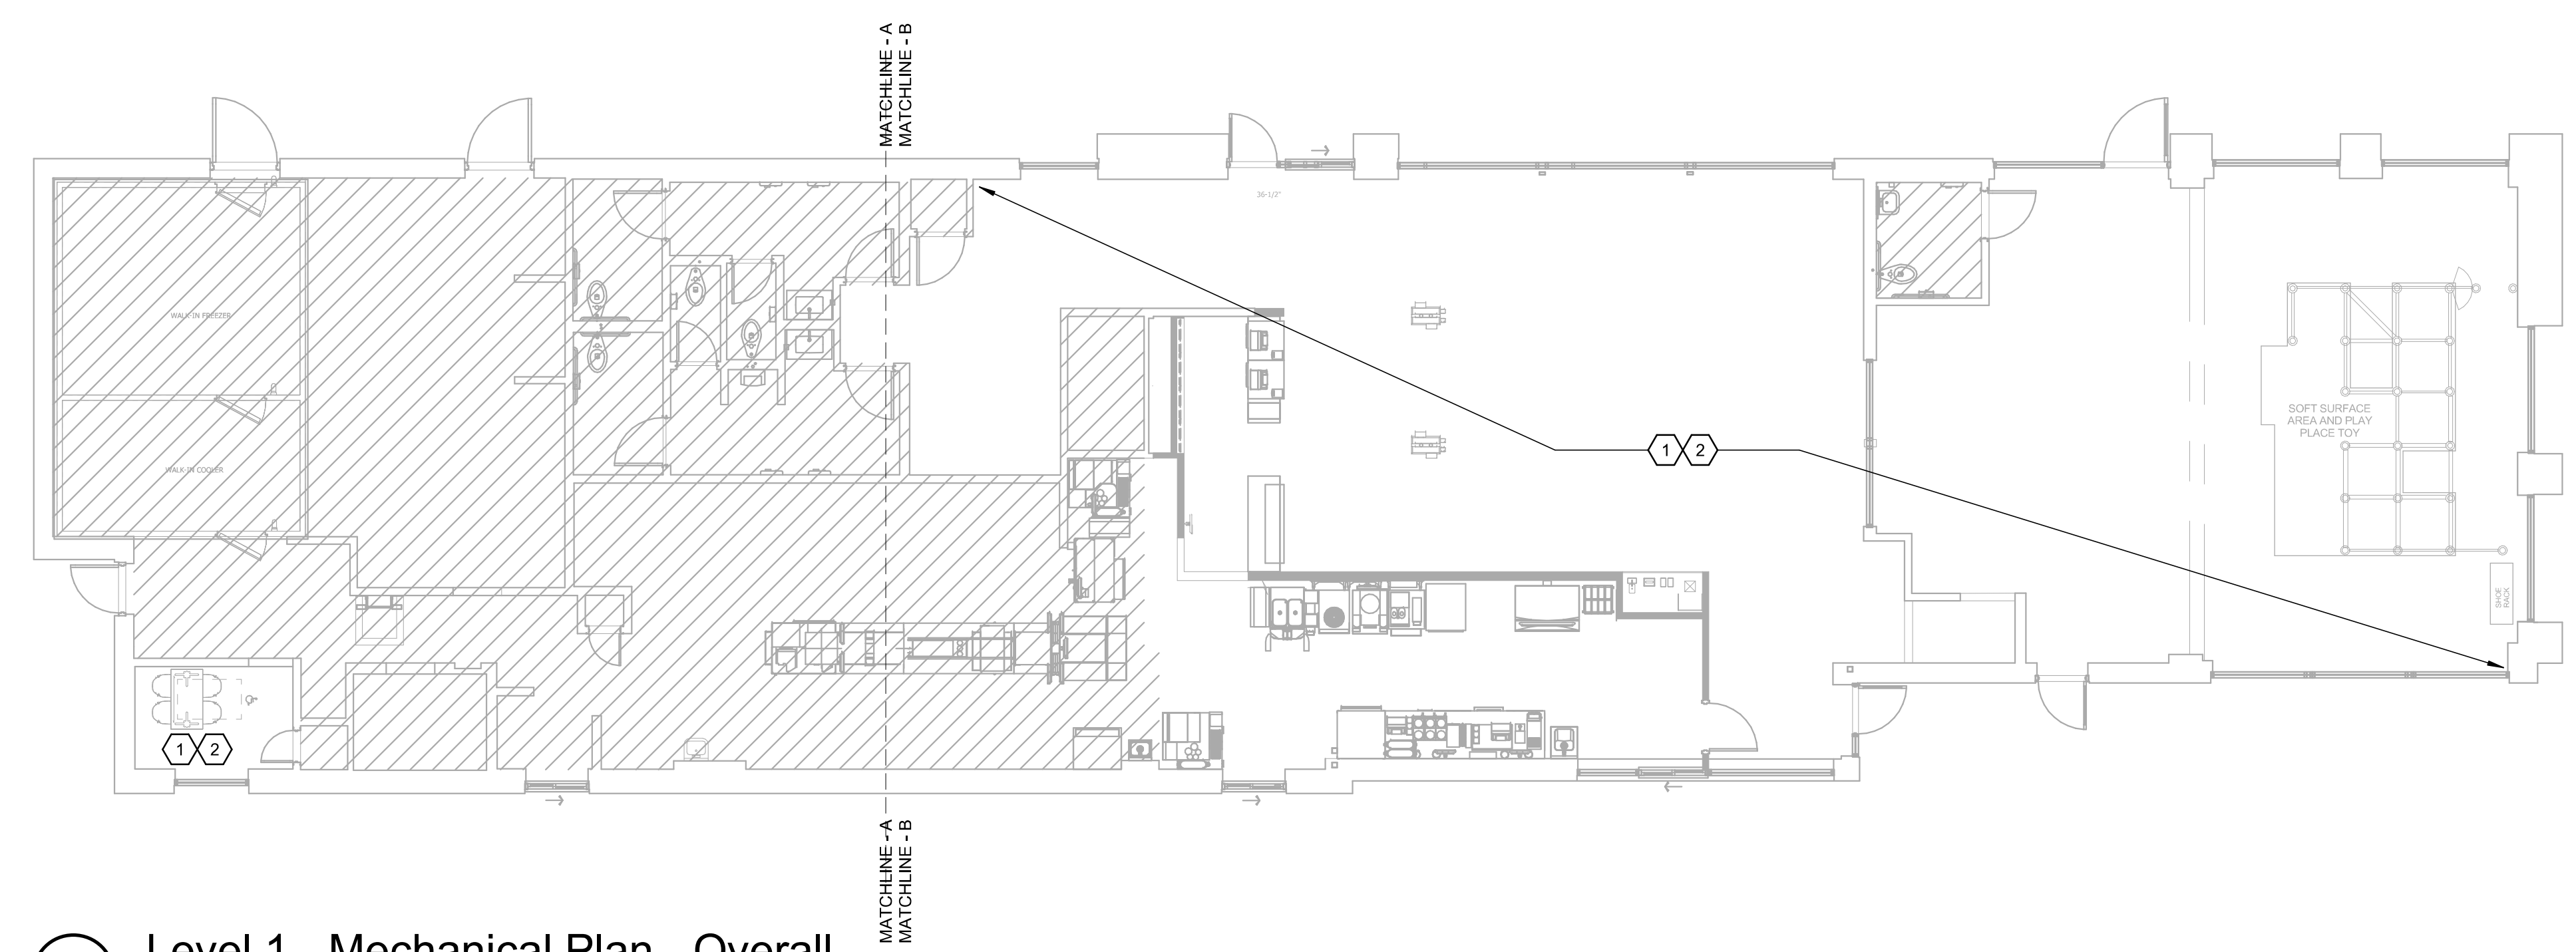
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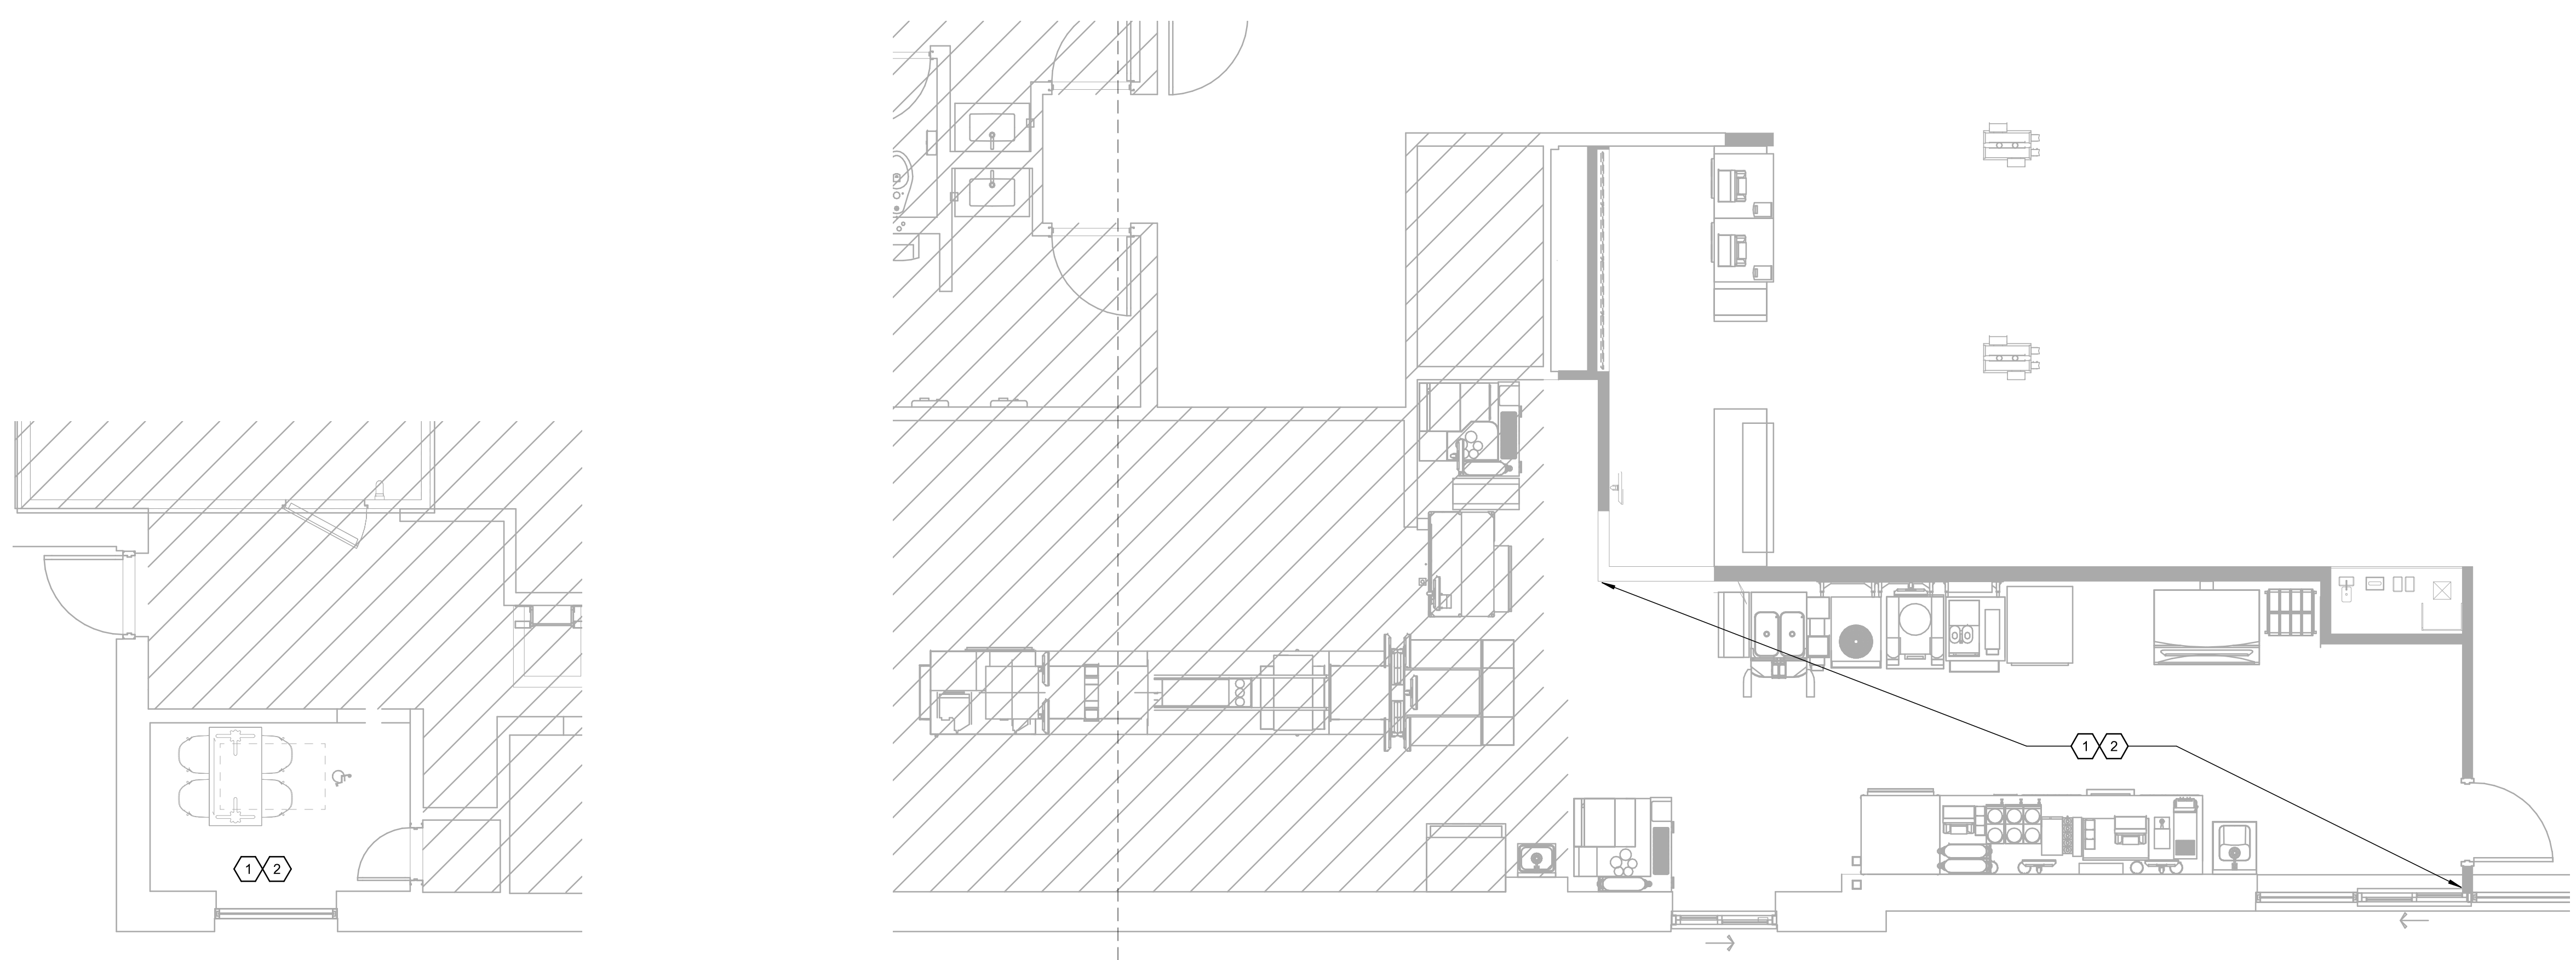
- # KEYED NOTES:**
- ALL EXISTING DIFFUSERS, ETC. TO BE CLEANED TO LIKE NEW CONDITION AND REUSED. REPAIR/REPLACE AS NEEDED. IF EXISTING LOCATION IS IN CONFLICT WITH NEW LIGHTING LAYOUT GC SHALL ADJUST SLIGHTLY AS REQ. FOR NEW LIGHTING LAYOUT-TYP.
  - CONTRACTOR TO FIELD VERIFY EXISTING CONDITIONS PRIOR TO BEGINNING CONSTRUCTION.

- DEMOLITION NOTES**
- IT IS THE CONTRACTOR'S RESPONSIBILITY TO REPLACE ANY ITEM OR EQUIPMENT DAMAGED DURING DEMOLITION. ANY ITEM OR EQUIPMENT THAT IS REMOVED TO FACILITATE THE DEMOLITION SHALL BE REINSTALLED BACK TO ITS ORIGINAL CONDITION. PATCH ALL OPENINGS IN FLOOR, CEILINGS, AND WALLS MADE IN ADJACENT AREAS THAT ARE NOT BEING DEMOLISHED.
  - REMOVE ALL HANGERS, SUPPORTS, AND ACCESSORIES ASSOCIATED WITH ITEMS OR EQUIPMENT BEING DEMOLISHED.
  - EXISTING SERVICES ARE BASED ON ORIGINAL DRAWINGS AND LIMITED FIELD WORK. CONTRACTOR SHALL VERIFY EXISTING SERVICES PRIOR TO TIE-IN.
  - RETURN AND EXHAUST GRILLES IN AREAS OF WORK SHALL BE COVERED WITH FILTER MEDIA DURING DEMOLITION.
  - CONTRACTOR SHALL CONDUCT PRE AIR BALANCES ON EXISTING SYSTEMS BEING REUSED. NOTIFY ENGINEER OF ANY DISCREPANCIES. IF BALANCING DEVICES ARE NOT PRESENT IN EXISTING CONDITIONS CONTRACTOR SHALL PROVIDE AS REQUIRED.
  - ROOMS IN THE CONSTRUCTION ZONE SHALL BE UNDER NEGATIVE PRESSURE IN RELATION TO OCCUPIED AREAS ADJOINING AREAS DURING OCCUPIED HOURS.
  - CONTRACTOR SHALL COORDINATE WITH OWNER TO SCHEDULE ANY UTILITY SHUTDOWNS. PROVIDE TEMPORARY CONNECTIONS AS REQUIRED TO MAINTAIN ALL NECESSARY SERVICES.
  - IF REQUIRED, CONTRACTOR SHALL COORDINATE WITH OWNER TO DETERMINE THE SALVAGE VALUE OF DEMOLISHED ITEMS. RECYCLABLE ITEMS WITHOUT SALVAGE VALUE SHALL BE PRESENTED TO RECYCLING FACILITY.

NOTE: THESE DRAWINGS AND THE PROJECT MANUAL FOR MCDONALD'S STANDARD BUILDING PROGRAM COPYRIGHT 2013 ARE INTENDED TO DESCRIBE AND PROVIDE FOR A FINISHED PIECE OF WORK. THEY ARE INTENDED TO BE COOPERATIVE, AND WHAT IS CALLED FOR BY EITHER WILL BE AS BINDING AS IF CALLED FOR BY BOTH. THE PROJECT MANUAL FOR MCDONALD'S STANDARD BUILDING PROGRAM COPYRIGHT 2013 IS AVAILABLE THROUGH THE MCDONALD'S ACM OR ECM.

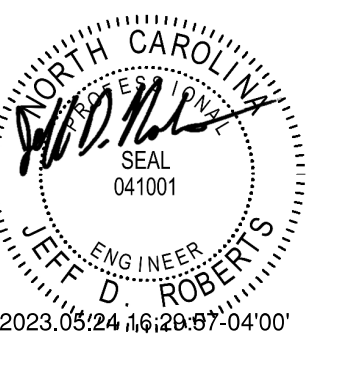

**1 Level 1 - Mechanical Plan - Overall**  
M-101 SCALE: 1/8" = 1'-0"



**2 Level 1 - Mechanical Plan - Employee Area**  
M-101 SCALE: 1/4" = 1'-0"

**3 Level 1 - Mechanical Plan - Customer Area**  
M-101 SCALE: 1/4" = 1'-0"

Rev	Date	Description

**McDonald's**  
McDonald's Store - Site ID# 32-0051  
NSN# 2550  
1726 West Cumberland Street  
Dunn, NC 28334  
Bethesda Region  
4601 Six Forks Road - Suite 200 - Raleigh, N.C. 27609

Drawn By IMEG  
Checked By IMEG  
Issue Date 05/23/2023  
Project No 220679

Sheet Title  
NEW MECHANICAL PLAN

Sheet Number  
**M-101**












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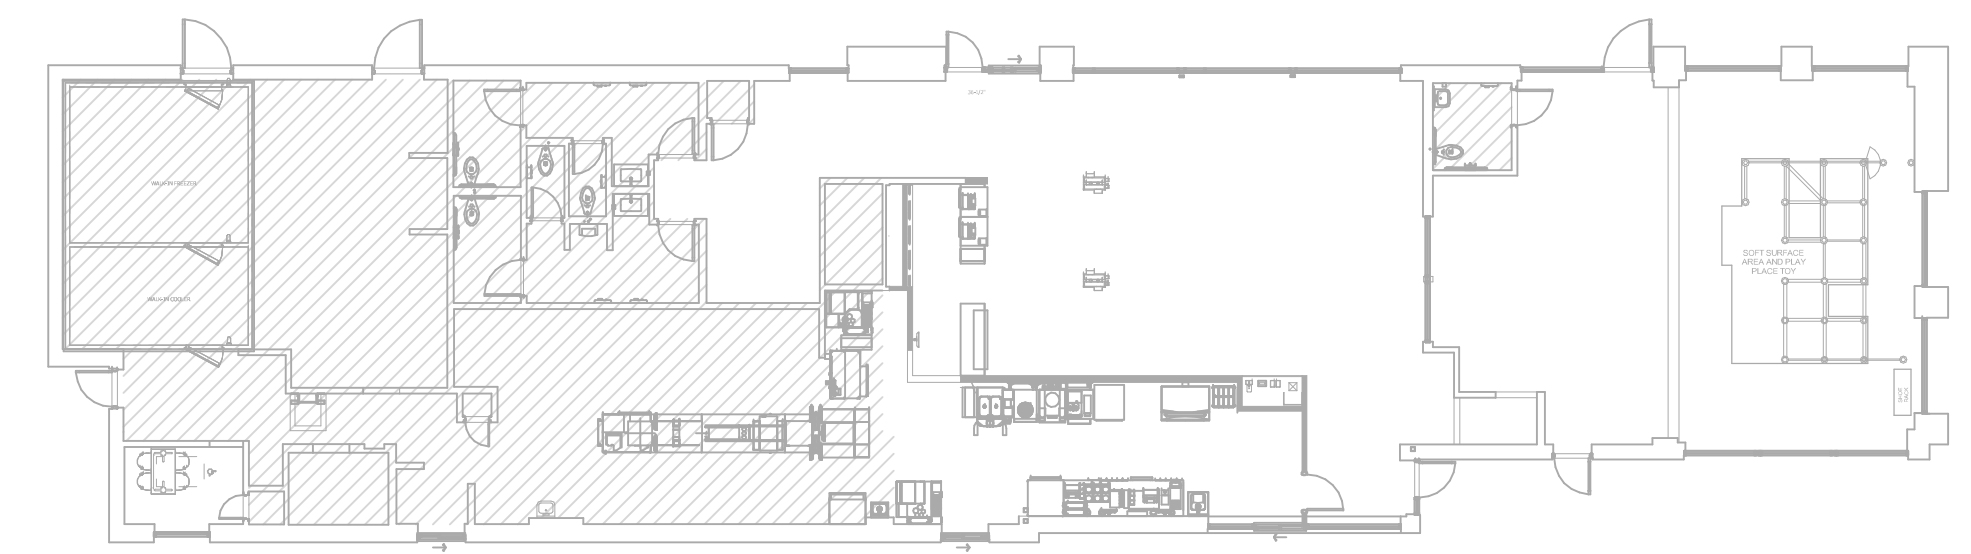
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Charleston, SC 29407  
Tel - 843 - 531-6848  
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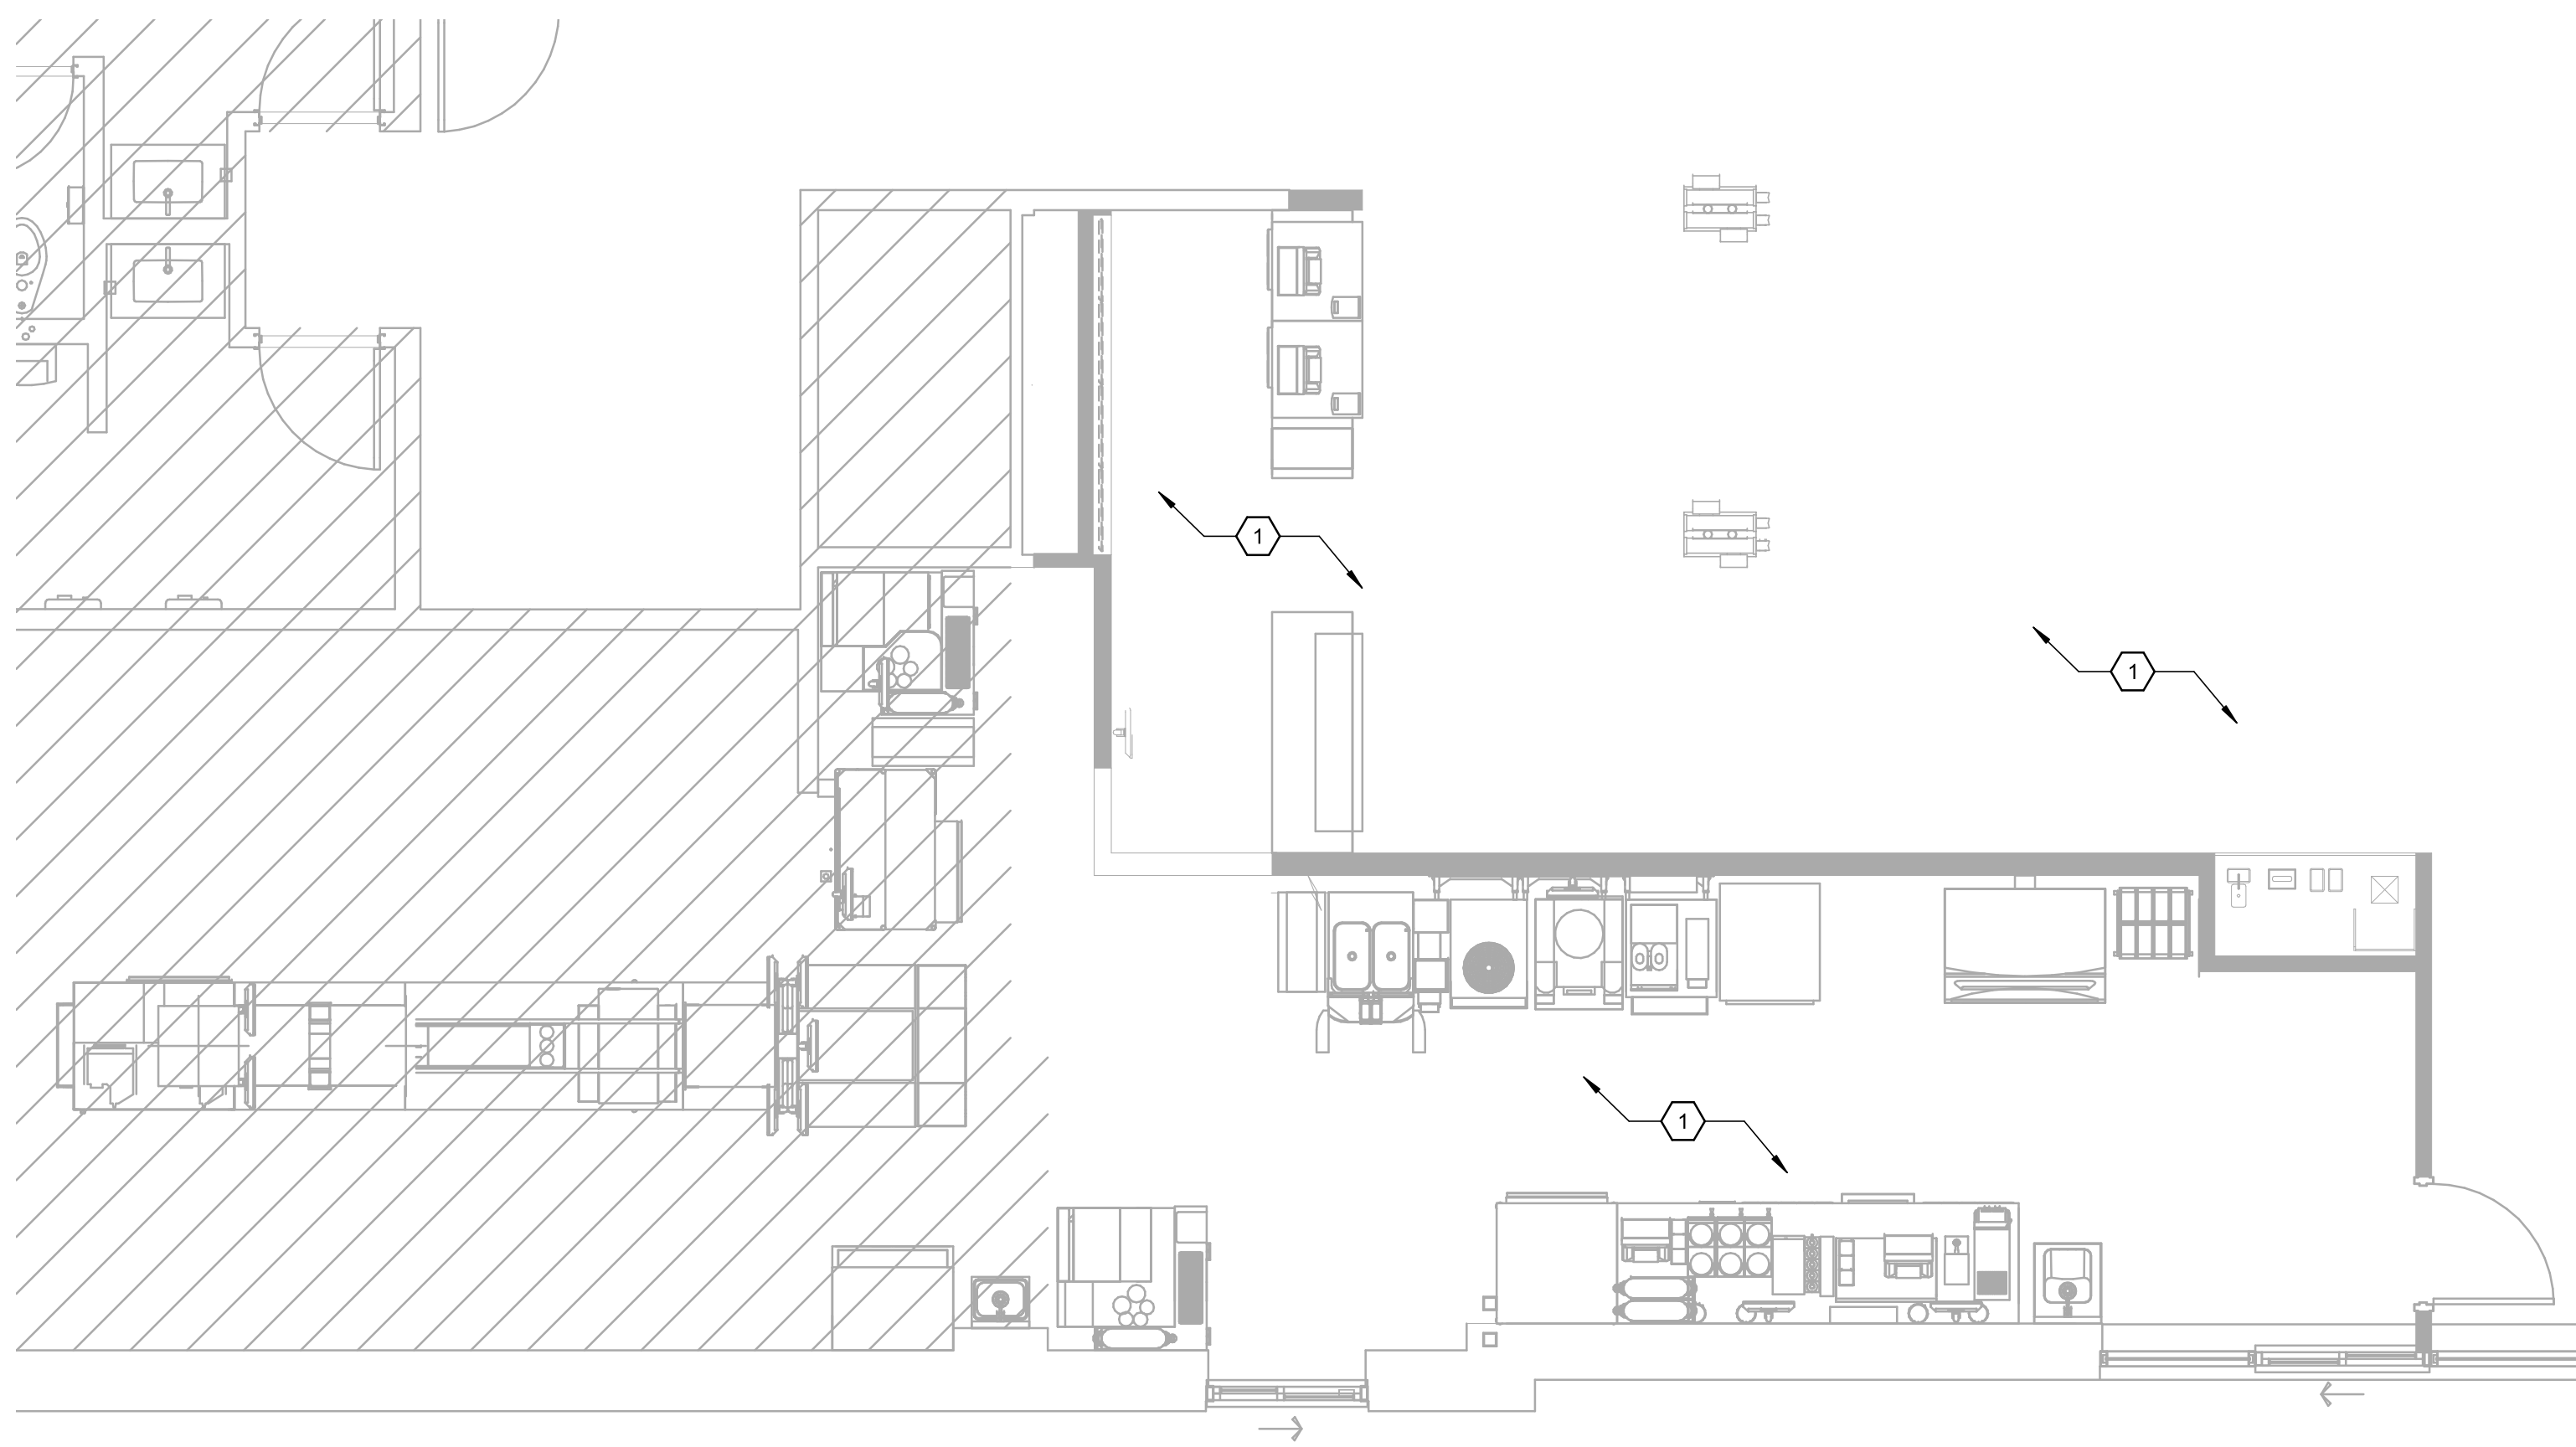
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2 Level 1-Lighting Plan - Employee Area  
E-101 SCALE: 1/4" = 1'-0"



1 Level 1- Lighting Plan Overall  
E-101 SCALE: 1/16" = 1'-0"

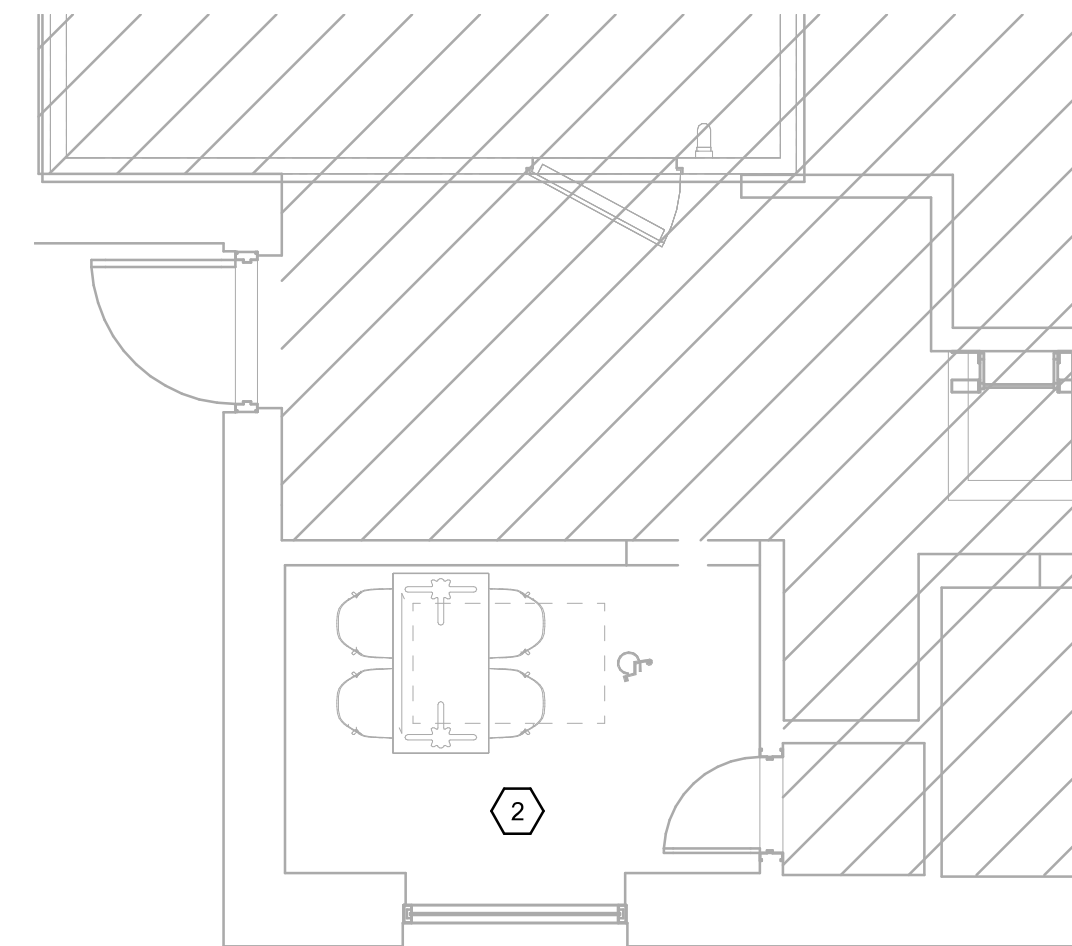

3 Level 1-Lighting Plan - Customer Area  
E-101 SCALE: 1/4" = 1'-0"

**NOTE:**  
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**GENERAL NOTES:**  
1. HATCHED AREA'S NOT INCLUDED IN SCOPE.

**KEYED NOTES:**  
# 1. EXTEND EXISTING LIGHTING CIRCUITS TO NEW FIXTURES. FIXTURE TYPE AND LAYOUT ACCORDING TO MCDONALD'S BUILDING STANDARDS AND LAHJ LIGHT LEVEL REQUIREMENTS. VERIFY CIRCUIT CAPACITY PRIOR.  
2. NO ELECTRICAL WORK IN THIS AREA

Rev	Date	Description

**McDonald's**  
**McDonald's Store - Site ID # 32-0051**  
 NSN # 2550  
 1726 West Cumberland Street  
 Dunn, NC 28334  
 Office Address  
 Bethesda Region  
 4601 Six Forks Road - Suite 200 - Raleigh, N.C. 27609

Drawn By IMEG  
 Checked By IMEG  
 Issue Date 05/23/2023  
 Project No 220679

Sheet Title  
 LIGHTING PLAN

Sheet Number  
**E-101**

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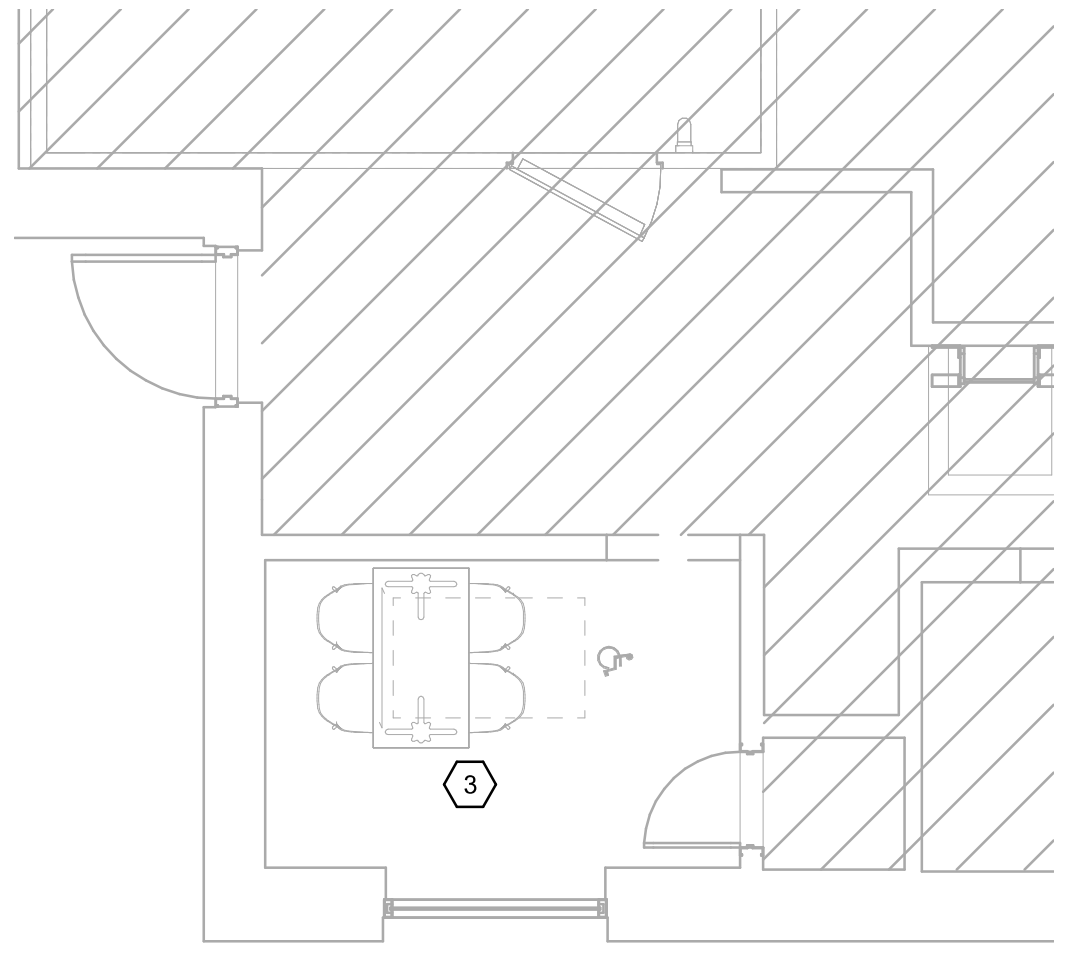
7752 Gateway Lane Suite 204 Concord, NC 28027 Tel - 704 - 688-7500

513A Savannah Hwy Charleston, SC 29407 Tel - 843 - 531-6848


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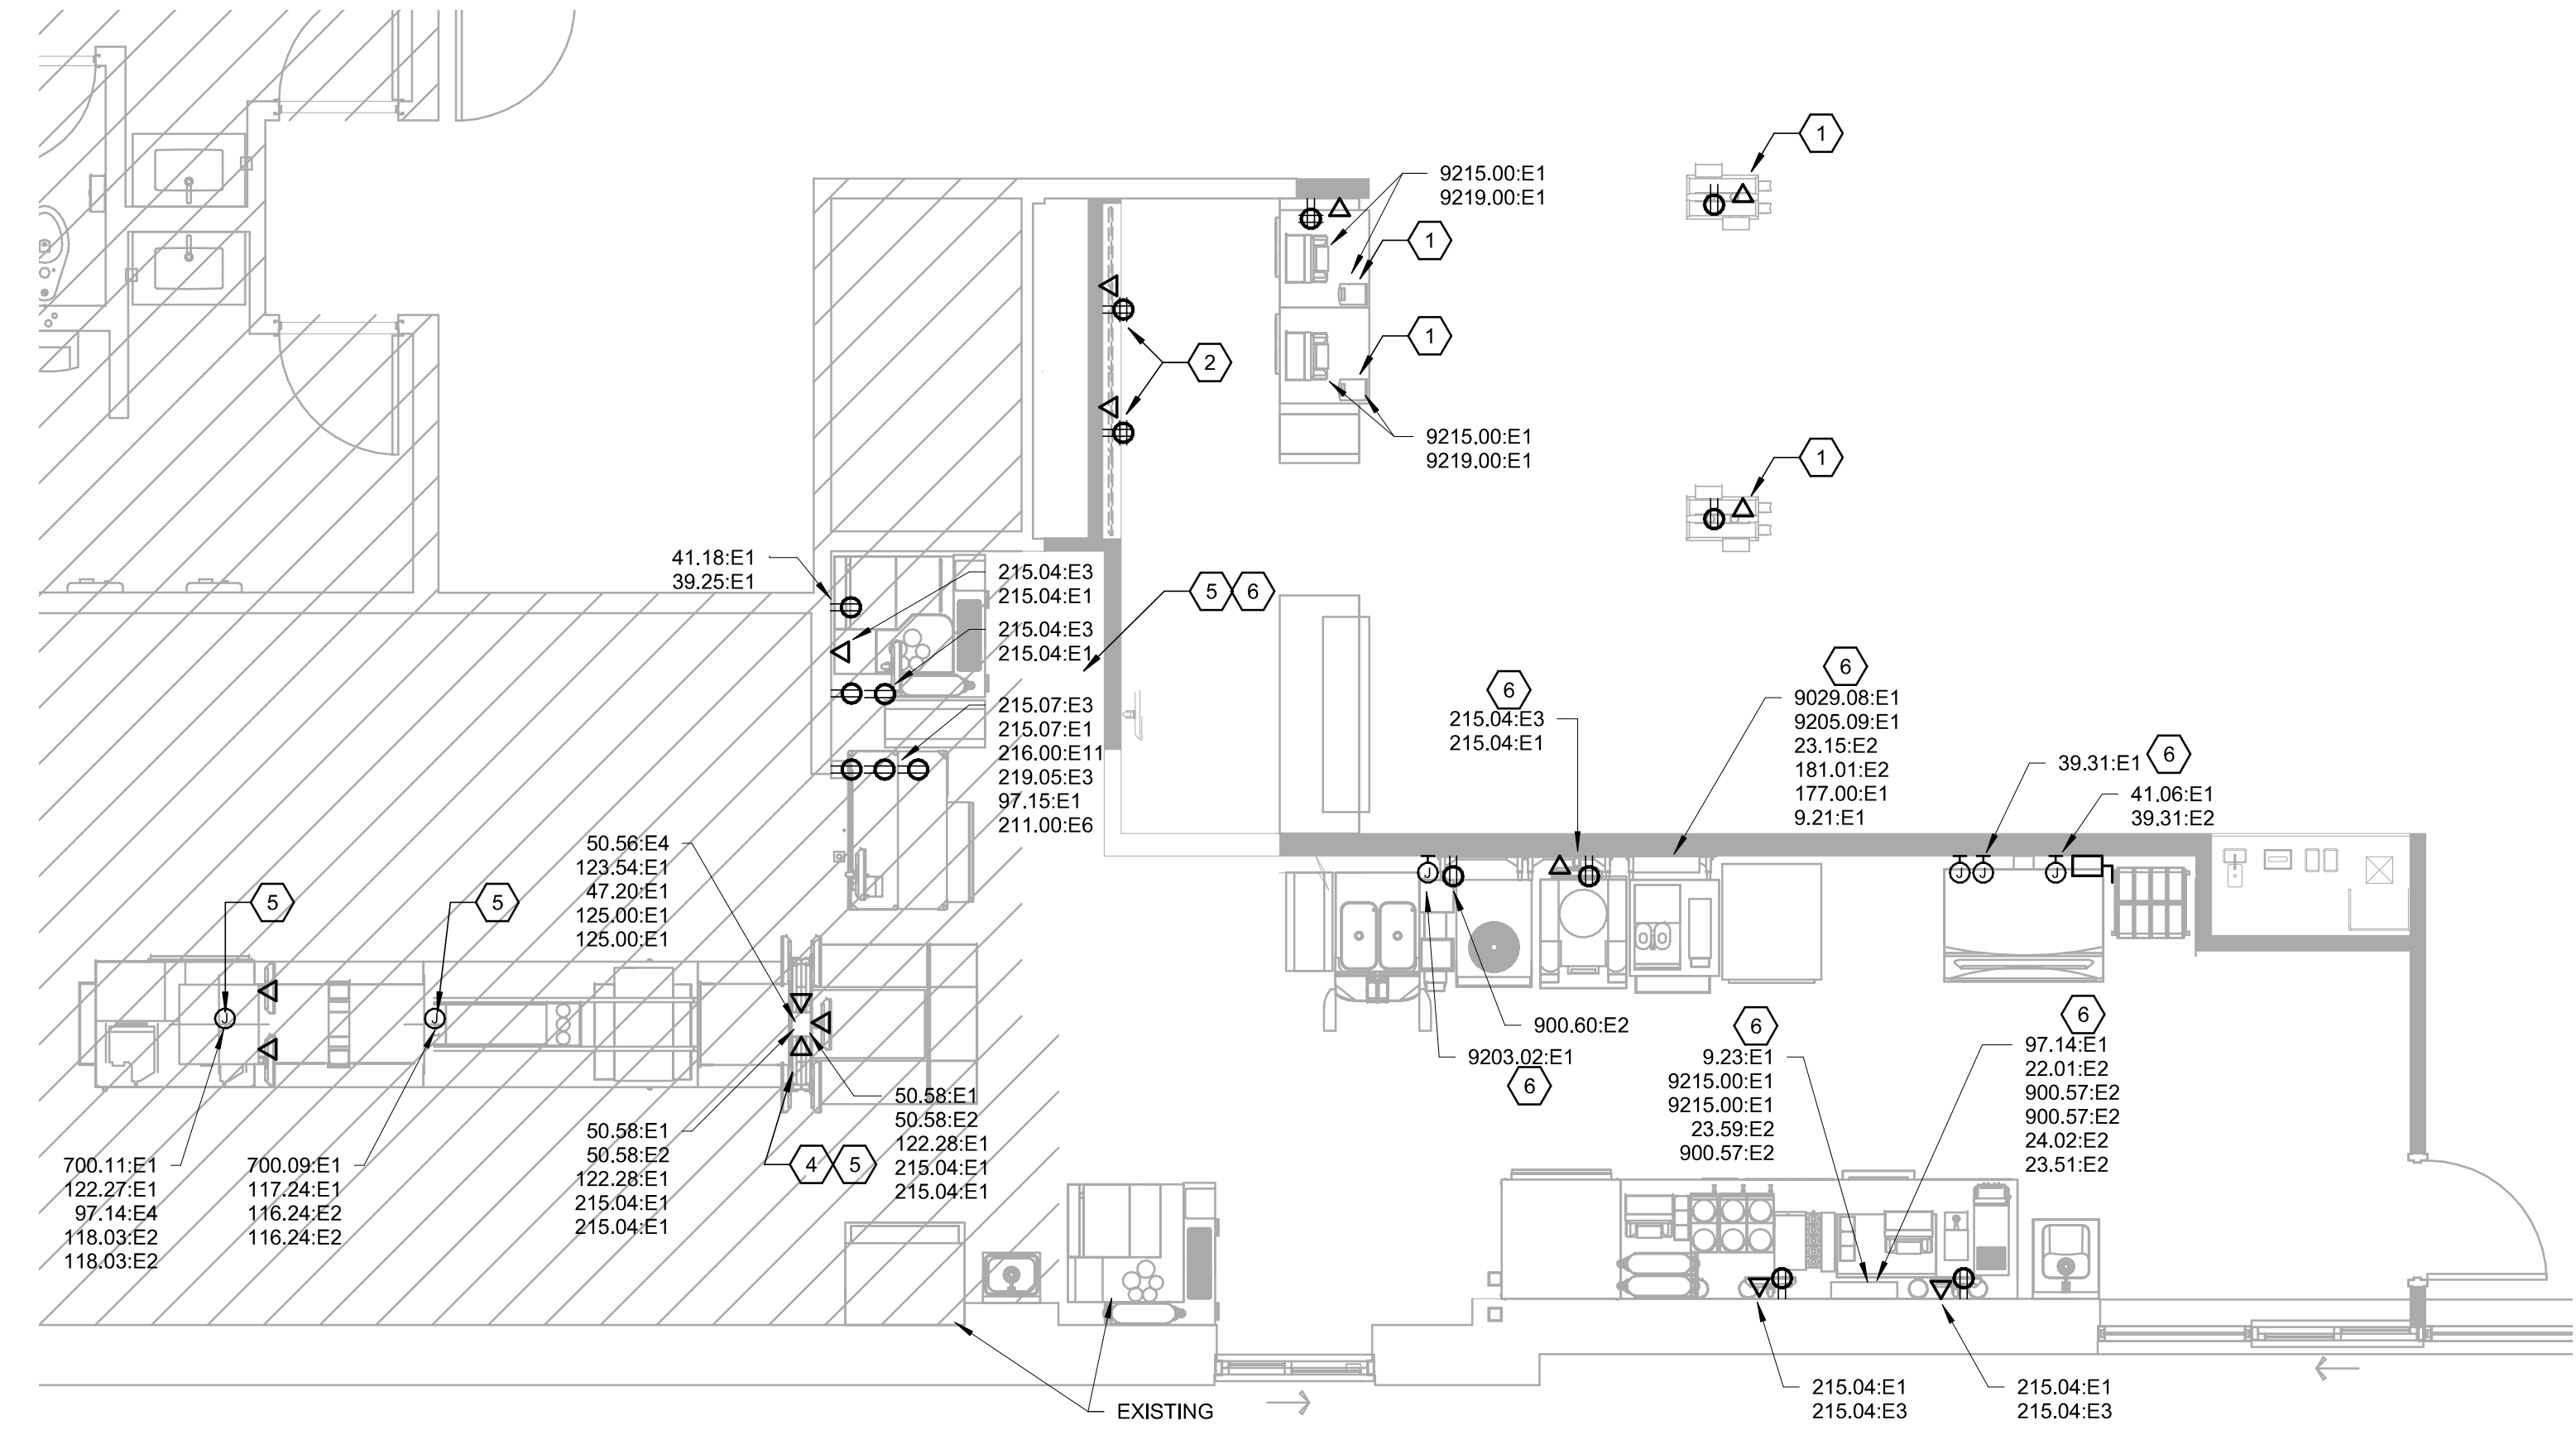
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2 Level 1-Power Plan - Employee Area SCALE: 1/4" = 1'-0"



1 Level 1-Power Plan Overall SCALE: 1/16" = 1'-0"



3 Level 1-Power Plan - Customer Area SCALE: 1/4" = 1'-0"

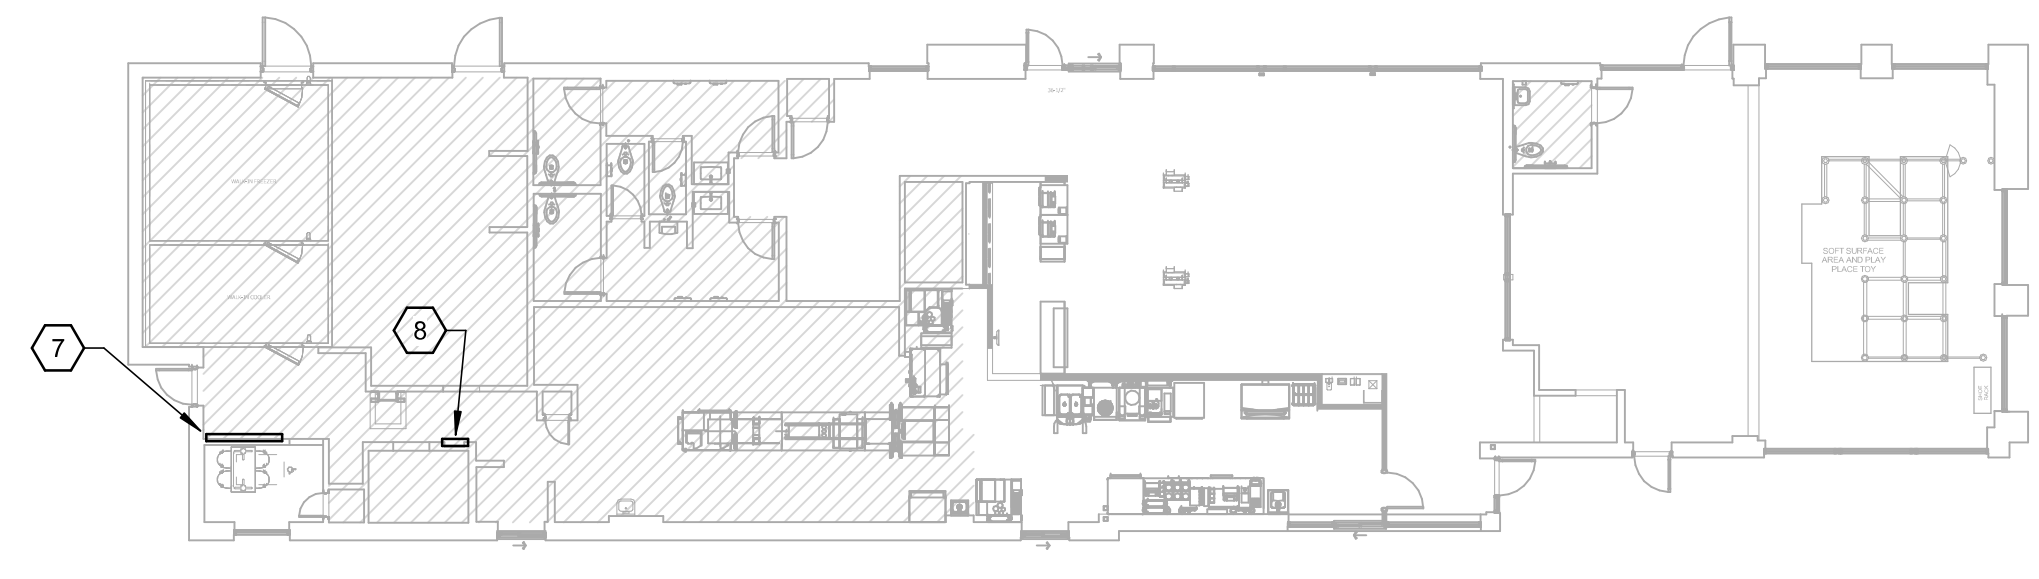KITCHEN EQUIPMENT SCHEDULE table with columns: ITEM, TAG, QTY, DESCRIPTION, VOLTS, PHASE, HP, BREAKER SIZE, AMPS, CONN TYPE, PLUG TYPE, CONN HEIGHT, REMARKS

NOTE: THESE DRAWINGS AND THE PROJECT MANUAL FOR MCDONALD'S STANDARD BUILDING PROGRAM COPYRIGHT 2013 ARE INTENDED TO DESCRIBE AND PROVIDE FOR A FINISHED PIECE OF WORK...

- GENERAL NOTES: 1. HATCHED AREA'S NOT INCLUDED IN SCOPE. 2. REFER TO KITCHEN EQUIPMENT SCHEDULE FOR EQUIPMENT SPECS AND CONNECTIONS. 3. REFER TO KITCHEN DESIGNER'S AND ARCHITECTURAL ELEVATIONS/DIMENSIONS FOR EXACT EQUIPMENT LOCATIONS.

- KEYED NOTES: 1. EXTEND EXISTING CIRCUITS AND DATA SERVING POINT OF SALE AND KIOSKS TO NEW LOCATION. 2. EXTEND EXISTING CIRCUITS AND DATA SERVING MENU BOARDS TO NEW LOCATION.

Revision table with columns: Rev, Date, Description

McDonald's McDonald's Store - Site ID# 32-0051 NSN# 2550 1726 West Cumberland Street Dunn, NC 28334

Drawn By IMEG Checked By IMEG Issue Date 05/23/2023 Project No 220679

Sheet Title POWER PLAN

Sheet Number E-102













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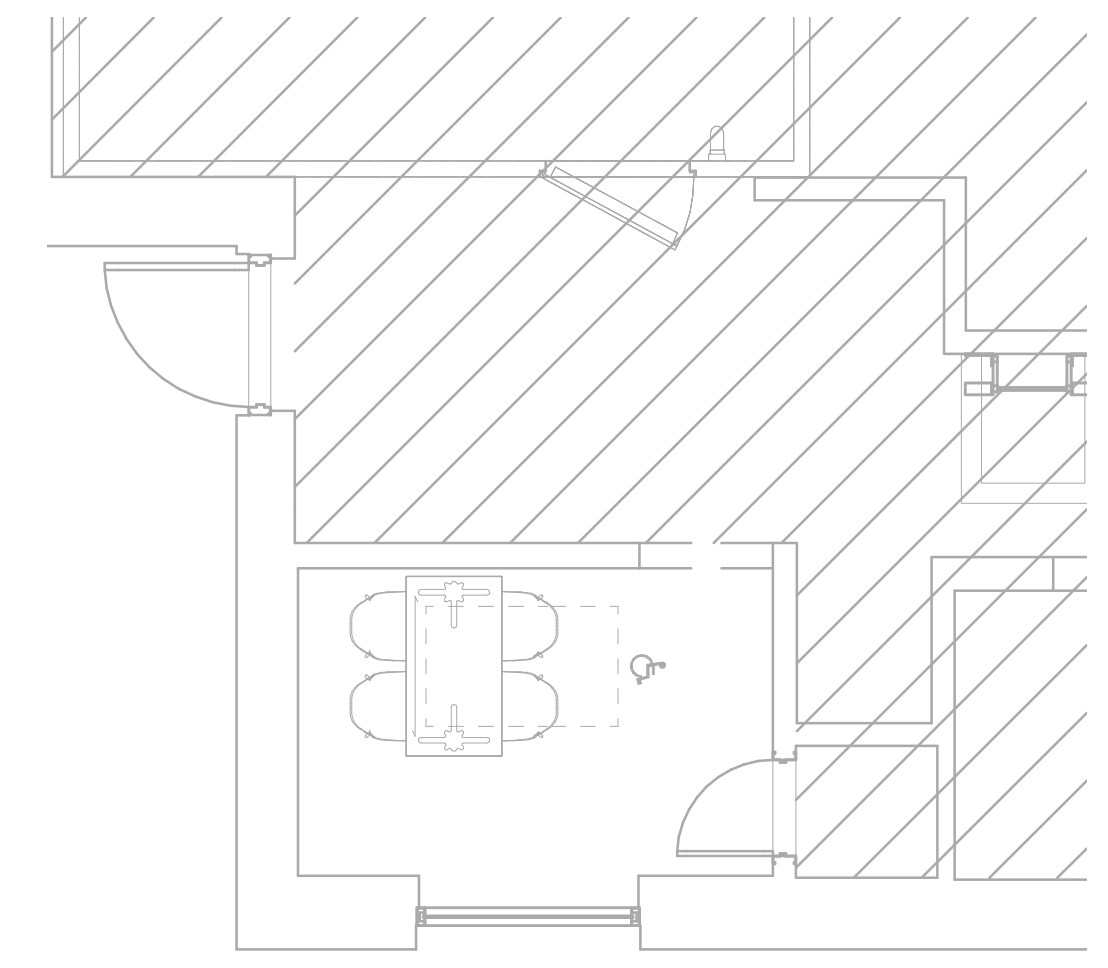


- # KEYED NOTES:
1. DISCONNECT AND REMOVE EXISTING PLUMBING FIXTURES AND ALL ASSOCIATED TRIM. REMOVE EXISTING WATER, WASTE, AND VENT PIPING TO MAIN. CAP AND SEAL PIPING.
  2. SAW CUT FLOOR SLAB AS REQUIRED TO INSTALL NEW PIPING TO SERVE NEW FIXTURES. CONTRACTOR TO FIELD VERIFY LOCATION OF EXISTING PIPING PRIOR TO BEGINNING CONSTRUCTION. PATCH SLAB TO MATCH EXISTING. COORDINATE WITH GC.
  3. EXTEND NEW SANITARY PIPING AND CONNECT TO EXISTING SANITARY PIPING IN THIS AREA. FIELD VERIFY EXACT LOCATION, SIZE, INVERT, AND DIRECTION OF FLOW OF EXISTING PIPING.
  4. EXTEND NEW VENT PIPING AND CONNECT TO EXISTING VENT PIPING IN THIS AREA. VERIFY EXACT LOCATION AND SIZE OF EXISTING PIPING IN FIELD.
  5. EXTEND NEW CW PIPING AND CONNECT TO EXISTING CW PIPING IN THIS AREA. VERIFY EXACT LOCATION AND SIZE OF EXISTING PIPING IN FIELD.
  6. EXTEND NEW HW PIPING AND CONNECT TO EXISTING HW PIPING IN THIS AREA. VERIFY EXACT LOCATION AND SIZE OF EXISTING PIPING IN FIELD.

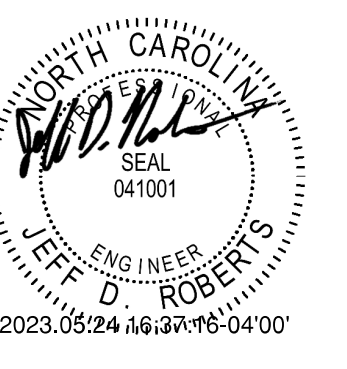
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1 Level 1-Plumbing Water Plan - Overall  
P-101 SCALE: 1/8" = 1'-0"



2 Level 1 - Plumbing Water Plan - Employee Area  
P-101 SCALE: 1/4" = 1'-0"

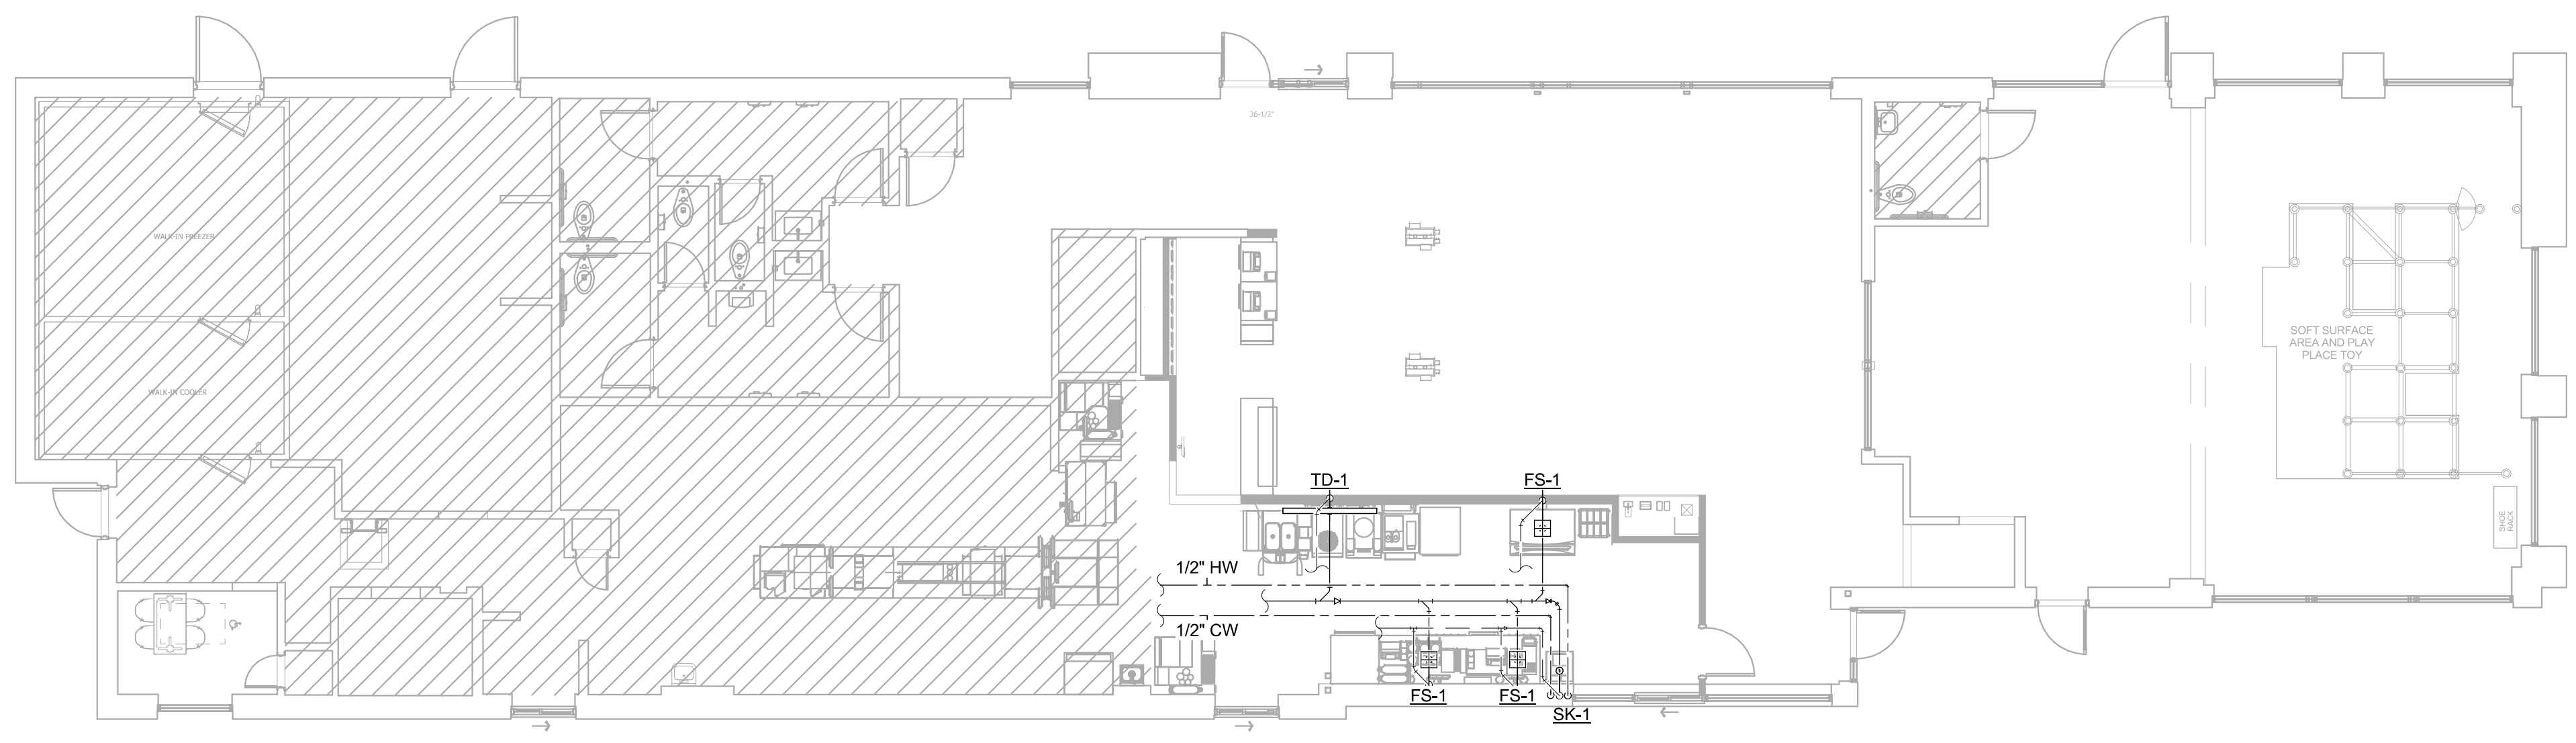

3 Level 1 - Plumbing Water Plan - Customer Area  
P-101 SCALE: 1/4" = 1'-0"

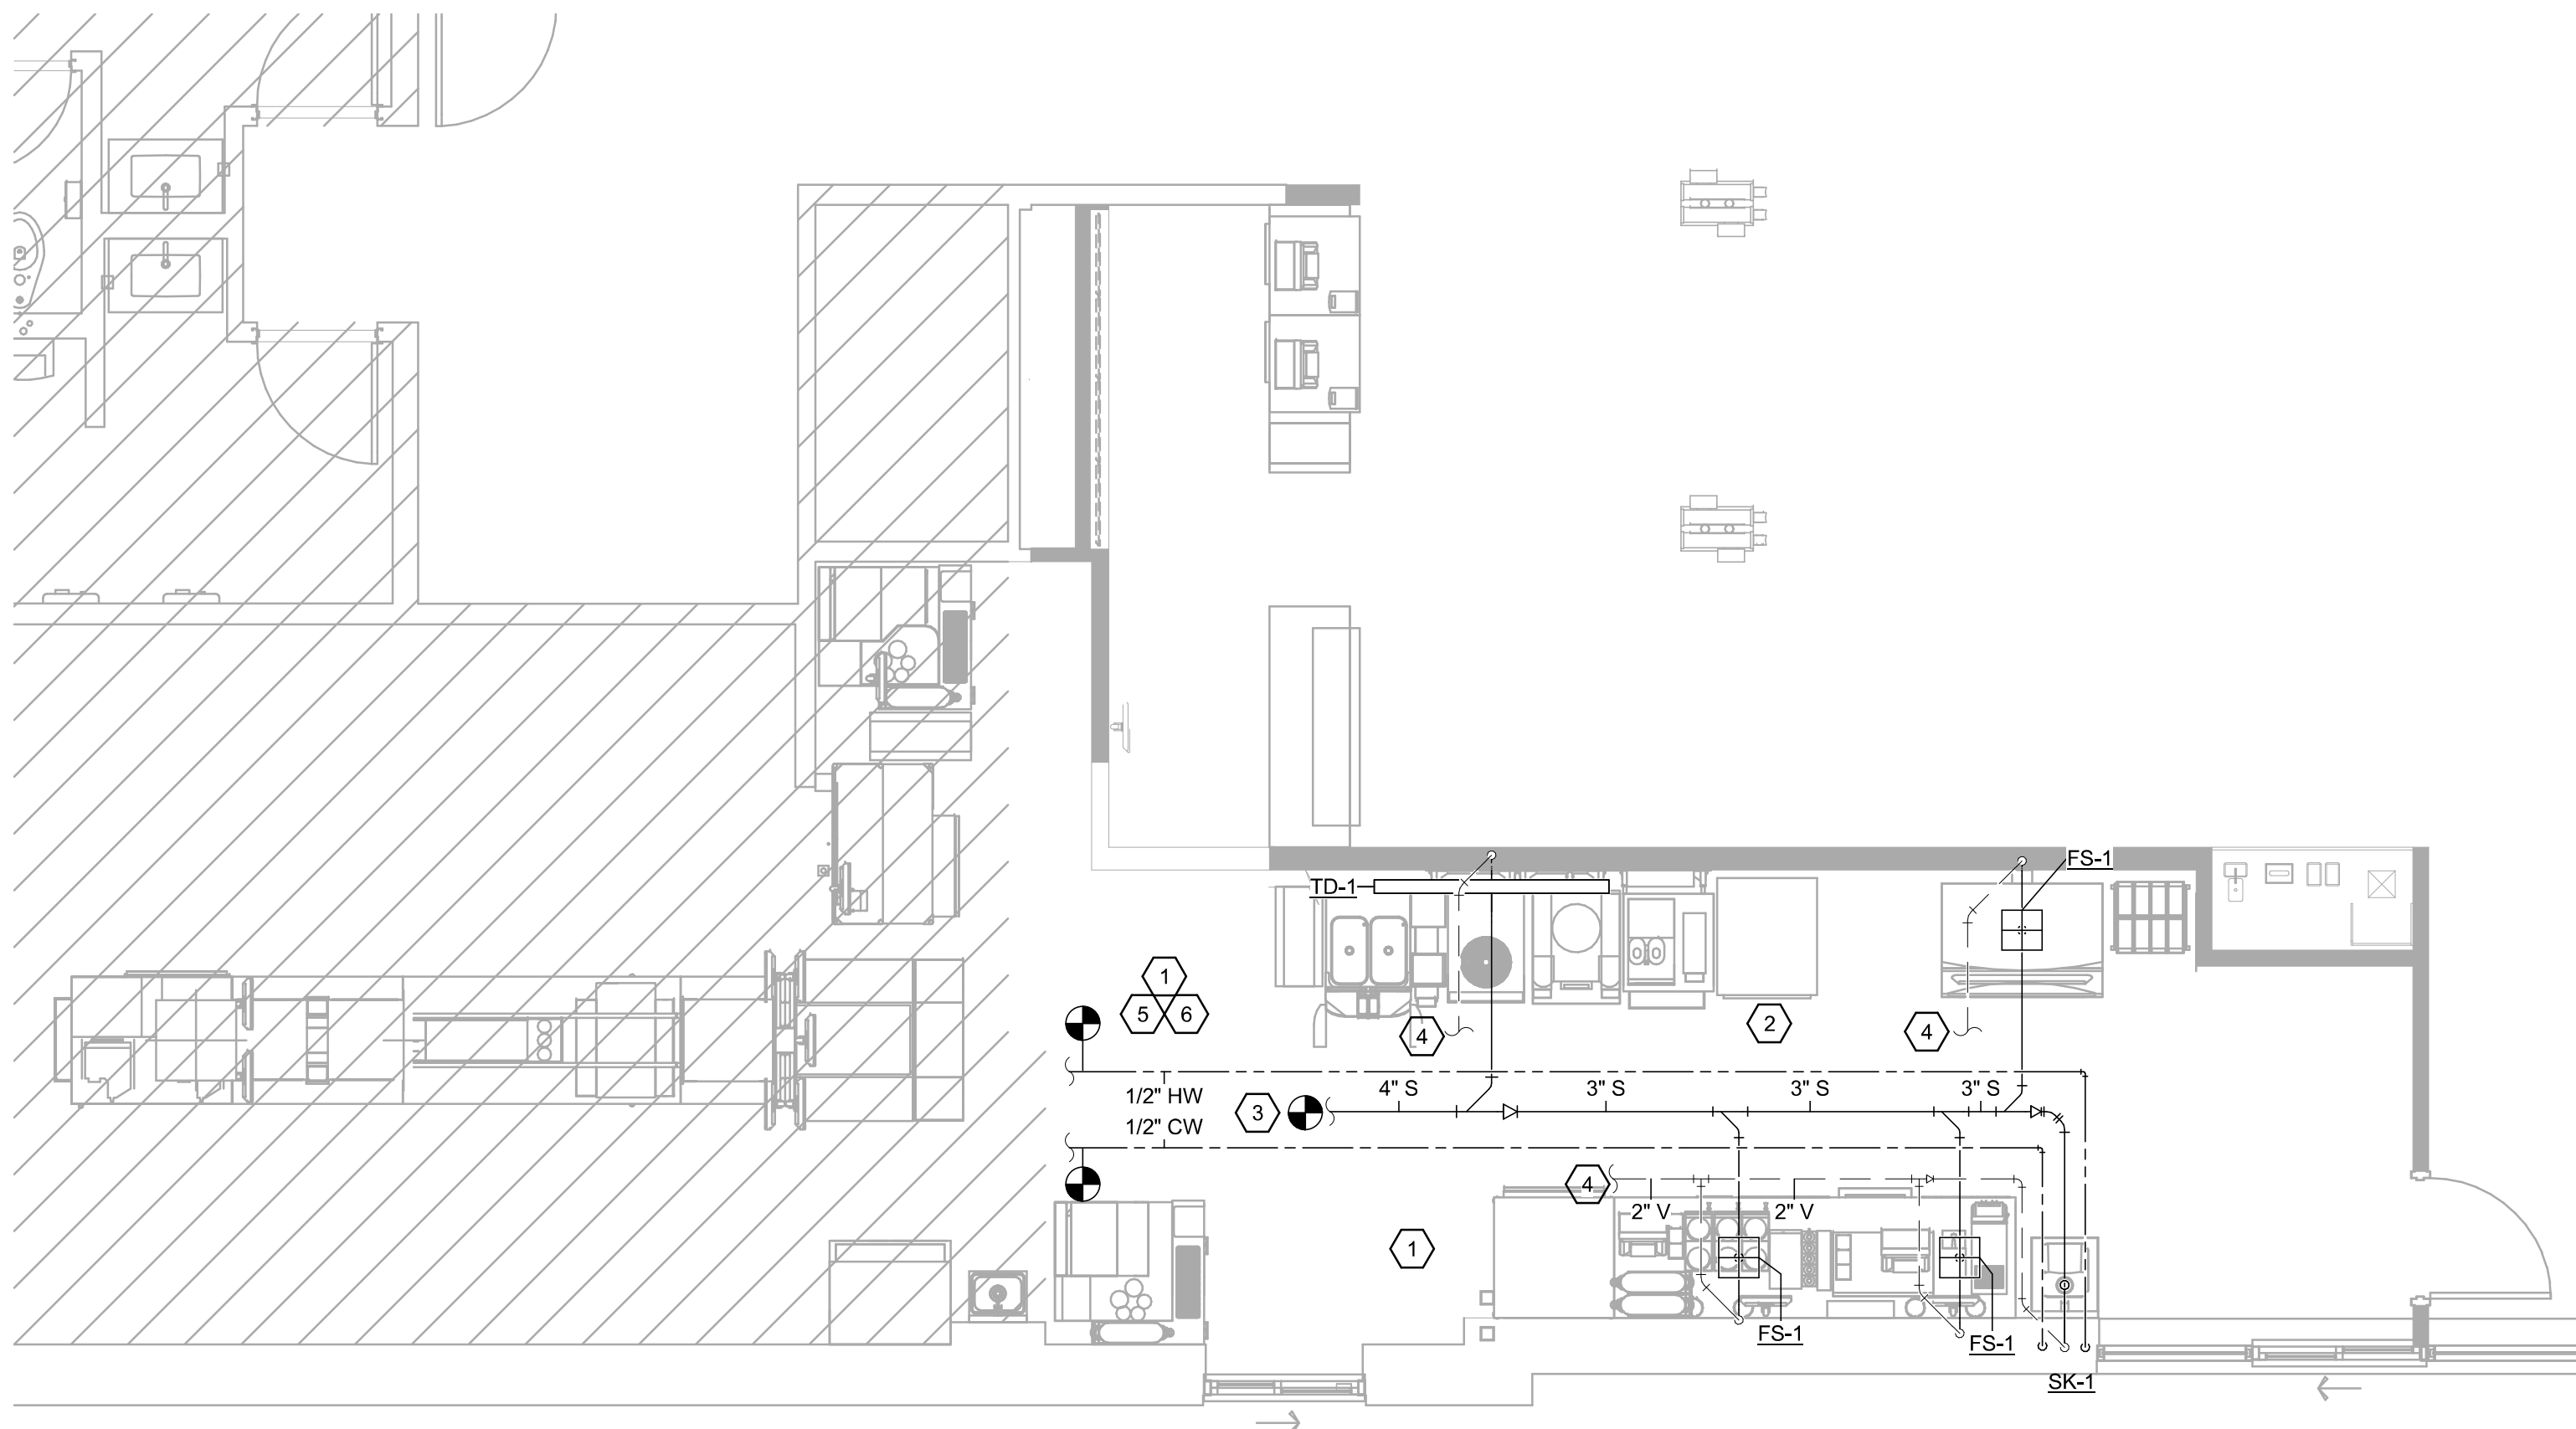Rev	Date	Description

**McDonald's**  
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Drawn By IMEG  
Checked By IMEG  
Issue Date 05/23/2023  
Project No 220679

Sheet Title  
NEW PLUMBING FLOOR PLAN

Sheet Number  
**P-101**



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