

COMPLIANCE CODE



ATC SITE NAME: MAMERS NC ATC SITE NUMBER: 414969

T-MOBILE SITE NAME: ATC-414969 T-MOBILE SITE NUMBER: 5RA0962A SITE ADDRESS: 177 DEAN RD.

LILLINGTON,NC 27546-7909

SITE CLASS: MONOPOLE

PROJECT SUMMARY



LOCATION MAP

SHEET INDEX

T-MOBILE COVERAGE STRATEGY COLLOCATION PLAN 67E998E 6160 (LRP) CONFIGURATION

PROJECT DESCRIPTION

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ALL WORK SHALL BE PERFORMED AND MATERIALS INSTALLED IN ACCORDANCE WITH THE CURRENT EDITIONS	SITE ADDRESS:	THE PROPOSED PROJECT INCLUDES INSTALLING EQUIPMENT CABINETS ON A PROPOSED CONCRETE PAD INSIDE A 10' X 15'	SHEET NO:	DESCRIPTION:	REV:	DATE:	BY:	
OF THE FOLLOWING CODES AS ADOPTED BY THE LOCAL GOVERNMENT AUTHORITIES. NOTHING IN THESE PLANS IS	177 DEAN RD. LILLINGTON,NC 27546-7909	GROUND SPACE WITHIN THE EXISTING COMPOUND, AND INSTALLING NEW EQUIPMENT AND MOUNTS ON THE EXISTING	G-001	TITLE SHEET	0	02/27/25	KPF	11
TO BE CONSTRUED TO PERMIT WORK NOT CONFORMING TO THESE CODES.	COUNTILITATIVETT	TOWER. TOWER SCOPE:	G-002	GENERAL NOTES	0	02/27/25	KPF	11
2015 IBC	GEOGRAPHIC COORDINATES: LATITUDE: 35.42135693	INSTALL (1) PLATFORM, (3) ANTENNA(s), (6) RRU(s), AND (2) 2.00" HYBRID TRUNK 6/24 4AWG (70M) CABLE(s)		EXISTING SURVEY				11
NATIONAL ELECTRICAL CODE (NFPA 70, NEC 2020 W/ AMND) 2018 NORTH CAROLINA MECHANICAL CODE (IMC 2015 W/	35° 25' 16.885" N	GROUND SCOPE:	C-101	DETAILED SITE PLAN	0	02/27/25	KPF	11
AMND) 2018 NORTH CAROLINA PLUMBING CODE (IPC 2015 W/ AMND)	LONGITUDE: -78.95682606 78° 57' 24.574" W	INSTALL (1) CONCRETE PAD, (1) ICE BRIDGE, (1) GPS ANTENNA, (2) H-FRAME, (1) PPC, (1) FIBER MANAGEMENT BOX, (1)	C-102	DETAILED EQUIPMENT PLAN	0	02/27/25	KPF	11
2018 NORTH CAROLINA ENERGY CONSERVATION CODE (IECC 2015 W/ AMND)	GROUND ELEVATION: 366' AMSL	COMMERCIAL GRADE WORK LIGHT, (1) NEMA ENCLOSURE, (1) TELCO CABINET, (1) ENCLOSURE 6160 CABINET, AND (1) B160	C-201	TOWER ELEVATION	0	02/27/25	KPF	
2018 NORTH CAROLÍNA FIRE PREVENTION CODE (IFC 2015 W/ AMND)		BATTERY CABINET	C-401	ANTENNA INFORMATION & SCHEDULE	0	02/27/25	KPF	
2018 NORTH CAROLINA BUILDING CODE 2018 NORTH CAROLINA RESIDENTIAL CODE (IRC 2015 W/		DDO IFOT NOTES	C-501	MOUNT DETAILS	0	02/27/25	KPF	
AMND) 2018 NORTH CAROLINA FUEL GAS CODE (IFGC 2015 W/ AMND)		PROJECT NOTES	C-502	CONSTRUCTION DETAILS	0	02/27/25	KPF	
, in the second of the second	PROJECT TEAM	THE FACILITY IS UNMANNED. A TECHNICIAN WILL VISIT THE SITE APPROXIMATELY ONCE A	C-503	CONSTRUCTION DETAILS	0	02/27/25	KPF	
	TOWER OWNER: APPLICANT:	MONTH FOR ROUTINE INSPECTION AND MAINTENANCE. 3. THE PROJECT WILL NOT RESULT IN ANY SIGNIFICANT LAND	E-101	GROUNDING PLAN AND NOTES	0	02/27/25	KPF	
	AMERICAN TOWER T-MOBILE	DISTURBANCE OR EFFECT OF STORM WATER DRAINAGE. 4. NO SANITARY SEWER, POTABLE WATER OR TRASH DISPOSAL	E-501	GROUNDING DETAILS	0	02/27/25	KPF	
	10 PRESIDENTIAL WAY 2801 YORKMONT RD, STE 200 WOBURN, MA 01801 CHARLOTTE, NC 28217	IS REQUIRED. 5. HANDICAP ACCESS IS NOT REQUIRED.	E-601	PANEL SCHEDULE & ONE-LINE DIAGRAM	0	02/27/25	KPF	
	ENGINEER:	THE PROJECT DEPICTED IN THESE PLANS QUALIFIES AS AN ELIGIBLE FACILITIES REQUEST ENTITLED TO EXPEDITED		SUPPLEMENTAL SHEETS (11 PAGES)				
	A.T. ENGINEERING SERVICES,	REVIEW UNDER 47 U.S.C. § 1455(A) AS A MODIFICATION OF AN EXISTING WIRELESS TOWER THAT INVOLVES THE						
UTILITY COMPANIES	PLLC 1 FENTON MAIN, STE 300	COLLOCATION, REMOVAL, AND/OR REPLACEMENT OF TRANSMISSION EQUIPMENT THAT IS NOT A SUBSTANTIAL						
POWER COMPANY: SOUTH RIVER ELECTRIC CORP.	CARY, NC 27511 PROPERTY OWNER:	CHANGE UNDER CFR § 1.61000 (B)(7).						
PHONE: 910-892-8071	DEBRA D WOMACK	PROJECT LOCATION DIRECTIONS						
TELEPHONE COMPANY: CENTURYLINK PHONE: 888-723-8010	177 DEAN RD. LILLINGTON,NC 27546-7909							
OTT.		TAKE EXIT 79 FROM INTERSTATE 95 ONTO N CAROLINA 50						-
Į Į,		NORTHKEEP LEFT ONTO NC-27 W AND US-421 N TURN LEFT ONTO DEAN RD.TURN LEFT ONTO THE GRAVEL ROAD AT 177.						-
Know where below.								-
Call before you dig.						1		



1 FENTON MAIN SUITE 300 CARY, NC 27511

PHONE: (919) 468-0112 P-1177

THE USE AND PUBLICATION OF THESE DRAWINGS SHALL BE RESTRICTED TO THE ORIGINAL SITE FOR WHICH THEY ARE PREPARED. ANY USE OR DISCLOSURE OTHER THAN THAT WHICH RELATES TO AMERICAN TOWER OR THE SPECIFIED CARRIER IS STRICTLY PROHIBITED. NEITHER THE ARCHITECT NOR THE ENGINEER WILL BE PROVIDING ON-SITE CONSTRUCTION REVIEW OF THIS PROJECT. CONTRACTOR(S) MUST VERIFY ALL DIMENSIONS AND ADVISE AMERICAN TOWER OR THE SPECIFIED CARRIER OF ANY DISCREPANCIES. ANY PRIOR ISSUANCE OF THIS DRAWING IS SUPERSEDED BY THE LATEST VERSION.

REV.	DESCRIPTION	BY	DATE
△.	FOR CONSTRUCTION	KPF	02/27/25
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	ATC SITE NUMBER:		

414969 ATC SITE NAME:

MAMERS NC

T-MOBILE SITE NAME

ATC-414969

SITE ADDRESS: 177 DEAN RD. LILLINGTON.NC 27546-7909

SEAL



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	ATC PROJ. #:	15020848_D2
	CUST. ID:	ATC-414969
	CUST. #:	5RA0962A
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TITLE SHEET

SHEET NUMBER:

G-001

GENERAL CONSTRUCTION NOTES:

- OWNER FURNISHED MATERIALS, T-MOBILE "THE COMPANY" WILL PROVIDE AND THE CONTRACTOR WILL INSTALL
- A. BTS EQUIPMENT FRAME (PLATFORM) AND ICEBRIDGE SHELTER (GROUND
 - BUILD/CO-LOCATE ONLY) AC/TELCO INTERFACE BOX (PPC)
 - C. ICE BRIDGE (CABLE TRAY WITH COVER) (GROUND BUILD/CO-LOCATE ONLY, GC TO FURNISH AND INSTALL FOR ROOFTOP INSTALLATION)
- D. TOWERS, MONOPOLES
- TOWER LIGHTING
- GENERATORS & LIQUID PROPANE TANK
- G. ANTENNA STANDARD BRACKETS, FRAMES AND PIPES FOR MOUNTING
- ANTENNAS (INSTALLED BY OTHERS)
- TRANSMISSION LINE
- TRANSMISSION LINE JUMPERS
- TRANSMISSION LINE CONNECTORS WITH WEATHERPROOFING KITS
- TRANSMISSION LINE GROUND KITS
- HANGERS
- HOISTING GRIPS
- O. BTS EQUIPMENT
- THE CONTRACTOR IS RESPONSIBLE TO PROVIDE ALL OTHER MATERIALS FOR THE COMPLETE INSTALLATION OF THE SITE INCLUDING, BUT NOT LIMITED TO, SUCH MATERIALS AS FENCING, STRUCTURAL STEEL SUPPORTING SUB-FRAME FOR PLATFORM, ROOFING LABOR AND MATERIALS GROUNDING RINGS GROUNDING WIRES COPPER-CLAD OR XIT CHEMICAL GROUND ROD(S), BUSS BARS, TRANSFORMERS AND DISCONNECT SWITCHES WHERE APPLICABLE, TEMPORARY ELECTRICAL POWER CONDUIT, LANDSCAPING COMPOUND STONE, CRANES, CORE DRILLING, SLEEPERS AND RUBBER MATTING, REBAR, CONCRETE CAISSONS, PADS AND/OR AUGER MOUNTS, MISCELLANEOUS FASTENERS, CABLE TRAYS, NON-STANDARD ANTENNA FRAMES AND ALL OTHER MATERIAL AND LABOR REQUIRED TO COMPLETE THE JOB ACCORDING TO THE DRAWINGS AND SPECIFICATIONS. IT IS THE POSITION OF T-MOBILE TO APPLY FOR PERMITTING AND CONTRACTOR RESPONSIBLE FOR PICKUP AND PAYMENT OF REQUIRED
- ALL WORK SHALL CONFORM TO ALL CURRENT APPLICABLE FEDERAL, STATE, AND LOCAL CODES, INCLUDING ANSI/EIA/TIA-222, AND COMPLY WITH ATC CONSTRUCTION
- CONTRACTOR SHALL CONTACT LOCAL 811 FOR IDENTIFICATION OF UNDERGROUND UTILITIES PRIOR TO START OF CONSTRUCTION.
- CONTRACTOR SHALL BE RESPONSIBLE FOR COORDINATING ALL REQUIRED INSPECTIONS.
- ALL DIMENSIONS TO, OF, AND ON EXISTING BUILDINGS, DRAINAGE STRUCTURES, AND SITE IMPROVEMENTS SHALL BE VERIFIED IN FIELD BY CONTRACTOR WITH ALL DISCREPANCIES REPORTED TO THE ENGINEER.
- DO NOT CHANGE SIZE OR SPACING OF STRUCTURAL ELEMENTS
- DETAILS SHOWN ARE TYPICAL: SIMILAR DETAILS APPLY TO SIMILAR CONDITIONS UNLESS
- THESE DRAWINGS DO NOT INCLUDE NECESSARY COMPONENTS FOR CONSTRUCTION SAFETY WHICH SHALL BE THE SOLE RESPONSIBILITY OF THE CONTRACTOR
- CONTRACTOR SHALL BRACE STRUCTURES UNTIL ALL STRUCTURAL ELEMENTS NEEDED FOR STABILITY ARE INSTALLED. THESE ELEMENTS ARE AS FOLLOWS: LATERAL BRACING, 34.
- CONTRACTOR SHALL DETERMINE EXACT LOCATION OF EXISTING UTILITIES, GROUNDS DRAINS, DRAIN PIPES, VENTS, ETC, BEFORE COMMENCING WORK
- INCORRECTLY FABRICATED, DAMAGED, OR OTHERWISE MISFITTING OR NONCONFORMING MATERIALS OR CONDITIONS SHALL BE REPORTED TO THE T-MOBILE REP PRIOR TO REMEDIAL OR CORRECTIVE ACTION, ANY SUCH REMEDIAL ACTION SHALL REQUIRE WRITTEN APPROVAL BY THE T-MOBILE REP PRIOR TO PROCEEDING.
- EACH CONTRACTOR SHALL COOPERATE WITH THE T-MOBILE REP, AND COORDINATE HIS WORK WITH THE WORK OF OTHERS.
- CONTRACTOR SHALL REPAIR ANY DAMAGE CAUSED BY CONSTRUCTION OF THIS PROJECT TO MATCH EXISTING PRE-CONSTRUCTION CONDITIONS TO THE SATISFACTION
- ALL CABLE/CONDUIT ENTRY/EXIT PORTS SHALL BE WEATHERPROOFED DURING 15. INSTALLATION LISING A SILICONE SEALANT
- WHERE EXISTING CONDITIONS DO NOT MATCH THOSE SHOWN IN THIS PLAN SET. CONTRACTOR SHALL NOTIFY THE T-MOBILE REP AND ENGINEER OF RECORD
- CONTRACTOR SHALL ENSURE ALL SUBCONTRACTORS ARE PROVIDED WITH A COMPLETE AND CURRENT SET OF DRAWINGS AND SPECIFICATIONS FOR THIS PROJECT.
- CONTRACTOR SHALL REMOVE ALL RUBBISH AND DEBRIS FROM THE SITE AT THE END OF **EACH DAY**
- CONTRACTOR SHALL COORDINATE WORK SCHEDULE WITH AMERICAN TOWER CORPORATION (ATC) AND TAKE PRECAUTIONS TO MINIMIZE IMPACT AND DISRUPTION OF OTHER OCCUPANTS OF THE FACILITY.
- CONTRACTOR SHALL FURNISH T-MOBILE AND AMERICAN TOWER CORPORATION (ATC) WITH A PDF MARKED UP AS-BUILT SET OF DRAWINGS UPON COMPLETION OF WORK
- PRIOR TO SUBMISSION OF BID CONTRACTOR SHALL COORDINATE WITH T-MOBILE REP. TO DETERMINE WHAT, IF ANY, ITEMS WILL BE PROVIDED. ALL ITEMS NOT PROVIDED SHALL BE PROVIDED AND INSTALLED BY THE CONTRACTOR. CONTRACTOR WILL INSTALL

- 22. PRIOR TO SUBMISSION OF BID. CONTRACTOR SHALL COORDINATE WITH T-MORII F REP TO DETERMINE IF ANY PERMITS WILL BE OBTAINED BY CONTRACTOR. ALL REQUIRED PERMITS NOT OBTAINED BY T-MOBILE MUST BE OBTAINED. AND PAID FOR, BY THE
- CONTRACTOR SHALL INSTALL ALL SITE SIGNAGE IN ACCORDANCE WITH T-MOBILE SPECIFICATIONS AND REQUIREMENTS.
- CONTRACTOR SHALL SUBMIT ALL SHOP DRAWINGS TO T-MOBILE FOR REVIEW AND 24. APPROVAL PRIOR TO FARRICATION
- ALL EQUIPMENT SHALL BE INSTALLED ACCORDING TO MANUFACTURER'S SPECIFICATIONS AND LOCATED ACCORDING TO T-MOBILE SPECIFICATIONS, AND AS SHOWN IN THESE PLANS
- 26. THE CONTRACTOR SHALL SUPERVISE AND DIRECT THE PROJECT DESCRIBED HEREIN THE CONTRACTOR SHALL BE SOLELY RESPONSIBLE FOR ALL THE CONSTRUCTION MEANS, METHODS, TECHNIQUES, SEQUENCES AND PROCEDURES AND FOR COORDINATING ALL PORTIONS OF THE WORK UNDER THE CONTRACT.
- CONTRACTOR SHALL NOTIFY T-MOBILE REP A MINIMUM OF 48 HOURS IN ADVANCE OF POURING CONCRETE OR BACKFILLING ANY UNDERGROUND UTILITIES, FOUNDATIONS OR SEALING ANY WALL, FLOOR OR ROOF PENETRATIONS FOR ENGINEERING REVIEW AND
- WHEN THE PROJECT SCOPE REQUIRES THE USE OF THE SAFETY CLIMB, THE GENERAL CONTRACTOR SHALL ENSURE THE SAFETY CLIMB IS FREE OF OBSTRUCTIONS, NOT RUBBING ON OR TRAPPED BY ANY INSTALLED CUSTOMER EQUIPMENT. IS VISUALLY AUT, MEETS MANUFACTURER INSTALLATION SPECIFICATIONS, AND IS FIRMLY SECURED AT ALL CABLE GUIDE LOCATIONS UPON PROJECT COMPLETION
- COMPLETION OF PROJECT SHALL NOT OBSTRUCT TRAP LOOSEN OR OTHERWISE CAUSE FAILURE TO MEET MANUFACTURER INSTALLATION REQUIREMENTS FOR THE
- CONTRACTOR SHALL BE RESPONSIBLE FOR SITE SAFETY INCLUDING COMPLIANCE WITH ALL APPLICABLE OSHA STANDARDS AND RECOMMENDATIONS AND SHALL PROVIDE ALL NECESSARY SAFETY DEVICES INCLUDING PPE AND PPM AND CONSTRUCTION DEVICES SUCH AS WELDING AND FIRE PREVENTION, TEMPORARY SHORING, SCAFFOLDING TRENCH BOXES/SLOPING, BARRIERS, ETC.
- THE CONTRACTOR SHALL PROTECT AT HIS OWN EXPENSE, ALL EXISTING FACILITIES AND SUCH OF HIS NEW WORK LIABLE TO INJURY DURING THE CONSTRUCTION PERIOD. ANY DAMAGE CAUSED BY NEGLECT ON THE PART OF THIS CONTRACTOR OR HIS REPRESENTATIVES, OR BY THE ELEMENTS DUE TO NEGLECT ON THE PART OF THIS CONTRACTOR OR HIS REPRESENTATIVES, EITHER TO THE EXISTING WORK, OR TO HIS WORK OR THE WORK OF ANY OTHER CONTRACTOR, SHALL BE REPAIRED AT HIS EXPENSE TO THE OWNER'S SATISFACTION.
- ALL WORK SHALL BE INSTALLED IN A FIRST CLASS, NEAT AND WORKMANLIKE MANNER BY MECHANICS SKILLED IN THE TRADE INVOLVED. THE QUALITY OF WORKMANSHIP SHALL BE SUBJECT TO THE APPROVAL OF THE T-MOBILE REP. ANY WORK FOUND BY THE T-MOBILE REP TO BE OF INFERIOR QUALITY AND/OR WORKMANSHIP REPLACED AND/OR REWORKED AT CONTRACTOR EXPENSE UNTIL APPROVAL IS
- IN ORDER TO ESTABLISH STANDARDS OF QUALITY AND PERFORMANCE, ALL TYPES OF MATERIALS LISTED HEREINAFTER BY MANUFACTURER'S NAMES AND/OR MANUFACTURER'S CATALOG NUMBER SHALL BE PROVIDED BY THESE MANUFACTURERS
- T-MOBILE FURNISHED EQUIPMENT SHALL BE PICKED-UP AT THE T-MOBILE WAREHOUSE, NO LATER THAN 48HR AFTER BEING NOTIFIED INSURED, STORED, UNCRATE, PROTECTED AND INSTALLED BY THE CONTRACTOR WITH ALL APPURTENANCES REQUIRED TO PLACE HE EQUIPMENT IN OPERATION, READY FOR USE. THE CONTRACTOR SHALL BE RESPONSIBLE FOR THE EQUIPMENT AFTER PICKING IT UP
- T-MOBILE OR HIS ARCHITECT/ENGINEER RESERVES THE RIGHT TO REJECT ANY EQUIPMENT OR MATERIALS WHICH, IN HIS OWN OPINION ARE NOT IN COMPLIANCE WITH THE CONTRACT DOCUMENTS, EITHER BEFORE OR AFTER INSTALLATION AND THE EQUIPMENT SHALL BE REPLACED WITH EQUIPMENT CONFORMING TO THE REQUIREMENTS OF THE CONTRACT DOCUMENTS BY THE CONTRACTOR AT NO COST TO T-MOBILE OR THEIR ARCHITECT/ENGINEER.

STRUCTURAL STEEL NOTES:

- STRUCTURAL STEEL SHALL CONFORM TO THE LATEST EDITION OF THE AISC SPECIFICATION FOR THE DESIGN, FABRICATION AND ERECTION OF STRUCTURAL STEEL
- 2. STRUCTURAL STEEL ROLLED SHAPES, PLATES AND BARS SHALL CONFORM TO THE FOLLOWING ASTM DESIGNATIONS:
 - A. ASTM A-572, GRADE 50 ALL W SHAPES, UNLESS NOTED OR A992 OTHERWISE
 - B. ASTM A-36 ALL OTHER ROLLED SHAPES, PLATES AND BARS UNLESS NOTED
 - C. ASTM A-500, GRADE B HSS SECTION (SQUARE, RECTANGULAR, AND ROUND)
 - D. ASTM A-325, TYPE SC OR N ALL BOLTS FOR CONNECTING STRUCTURAL
 - E. ASTM F-1554 07 ALL ANCHOR BOLTS, UNLESS NOTED OTHERWISE
- ALL EXPOSED STRUCTURAL STEEL MEMBERS SHALL BE HOT-DIPPED GALVANIZED AFTER 3. FABRICATION PER ASTM A123. EXPOSED STEEL HARDWARE AND ANCHOR BOLTS SHALL BE GALVANIZED PER ASTM A153 OR B695.
- ALL FIELD CUT SURFACES, FIELD DRILLED HOLES AND GROUND SURFACES WHERE EXISTING PAINT OR GALVANIZATION REMOVAL WAS REQUIRED SHALL BE REPAIRED WITH (2) BRUSHED COATS OF ZRC GALVILITE COLD GALVANIZING COMPOUND PER ASTM A780 AND MANUFACTURER'S RECOMMENDATIONS

- DO NOT DRILL HOLES THROUGH STRUCTURAL STEEL MEMBERS EXCEPT AS SHOWN AND DETAILED ON STRUCTURAL DRAWINGS.
- 6 CONNECTIONS:
 - A. ALL WELDING TO BE PERFORMED BY AWS CERTIFIED WELDERS AND CONDUCTED IN ACCORDANCE WITH THE LATEST EDITION OF THE AWS WELDING
 - B. ALL WELDS SHALL BE INSPECTED VISUALLY, 25% OF WELDS SHALL BE INSPECTED WITH DYE PENETRANT OR MAGNETIC PARTICLE TO MEET THE ACCEPTANCE CRITERIA OF AWS D1.1. REPAIR ALL WELDS AS NECESSARY
 - INSPECTION SHALL BE PERFORMED BY AN AWS CERTIFIED WELD INSPECTOR.
 - D. IT IS THE CONTRACTORS RESPONSIBILITY TO PROVIDE BURNING/WELDING PERMITS AS REQUIRED BY LOCAL GOVERNING AUTHORITY AND IF REQUIRED SHALL HAVE FIRE DEPARTMENT DETAIL FOR ANY WELDING ACTIVITY
 - E. ALL ELECTRODES TO BE LOW HYDROGEN, MATCHING FILLER METAL, PER AWS D1.1. UNLESS NOTED OTHERWISE.
 - F. MINIMUM WELD SIZE TO BE 0.1875 INCH FILLET WELDS, UNLESS NOTED
 - G. PRIOR TO FIELD WELDING GALVANIZING MATERIAL, CONTRACTOR SHALL GRIND OFF GALVANIZING 1/2" BEYOND ALL FIELD WELD SURFACES. AFTER WELD AND WELD INSPECTION IS COMPLETE, REPAIR ALL GROUND AND WELDED SURFACES WITH ZRC GALVILITE COLD GALVANIZING COMPOUND PER ASTM A780 AND MANUFACTURERS RECOMMENDATIONS.
 - H THE CONTRACTOR SHALL PROVIDE ADEQUATE SHORING AND/OR BRACING WHERE REQUIRED DURING CONSTRUCTION UNTIL ALL CONNECTIONS ARE
 - ANY FIELD CHANGES OR SUBSTITUTIONS SHALL HAVE PRIOR APPROVAL FROM THE ENGINEER, AND T-MOBILE PROJECT MANAGER IN WRITING

ANTENNA INSTALLATION NOTES:

- WORK INCLUDED:
 - ANTENNA AND COAXIAL CABLES ARE FURNISHED BY T-MOBILE UNDER A SEPARATE CONTRACT. THE CONTRACTOR SHALL ASSIST ANTENNA INSTALLATION CONTRACTOR IN TERMS OF COORDINATION AND SITE ACCESS. ERECTION SUBCONTRACTOR SHALL BE RESPONSIBLE FOR THE PROTECTION OF
 - B. INSTALL ANTENNAS AS INDICATED ON DRAWINGS AND T-MOBILE SPECIFICATIONS
 - C. INSTALL GALVANIZED STEEL ANTENNA MOUNTS AS INDICATED ON DRAWINGS.
 - D. INSTALL FURNISHED GALVANIZED STEEL OR ALUMINUM WAVEGUIDE AND PROVIDE PRINTOUT OF THAT TEST
 - E. CONTRACTOR SHALL PROVIDE FOUR (4) SETS OF SWEEP TESTS USING ANRITZU-PACKARD 8713B RF SCALAR NETWORK ANALYZER. SUBMIT FREQUENCY DOMAIN REFLECTOMETER(FDR) TESTS RESULTS TO THE PROJECT MANAGER. SWEEP TESTS SHALL BE AS PER ATTACHED RES "MINIMUM FIELD TESTING. RECOMMENDED FOR ANTENNA AND HELIAX COAXIAL CABLE SYSTEMS" DATED 10/5/93. TESTING SHALL BE PERFORMED BY AN INDEPENDENT TESTING SERVICE AND BE BOUND AND SUBMITTED WITHIN ONE WEEK OF WORK COMPLETION.
 - F. INSTALL COAXIAL CABLES AND TERMINATING BETWEEN ANTENNAS AND EQUIPMENT PER MANUFACTURER'S RECOMMENDATIONS. WEATHERPROOF ALL CONNECTIONS BETWEEN THE ANTENNA AND EQUIPMENT PER MANUFACTURER'S REQUIREMENTS. TERMINATE ALL COAXIAL CABLE THREE (3) FEET IN EXCESS OF ENTRY PORT LOCATION UNLESS OTHERWISE STATED.
 - G. ANTENNA AND COAXIAL CABLE GROUNDING:
- 2. ALL EXTERIOR #6 GREEN GROUND WIRE "DAISY CHAIN" CONNECTIONS ARE TO BE WEATHER SEALED WITH RFS CONNECTORS/SPLICE WEATHERPROOFING KIT #221213 OR
- ALL COAXIAL CABLE GROUNDING KITS ARE TO BE INSTALLED ON STRAIGHT RUNS OF COAXIAL CABLE (NOT WITHIN BENDS).

CONCRETE AND REINFORCING STEEL NOTES:

- DESIGN AND CONSTRUCTION OF ALL CONCRETE ELEMENTS SHALL CONFORM TO THE LATEST EDITIONS OF ALL APPLICABLE CODES INCLUDING: ACI 301 "SPECIFICATIONS FOR STRUCTURAL CONCRETE FOR BUILDINGS", ACI 117 "SPECIFICATIONS FOR TOLERANCES FOR CONCRETE CONSTRUCTION AND MATERIALS", AND ACI 318 "BUILDING CODE REQUIREMENTS FOR REINFORCED CONCRETE.
- 2. MIX DESIGN SHALL BE APPROVED BY T-MOBILE REP PRIOR TO PLACING CONCRETE
- CONCRETE SHALL BE NORMAL WEIGHT, 6 % AIR ENTRAINED (+/- 1,5%) WITH A SLUMF RANGE OF 3-6" AND HAVE A MINIMUM 28-DAY COMPRESSIVE STRENGTH OF 4500 PSI UNLESS OTHERWISE NOTED.
 - THE FOLLOWING MATERIALS SHALL BE USED: ASTM C150, TYPE 2

PORTLAND CEMENT: REINFORCEMENT: ASTM A185. PLAIN STEEL WELDED WIRE FABRIC REINFORCEMENT BARS: ASTM A615, GRADE 60, DEFORMED

NORMAL WEIGHT AGGREGATE: ASTM C33 WATER: ASTM C 94/C 94M

WELDED WIRE FARRIC: ASTM A185 ADMIXTURES:

> -WATER-REDUCING AGENT: ASTM C 494/C 494M, TYPE A -AIR-ENTERING AGENT: ASTM C 260/C 260M -SUPERPLASTICIZER ASTM C494, TYPE F OR TYPE G -RETARDING: ASTM C 494/C 494M, TYPE B

- MINIMUM CONCRETE COVER FOR REINFORCING STEEL SHALL BE NO LESS THAN 3".
- A 3/4" CHAMFER SHALL BE PROVIDED AT ALL EXPOSED EDGES OF CONCRETE IN
- INSTALLATION OF CONCRETE EXPANSION/WEDGE ANCHOR SHALL BE PER MANUFACTURER'S WRITTEN RECOMMENDED PROCEDURE. THE ANCHOR BOLT, DOWEL OR ROD SHALL CONFORM TO MANUFACTURER'S RECOMMENDATION FOR EMBEDMENT DEPTH OR AS SHOWN ON THE DRAWINGS. NO REBAR SHALL BE CUT WITHOUT PRIOR APPROVAL FROM AN ATC ENGINEER WHEN DRILLING HOLES IN CONCRETE
- ADMIXTURES SHALL CONFORM TO THE APPROPRIATE ASTM STANDARD AS REFERENCED
- DO NOT WELD OR TACK WELD REINFORCING STEEL.
- ALL DOWELS, ANCHOR BOLTS, EMBEDDED STEEL, ELECTRICAL CONDUITS, PIPE SLEEVES, GROUNDS AND ALL OTHER EMBEDDED ITEMS AND FORMED DETAILS SHALL BE IN PLACE BEFORE START OF CONCRETE PLACEMENT
- REINFORCEMENT SHALL BE COLD BENT WHENEVER BENDING IS REQUIRED.
- 12. DO NOT PLACE CONCRETE IN WATER, ICE, OR ON FROZEN GROUND.
- FOR COLD-WEATHER (ACI 306) AND HOT-WEATHER (ACI 301M) CONCRETE PLACEMENT, CONFORM TO APPLICABLE ACI CODES AND RECOMMENDATIONS. IN FITHER CASE. MATERIALS CONTAINING CHLORIDE, CALCIUM, SALTS, ETC. SHALL NOT BE USED. PROTECT FRESH CONCRETE FROM WEATHER FOR 7 DAYS, MINIMUM.
- 14. ALL CONCRETE SHALL HAVE A "SMOOTH FORM FINISH.
- SPLICING OF REINFORCEMENT IS PERMITTED ONLY AT LOCATIONS SHOWN IN THE CONTRACT DRAWINGS OR AS ACCEPTED BY THE ENGINEER. UNLESS OTHERWISE SHOWN OR NOTED REINFORCING STEEL SHALL BE SPLICED TO DEVELOP ITS FULL TENSILE CAPACITY (CLASS A) IN ACCORDANCE WITH ACI 318.
- DETAILING OF REINFORCING STEEL SHALL CONFORM TO "ACLIMANUAL OF STANDARD PRACTICE FOR DETAILING REINFORCED CONCRETE STRUCTURES" (ACI 315)
- ALL SLAB CONSTRUCTION SHALL BE CAST MONOLITHICALLY WITHOUT HORIZONTAL CONSTRUCTION JOINTS, UNLESS SHOWN IN THE CONTRACT DRAWINGS
- LOCATION OF ALL CONSTRUCTION JOINTS ARE SUBJECT TO THE REQUIREMENTS OF THE CONTRACT DOCUMENTS, CONFORMANCE WITH ACI 318, AND ACCEPTANCE OF THE ENGINEER. DRAWINGS SHOWING LOCATION OF DETAILS OF THE PROPOSED CONSTRUCTION JOINTS SHALL BE SUBMITTED WITH REINFORCING STEEL PLACEMENT
- SPLICES OF WWF, AT ALL SPLICED EDGES, SHALL BE SUCH THAT THE OVERLAP MEASURED BETWEEN OUTERMOST CROSS WIRES OF EACH FABRIC SHEET IS NOT LESS THAN THE SPACING OF THE CROSS WIRE PLUS 2 INCHES, NOR LESS THAN 6".
- BAR SUPPORTS SHALL BE ALL-GALVANIZED METAL WITH PLASTIC TIPS.
- ALL REINFORCEMENT SHALL BE SECURELY TIED IN PLACE TO PREVENT DISPLACEMENT BY CONSTRUCTION TRAFFIC OR CONCRETE. TIE WIRE SHALL BE OF SUFFICIENT STRENGTH FOR INTENDED PURPOSE, BUT NOT LESS THAN NO. 18 GAUGE.
- SLAB ON GROUND: COMPACT STRUCTURAL FILL TO 95% DENSITY AND THEN PLACE 6"

ELECTRICAL NOTES:

- ELECTRICAL WORK SHALL BE PERFORMED BY ELECTRICAL CONTRACTOR. ELECTRICAL CONTRACTOR SHALL ENSURE THAT ALL WORK COMPLIES WITH ALL APPLICABLE LOCAL AND STATE CODES AND NATIONAL ELECTRICAL CODE.
- ALL SUGGESTED ELECTRICAL ELEMENTS (SUCH AS BREAKER SIZES, WIRE SIZES, CONDUITS SIZES) ARE FOR ZONING PURPOSES ONLY. IT IS THE RESPONSIBILITY TO OF THE ELECTRICAL CONTRACTOR TO CONFIRM COMPLIANCE WITH LOCAL ELECTRICAL CODES AND PASS ALL APPLICABLE AND NECESSARY INSPECTIONS. IN SOME EVENTS, IT MAY BE NECESSARY TO PERFORM AN ELECTRICAL LOAD STUDY TO VERIFY THE CAPACITY OF THE EXISTING SERVICE. THIS IS NOT THE RESPONSIBILITY OF ATC. IT IS THE RESPONSIBILITY OF THE ELECTRICAL CONTRACTOR.
- CONTRACTOR SHALL FIELD LOCATE ALL BELOW GRADE GROUNDING CABLES AND UTILITY LINES PRIOR TO CONSTRUCTION, CONTRACTOR IS RESPONSIBLE FOR RELOCATION OF ALL UTILITIES AND GROUNDING LINES THAT MAY BECOME DISTURBED OR CONFLICTING IN THE COURSE OF CONSTRUCTION.

ALL DISCREPANCIES FROM WHAT IS SHOWN ON THESE CONSTRUCTION DRAWINGS SHALL BE COMMUNICATED TO ATC ENGINEERING IMMEDIATELY FOR CORRECTION OR RE-DESIGN FAILURE TO COMMUNICATE DIRECTLY WITH ATC ENGINEERING OR ANY CHANGES FROM THE DESIGN CONDUCTED WITHOUT PRIOR APPROVAL FROM ATC ENGINEERING SHALL BE THE SOLE RESPONSIBILITY OF THE GENERAL CONTRACTOR.



PHONE: (919) 468-0112

P-1177

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REV.	DESCRIPTION	BY	DATE
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	ATC SITE NUMBER:		

414969 ATC SITE NAME

MAMERS NC

T-MOBILE SITE NAME:

ATC-414969 SITE ADDRESS 177 DEAN RD. LILLINGTON.NC 27546-7909



Digitally Signed: 2025-02-27

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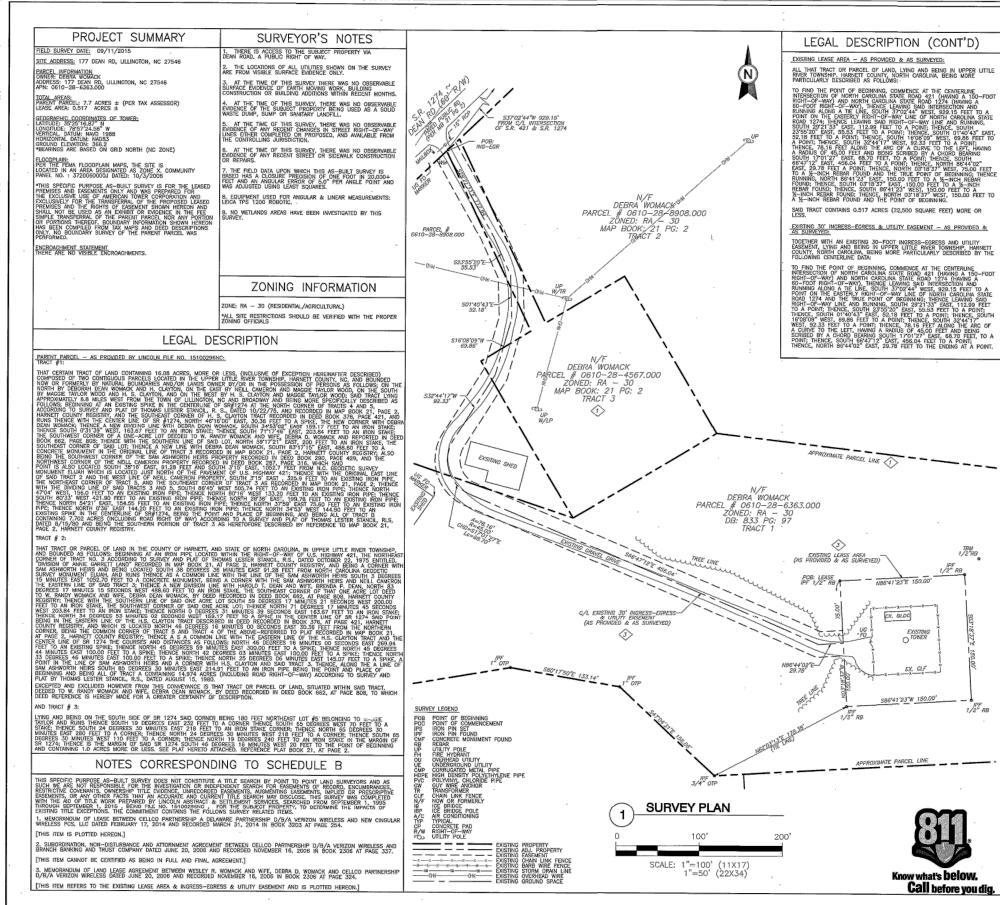
ATC PROJ. #: 15020848_D2 CUST ID: ATC-414969 CUST. #: 5RA0962A

GENERAL NOTES


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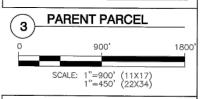
G-002


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SCALE: 1"=50' (11X17) 1"=25' (22X34)

P2P DRAWING NO: 15-D-203 P2P JOB NO: N150055

SHEET NUMBER: REVISION: V-101 0

AMERICAN TOWER ® ATC TOWER SERVICES, INC.
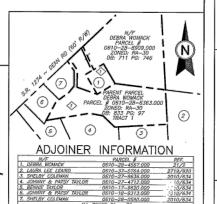
> 3500 REGENCY PARKWAY SUITE 100 CARY, NC 27518 PHONE: (919) 468-0112 FAX: (919) 466-5415

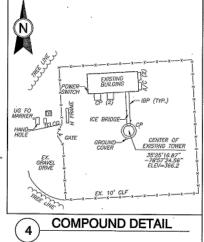REV. DESCRIPTION BY INITIAL RELEASE EAL 9/21/15

> ATC SITE NUMBER 414969

ATC SITE NAME:

MAMERS, NC

SITE ADDRESS: 179 DEAN RD, LILLINGTON, NC 27546




thur Mil CHRISTOPHER MIELKE.

NORTH CARCILINA REGISTERED LAND SURVEYOR #L-5021
POINT TO POINT LAND SURVEYORS, INC.
FIRM LICENSE NUMBER: C-4145
S31 KEISLER DRIVE, SURITE 104
CARY, NC 27518
(ORECT) 984-242-0864 (MAIN) 866-706-9114

SURVEY BY: DOINT TO POINT
LAND SURVEYORS
531 KEISLER DRIVE, SUITE 104
CARY, NC 27518
(p) (984) 242-0864
(F) (984) 242-0868
(W) pointtopointsurvey.com

DRAWN BY: EAL APPROVED BY: JKL DATE DRAWN: 09/21/2015 ATC JOB NO: 414969

*AS-BUILT SURVEY

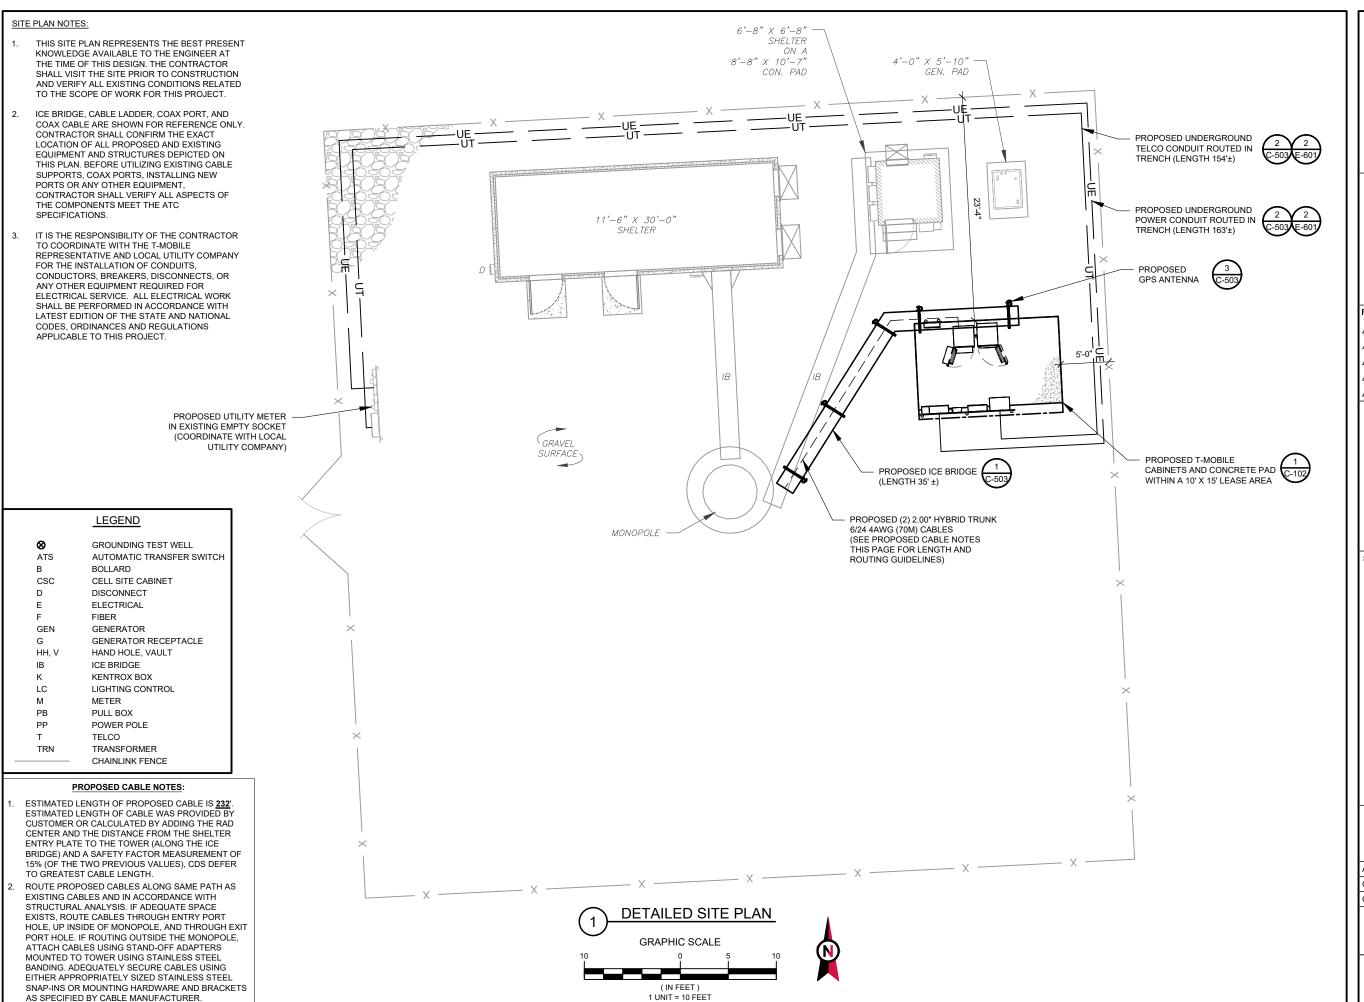



SUITE 300

CARY, NC 27511

PHONE: (919) 468-0112

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ATC-414969

SITE ADDRESS: 177 DEAN RD. LILLINGTON.NC 27546-7909

SEAL:



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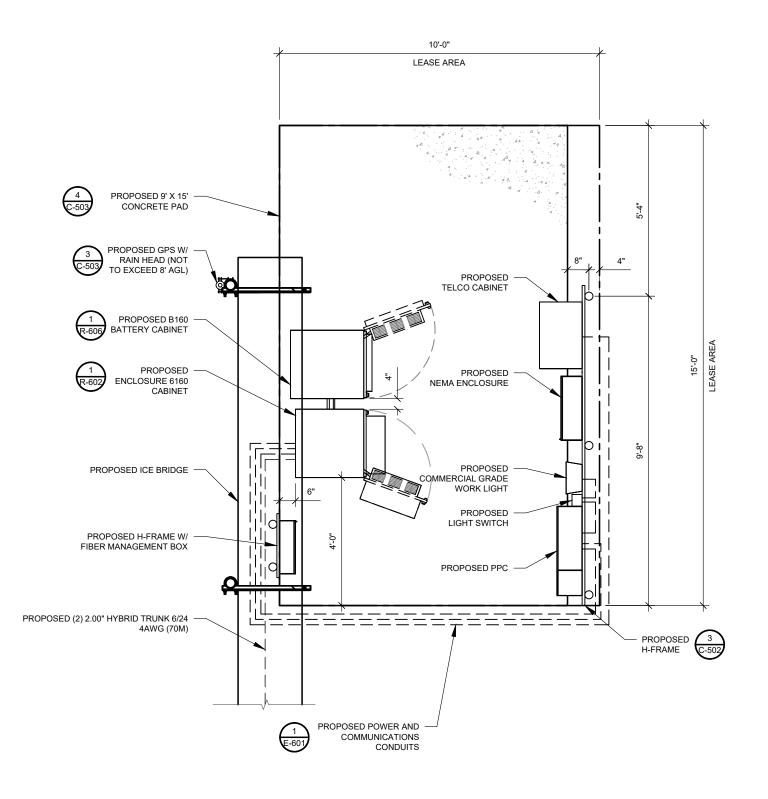
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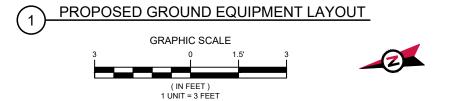
ATC PROJ. #:	15020848_D2
CUST. ID:	ATC-414969
CUST. #:	5RA0962A

DETAILED SITE PLAN

SHEET NUMBER:

C-101







1 FENTON MAIN SUITE 300 CARY, NC 27511 PHONE: (919) 468-0112

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THE LATEST VERSION.

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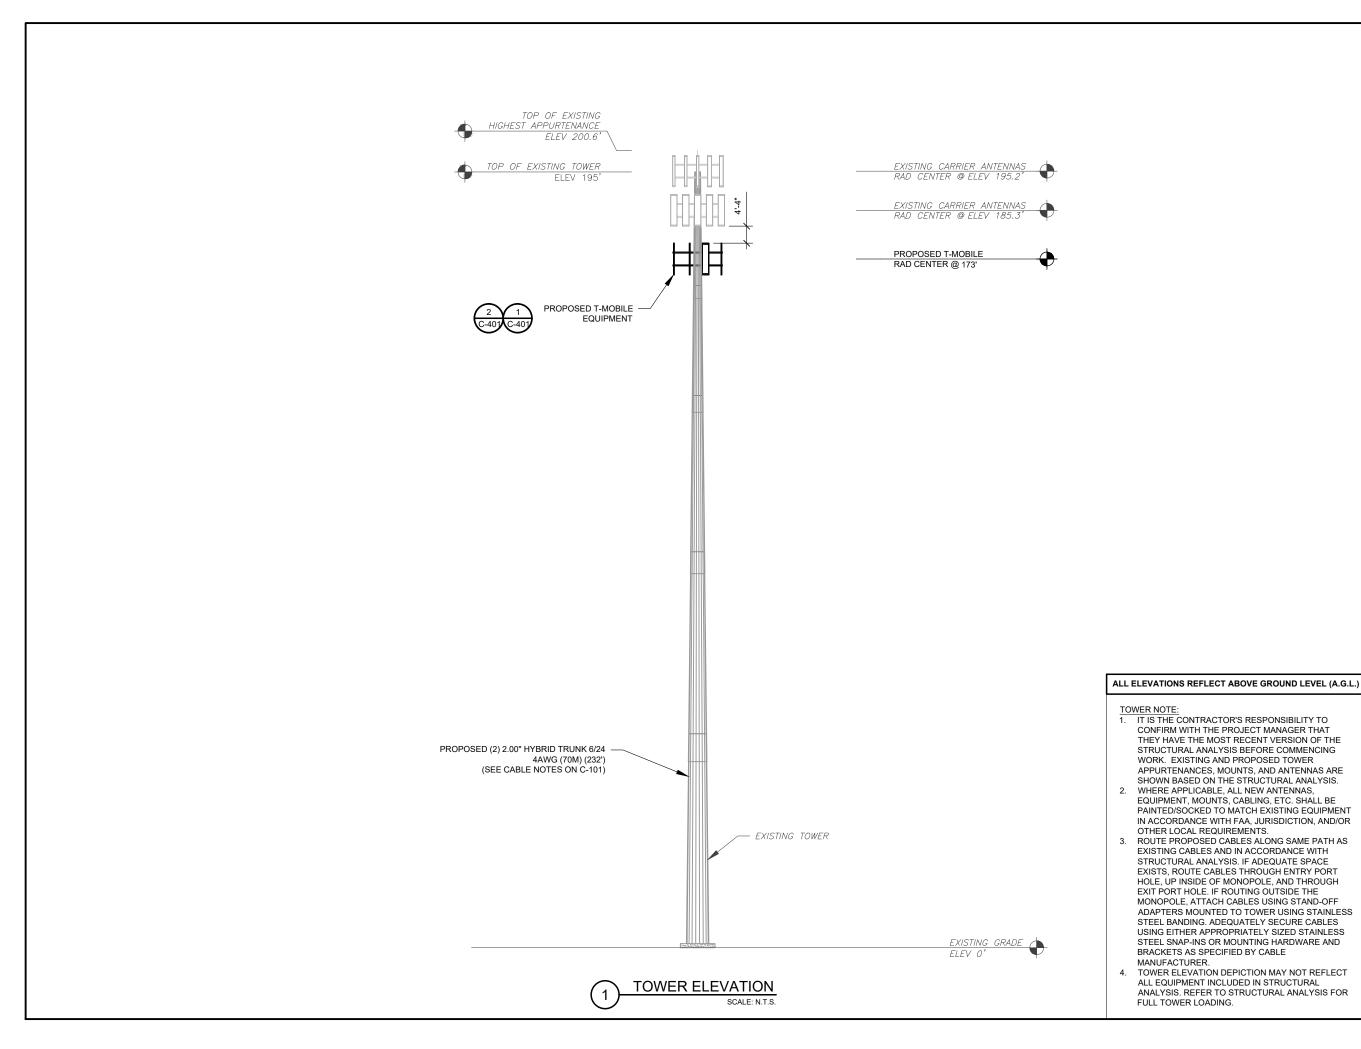
	ATC PROJ. #:	15020848_D2
	CUST. ID:	ATC-414969
	CUST. #:	5RA0962A
		-

DETAILED EQUIPMENT PLAN

SHEET NUMBER:

C-102

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1 FENTON MAIN SUITE 300 **CARY, NC 27511** PHONE: (919) 468-0112

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SITE ADDRESS: 177 DEAN RD. LILLINGTON,NC 27546-7909

THEY HAVE THE MOST RECENT VERSION OF THE

APPURTENANCES, MOUNTS, AND ANTENNAS ARE

SHOWN BASED ON THE STRUCTURAL ANALYSIS.

EQUIPMENT, MOUNTS, CABLING, ETC. SHALL BE PAINTED/SOCKED TO MATCH EXISTING EQUIPMENT IN ACCORDANCE WITH FAA, JURISDICTION, AND/OR

ROUTE PROPOSED CABLES ALONG SAME PATH AS EXISTING CABLES AND IN ACCORDANCE WITH STRUCTURAL ANALYSIS. IF ADEQUATE SPACE EXISTS, ROUTE CABLES THROUGH ENTRY PORT HOLE, UP INSIDE OF MONOPOLE, AND THROUGH EXIT PORT HOLE. IF ROUTING OUTSIDE THE MONOPOLE, ATTACH CABLES USING STAND-OFF ADAPTERS MOUNTED TO TOWER USING STAINLESS STEEL BANDING. ADEQUATELY SECURE CABLES USING EITHER APPROPRIATELY SIZED STAINLESS STEEL SNAP-INS OR MOUNTING HARDWARE AND BRACKETS AS SPECIFIED BY CABLE

TOWER ELEVATION DEPICTION MAY NOT REFLECT

ANALYSIS. REFER TO STRUCTURAL ANALYSIS FOR

ALL EQUIPMENT INCLUDED IN STRUCTURAL

STRUCTURAL ANALYSIS BEFORE COMMENCING

WORK. EXISTING AND PROPOSED TOWER

OTHER LOCAL REQUIREMENTS.

MANUFACTURER.

FULL TOWER LOADING.



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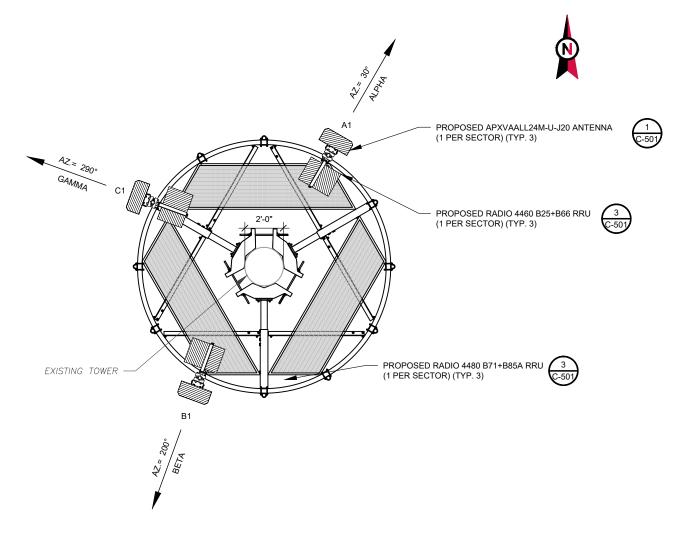
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ATC PROJ. #:	15020848_D2
CUST. ID:	ATC-414969
CUST. #:	5RA0962A

TOWER ELEVATION

SHEET NUMBER:

C-201



	FINAL ANTENNA PLAN
レン	SCALE: N.T.S.

	FINAL ANTENNA/ COAX SCHEDULE						
SECTOR	ANT.	MODEL#	RAD CENTER	AZIMUTH	ADDITIONAL TOWER MOUNTED EQUIPMENT	CABLE DESCRIPTION	
ALPHA	A1	APXVAALL24M-U-J20		30°	RADIO 4480 B71+B85 RADIO 4460 B25+B66		
BETA	B1	APXVAALL24M-U-J20	173'	200°	RADIO 4480 B71+B85 RADIO 4460 B25+B66	(2) 2.00" HYBRID TRUNK 6/24 4AWG (70M) (232')	
GAMMA	C1	APXVAALL24M-U-J20		290°	RADIO 4480 B71+B85 RADIO 4460 B25+B66		

^{1.} GC TO VERIFY THE FINAL RFDS MATCHES THE FINAL CONSTRUCTION DRAWINGS. GC TO NOTIFY ATC PM OF ANY DISCREPANCY PRIOR TO INSTALLING THE EQUIPMENT.

ANTENNA SCHEDULE

RF JUMPER LENGTH MONOPOLE = 15'± GUYED / SELF SUPPORT = FACE WIDTH + 15' REFER TO FINAL RFDS FOR TYPE AND QUANTITY

AMERICAN TOWER® A.T. ENGINEERING SERVICES, PLLC

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	CUST. ID:	ATC-414969
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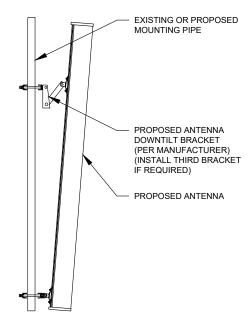
ANTENNA INFORMATION & SCHEDULE

SHEET NUMBER:

C-401


GC TO CAP ALL UNUSED PORTS.
 GC TO CONFIRM SPACING OF PROPOSED EQUIP DOES NOT CAUSE TOWER CONFLICTS NOR IMPEDE TOWER CLIMBING PEGS.

EXISTING/PROPOSED MOUNTS AND/OR MOUNT
MODIFICATIONS NOT SHOWN FOR CLARITY. REFER TO
ANTENNA PLANS, MOUNT ANALYSES AND/OR MOUNT
MODIFICATION DOCUMENTS FOR ADDITIONAL DETAIL.



1 PROPOSED ANTENNA MOUNTING DETAIL - TYPICAL

SCALE: N.T.S.

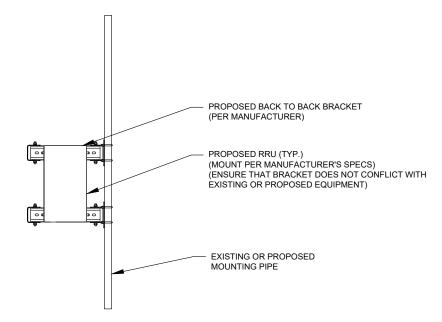

PROPOSED RRU MOUNTING DETAIL - TYPICAL

SCALE: N.T.S.



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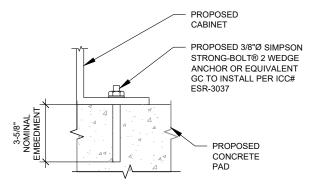
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ı	ATC PROJ. #:	15020848_D2
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ı	CUST. #:	5RA0962A

MOUNT DETAILS

SHEET NUMBER:


C-501



NOTE:

INSTALL SIMPSON STRONG-TIE® STRONG-BOLT® 2 WEDGE ANCHOR(S) STRICTLY PER INSTALLATION INSTRUCTIONS INCLUDED WITH PRODUCT OR FOUND ONLINE AT WWW.STRONGTIE.COM. PROPER INSTALLATION IS CRITICAL FOR FULL PERFORMANCE.




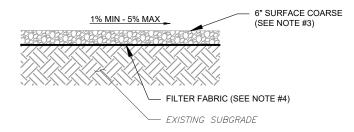

NOTES:

- CONTRACTOR TO CONTACT ALL UTILITIES FOR LOCATION OF UNDERGROUND SERVICES. SERVICE LOCATIONS TO BE CONFIRMED PRIOR TO CONSTRUCTION.
- 2. REMOVE ALL UNSUITABLE OR DELETERIOUS MATERIAL AS REQUIRED. COMPACT UNDERLYING SOIL TO 90% OF MAXIMUM DENSITY. REPLACE REMOVED SOIL WITH 8" LIFTS OF GRANULAR "B" MATERIAL TO A DEPTH OF 4" BELOW PROPOSED GRADE. COMPACT TO MINIMUM 95% OF MAXIMUM DRY DENSITY ALL COMPACTION SHALL BE IN ACCORDANCE WITH THE MOST RECENT IBC. REVIEW WITH PROJECT MANAGER AND GEOTECT PRIOR TO CONSTRUCTION.
- SURFACE COARSE OF GRANULAR "A" MATERIAL SHALL CONSIST OF EVENLY GRADED MIXTURE OF CRUSHED STONE OR GRAVEL, WITH 100% PASSING THROUGH 3/4" SIEVE AND NOT MORE THAN 5% PASSING THROUGH #4 SIEVE.
- 4. PROVIDE GEOTEXTILE FABRIC UNDER WASHED CHIPPED STONE COMPOUND UNLESS NOTED OTHERWISE. WOVEN GEOTEXTILE:US FABRICS: US 230 OR APPROVED EQUIVALENT. CONTRACTOR MAY SUBMIT DESIGN ALTERNATIVE AS OUTLINED IN THE AMERICAN TOWER MASTER SPECIFICATIONS.



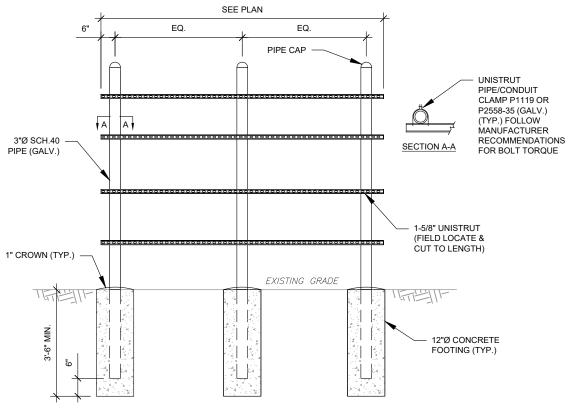

H-FRAME NOTES:

- 1. IF IT IS NECESSARY TO EXTEND THE H-FRAME, AN ADDITIONAL POST WILL ALWAYS BE REQUIRED.
- . PROPOSED UNISTRUTS TO BE FIELD CUT AND SHOULD NOT EXTEND MORE THAN 6 INCHES BEYOND THE LAST POST.
- 3. SPRAY ENDS OF UNISTRUT WITH COLD GALVANIZING SPRAY PAINT, ALLOW TO DRY, THEN COVER WITH RUBBER PROTECTIVE CAPS FOR SAFETY.
- 4. UNISTRUT TO BE CUT FLUSH WITH NO SHARP OR JAGGED EDGES.
- 5. ALL PROPOSED HARDWARE TO BE MOUNTED PER MANUFACTURERS SPECS.





A.T. ENGINEERING SERVICES, PLLC

1 FENTON MAIN
SUITE 300
CARY, NC 27511
PHONE: (919) 468-0112

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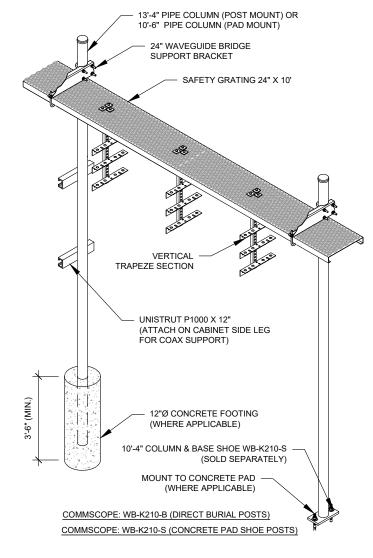
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CUST. #:	5RA0962A		
CUST. ID:	ATC-414969		
ATC PROJ. #:	15020848_D2		

CONSTRUCTION DETAILS

SHEET NUMBER:


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CONSTRUCTION NOTE:


- INSTALL ICE BRIDGE TO ALLOW 7 FEET CLEARANCE ABOVE GRADE TO LOWEST APPLIETENANCE
- 2. INSTALL PER MANUFACTURES SPECIFICATION.






- IF FREE OF ORGANIC OR OTHER DELETERIOUS MATERIAL, EXCAVATED MATERIAL MAY BE USED FOR BACKFILL.
- IF NOT, PROVIDE CLEAN, COMPACTIBLE MATERIAL. COMPACT IN 8" LIFTS. REMOVE ANY LARGE ROCKS PRIOR TO BACKFILLING. CONTRACTOR TO VERIFY LOCATION OF EXISTING U/G UTILITIES PRIOR TO DIGGING.
- IF CURRENT AS-BUILT DRAWINGS ARE NOT AVAILABLE CONTRACTOR SHALL HAND DIG U/G TRENCHING.
- 4. CONCRETE ENCASE CONDUIT WHEN TRENCHING UNDER SITE ACCESS ROAD.

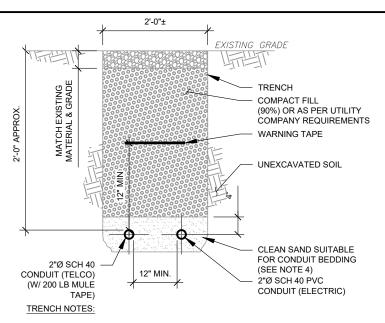2 TELCO AND POWER CONDUIT JOINT TRENCH SCALE: N.T.S.

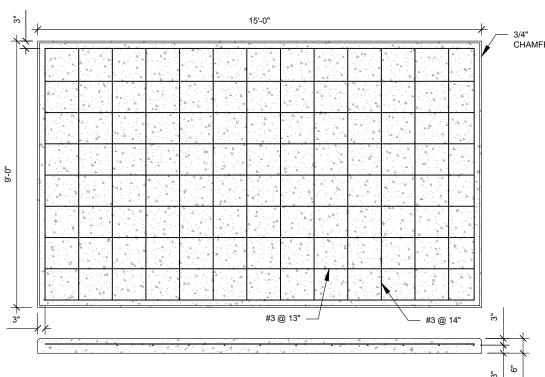

PAD NOTES:

- 1. PADS SHALL BE PRE-CAST MATCHING THIS DESIGN WHERE ALLOWED BY LOCAL JURISDICTION.
- 2. REFER TO CONCRETE & REINFORCED STEEL NOTES ON SHEET G-002 & ATC SPEC 033000 FOR CAST-IN-PLACE PADS.

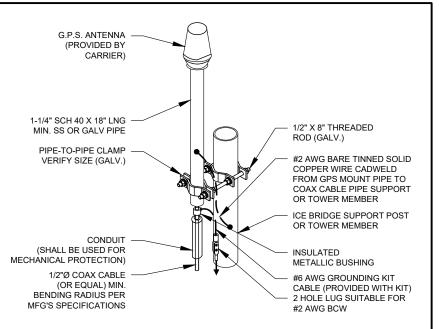

NOTE

GPS SHALL BE PLACED WITH CLEAR SIGHT LINE TO THE SOUTHERN SKY.
 CONTRACTOR TO SUPPLY COAX FOR GPS UNIT.

GPS ANTENNA ATTACHMENT DETAIL

SCALE: N.T.S.

6" EXISTING CRUSHED

STONE OR GRAVEL

(SEE NOTE 2)

3/4"
CHAMFER

FINISHED
GRADE

PROPOSED PAD

PAD NOTES:

COMPACTED FILL

EXISTING

- SUBGRADE AND FILL SHALL CONSIST OF CLEAN SOIL.
 DELETRIOUS MATERIAL AND ORGANICS SHALL BE
 REMOVED.
- MECHANICALLY COMPACT FOOTPRINT OF PAD PLUS 2' PERIMETER.
- USE GALVANIZED HILTI EXPANSION ANCHORS OR, APPROVED EQUAL, FOR EQUIPMENT ANCHORAGE.
- FOR SIZE AND LOCATION OF ANCHORS AND OTHER REQUIREMENT, SEE EQUIPMENT VENDOR DRAWINGS.

GRAVEL PREPARATION
SCALE: N.T.S



1 FENTON MAIN SUITE 300 CARY, NC 27511 PHONE: (919) 468-0112 P-1177

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CONSTRUCTION		
CUST. #:	5RA0962A	
CUST. ID:	ATC-414969	
ATC PROJ. #:	15020848_D2	

DETAILS

SHEET NUMBER:

C-503

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GROUNDING NOTES:

ALL EQUIPMENT ENCLOSURES, DEVICES AND CONDUITS SHALL BE GROUNDED TO CONFORM WITH THE LATEST REQUIREMENTS OF THE NEC BY THE INSTALLATION OF A SEPARATE, GREEN, INSULATED GROUND CONDUCTOR FOR ALL FEEDER AND BRANCH CIRCUITS. GROUND CONDUCTORS SHALL BE OF THE SIZE INDICATED ON THE DRAWINGS. GROUND CONDUCTORS SHALL BE CONTINUOUS IN LENGTH AND SHALL BE BONDED TO EACH ENCLOSURE THEY PASS THROUGH. CONDUIT SHALL NOT BE USED AS A GROUNDING CONDUCTOR.

GROUNDING CONDUCTORS SHALL:


- A. BE #2 AWG SOLID BARE TINNED COPPER (SBTC) FOR ALL GROUNDING SYSTEM WIRE UNLESS OTHERWISE NOTED, OR OTHERWISE REQUIRED BY
- B. BE MINIMUM 12" BEND RADIUS. KEEP NUMBER OF BENDS TO A MINIMUM.
- C. AVOID LONG BONDING CONNECTION RUNS. MAKE DIRECT AS POSSIBLE.
- D. NOT HAVE ANY U-SHAPED RUNS.
- BE IN NON-METALLIC CONDUIT ONLY, IF IN CONDUIT.
- BE PLACED THROUGH NON-METALLIC SLEEVES IN FLOORS, WALLS, CEILINGS,
- G. PROTECTED IN NON-METALLIC CONDUIT WHERE EXPOSED ABOVE GRADE
- INSTALL ALL GROUNDING RINGS AND RADIALS WITH CONDUCTIVE CEMENT, SANKOSHA AS DISTRIBUTED BY ELECTRIC MOTION COMPANY, INC., WINSTED, CT 06098, OR AS SPECIFICALLY INDICATED. INSTALL PER MANUFACTURER'S SPECIFICATIONS.

GROUND RINGS SHALL BE:

- A. MINIMUM 30" BELOW GRADE, OR BELOW FROST LINE WHICHEVER IS
- B. MINIMUM 2' FROM FOUNDATIONS, FOOTINGS, OTHER GROUNDING SYSTEMS AND ALL CONDUCTIVE OBJECTS.
- C. WITH MINIMUM 12" BEND RADII.
- WITH ALL CONNECTIONS IN CONTACT WITH EARTH, BONDED BY EXOTHERMIC WELDING.
- E. BONDED TO A SINGLE POINT GROUND (SPG) WITH A SINGLE WIRE AS INDICATED ON DRAWINGS.

GROUND RODS SHALL BE:

- A. MINIMUM 5/8" DIAMETER.
- MINIMUM 10' LONG.
- COPPER-CLAD GALVANIZED STEEL OR STAINLESS STEEL.
- D. PLACED IN UNDISTURBED SOIL AND BELOW THE FROST LINE
- E. INSTALLED WITH MINIMUM SEPARATION DISTANCE OF TWICE THE DEPTH OF THE ROD(S), OR AS INDICATED ON DRAWINGS.
- F. MINIMUM TWO (2) RODS ON THE TOWER RING OR ONE (1) PER LEG WHICHEVER IS LARGER, MINIMUM FOUR (4) RODS ON EVERY EQUIPMENT BUILDING RING WITH ONE AT EACH CORNER OR AS INDICATED, MINIMUM ONE (1) ROD FOR POWER SERVICE GROUNDING ELECTRODE, AND MINIMUM ONE (1) ROD AT END OF EACH
- CONDUCTIVE OBJECTS, SUCH AS FENCES, SHALL BE BONDED TO THE GROUNDING SYSTEM IF WITHIN 20' OF THE TOWER GROUNDING SYSTEM, OR 5' OF ANY OTHER GROUNDED COMPONENT.

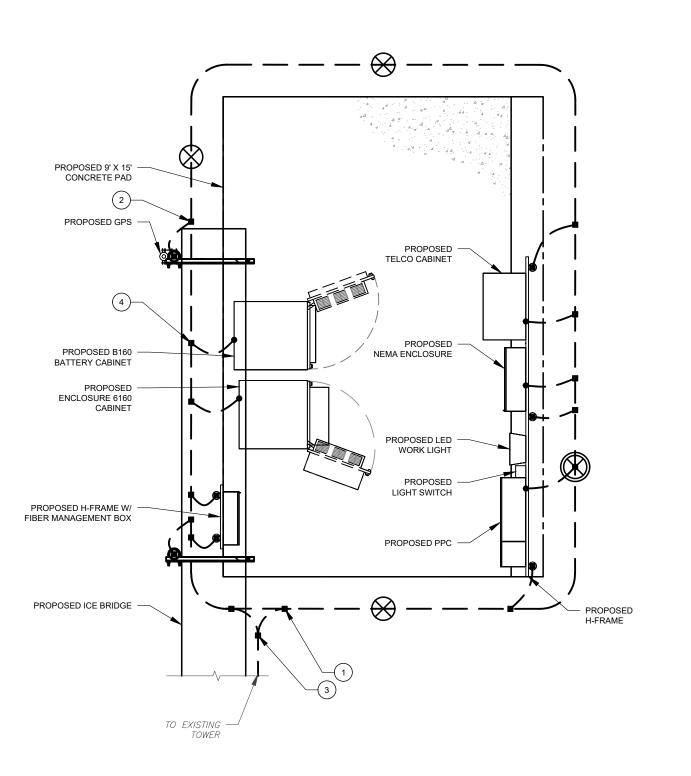

DETAILED GROUNDING PLAN

GROUNDING PLAN LEGEND:

--- EXISTING GROUND WIRE GROUND WIRE

EXOTHERMIC WELD

MECHANICAL WELD




5/8"Ø X 10' COPPER **GROUND ROD**



TEST WELL

GROUNDING KEYED NOTES:

- BOND TO TOWER GROUND RING
- #2 AWG BOND FROM VERTICAL H-FRAME AND ICE BRIDGE POST TO EXTERNAL GROUND RING (TYP. EVERY POST).
- #2 AWG SBTC BOND FROM TOWER GROUND RING TO
- EQUIPMENT BOND TO GROUND RING (TYP.)

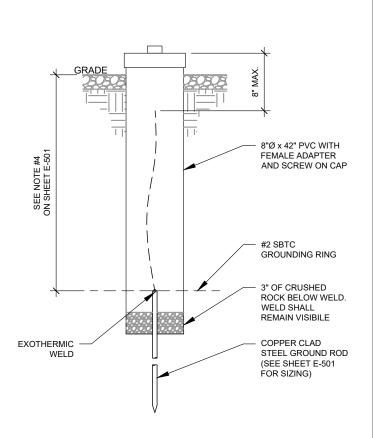

TEST WELL DETAIL



P-1177

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REV.	DESCRIPTION	BY	DATE
<u> </u>	FOR CONSTRUCTION	KPF	02/27/25
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		_	
	ATC SITE NUMBER:		

414969 ATC SITE NAME:

MAMERS NC

T-MOBILE SITE NAME

ATC-414969

SITE ADDRESS: 177 DEAN RD. LILLINGTON,NC 27546-7909



Digitally Signed: 2025-02-27


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ı	CUST. #:	5RA0962A	
ı	CUST. ID:	ATC-414969	
ı	ATC PROJ. #:	15020848_D2	

GROUNDING PLAN AND NOTES


SHEET NUMBER:

E-101

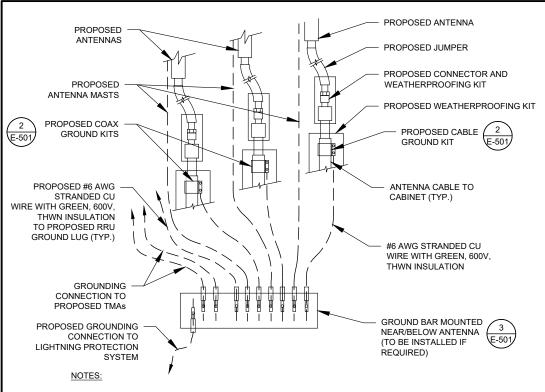

- THIS DETAIL IS INTENDED TO SHOW THE GENERAL GROUNDING REQUIREMENTS. SLIGHT ADJUSTMENTS MAY BE REQUIRED BASED ON EXISTING SITE CONDITIONS. THE CONTRACTOR SHALL MAKE FIELD ADJUSTMENTS AS NEEDED AND INFORM THE CONSTRUCTION MANAGER OF ANY CONFLICTS.
- SITE GROUNDING SHALL COMPLY WITH T-MOBILE GROUNDING STANDARDS, LATEST EDITION, AND COMPLY WITH T-MOBILE GROUNDING CHECKLIST, LATEST VERSION. WHEN NATIONAL AND LOCAL GROUNDING CODES ARE MORE STRINGENT THEY SHALL GOVERN.



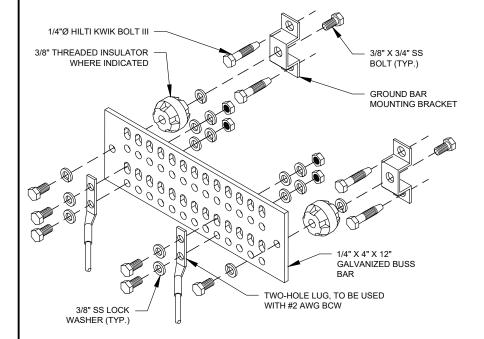

GROUND BAR NOTES


GROUND KITS COME WITH ALL HARDWARE, NUTS, BOLTS, WASHERS, ETC. EXCEPT THE STRUCTURAL MOUNTING MEMBER(S)

MAIN GROUND BAR DETAIL

2. GROUND BAR SHALL BE BOLTED TO STRUCTURAL MEMBER OR ANCHORED TO CONCRETE SLAB W/ HILTI KWIK BOLT III.




GROUND ROD DETAIL

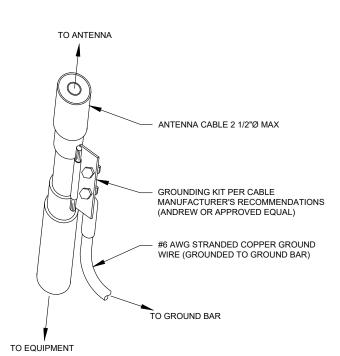

- <u>GROUND KIT NOTES:</u>

 1. DO NOT INSTALL CABLE GROUND KIT AT A BEND AND ALWAYS DIRECT GROUND WIRE DOWN TO GROUND BAR.
- 2. CONTRACTOR SHALL PROVIDE WEATHERPROOFING KIT (ANDREW PART NUMBER 221213) AND INSTALL/TAPE PER MANUFACTURER'S SPECIFICATIONS

CABLE GROUND KIT CONNECTION DETAIL

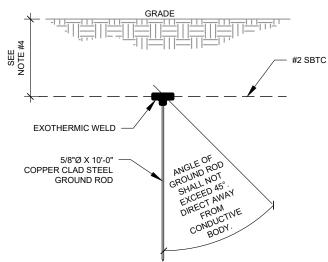


- SEPARATION DIMENSION TO BE VERIFIED WITH LOCAL UTILITY COMPANY
- 2. COORDINATE UTILITY, LOCATE BEFORE DIGGING.
- CONDUIT TRENCHING DEPTHS AT 36" OR 6" BELOW FROST LINE, WHICHEVER IS GREATER.
- ALL RING AND RADIAL DEPTHS AT 30" OR 6" BELOW FROST LINE, WHICHEVER IS GREATER.

3/8" X 1-1/4" SS BOLT 3/8" SS LOCK WASHER (EACH SIDE) (EACH SIDE) 1/4" X 4" X 6" GROUND BAR (ERICO P/N: EGBA14406CC OR EQUAL) TWO-HOLE LUG, TO BE USED WITH #2 AWG BCW (LOWER TOWER GROUND BAR ONLY)

GROUND BAR NOTES:

- GROUND BAR KITS COME WITH ALL HARDWARE, NUTS, BOLTS, WASHERS, ETC. EXCEPT THE STRUCTURAL MOUNTING MEMBER(S).
- 2. GROUND BAR TO BE BONDED DIRECTLY TO TOWER

TOWER GROUND BAR DETAIL

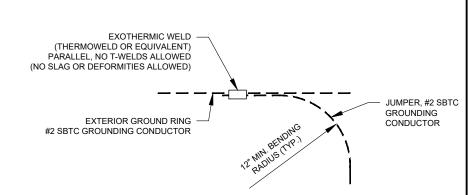

AMERICAN TOWER® A.T. ENGINEERING SERVICES, PLLC 1 FENTON MAIN SUITE 300

CARY, NC 27511

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P-1177

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Digitally Signed: 2025-02-27

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ATC PROJ. #:	15020848_D2
CUST. ID:	ATC-414969
CUST. #:	5RA0962A

GROUNDING DETAILS

SHEET NUMBER

E-501

REVISION

TIE CONNECTION DETAIL

SCALE: N.T.S

NEL		TYPE:		LIGHTING					SYSTEM			120/2		ð, 3W, 24	CKT		LOCATION:	TMO LEASE EQU	PMENT AF	REA
SIGNATION: _	TMO	MOUNTING:		s	URFACE			MAIN F		IN BREAKER (MB):		200A			_					
		ENCLOSURE	E:	N	IEMA 3R				MAIN B	JS RATII	NG:		22	25A			PANEL NOTES:	PROPO	SED	
									MIN. A.I	.C. RATII	NG:		N	I/A			_			
ONNECTED			FE	EDER OF	R BRANC	CH CIRC	JIT				FE	EDER C	OR BRAI	NCH CIRC	CUIT				CONN	ECTED
OAD (kVA)	BRIEF DESCRIPTION	В	REAKER		CIRCUIT		POLE CIRC. CIRC.	POLE	CIRCUIT BREA		KER BRIEF DESCRIPTION		DESCRIPTION	LOAD (kVA)						
а в		AM	PS POLES	WIRE	GND	COND.	NO.	NOTES		NOTES	NO.	COND.	GND	WIRE	POLES	AMPS			А	В
01	SURGE	60	0 2	3-#6	#10	1"	1				2	1/2"	#12	2-#12	1	20		GFI	0.18	
0.01	SURGE	6	0 2	3-#6	#10	'	3				4	1/2"	#12	2-#12	1	20		LIGHT		0.50
50	ENCLOSURE 6160	15	50 2	2-#3/0	#6	2"	5				6	1/2"	#12	2-#12	1	20	Α	AAV GFI	0.15	
7.50	ENCLOSORE 0100	10	50 2	2-#3/0	#0	4	7				8									0.00
00							9				10								0.00	
0.00							11				12									0.00
00							13				14								0.00	
0.00							15				16									0.00
00							17				18								0.00	
0.00							19				20									0.00
00							21				22								0.00	
0.00							23				24									0.00
5 7.5								Α	В	тот									0.3	0.5
								7.8	8.0	15				OAD (kV	۹)					
								7.8	8.0	15	.9	DEMAN	D LOAD	(kVA)			DE	RATING FACTOR (809	5)	

1 PANEL SCHEDULE

PROPOSED 200A, 240V, 3W, 2P	<u> </u>
UTILITY METER IN EXISTING METER SOCKET	
(MEET LOCAL UTILITY SPECS.)	
PROPOSED 200/2 SERVICE MAIN BREAKER SUITABLE AND LISTED FOR THE APPLICATION	200/2
3-#3/0 AWG CU, 1-#6 AWG CU G 2"C	VERIFY EXISTING GROUND PER NEC
PROPOSED 200A, 120/240V, 3W, 2P PPC (SEE PANEL SCHEDULE)	200/2 PROPOSED GENERATOR PLUG
PROPOSED INTEGRATED	
MANUAL TRANSFER SWITCH	SEE PANEL SCHEDULE FOR PROPOSED CIRCUITS
	PRIMARY CABINET
	2" CONDUIT, FOR CAT6
	GROUND PER NEC 2#12, 1 #12G IN 1" CONDUIT FROM TELCO/FIBER
	CABINET PRIMARY CABINET
	2" CONDUIT, FOR FIBER SERVICE
	FOR FIDER SERVICE

ONE-LINE DIAGRAM

	STANDARD CONDUIT USE TABLE								
CONDUIT TYPE	USE CASE	LOCATION	USE CASE EXAMPLE						
RMC (METALLIC)	AC, DC COMM	ABOVE GROUND	ABOVE GROUND PPC TO SSC						
PVC	AC POWER	UNDERGROUND	UNDERGROUND PPC TO SSC OR BACKHAUL TRANSPORT HUB TO SSC						
LFMC	C AC, DC, COMM MAX 6' PER CONDUIT RUN, ABOVE GROUND ONLY		TIGHT LOCATIONS BETWEEN HUB AND CONDUIT BUT NOT TO BE USED WHERE IT CAN BE STEPPED ON						
EMT	EMT INDOOR AC, DC INDOOR NOT EXPOSED TO THE OUTDOOR COMM ENVIRONMENT (MUST BE DRY)		CIRCUIT PANEL TO JUNCTION BOX						
LFNC	GROUND WIRE	CONCEALING AND PROTECTING BTCW RISERS ONLY	GROUND RING TO MGB OR SSC						

	EXCEPTION CONDUIT USE TABLE									
CONDUIT TYPE	USE CASE	LOCATION	USE CASE EXAMPLE							
EMT (NOT PREFERRED)	OUTDOOR DC, COMM	OUTDOOR WHEN USED WITH WATERTIGHT HUBS ONLY	BETWEEN EQUIPMENT AND BATTERY CABINET OR EQUIPMENT TO EQUIPMENT CABINETS FOR INTER CABINET CONNECTION							
RMC NONMETALLIC (ALUMINUM)	OUTDOOR/INDOOR PER NEC GUIDLINES	ABOVE GROUND	MAT BE USED AS A LOWER COST ALTERNATIVE TO METALLIC RMC, MUST MEET OR EXCEED FEDERAL SPEC: WW-C-540C, UL-6A, ANSI C80.5, NEC 344.10 (A) ALLOWS THE USE OF EITHER ALUMINUM OR GALVANIZED FITTINGS							

(3)

CONDUIT USE TABLES

NOTE

- ALL EQUIPMENTS' SHORT-CIRCUIT CURRENT RATING SHALL EXCEED AVAILABLE FAULT CURRENT PER UTILITY
- CURRENT PER UTILITY
 2. CONTRACTOR TO INSTALL HANDHOLES AT EVERY 3RD 90° TURN

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CUST. #:	5RA0962A

PANEL SCHEDULE & ONE-LINE DIAGRAM

SHEET NUMBER:

E-601

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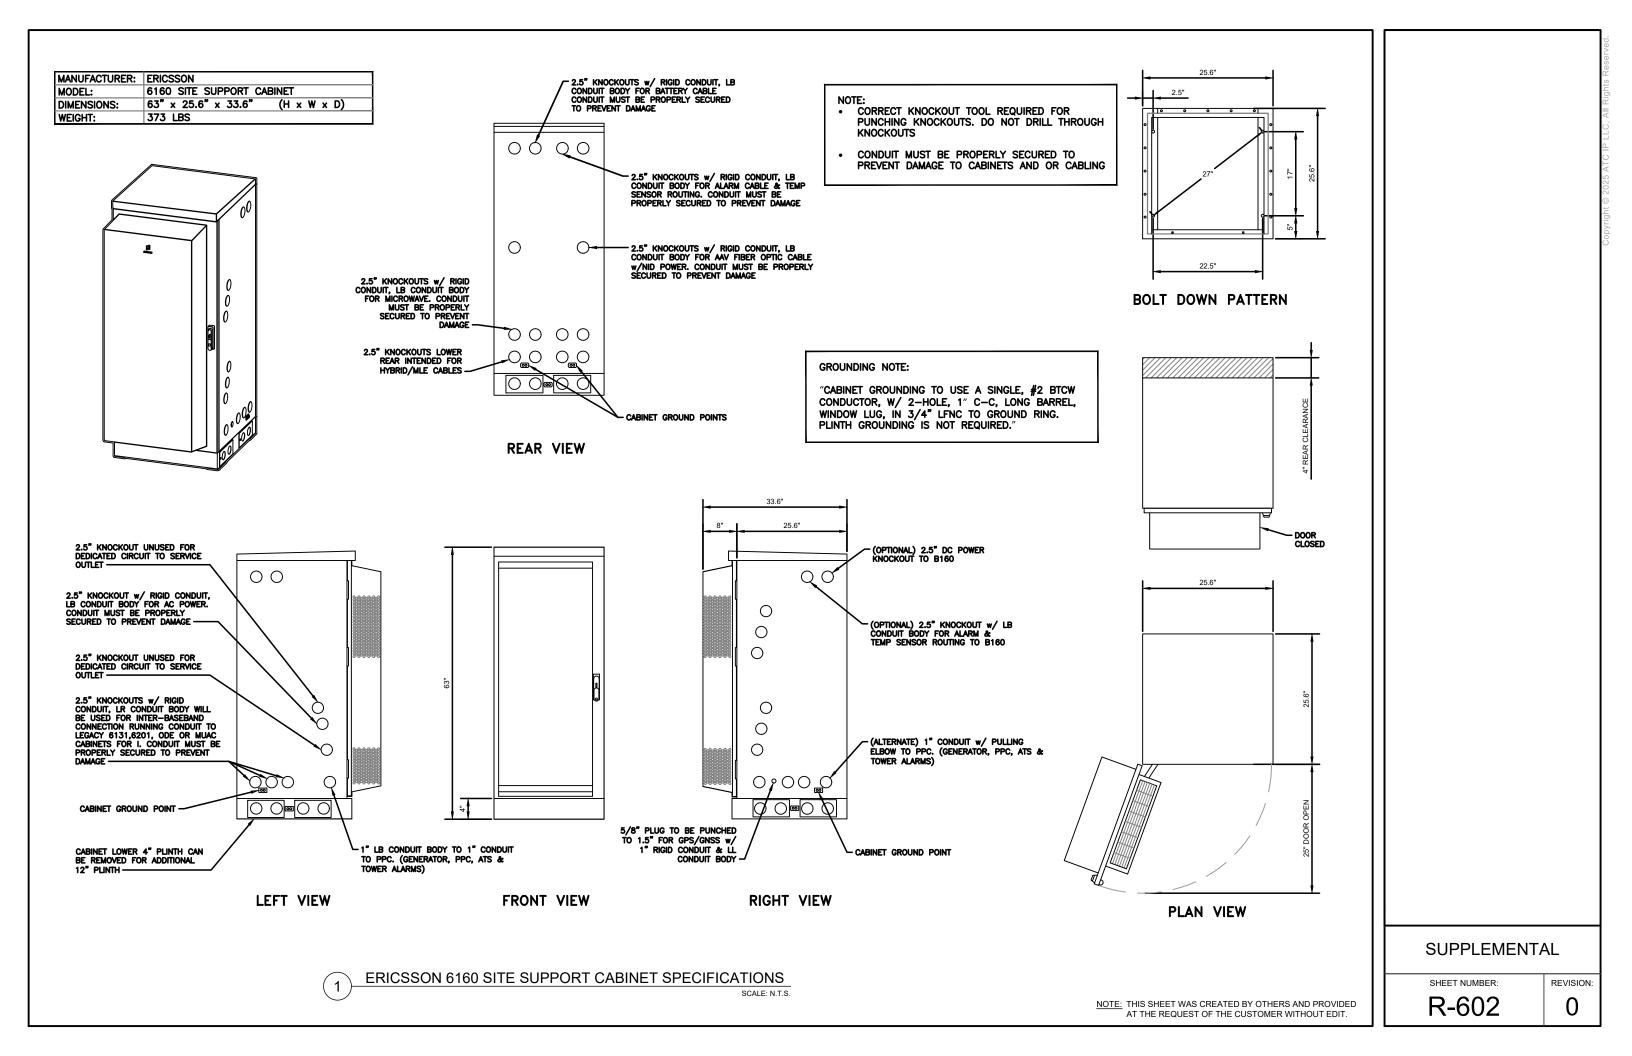
	Proposed RAN Equipment							
	Proposed RAN Equip	ment						
	Template: 67E998E 6160	(LRP)						
Enclosure	1	2						
Enclosure Type	(B160)	Enclosure 6160_v2 AC						
Transport System		(CSR IXRe V2 (Gen2)						
Hybrid Cable System		Hybrid Trunk 6/24 4AWG 70m (x2)						
Baseband		RP 6672 N600 N1900 N2100 L600 L1900 L2100						
RAN Scope of Work	C:							
Install: (2) HCS 6/2/	4 4AWG 70m, (1) RP6672, (1) E6160, (1) B160, (1) IXR-e							


CABINET CONFIGURATION

SUPPLEMENTAL

SHEET NUMBER:


R-601



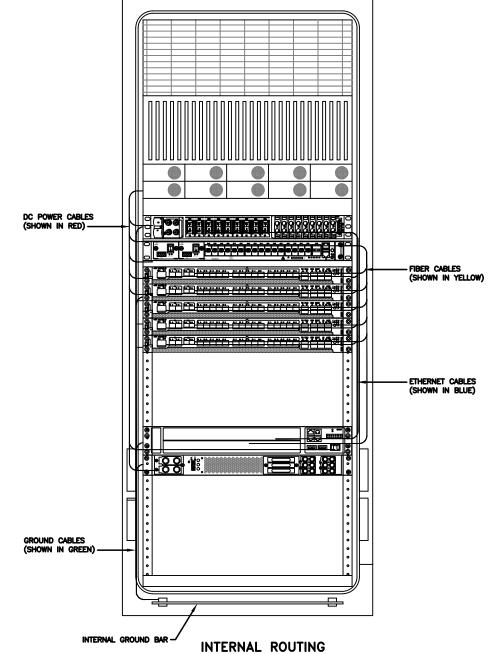

(DOOR OPEN)

R/	ACK ASSIGNMENTS					
RU SLOTS	DESCRIPTION					
1						
2	DC DISTRIBUTION					
3	DO DIOTRIBOTION					
4						
5	DECTIFIED SUFIE					
6	RECTIFIER SHELF					
7	FIBER BOX					
8	DCDU					
9	BACKHAUL ROUTER					
10	BACKHAUL ROUTER					
11	1ST BASEBAND					
12	2ND BASEBAND					
13	3RD BASEBAND					
14	4TH BASEBAND					
15	5TH BASEBAND					
16						
17	EXPANSION					
18	EM ANOION					
19						
20	EXPANSION / LEGACY					
21	BASEBAND / VOLTAGE BOOSTER					
22	VOLTAGE BOOSTER					
23						
24	OPEN SPACE FOR SPD ACCESS					
25	,,,,,,,,,,,,,,,,,,,,,,,,,,,,,,,,,,,,,,,					

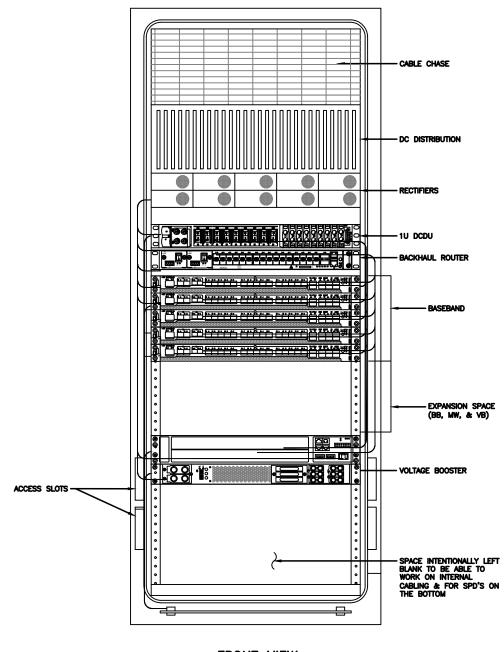

FRONT VIEW (DOOR OPEN)

SUPPLEMENTAL

REVISION:


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SHEET NUMBER:

R-603

NOTE:
THIS IS FOR REFERENCE ONLY, CHECK
FOR SPECIFIC DETAIL IN T-MOBILE
CABINET SPECIFIC INSTALLATION GUIDES

			Breaker A	llocation for E6160				
3 SLOT	Ckt #		w/ DCDU Prior to availability of the 4460 and 4480	w/ DCDU Later Design Post- 4460 and Post-4480	w/ DCDU 4 and 6 Sector designs			
1		1	Router	Radio 4460 B25/66 ζ-1				
2		2	F	Future				
3	LVD1 47.0V	3	PSU 4813 feeding B25	i/66 α, β and γ (AIR 1641s)	PSU 4813 feeding B41-δ & B71/12-δ			
4	47.00	4			(Air 6449s and Radio 4480s)			
5		5	DC.II	J 4813 feeding B41 α, β and γ (Air 6	140-)			
6		6	PSU	149s)				
7		1	PSU 4813 feeding B71/12	DCI 1012 for all to a D71 (12 or	0 d (D d) - 4400-)			
8	LVD2	2	α, β and γ (Radio 4449s)	PSU 4813 feeding B71/12 α	: α, μ and γ (καυτο 4460S)			
9		3	F	uture	Radio 4460 B25/66 δ-1			
10	45.1V	4	F	Radio 4460 B25/66 δ-2				
11		5	F	Radio 4460 B25/66 ε-1				
12		6	F	uture	Radio 4460 B25/66 ε-2			
13		1		Router PS-1				
14		2	Radio 4415 B25/66 α	Radio 4460 B	25/66 α-1			
15		3	Radio 4415 B25/66 β	Radio 4460 B	25/66 α-2			
16		4	Radio 4415 B25/66 γ	Radio 4460 B25/66 β-1				
17	BLVD 43.2V	5	PSU 4813 feeding B2/25	Radio 4460 B	25/66 β-2			
18	-J.2V	6	α, β and γ (Radio 4424s)	Radio 4460 B	25/66 γ-1			
19		7	Future	Radio 4460 B25/66 γ-2				
20		8		DCDU				
21		9		AAV				
			ar Alaha 0	Sector Identification				

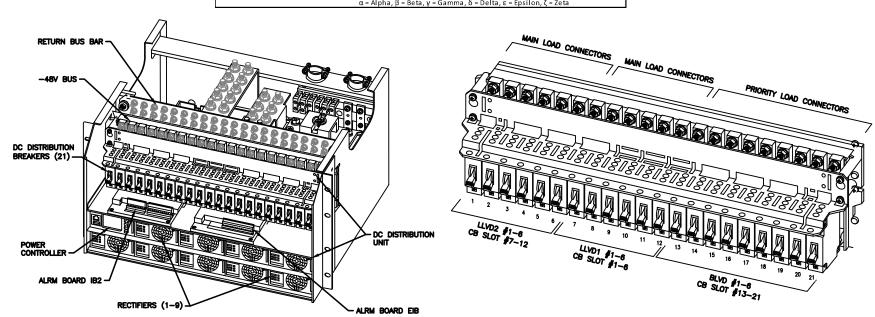

POWER SUBRACK

DC DISTRIBUTION

ERICSSON 6160 ELECTRICAL DETAILS

SCALE: N.T.S.

NOTE: THIS SHEET WAS CREATED BY OTHERS AND PROVIDED AT THE REQUEST OF THE CUSTOMER WITHOUT EDIT.


SUPPLEMENTAL

SHEET NUMBER:


REVISION: R-604

NOTE:

- 1. ALL CONDUIT AND FITTING ENTRANCES INTO CABINETS AND ENCLOSURES MUST UTILIZE MYERS OR EQUIVALENT HUBS OR SEALING WASHERS TO PREVENT WATER ENTRY/SEEPAGE INTO CABINETS AND ENCLOSURES.
- 2. (LIQUIDFLEX) FLEXIBLE METALLIC CONDUIT (LFMC) & ASSOCIATED FÎTTINGS CAN BE USED AS NEEDED BUT ONLY FOR TIGHT CONDUIT BENDS AND RUNS SUBJECT TO UL AND NEC LIMITATIONS. 6' MAX PER
- 3. POWER CONDUIT BODY ATTACHED WITH SHORT NIPPLE AND SEALING WASHER INSIDE & OUT. (FOR DOOR HOOD CLEARANCE)
- 4. PULLING ELBOWS MAY BE USED IN LIEU OF A CONDUIT BODIES WHEN CLEARANCE IS LIMITED.
- 5. ALL EXTERNAL ALARM CONDUITS ARE TOO TERMINATE AT THE PPC WITH A SINGLE 1" ALARM CONDUIT TO THE 6160.
- 6. (DO NOT USE CHASE NIPPLES) CONDUIT SHOULD HAVE SEALING WASHERS INSIDE AND OUT W/ LOCK NUT AND CAP.

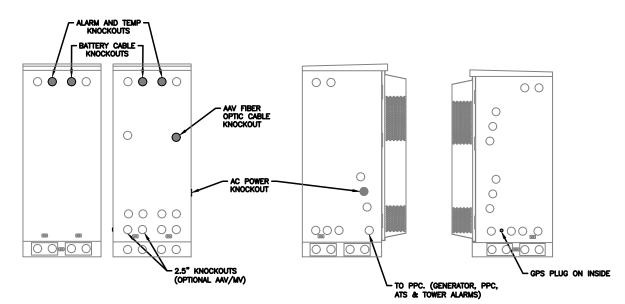

CONDUIT LOCATIONS

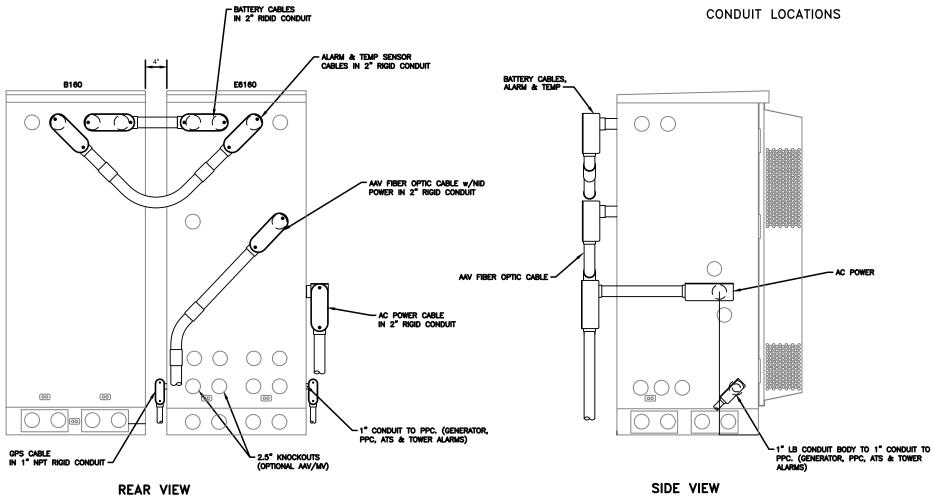


SUPPLEMENTAL

SHEET NUMBER:

R-605

ERICSSON 6160/B160 CONDUIT ROUTING DETAILS

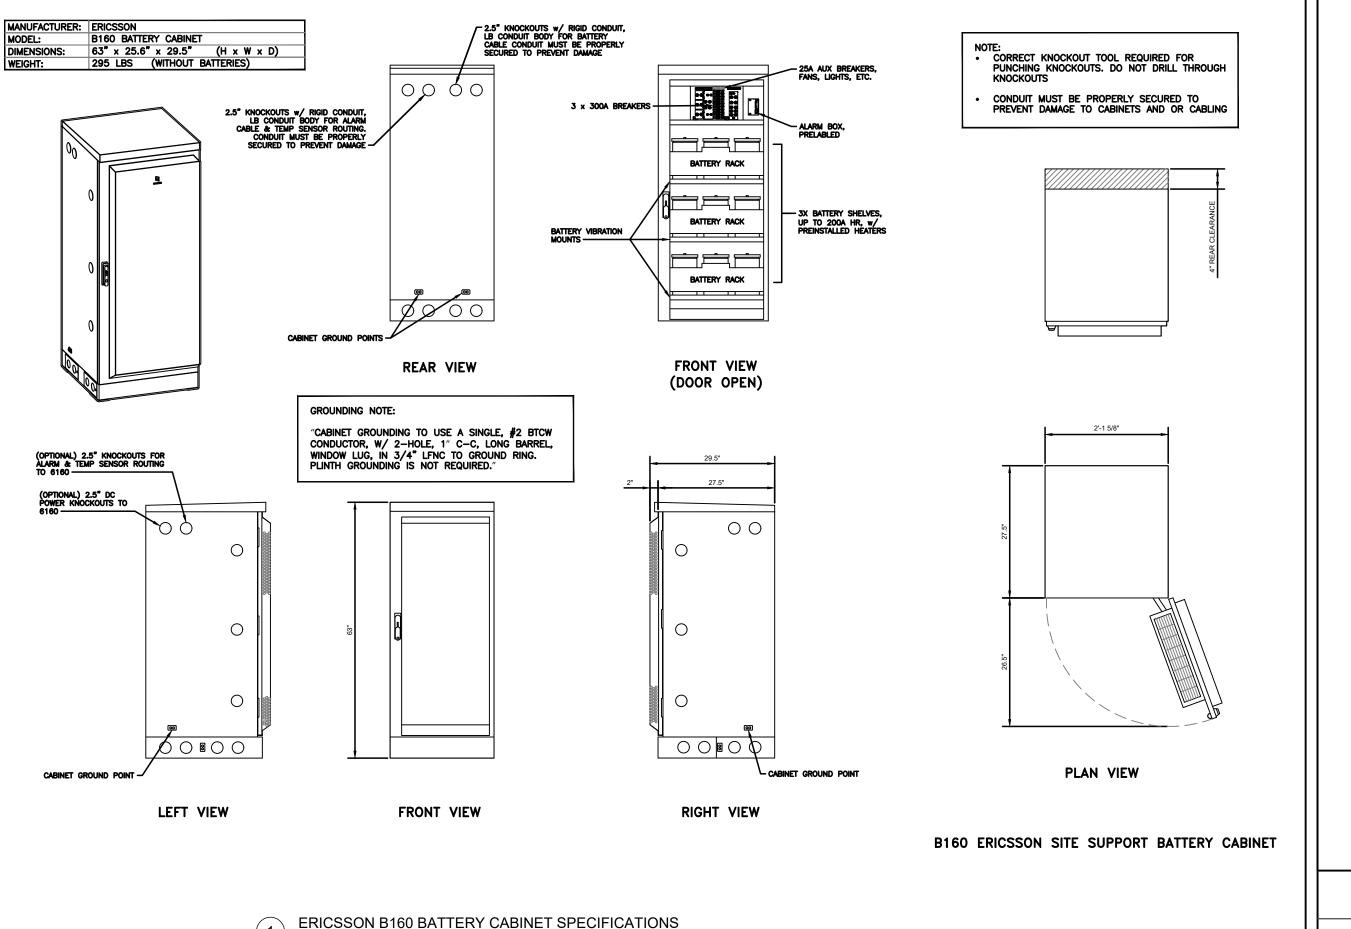

SUPPLEMENTAL


SHEET NUMBER:

R-606


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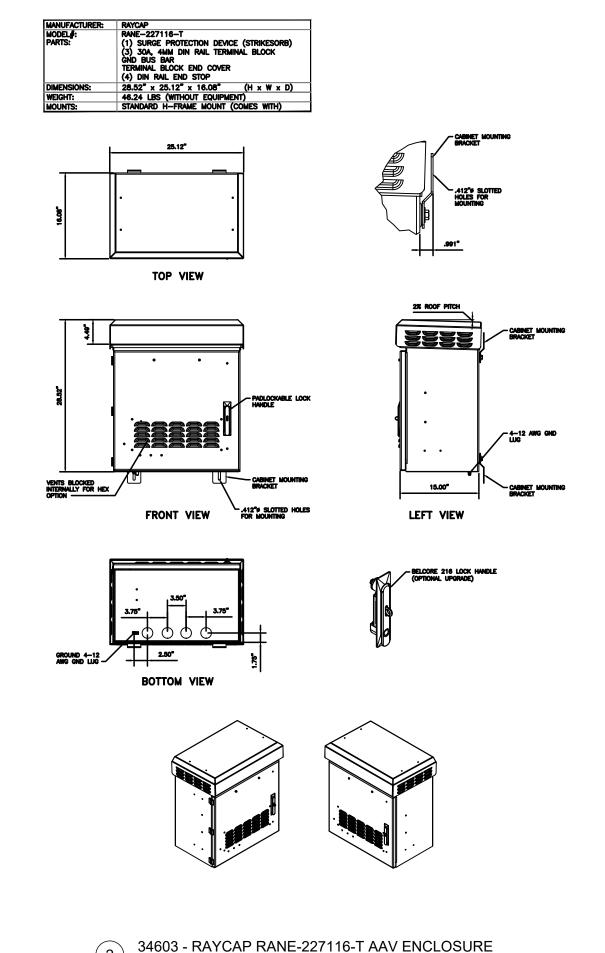
REVISION

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SUPPLEMENTAL SHEET NUMBER: REVISION R-607 0 NOTE: THIS SHEET CREATED BY OTHERS AND PROVIDED BY REQUEST OF CUSTOMER WITHOUT EDIT.



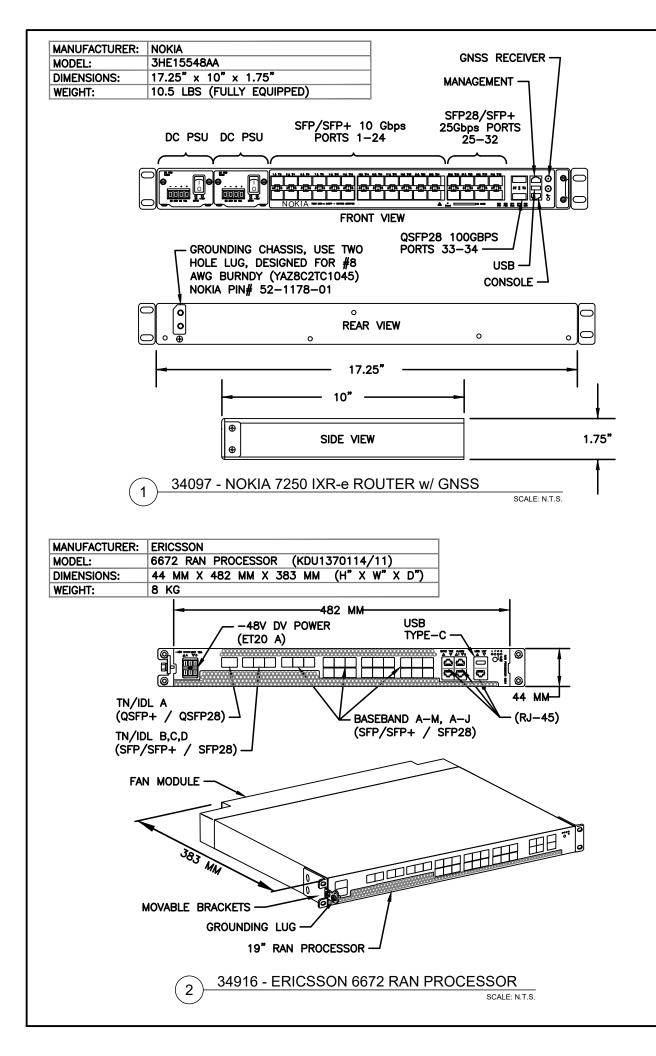

SHEET NUMBER:

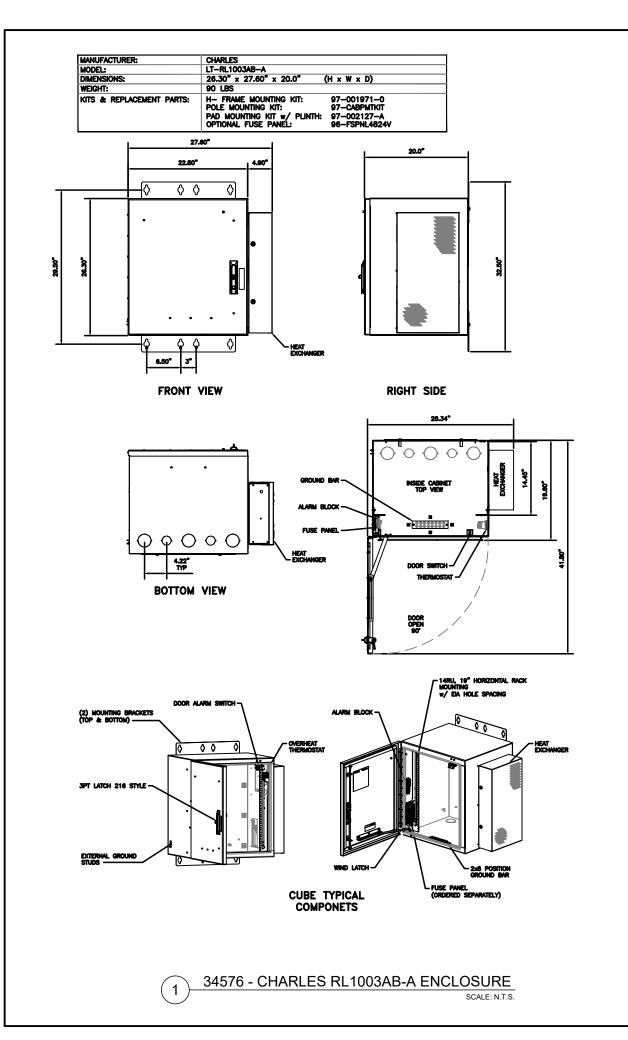R-608

REVISION


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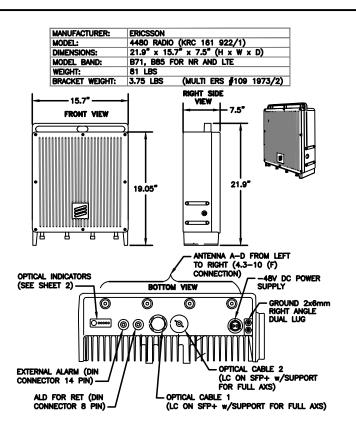
SUPPLEMENTAL


NOTE: THIS SHEET CREATED BY OTHERS AND PROVIDED BY REQUEST OF CUSTOMER WITHOUT EDIT.


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SCALE: N.T.S.





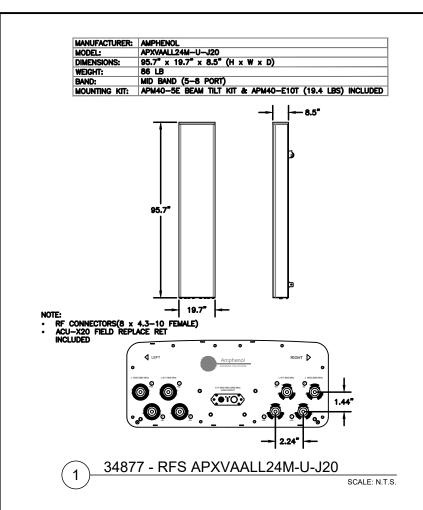

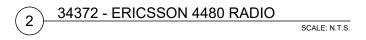

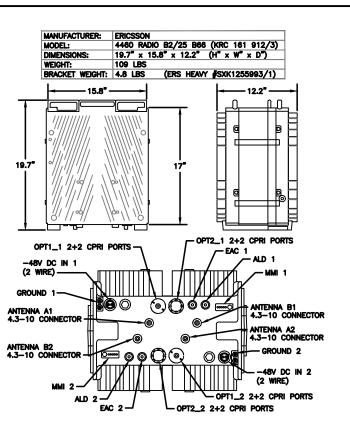3 34373 - ERICSSON 4460 RADIO B2/25 B66

SCALE: N.T.S.

SUPPLEMENTAL


SHEET NUMBER:

R-609

)9

REVISION

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Cable Vendor Cable Type		Nominal OD (in.)			enTop Breakout	MAX ENTITLEMENT	
HCS 2.0	6 AWG 25' to 225'	cable lengths			HCS Pendant (Breakout) Dimension (in	n.)	
Alliance	6x24 6AWG	1.46	1.67	1.61	16.36 x 9.30 x 5.79 (sq./in 152.15)	Nominal DD (in.)	1.55
CommScope	6x24 6AWG	1.55	1.89	1.71	19.37 x 10.83 x 5.12 (sq./in 235.07)	C.S. Area (sq./in.)	1.89
NWS	6x24 6AWG	1.48	1.72	1.61	15.95 x 10.20 x 3.21 (sq./in 162.69)	Weight (lbs./ft)	1.71
Amphenol	6x24 6AWG	1.46	1.67	1.65	19.37 x 10.83 x 5.12 (sq./in 209.78)	Pendant (sq/in)	235.07
	4 AWG 250' to 450' cable lengths						
Alliance	6x24 4AWG	1.8	2.54	2.48	16.36 x 9.30 x 5.79 (sq./in 152.15)	Nominal OD (in.)	1.8
CommScope	6x24 4AWG	1.76	2.43	2.4	19.37 x 10.83 x 5.12 (sq./in 235.07)	C.S. Area (sq./in.)	2.54
NWS	6x24 4AWG	1.79	2.52	2.65	15.95 x 10.20 x 3.21 (sq./in 162.69)	Weight (lbs./ft)	2.65
Amphenol	6x24 4AWG	1.71	2.3	2.55	19.37 x 10.83 x 5.12 (sq./in 209.78)	Pendant (sq/in)	235.07
6x24					óx24 Canister Breakout - OD x Length (in.)		
Alliance	6x24 4AWG	1.8	2.54	2.48	3.11 x 9.45 (c.s. Area 7.60)	Nominal OD (in.)	2
CommScope	6x24 4AWG	1.76	2.43	2.29	2.68 x 9.81 (c.s. Area 5.64)	C.S. Area (sq./in.)	3.13
H&S	6x24 4AWG	1.62	2.04	2.39	3.82 x 9.26 [c.s. Area 11.46]	Weight (lbs./ft)	2.65
NWS	6x24 4AWG	1.79	2.52	2.65	2.99 x B.82 (c.s. Area 7.02)	Canister (sq/in)	11.46
RFS	6x24 4AWG	2	3.13	2.55	2.88 x 9.72 (c.s. Area 6.51)		

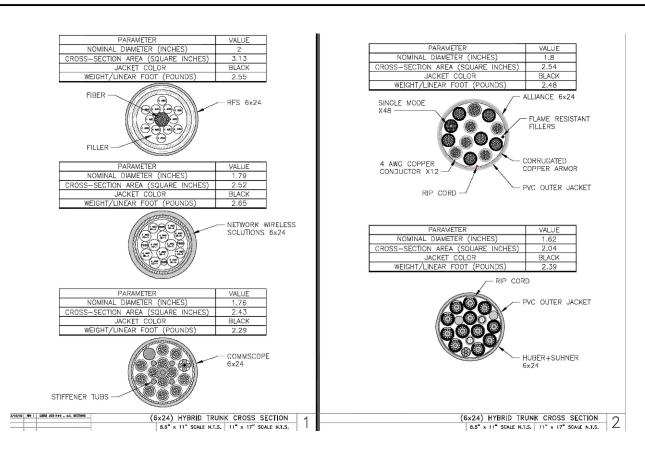(6x24) HYBRID TRUNK ENTITLEMENT INFORMATION 8.5" x 11" SCALE N.T.S. | 11" x 17" SCALE N.T.S.


HYBRID TRUNK INFORMATION (6X24)

SCALE: N.T.S.

SUPPLEMENTAL

SHEET NUMBER:

R-610

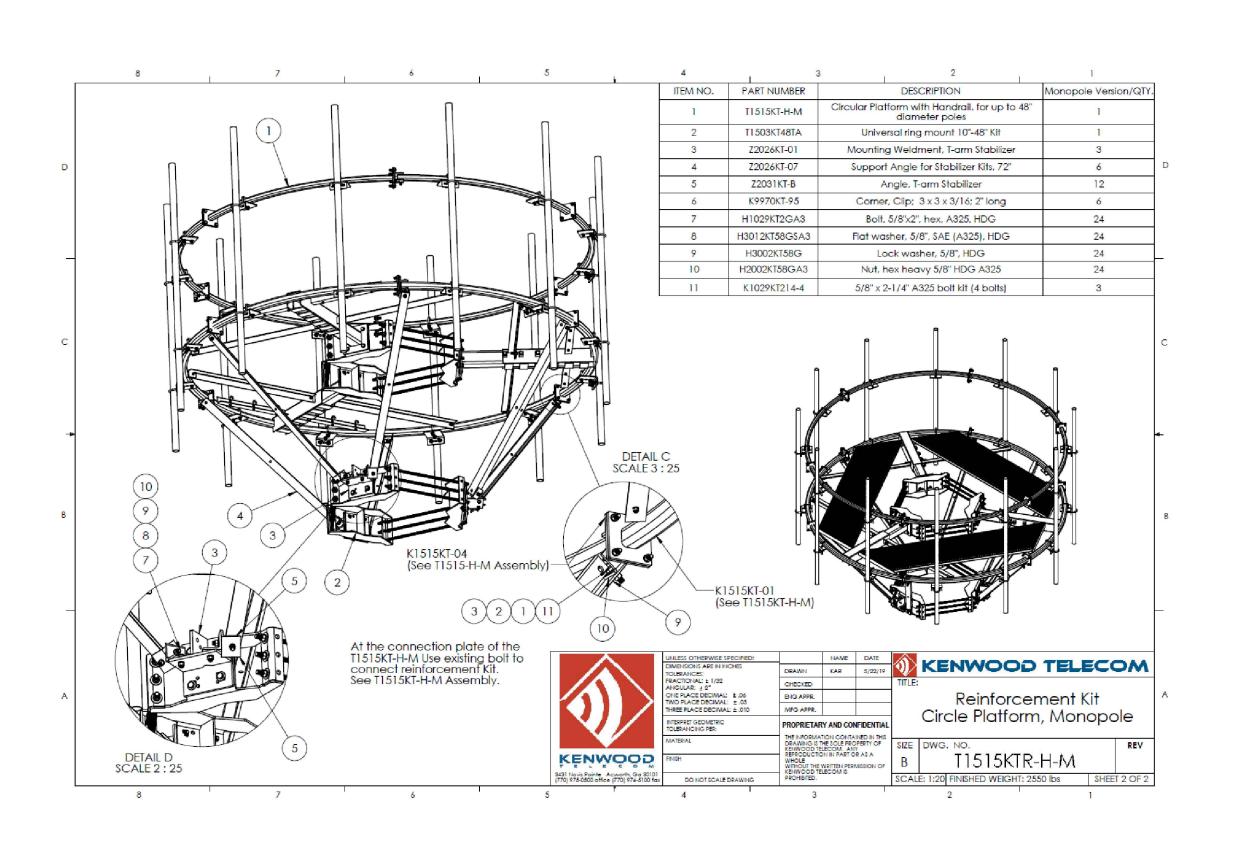

SUPPLEMENTAL

SHEET NUMBER:

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