# **LOCATION MAP** 35.379786. -78.820025

SITE NAME: LILLINGTON

SITE NUMBER: NC14882-A-01

SITE NUMBER: 5RA0183A 67E5D998E ODE+6160

PROPOSED WORK WILL CONSIST OF PREPARATION AND INSTALLATION OF

REQUIRED. NO NEW BUILDING BEING CONSTRUCTED, AND NO ELECTRICAL

WORK BEING DONE. ALL PROPOSED CONSTRUCTION WILL BE CONTAINED

WITHIN THE LIMITS OF THE EXISTING FENCED TELECOM COMPOUND OR

LIMITED TO; ANTENNA SWAP & INSTALL, MOUNT WORK, COAX REMOVAL,

WITHIN PROPOSED UTILITY EASEMENT. WORK WILL INCLUDE, BUT NOT

CELLULAR COMMUNICATION CARRIER EQUIPMENT, WHERE ALL WORK

SHALL BE CONTAINED WITHIN COMPOUND & SHALL NOT ADVERSELY

IMPACT THE SURROUNDING ADJACENT PARCELS. NO GRADING IS

SITE NAME: SOUTH LILLINGTON

**ANCHOR** 

187' & 176' RAD CENTER

### PROJECT DIRECTORY

AARON MEYERS APPLICANT:

AMEYERS@SBASITE.COM 704.527.0003 x 2101 SBA COMMUNICATIONS

CORPORATION

9125-A SOUTHERN PINE BOULEVARD

CHARLOTTE, NC 28276

**ENGINEERING:** P. MARSHALL & ASSOCIATES

3545 WHITEHALL PARK DRIVE SUITE 450

CHARLOTTE, NORTH CAROLINA 28273

TREVOR MCALLISTER

tmcallister@pmass.com 478-542-3291

ALL CONSTRUCTION SPECIFIED ON DOCUMENTS SUBMITTED FOR BUILDING PERMIT SHALL COMPLY WITH THE REQUIREMENTS OF THE FOLLOWING & ALL WORK SHALL BE PERFORMED IN ACCORDANCE WITH CURRENT EDITIONS OF THE FOLLOWING CODES AS ADOPTED BY THE LOCAL **GOVERNING AUTHORITIES:** 

- 2018 NORTH CAROLINA BUILDING CODE (2015 IBC)
- 2018 NORTH CAROLINA FIRE CODE

-PROJECT SUMMARY -

SCOPE OF WORK

INSTALLATION.

CODES

- 2018 NORTH CAROLINA PLUMBING CODE
- 2018 NORTH CAROLINA MECHANICAL CODE
- 2018 NORTH CAROLINA ENERGY CONSERVATION CODE
- 2020 NORTH CAROLINA ELECTRICAL CODE NFPA 70 ANSI/ TIA
- TIA-222-G, TIA-598-C, TIA-6087-B, TIA-569-B, TIA-568-C
- TIA-1019-A

### SITE DESIGN SUMMARY:

WIND LOAD DESIGN: **EXPOSURE CATEGORY:** 

117\_\_mph

OCCUPANCY: CONSTRUCTION TYPE:

FACILITY IS UNMANNED AND NOT FOR HUMAN HABITATION.

HANDICAP ACCESS IS NOT REQUIRED. FACILITY HAS NO SANITARY OR POTABLE WATER

THERE IS "NO EMERGENCY RESPONSE EQUIPMENT ON THE TOWER AND EXISTING &/OR PROPOSED EQUIPMENT WILL NOT INTERFERE WITH COUNTY EMERGENCY COMMUNICATIONS AND THAT, IF SUCH, INTERFERENCE IS FOUND TO EXIST, THEN APPLICANT WILL TAKE WHATEVER STEPS NECESSARY TO CORRECT INTERFERENCE."

### -SITE SUMMARY -

SITE ADDRESS: 162 MATTIE RIDGELL LN

LILLINGTON, NC 27546

FLAG POLE

SBA

NC14882-A-01 SBA NUMBER: LILLINGTON SBA NAME:

TOWER:

COMPANY:

CARRIER: SPRINT/T-MOBILE TENANT ID/NAME: 5RA0183A

SITE LATITUDE(NAD83): 35.379786 (35° 22' 47.2" N) SITE LONGITUDE(NAD83): -78.820025 (-78° 49' 12.1")

GND ELEVATION (NAVD88): 208' TOWER HEIGHT (AGL.)

JURISDICTION: HARNETT COUNTY PARCEL #: 7362203 RA-20R ZONING:

ACREAGE: 72.62 ACRES (E) IMPERVIOUS: 5475± SQFT. (P) IMPERVIOUS: 0 SQFT. COMPOUND SIZE: 5475± SQFT.

UTILITIES:

POWER COMPANY: DUKE ENERGY

TELCO COMPANY: TWC

FEMA PANEL:

THIS SITE IS NOT IN ANY SPECIAL FLOOD HAZARD AREAS OR FUTURE CONDITIONS FLOOD HAZARD AREAS, AS SHOWN PER FIRM PANEL: 3720054800J. DATED: 10/03/06.

### -SHEET INDEX

1-1	IIITE 2HEEI
T-1A	APPENDIX B
T-1B	APPENDIX B
T-1C	APPENDIX B
C-1	SITE PLAN
C-2	EQUIPMENT PLAN
C-3	TOWER ELEVATION
C-4	ANTENNA ORIENTATION & CAE

ABLE SCHEDULE PLUMBING DIAGRAM C-5

C-6 **EQUIPMENT SPECS** C-7 **ANTENNA SPECS** E-1 **ELECTRICAL NOTES** 

E-2 PANEL SCHEDULE & ONE-LINE DIAGRAM

G-1 **GROUNDING DETAILS** 

### **T** - Mobile-



SBA COMMUNICATIONS CORP. 5900 BROKEN SOUND PKWY NW BOCA RATON, FL 33487



LOCATION:

162 MATTIE RIDGELL LN LILLINGTON, NC 27546

LILLINGTON NC14882-A-01 T-MOBILE:

**SOUTH LILLINGTON** 

5RA0183A

SITE TYPE:


190' FLAG POLE T-MOBILE ANCHOR

REV	DATE	DESCRIPTION
0	7/17/22	FOR CONSTRUCTION
1	11/30/22	FOR CONSTRUCTION
2	12/8/22	JX REV. 2
3	12/12/22	FULL CANISTER EXPANSION

SITE COORDINATES LAT: 35.379786 LONG: -78.820025

DRAWN: RSW CHECKED: PWM

22SBATNCM-0042

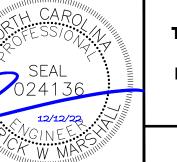

TITLE SHEET & **PROJECT INFORMATION** 

T-1



CALL NORTH CAROLINA ONE CALL (800) 632-4949 CALL 3 WORKING DAYS **BEFORE YOU DIG!** 



## 2018 APPENDIX B BUILDING CODE SUMMARY FOR ALL COMMERCIAL PROJECTS

### (EXCEPT 1 AND 2-FAMILY DWELLINGS AND TOWNHOUSES)

(Reproduce the following data on the building plans sheet 1 or 2)

Name of Project:	SOUTH LILLINGTON -5RA01	83A				
	TIE RIDGELL LN LILLINGTON, N			Zip Code		
Owner/Authorize	ed Agent: AARON MEYERS	Phone # ( _704	.) <u>527</u> - <u>0003 x2</u>	101 E-Mail AMEYERS@sbasite.co		
Owned By:	☐ Cit	ty/County	Private	☐ State		
Code Enforceme	nt Jurisdiction: Cit	ty	CountyHAR	NETT COUNTY State		
CONTACT:						
DESIGNER	FIRM	NAME	LICENSE #	TELEPHONE # E-MAIL		
Architectural				()		
Civil	P. MARSHALL & ASSOCIATES	PATRICK MARSHALL	024136	( 678 ) 280-2325		
Electrical				()		
Fire Alarm				(—)———————————————————————————————————		
Plumbing Mechanical						
	ipe					
Structural	<u> </u>					
Retaining Walls	>5' High					
Other				()		
("Other" should	include firms and individu	als such as truss, p	recast, pre-engine	eered, interior designers, etc.)		
2019 NC DIHI I	DING CODE: New 1	Duilding	Shell/Core	☐ 1 <sup>st</sup> Time Interior Completions		
2016 NC BUILL	<u> </u>			_		
	☐ Addit		Phased Construc	_		
2018 NC EXIST	ING BUILDING CODE	: Prescriptive	Alteratio	n Level I Historic Property		
(check all that ap	ply)	☐ Repair		n Level II Change of Use		
		☐ Chapter 14	☐ Alteratio	n Level III		
CONSTRU	CTED: (date)	CURRE	NT OCCUPANO	<b>Y(S)</b> (Ch. 3):		
RENOVAT	RENOVATED: (date) PROPOSED OCCUPANCY(S) (Ch. 3):					
OCCUPANCY	CATEGORY (Table 160	4.5): Current: <u>UTI</u>	LITY & MISC. P1	oposed: UTILITY & MISC.		
BASIC BUILDI	NC DATA					
Construction Ty	_	□ II-A	□ III-A	□ IV □ V-A		
(check all that ap		⊠ II-B	□ III-B	□ V-B		
Sprinklers:	No ☐ Partial	☐ NFPA 13	☐ NFPA 13R	□ NFPA 13D		
Standpipes:	No Class □ I		☐ Wet ☐ Dry	_		
	=			<u> </u>		
Primary Fire Di	_ =		Hazard Area:	⊠ No ☐ Yes		
Special Inspection	ons Required: No	☐ Yes				
	GR	OSS BUILDING	AREA TABLE			
FLOOR	EXISTING (SQ FT)	New (	SQ FT)	SUB-TOTAL		
3 <sup>rd</sup> Floor						
2 <sup>nd</sup> Floor						
Mezzanine						
1st Floor						
Basement						
TOTAL						

		ALL	OWABLE ARE	E <b>A</b>			
Primary Occu	ipancy Classificati	ion(s):					
Assembly	□ A-1	☐ A-2	ПА	3	□ A-4	☐ A-5	
Business	Ħ	_	_		_	_	
Education	al 🗍						
Factory	☐ F-1 Mod	erate  F-2 Lo	W				
Hazardou	s 🔲 H-1 Deto	onate 🔲 H-2 De	eflagrate 🔲 H	-3 Combust	☐ H-4 Healtl	n H-5 HPM	
Institution	al 🗌 I-1	☐ I-2	_ I-	3	☐ I-4		
I-1	Condition 1	$\square$ 2					
I-2	Condition 1	$\square$ 2					
	Condition 1	$\square$ 2 $\square$ 3	☐ 4 ☐ 5				
Mercantil	=	_	_		_		
Residentia	_	☐ R-2	_	-3	☐ R-4		
Storage	S-1 Mod		S-2 Low		High-piled		
		Garage	☐ Enclosed		Repair Ga	rage	
	d Miscellaneous	$\boxtimes$					
Accessory Oc	cupancy Classifica	ntion(s):					
Incidental Us	es (Table 509):						
This se	eparation is not exe	mpt as a Non-Sepa	rate <sup>1</sup>	's).			
Special Uses (	Chapter 4 – List C	Code Sections):	ON of C				
	sions: (Chapter 5 -	- List Code	$\bigcirc$ '-				
-	ancy: Select one	Ser	$\mathcal{O}$	<u> </u>			
-	•	36,	$\cup_{L_i}$	<i>'</i> —		-	
Select one		111	$\sim$				
_AC	tual Area of Oc vable Area ι	111.14	$\mathcal{V}$	Occupancy B Occupancy B	<u>≤</u> 1		
Allow	abie Area c	, ~! !!	Area of	Оссирансу в			
		80		4	. =	< 1.00	
		•	_		– –		
STORY	DESCRIPTION AND	(A)	(B)	(c)		(D)	
NO.	USE	LDG AREA PER	TABLE 506.24	AREA FOR FRON	TAGE ALLOW	ABLE AREA PER	
		STORY (ACTUAL)	AREA	INCREASE <sup>1</sup>		OR UNLIMITED <sup>2,3</sup>	
		,					
<sup>1</sup> Frontage area	a increases from Se	ction 506.2 are cor	nputed thus:				
a. Perin	neter which fronts a	public way or ope	n space having	20 feet minimu	m width =	(F)	
	<b>Building Perimeter</b>		(P)			, ,	
c. Ratio							
d. W = 1							
	ea applicable under						
	uilding Area = total						
4 701	C 1						
			comply with Tal	ole 406.5.4. Th	ie maximum a	rea of air traffic	
control towe	m area of open park ers must comply wit rease is based on the	th Table 412.3.1.			ie maximum a	rea of air traffic	

**T** - Mobile



SBA COMMUNICATIONS CORP. 5900 BROKEN SOUND PKWY NW BOCA RATON, FL 33487



LOCATION:

162 MATTIE RIDGELL LN LILLINGTON, NC 27546

OD/ t.

LILLINGTON NC14882-A-01

T-MOBILE:

SOUTH LILLINGTON

5RA0183A

SITE TYPE:

190' FLAG POLE T-MOBILE ANCHOR

	1 1010	BILL 7 (140) TOTA
REV	DATE	DESCRIPTION
0	7/17/22	FOR CONSTRUCTION
1	11/30/22	FOR CONSTRUCTION

SITE COORDINATES

LAT: 35.379786

LONG: -78.820025

DRAWN: RSW CHECKED: PWM

JOB#: 22SBATNCM-0042

**APPENDIX B** 

T-1A

### ALLOWABLE HEIGHT

	ALLOWABLE	SHOWN ON PLANS	CODE REFERENCE
Building Height in Feet (Table 504.3)			
Building Height in Stories (Table 504.4)			

<sup>1</sup> Provide code reference if the "Shown on Plans" quantity is not based on Table 504.3 or 504.4.

### FIRE PROTECTION REQUIREMENTS

BUILDING ELEMENT	FIRE		RATING	DETAIL#	DESIGN#	SHEET # FOR	SHEET #
	SEPARATION	REQ'D	PROVIDED	AND "	FOR	RATED	FOR
	DISTANCE (FEET)		(W/* REDUCTION)	SHEET #	RATED ASSEMBLY	PENETRATION	RATED JOINTS
Structural Frame,							
including columns, girders,							
trusses							
Bearing Walls					'		
Exterior					_		
North				Į.	_		
East				_			
West			├ <b>-</b> ⋌	· 1			
South		<b>.</b>	<b>├</b>	\ '			
Interior		<b>├</b>	\( )	` _			
Nonbearing Walls and Partitions		J	MOI	$\mathcal{A}(\cdot)$	)		
Exterior walls	L	' D	. ' - '	M_			
North	L \	1 r	$\cdot$ $\sim$	<b>'</b>	<b></b>		
East	· ~	١.	ハソ	·			
West	1	` .	11 <b>\</b> \				
South		$\alpha$	· ) • · · · · · · · · · · · · · · · · ·				
Interior walls and partitions	_	$\mathcal{O}$					
Floor Construction		~					
Including supporting beams							
and joists							
Floor Ceiling Assembly							
Columns Supporting Floors							
Roof Construction, including supporting beams and joists							
Roof Ceiling Assembly							
Columns Supporting Roof							
Shaft Enclosures - Exit							
Shaft Enclosures - Other							
Corridor Separation							
Occupancy/Fire Barrier Separa	tion	<b>-</b>		-			
Party/Fire Wall Separation		l		1			
Smoke Barrier Separation		<b>-</b>		<b> </b>			
Smoke Partition		l		1			
Tenant/Dwelling Unit/ Sleeping Unit Separation							
Incidental Use Separation							

<sup>\*</sup> Indicate section number permitting reduction

#### ACCESSIBLE DWELLING UNITS (SECTION 1107)

TOTAL	ACCESSIBLE	ACCESSIBLE	TIFEA	THEA	TILED	TIFED	TOTAL
Units	Units	Units	Units	Units	Units	Units	ACCESSIBLE UNIT
	REQUIRED	Provided	REQUIRED	PROVIDED	REQUIRED	PROVIDED	PROVIDED

#### ACCESSIBLE PARKING (SECTION 1106)

### SPECIAL APPROVALS

 $\textbf{Special approval:} \ (Local \ Jurisdiction, Department \ of \ Insurance, OSC, DPI, DHHS, etc., describe \ below)$ 

#### PERCENTAGE OF WALL OPENING CALCULATIONS

FIRE SEPARATION DISTANCE (FEET) FROM PROPERTY LINES	DEGREE OF OPENINGS PROTECTION (TABLE 705.8)	ALLOWABLE AREA (%)	ACTUAL SHOWN ON PLANS (%)

### LIFE SAFETY SYSTEM REQUIREMENTS

Emergency Lighting: Exit Signs: Fire Alarm: Smoke Detection Systems:	☐ Yes ☐ Yes ☐ Yes ☐ Yes	☐ No ☐ No
Smoke Detection Systems: Carbon Monoxide Detection:	Yes Yes	
		_

Life Safety Plan Sheet #:		<b>N</b>	
☐ Fire and/or smoke rated wall locations (Chapter 7)	_ く	<u>۲</u>	
☐ Assumed and real property line locations (if not)	$\bigcirc$	•	
Exterior wall opening area with respect to	<b>(( )</b>		

xit door can accommodate based on egress width (1005.3)

re fire rated floor/ceiling and/or roof structure is provided for

LIFE SAFETY PLAN REQUIREM

 □ Exterior wall opening area Occupancy Use for each area as it re<sup>1</sup> Occupant loads for each area ☐ Exit access travel distance Common path of trav Dead end lengths (.

☐ Clear exit widths for . Maximum calculated oc Actual occupant load for c

Life Safety Plan Sheet #:

A separate schematic plan in purposes of occupancy separa.

Location of doors with panic hardware (1010.1.10)

Location of doors with delayed egress locks and the amount of delay (1010.1.9.7) Location of doors with electromagnetic egress locks (1010.1.9.9) ☐ Location of doors equipped with hold-open devices

Location of emergency escape windows (1030) ☐ The square footage of each fire area (202)

☐ The square footage of each smoke compartment for Occupancy Classification I-2 (407.5) ☐ Note any code exceptions or table notes that may have been utilized regarding the items above

#### ENERGY SUMMARY ENERGY REQUIREMENTS:

The following data shall be considered minimum and any special attribute required to meet the energy code shall also be provided. Each Designer shall furnish the required portions of the project information for the plan data sheet. If performance method, state the annual energy cost for the standard reference design vs annual energy cost for the Existing building envelope complies with code: Select one

Exempt Building: Select one Provide code or statutory reference

Climate Zone: Select one

Method of Compliance: <u>Select one</u> (If "Other" specify source here)

### THERMAL ENVELOPE (Prescriptive method only)

### Roof/ceiling Assembly (each assembly) Description of assembly:

U-Value of total assembly: R-Value of insulation: Skylights in each assembly: U-Value of skylight:

total square footage of skylights in each asso

Exterior Walls (each assembly)

Description of assembly: U-Value of total assemble R-Value of insulation

Walls below grade

R-Value of insul.

Description 6. U-Value of tota

### Floors over unconditioned space (each assembly) Description of assembly:

R-Value of insulation:

### Floors slab on grade

Description of assembly U-Value of total assembly: R-Value of insulation:

Horizontal/vertical requirement: slab heated:

**T** - Mobile-



SBA COMMUNICATIONS CORP. 5900 BROKEN SOUND PKWY NW BOCA RATON, FL 33487



LOCATION:

162 MATTIE RIDGELL LN LILLINGTON, NC 27546

LILLINGTON NC14882-A-01 T-MOBILE:

**SOUTH LILLINGTON** 

5RA0183A

SITE TYPE:

190' FLAG POLE T-MOBILE ANCHOR

REV	DATE	DESCRIPTION
0	7/17/22	FOR CONSTRUCTION
1	11/30/22	FOR CONSTRUCTION

SITE COORDINATES LAT: 35.379786 LONG: -78.820025

DRAWN: RSW CHECKED: PWM

JOB#: 22SBATNCM-0042

**APPENDIX B** 

**T-1B** 

### 2018 APPENDIX B BUILDING CODE SUMMARY FOR ALL COMMERCIAL PROJECTS

### STRUCTURAL DESIGN (PROVIDE ON SHEET 1 OR 2 OF THE STRUCTURAL SHEETS)

DESIGN LOADS:	
Importance Factors:	Wind (I <sub>w</sub> ) Snow (I <sub>s</sub> ) Seismic (I <sub>E</sub> )
Live Loads:	Roof psf Mezzanine pef Floor
Ground Snow Load:	psf
	cic Wind c C D
SEISMIC DESIGN CATE	$\mathcal{M}''$ $\mathcal{M}$ $\mathcal{M}''$ $\mathcal{M}$ $\mathcal{M}$ $\mathcal{M}$ $\mathcal{M}$ $\mathcal{M}$ $\mathcal{M}$ $\mathcal{M}$
Provide the following Seisn	, 2////
Occupancy Categor	
Spectral Response Ac	%g S <sub>1</sub> %g
Site Classification (AS	$ \begin{array}{c ccccccccccccccccccccccccccccccccccc$
`	arce: Field Test Presumptive Historical Data
Basic structural system (	
☐ Bearing Wall	
Building Fran	
☐ Moment Fran	
Analysis Procedure:	☐ Simplified ☐ Equivalent Lateral Force ☐ Dynamic
Architectural, Mechanic	al, Components anchored?  Yes No
LATERAL DESIGN CONTROL	: Earthquake  Wind
SOIL BEARING CAPACITIES:	
	of test report) psf
Presumptive Bearing cap	acity psf
Pile size, type, and capaci	

### 2018 APPENDIX B **BUILDING CODE SUMMARY FOR ALL COMMERCIAL PROJECTS** MECHANICAL DESIGN

(PROVIDE ON THE MECHANICAL SHEETS IF APPLICABLE)

MECHANICAL SUMMARY

MECHANICAL SYSTEMS, SERVICE SYSTEMS AND EQUIPMENT

	**
	oulb:
summer dry	/ bulb:
Interior design cond	ditions
winter dry b	oulb:
summer dry	y bulb:
relative hum	midity:
Building heating loa	y bulb: A A A A A A A A A A A A A A A A A A A
Building cooling loa	ad: _
	G THE Y
Mechanical Spacing	g Conditioni.
Mechanical Spacing Unitary	g Conditioni.
Unitary	ion of unit:
Unitary descripti	
Unitary descripti heating e	ion of unit:
Unitary descripti heating e cooling e	ion of unit:
Unitary descripti heating e cooling e	ion of unit: efficiency: efficiency:
Unitary descripti heating e cooling e size cate	ion of unit: efficiency: efficiency:
Unitary descripti heating e cooling e size cate	ion of unit: efficiency: efficiency: egory of unit:

### 2018 APPENDIX B **BUILDING CODE SUMMARY FOR ALL COMMERCIAL PROJECTS** ELECTRICAL DESIGN

(PROVIDE ON THE ELECTRICAL SHEETS IF APPLICABLE)

ELECTRICAL SUMMARY

ELECTRICAL SYSTEM AND EQUIPMENT

Method of Compliance: Select one

Lighting schedule (each fixture type) lamp type required in fixture number of lamps in fixture ballast type used in the fixty total wattage per fi total interior wattage

Additional Prescriptive Complia.

total exterior wattage

506.2.1	More Efficient N chanical Equipment
506.2.2	Reduced Lighting Power Density
506.2.3	Energy Recovery Ventilation Systems
	Higher Efficiency Service Water Heating
506.2.5	On-Site Supply of Renewable Energy
	Automatic Daylighting Control Systems

**T** - Mobile



SBA COMMUNICATIONS CORP. 5900 BROKEN SOUND PKWY NW BOCA RATON, FL 33487



LOCATION:

162 MATTIE RIDGELL LN LILLINGTON, NC 27546

LILLINGTON NC14882-A-01 T-MOBILE:

**SOUTH LILLINGTON** 

5RA0183A

SITE TYPE:

190' FLAG POLE T-MOBILE ANCHOR

		B122 / ((1011011
REV	DATE	DESCRIPTION
0	7/17/22	FOR CONSTRUCTION
1	11/30/22	FOR CONSTRUCTION


SITE COORDINATES LAT: 35.379786 LONG: -78.820025

DRAWN: RSW CHECKED: PWM

JOB#: 22SBATNCM-0042

**APPENDIX B** 

**T-1C** 

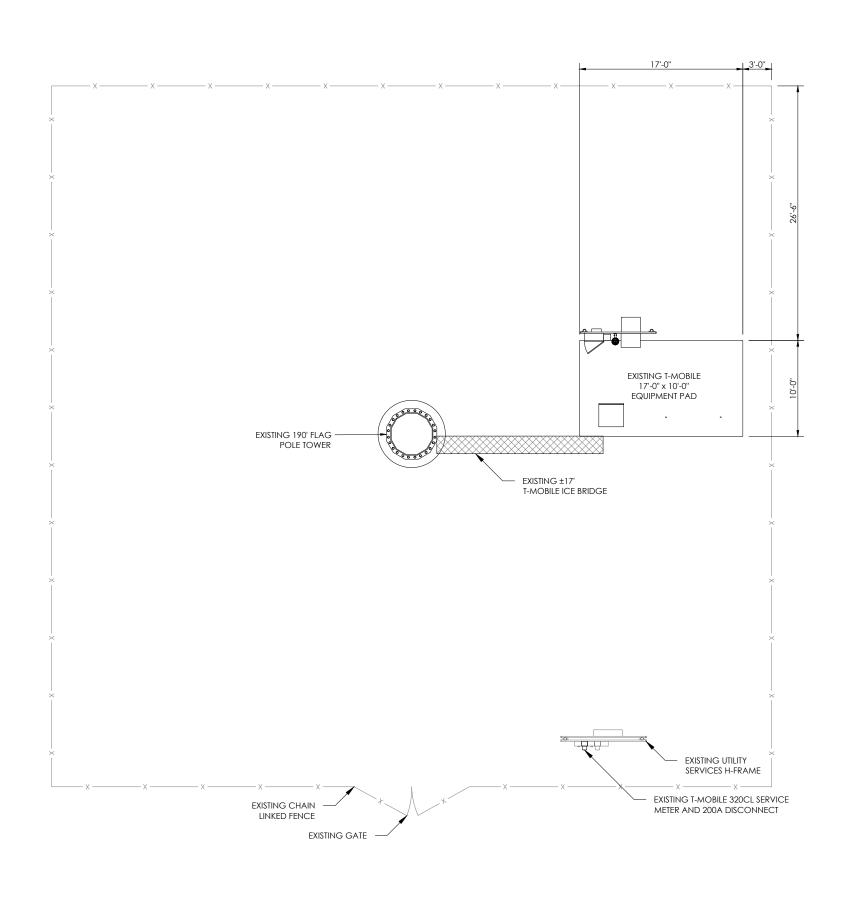

### -GENERAL NOTES -

- 1. ALL MATERIAL AND EQUIPMENT FURNISHED SHALL BE NEW AND OF GOOD QUALITY. FREE FROM FAULTS AND DEFECTS AND IN CONFORMANCE WITH THE CONTRACT DOCUMENTS. ANY SUBSTITUTIONS MUST BE PROPERLY APPROVED AND AUTHORIZED IN WRITING BY THE OWNER AND ENGINEER PRIOR TO INSTALLATION. CONTRACTOR SHALL FURNISH SATISFACTORY EVIDENCE AS TO THE KIND OF QUALITY OF MATERIAL AND EQUIPMENT BEING SUBSTITUTED.
- 2. ACCESS TO PROPOSED WORK SITE MAY BE RESTRICTED. THE CONTRACTOR SHALL COORDINATE INTENDED CONSTRUCTION ACTIVITY, INCLUDING WORK SCHEDULE AND MATERIALS ACCESS WITH THE LEASING AGENT FOR APPROVAL.
- 3. CONTRACTOR SHALL HAVE PRESENT ON SITE CURRENT CARRIER SUPPLIED INFORMATION PRIOR TO COMMENCE OF WORK; IE. RFDS, DESIGN DOCUMENTS SPECIFIC TO SITE AND CONFIGURATION. NOTIFY CONSTRUCTION MANAGER OF ANY DISCREPANCY PRIOR TO ARRIVAL AT SITE.
- 4. ALL HARDWARE ASSEMBLY MANUFACTURER'S INSTRUCTION SHALL BE FOLLOWED EXACTLY AND SHALL SUPERSEDE ANY CONFLICTING NOTES ENCLOSED HEREIN.
- 5. ALL DAMAGE TO EXISTING UNDERGROUND, OVERHEAD OBSTACLES AND/OR EXISTING EQUIPMENT, PAD OR SHELTERS SHALL BE REPLACED BACK TO FULL ORIGINAL OR BETTER CONDITION & SHALL MATCH EXISTING CONDITIONS BY REPAIRS AT GENERAL CONTRACTOR EXPENSE.
- 6. THE EXISTING TREES AND VEGETATION ARE SUFFICIENT TO PROVIDE THE REQUIRED SCREENING PER LOCAL ORDINANCE. IF THE VEGETATION IS REMOVED OR DAMAGED, NEW LANDSCAPING/ SCREENING WILL BE INSTALLED TO MEET LOCAL ORDINANCE REQUIREMENTS.

# **T** - Mobile-



SBA COMMUNICATIONS CORP. 5900 BROKEN SOUND PKWY NW BOCA RATON, FL 33487



LOCATION:

162 MATTIE RIDGELL LN LILLINGTON, NC 27546

SBA:

LILLINGTON NC14882-A-01

T-MOBILE:

**SOUTH LILLINGTON** 

5RA0183A

SITE TYPE:

190' FLAG POLE T-MOBILE ANCHOR

REV	DATE	DESCRIPTION
0	7/17/22	FOR CONSTRUCTION
1	11/30/22	FOR CONSTRUCTION

SITE COORDINATES

LAT: 35.379786

LAT: 35.3/9/86 LONG: -78.820025

DRAWN: RSW CHECKED: PWM

JOB#: 22SBATNCM-0042

-NORTH ARROW


-GRAPHIC SCALE






1"=5'-0" (FULL SIZE) 1"=10'-0" (11x17)

SITE PLAN

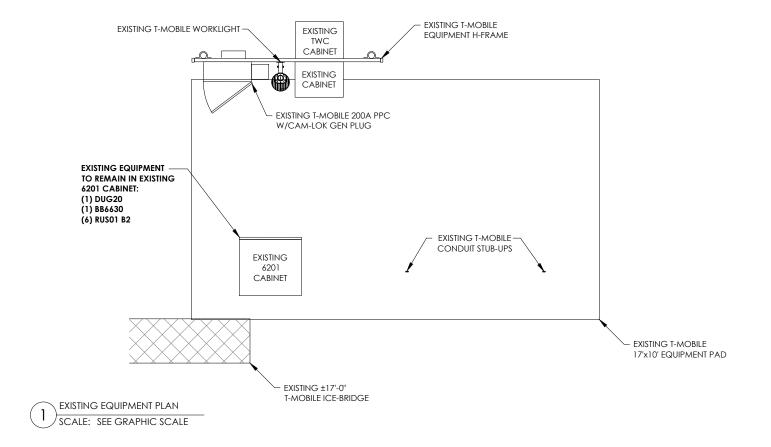

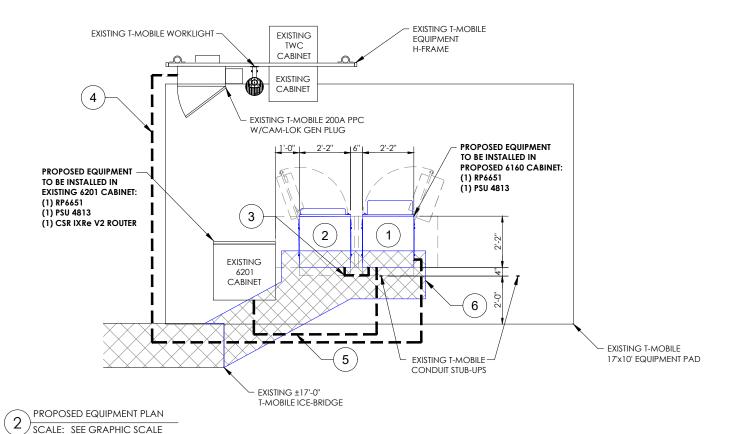

### **KEYED NOTES**

- 1. PROPOSED ENCLOSURE 6160 CABINET ATTACHED TO PLATFORM AT EACH CORNER PER MANUFACTURER'S SPECIFICATIONS. GROUND CABINET WITH MECHANICAL 2-LUG CONNECTION & #2 TINNED SOLID COPPER IN 3/4" NON METALLIC FLEX. CONDUIT TO EXISTING EQ. GROUND (TYP)
- 2. PROPOSED ENCLOSURE B160 BATTERY CABINET ATTACHED TO PLATFORM AT EACH CORNER PER MANUFACTURER'S SPECIFICATIONS. GROUND CABINET WITH MECHANICAL 2-LUG CONNECTION & #2 TINNED SOLID COPPER IN 3/4" NON METALLIC FLEX. CONDUIT TO EXISTING EQ. GROUND. (TYP)
- PROPOSED (2) 2" CONDUIT WITH PULLSTRINGS FROM PROPOSED ENCLOSURE 6160 CABINET TO PROPOSED ENCLOSURE B160 BATTERY CABINET.
- 4. PROPOSED (2) 2" CONDUIT FROM EXISTING PPC TO PROPOSED ENCLOSURE 6160 CABINET.
- 5. PROPOSED (1) 2" CONDUIT FROM PROPOSED 6160 CABINET TO EXISTING 6201 EQUIPMENT CABINET
- 6. PROPOSED ±10' ICEBRIDGE EXTENSION FOR HCS CABLE MANAGEMENT

### -EQUIPMENT NOTE-

THE CABINETS ARE CONSTRUCTED OF NONCOMBUSTIBLE MATERIALS TO MEET THE REQUIREMENTS OF THE CURRENT NFPA 37 EDITION 2018. CABINET CONSTRUCTION THAT PASSED A SIMULATED BRUSH FIRE TEST TO DEMONSTRATE COMPLIANCE TO TELCORDIA GR-487-CORE SECTION 3.39 FIRE RESISTANCE REQUIREMENT R3-265. REFER TO THE NATIONAL TECHNICAL SYSTEMS (NTS) REPORT NO. PR067628-GR487.

### -CONDUIT NOTE


UNDERGROUND CONDUIT SHALL BE SCHEDULE 40 PVC CONDUIT (MEET NEMA TC2 - 1990). EXPOSED CONDUIT SHALL BE RIGID GALVANIZED STEEL CONDUIT BEFORE RISING ABOVE GRADE. PLUG AND CAP EACH END OF SPARE AND EMPTY CONDUITS AND PROVIDE TWO SEPARATE PULL STRINGS 200 LB. TEST POLYETHYLENE CORD. ALL CONDUIT BENDS SHALL BE A MINIMUM OF 24" RADIUS. RGS CONDUITS, WHEN SPECIFIED, SHALL MEET UL-6 FOR GALVANIZED STEEL. ALL FITTINGS SHALL BE SUITABLE FOR USE WITH THREADED RIGID CONDUIT. LIQUIDTIGHT FLEX METAL CONDUIT (LFMC) IS ACCEPTABLE ABOVE GRADE, AS REQUIRED AND NECESSARY.

### GRAPHIC SCALE

3/4"=1'-0" (FULL SIZE) 3/8"=1'-0" (11x17)

### -NORTH ARROW-



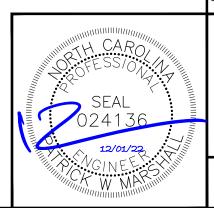

# **T** - Mobile-



SBA COMMUNICATIONS CORP. 5900 BROKEN SOUND PKWY NW BOCA RATON, FL 33487



LOCATION:

162 MATTIE RIDGELL LN LILLINGTON, NC 27546

LILLINGTON NC14882-A-01 T-MOBILE:

**SOUTH LILLINGTON** 

5RA0183A

SITE TYPE:

190' FLAG POLE T-MOBILE ANCHOR


REV	DATE	DESCRIPTION
0	7/17/22	FOR CONSTRUCTION
1	11/30/22	FOR CONSTRUCTION

SITE COORDINATES LAT: 35.379786 LONG: -78.820025

DRAWN: RSW CHECKED: PWM

JOB# 22SBATNCM-0042

**EXISTING EQUIPMENT PLAN** 

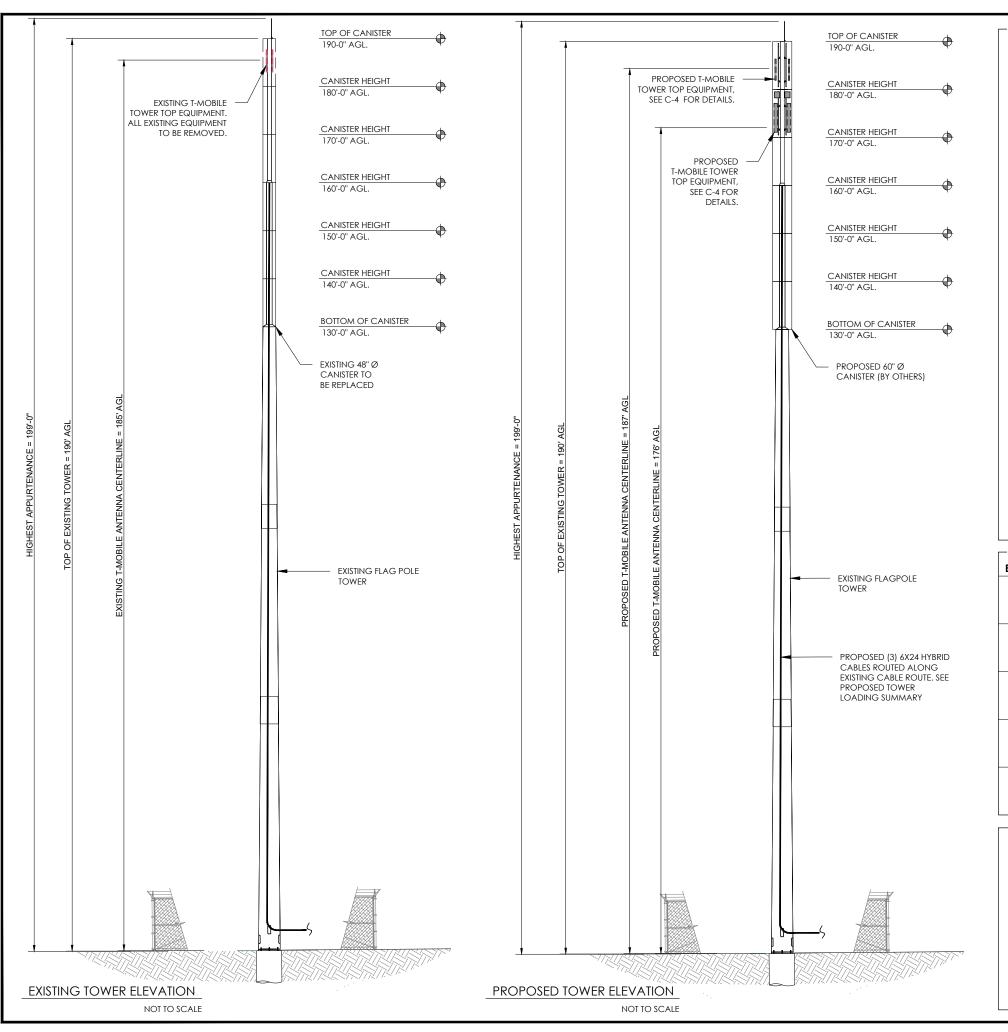

### -GENERAL NOTES

- REFER TO TOWER STRUCTURAL ANALYSIS FOR PROPOSED ANTENNA CABLE LOADING DETAILS
- 2. TOWER ELEVATION SHOWN IS NOT DRAWN TO SCALE AND IS ONLY INTENDED FOR REFERENCE PURPOSES. REFER TO ORIGINAL TOWER DESIGN FOR ADDITIONAL INFORMATION.
- 3. ALL TOWER DIMENSIONS SHALL BE VERIFIED WITH THE PLANS PRIOR TO COMMENCING CONSTRUCTION. NOTIFY THE ENGINEER IMMEDIATELY IF ANY DISCREPANCIES ARE DISCOVERED.
- 4. ALL HARDWARE ASSEMBLE MANUFACTURER'S INSTRUCTIONS SHALL BE FOLLOWED EXACTLY AND SHALL SUPERSEDE ANY CONFLICTING NOTES ENCLOSED HEREIN.
- 5. ALL MATERIALS AND EQUIPMENT FURNISHED SHALL BE NEW AND OF GOOD QUALITY, FREE FROM FAULTS AND DEFECTS AND IN CONFORMANCE WITH THE CONTRACT DOCUMENTS. ANY AND ALL SUBSTITUTIONS MUST BE PROPERLY APPROVED AND AUTHORIZED IN WRITING BY THE OWNER AND ENGINEER PRIOR TO INSTALLATION. CONTRACTOR SHALL FURNISH SATISFACTORY EVIDENCE AS TO THE KIND OF QUALITY OF THE MATERIALS AND EQUIPMENT BEING SUBSTITUTED.
- 6. CONTRACTOR TO REFER TO THE MOUNT ANALYSIS AND CONCEALMENT DRAWINGS BY OTHERS FOR THIS PROJECT.

### **FINISH NOTES:**

TOWER- GALVANIZED TOWER MOUNTS- GALVANIZED

ANTENNA- NEUTRAL (MANUFACTURER FINISH)

FOUNDATIONS- UNPAINTED CONCRETE

ICE BRIDGE- GALVANIZED CABLES- BLACK

BASE CABINETS/EQUIPMENT- NEUTRAL (MANUFACTURER FINISH)

TOWER LOADING SUMMARY				
EXISTING	REMOVE	EQUIPMENT	ADD	TOTAL
3	3	ANTENNA	6	6
3	3	TMA	0	0
0	0	RADIOS	6	6
6	0	COAX	0	6
0	0	HYBRIDS	3	3





SBA COMMUNICATIONS CORP. 5900 BROKEN SOUND PKWY NW BOCA RATON, FL 33487



LOCATION:

162 MATTIE RIDGELL LN LILLINGTON, NC 27546

LILLINGTON

NC14882-A-01

T-MOBILE:

SOUTH LILLINGTON

5RA0183A


ITE TYPE:

190' FLAG POLE T-MOBILE ANCHOR

REV	DATE	DATE DESCRIPTION			
0	7/17/22	FOR CONSTRUCTION			
1	11/30/22	FOR CONSTRUCTION			
2	12/8/22	JX REV. 2			
3	12/12/22	FULL CANISTER EXPANSION			
SI	SITE COORDINATES				
LA	LAT: 35.379786				
LC	LONG: -78.820025				
DRAWN: RSW					
CHECKED: PWM					



JOB#: 22SBATNCM-0042

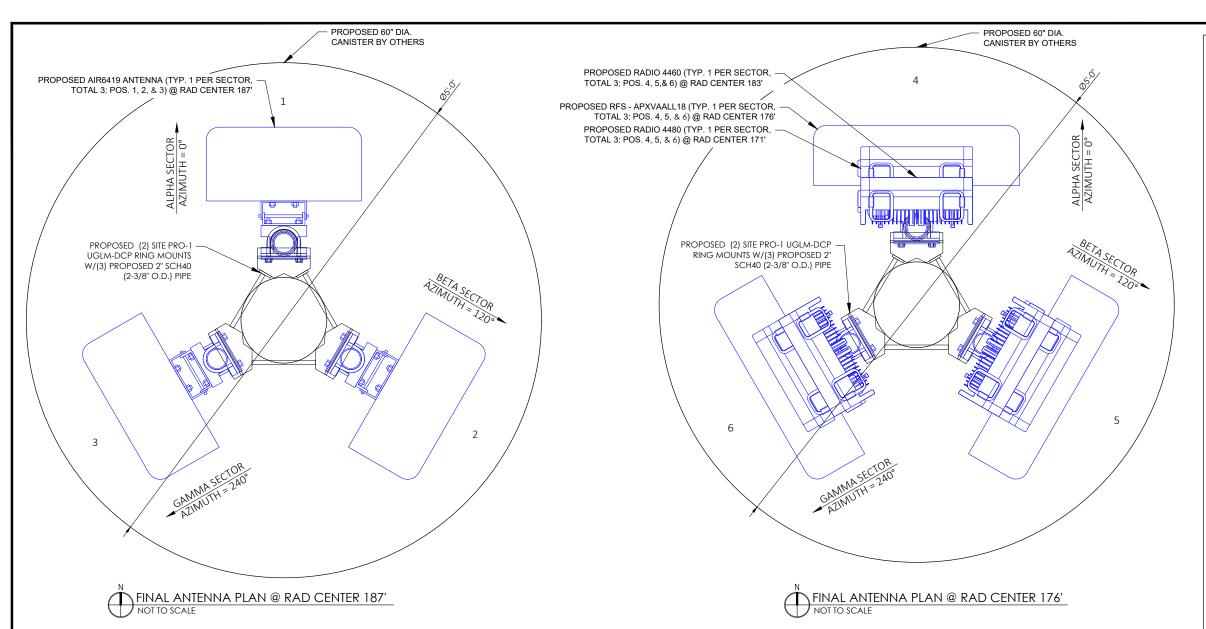

**RADIO MODEL** 

ALPHA	1	<b>0</b> °	ERICSSON - AIR6419 B41 (MASSIVE MIMO) (P)	-	(2) COAX CABLES 1-5/8" (E) (DISCONNECTED)
BETA	2	120°	ERICSSON - AIR6419 B41 (MASSIVE MIMO) (P)	-	(2) COAX CABLES 1-5/8" (E) (DISCONNECTED)
GAMMA	3	240°	ERICSSON - AIR6419 B41 (MASSIVE MIMO) (P)	-	(2) COAX CABLES 1-5/8" (E) (DISCONNECTED)
-	-	-		-	-
ALPHA	4	0°	RFS - APXVAALL18_43-U-NA20 (OCTO) (P)	(1) RADIO 4460 B25 + B66 (P @183') (1) RADIO 4480 B71 + B85 (P @171')	(1) 6X24 HCS 4AWG 70M (229') (P)
BETA	5	120°	RFS - APXVAALL18_43-U-NA20 (OCTO) (P)	(1) RADIO 4460 B25 + B66 (P @183') (1) RADIO 4480 B71 + B85 (P @171')	(1) 6X24 HCS 4AWG 70M (229') (P)
GAMMA	6	240°	RFS - APXVAALL18_43-U-NA20 (OCTO) (P)	(1) RADIO 4460 B25 + B66 (P @183') (1) RADIO 4480 B71 + B85 (P @171')	(1) 6X24 HCS 4AWG 70M (229') (P)
-	-	-		-	
	1	1			

**ANTENNA MODEL** 

-PROPOSED ANTENNA SCHEDULE

SECTOR | MARK | AZIMUTH

### ANTENNA NOTE

CABLE DESCRIPTION

CONTRACTOR TO ROTATE THE ANTENNAS AND OR MOUNTS TO OBTAIN NEW AZIMUTHS. REFER TO FINAL RF DOCUMENTS TO CONFIRM NEW AZIMUTHS

(E)- EXISTING (P) - PROPOSED

GC TO PROVIDE POST CONSTRUCTION DOCUMENTATION ON ALL ANTENNA AZIMUTHS AND COLOR CODING FOR CABLES.

### EQUIPMENT NOTES

- THE HYBRID CABLE LENGTH SHOWN IS ONLY AN ESTIMATE AND SHOULD NOT BE USED FOR ORDERING MATERIALS. CONFIRM THE REQUIRED HYBRID CABLE LENGTH WITH T-MOBILE PRIOR TO ORDERING OR INSTALLATION.
- 2. THE CONTRACTOR SHALL TEST THE OPTICAL FIBER AFTER INSTALLATION IN ACCORDANCE WITH T-MOBILE STANDARDS AND SUPPLY THE RESULTS TO T-MOBILE.
- THE CONTRACTOR SHALL
  CONFIRM THE TOWER TOP
  EQUIPMENT LIST ABOVE WITH THE
  FINAL T-MOBILE RFDS PRIOR TO
  INSTALLATION.
- 4. ALL PROPOSED ANTENNA
  CABLES SHALL BE COLOR
  CODED PER T-MOBILE MARKET
  STANDARDS.
- 5. REFER TO ERICSSON EQUIPMENT INSTALLATION STANDARDS FOR ADDITIONAL INFORMATION.
- 6. REFER TO EQUIPMENT
  MANUFACTURER'S
  SPECIFICATION SHEETS FOR
  ADDITIONAL INFORMATION NOT
  LISTED ABOVE.
- 7. CONTRACTOR TO FIELD
  COORDINATE EXACT LOCATION
  OF PROPOSED EQUIPMENT WITH
  EXISTING CONDITIONS ON SITE.
- 8. PROPOSED EQUIPMENT SHALL BE INSTALLED PER MANUFACTURER'S SPECIFICATIONS. ALL HARDWARE FASTENERS SHALL BE HIGH STRENGTH (A325, A36)
- 9. DRILLING OF EXISTING STEEL MEMBERS IS NOT PERMITTED.
- 10. BOND PROPOSED EQUIPMENT TO EXISTING SECTOR GROUND BAR PER MANUFACTURER'S SPECIFICATIONS. PROVIDE ADDITIONAL SECTOR GROUND BARS AS REQUIRED.
- 11. ALL ANTENNAS, CABLES, AND MOUNTS SHALL BE INSTALLED IN ACCORDANCE WITH THE ENGINEER'S RECOMMENDATIONS IN A MANNER CONSISTENT WITH THE STRUCTURAL ANALYSIS REPORT.
- 12. CONTRACTOR TO CONTACT T-MOBILE FOR UP-TO-DATE RF DESIGN DATA. NOTIFY ENGINEER IF CONFLICT EXISTS.

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SBA COMMUNICATIONS CORP. 5900 BROKEN SOUND PKWY NW BOCA RATON, FL 33487



LOCATION:

162 MATTIE RIDGELL LN LILLINGTON, NC 27546

LILLINGTON NC14882-A-01

T-MOBILE:

SOUTH LILLINGTON

5RA0183A

SITE TYPE:

190' FLAG POLE T-MOBILE ANCHOR

REV	DATE	DESCRIPTION
0	7/17/22	FOR CONSTRUCTION
1	11/30/22	FOR CONSTRUCTION

SITE COORDINATES
LAT: 35.379786

LONG: -78.820025

DRAWN: RSW
CHECKED: PWM

JOB#: 22SBATNCM-0042



ANTENNA
ORIENTATION &
CABLE SCHEDULE

### PROPOSED RF CONFIGURATION: 67E5D998E ODE+6160

DIAGRAM NOT PROVIDED SEE

RFDS PLUMBING DIAGRAM SCALE: NOT TO SCALE

### **Coax Color Coding**

☐ Antennas will be labeled (back of antenna view) Right to left 1 · X ports Coax/Jumper lines will be identified by sector color and by number of bands around the coax/jumper



### ANTENNA #1 ANTENNA #2 ANTENNA #3 ANTENNA #4 XX EXAMPLE: COAX WITH FOUR BANDS OF

FRONT OF THE ANTENNA

RED TAPE WILL REPRESENT ALPHA SECTOR AND THE 4TH PORT OF ANTENNA

### COLOR CODING NOTES:

color FIBER CABLE

TAG #2

### color GSM color UMTS 1900 color UMTS AWS color LTE

COAX COLOR CODING 2) SCALE: NOT TO SCALE

Breakout DC

conductors (6 pairs, 6AWG), w/shrink cap on tips

0.5 m

0.2 m

4AWG

Conductor

pairs (6)

2 m

Cable Assembly Lenath

### METALLIC TAG NOTES:

- TWO METALLIC TAGS SHALL BE ATTACHED AT EACH END OF EVERY CABLE LONGER THAN (3) THREE FEET C. CABLE LESS THAN (3) THREE FEET WILL HAVE TWO METALLIC TAGS ATTACHED AT THE CENTER OF THE
- METALLIC TAGS ATTACHED AT THE CENTER OF THE CABLE.

  3. TAGS WILL BE FASTENED WITH STAINLESS STEEL ZIP TIES APPROPRIATE FOR CABLE DIAMETER.

  4. STANDARDIZED METALLIC TAG KIT WILL BE ASSEMBLED WITH TAGS ALREADY ENGRAVED TO ACCOMMODATE ALL CONFIGURATIONS.
- TAG #1

Color

coded

4x6 fiber

Bundle 4:

Fiber pairs

terminated

with LC plug,

protected with

dust cap

1180 mm\*

0.3 m

(see table above

for breakout

lengths/bundle)

50 mm diam., max→

Bulkhead fitting →

### TAG #2 TAG #1

- CABLE SCHEDULE

  ALL ANTENNAS SHALL BE FURNISHED WITH
  DOWNTH IT BRACKETS.
  CONTRACTOR SHALL COORDINATE
  REQUIRED MECHANICAL DOWNTH FOR
  REQUIRED MECHANICAL DOWNTH FOR
  ALCH ANTENNA WITH RE REGINHEER
  ANTENNA DOWNTH SHALL BE SET AND
  VERIFIED BY A SMART LEVEL
  CONTRACTOR SHALL INSTALL COLOR CODE
  RINGS ON EACH OF THE HORBID CABLES
  AND JUMPER CABLES WITH UV RESISTANT
  TAPE ALL CABLE SHALL BE MARKED AT
  TOP AND BOTTOM WITH 2" COLOR TAPE OR
  STENICH TAG COLOR TAPE MAY BE
  OBTAINED FROM GRAYBAR ELECTRONICS.

LOCATION:

162 MATTIE RIDGELL LN LILLINGTON, NC 27546

T - Mobile-

SBA COMMUNICATIONS CORP. 5900 BROKEN SOUND PKWY NW

BOCA RATON, FL 33487

SBA

LILLINGTON NC14882-A-01

T-MOBILE:

**SOUTH LILLINGTON** 

5RA0183A

SITE TYPE:


190' FLAG POLE T-MOBILE ANCHOR


		REV	DATE	DESCRIPTION
		0	7/17/22	FOR CONSTRUCTION
"6x24" Hybrid Cable System	NOTE:	1	11/30/22	FOR CONSTRUCTION
	ALL FIBER SPARES AT TOWER TOP TO BE			
	SEALED WITH SELF-AMALGAMATING			
γγγγγγγγγγγγγγγγγγγγγγγγγγγγγγγγγγγγ	SEALING TAPE.			
nairs hairs	DC CABLE SPLICES TO USE THIS SPLICE			
terminated w/ mm 0.8 m* 1.0 m*	AND SEALED WITH SELF-AMALGAMATING			
Color ODC plug,	SEALING TAPE FOLLOWED BY HEAT SHRINK TUBING.			
coded weatherproof	SHRINK TUBING.			
cap				
86 mm diam., Optical fiber and				
L=250 mm, DC conductor *Each subsequent				
max breakout pair in the bundle				
staggered in length to clear previous		SI	TE COORE	DINATES
n diam., max—  pair's connector				79786
		LC	DNG: -78.8	320025
Bottom Fiber Pigtail Lengths				
Bundle 1: 1000 mm*		DRAV	VN: RSW	
Bundle 2: 1060 mm*				
Bundle 3: 1120 mm*		CHEC	KED: PWM	1

22SBATNCM-0042 JOB#

> **PLUMBING DIAGRAM**

6X24 HCS 4AWG HYBRID CABLE, (6) DC PAIRS + (24) OPTICAL PAIRS (3) SCALE: NOT TO SCALE

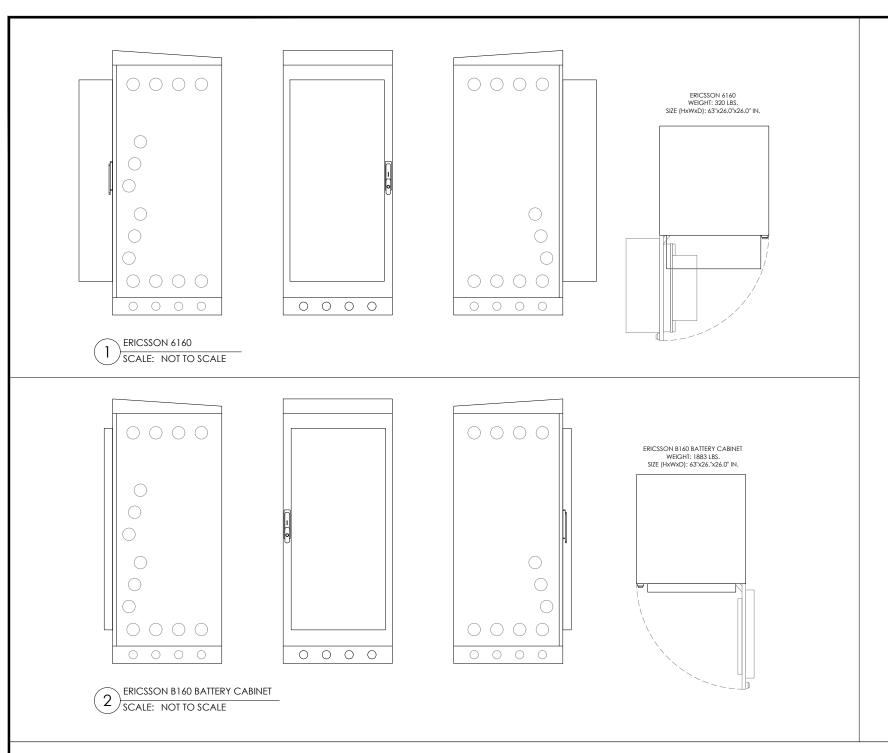

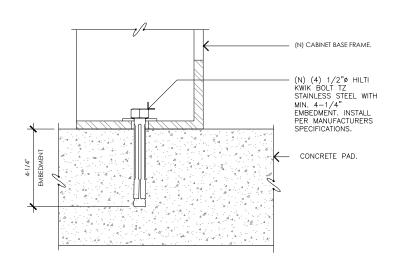

CABINET ANCHORAGE DETAIL SCALE: NOT TO SCALE

# T - Mobile-



SBA COMMUNICATIONS CORP. 5900 BROKEN SOUND PKWY NW BOCA RATON, FL 33487



LOCATION:

162 MATTIE RIDGELL LN LILLINGTON, NC 27546

LILLINGTON NC14882-A-01

T-MOBILE:

SOUTH LILLINGTON

5RA0183A

SITE TYPE:

190' FLAG POLE T-MOBILE ANCHOR

REV	DATE	DESCRIPTION
0	7/17/22	FOR CONSTRUCTION
1	11/30/22	FOR CONSTRUCTION
	·	

SITE COORDINATES LAT: 35.379786 LONG: -78.820025

DRAWN: RSW CHECKED: PWM

JOB#: 22SBATNCM-0042

CONSTANT VOLTAGE CHARGING IS RECOMMENDED RECOMMENDED FLOAT VOLTAGE: 2.27 +/- 0.02 VPC

	SPECIFICATIONS										
CAPACITY (AH)					NOMINAL DIMENSIONS					NOMINAL	
MODEL NUMBER VOLTA	VOLTAGE	8 HR TO 1.75 VPC	10 HR TO 1.8 VPC	INCHES			MILLIMETERS			WEIGHT	
		@ 25°	@ 25°	Α	В	С	Α	В	С	LBS	Kg
NSB 190FT RED BATTERY	12	183 / 186 AH	187 / 190 AH	22.0	4.9	12.6	560	125	320	124.3	56.3

NORTHSTAR - NSB 190FT RED BATTERY 3) SCALE: NOT TO SCALE

ELECTRICAL DATA					
MODEL NUMBER	SHORT CIRCUIT CURRENT	INTERNAL RESISTANCE (mOhms)			
NSB 190FT RED BATTERY	5000 A	2.8			

CHAPTER 12, SECTION 1206

TOTAL BATTERY WEIGHT (12 BATTERIES):

ELECTRICAL ENERGY STORAGE SYSTEM						
1206.2 SC	OPE:					
STATIONARY STORAGE BATTERY SYSTEMS HAVING CAPACITIES EXCEEDING THE VALUES SHOWN IN TABLE 1206.2 SHALL COMPLY W/ SECTION 1206.2.1 THROUGH 1206.2.12.6, AS APPLICABLE.						
BATTERY STORAGE SYSTEM THRESHOLD QTY'S						
CATTE	RY TECHNO	DLOGY	CAPACITY ALLOWED			
LEAD	ACID, ALL	TYPES	70 kWh (252 MEGAJOULES)			
AH = VOLTAGE (AH)/1000						
VOLTS	АН		kWh	NO. OF BATTERIES	TOTAL kWh	
12	190	1000	2.28	12	27.36	
CONCLU	SIONS:					
27.36	<	70 kWh	SECTION	1206.2 DO	S NOT APPLY	

TOTAL GALLONS - ELECTROLYTE & ACID (12 BATTERIES): 33.36


LL COMPLY	NSB 190FT RED BA	TTERY LEAD &	ACID WEIGHTS (12-	VOLT MODULE):
ICABLE.		WEIGHT	/KG	10.5
r's	ELECTROLYTE	WEIGHT	/LBS	23.2
.OWED	LLLCIKOLIIL	VOLUME /LITERS		7.8
		VOLUME	/GALLONS	2.08
(AJOULES)		WEIGHT	/KG	4.8
	ACID	WEIGHI	/LBS	10.5
TOTAL kWh	ACID	VOLUME	/LITERS	2.6
TOTAL KITTI		VOLUME	/GALLONS	0.7
27.36	LEAD	WEIGHT	/KG	17.9
	LEAD	WEIGHI	/LBS	39.4
S NOT APPLY	LEAD OXIDE	VOLUME	/KG	23.3
	LEAD OXIDE	VOLUME	/LBS	51.2
1,491.6 LBS	TOTAL WEIGHT	WEIGHT	/KG	56.3
ES): 33.36	TOTAL WEIGHT	WEIGHT	/LBS	124.3
	•			

### **BATTERY CABINET NOTE**

THE BATTERIES INSTALLED IN THE CABINET ARE VALVE REGULATED LEAD-ACID (VRLA) CELLS BATTERY STRINGS; NORTHSTAR NSB 190FT RED. ALL NORTHSTAR BATTERIES ARE COMPLIANT WITH: TELCORDIA SR4228, IEC 60896; BELLCORE GR-63-CORE, ISSUE 1; UL APPROVED AND UN2800 CERTIFIED. NORTHSTAR IS REGISTERED TO ISO 9001 AND ISO 14001. ERICSSON CABINET PROVIDES REQUIRED VENTILATION, SMOKE, SEISMIC & ADDITIONAL SIGNAGE TO MEET ALL IFC SECTION 608 REQUIREMENTS.




**ANTENNA SPECS** 

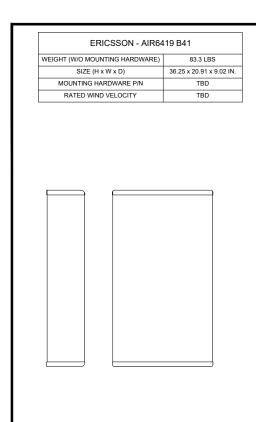

ERICSSON - AIR6419 B41

SCALE: NOT TO SCALE

RFS - APXVAALL18_43-U-NA20				
WEIGHT (W/O MOUNTING HARDWARE)	93 LBS			
SIZE (H x W x D)	72 x 24 x 8.5 IN.			
MOUNTING HARDWARE P/N	APM40-5E			
RATED WIND VELOCITY	150 MPH			

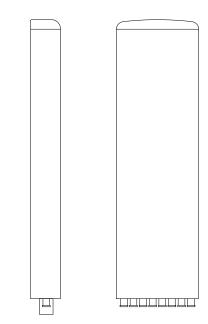


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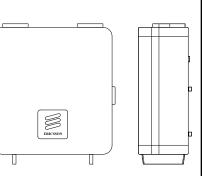
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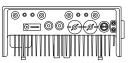
NOT USED 3) SCALE: NOT TO SCALE

**ERICSSON BASEBAND 6630** 

ERICSSON - RADIO 4480 B71+B85 WEIGHT (W/O MOUNTING HARDWARE) 21.8 x 15.4 x 7.5 SIZE (HxWxD)







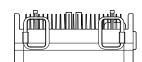


ERICSSON RADIO 4480 B71+B85 (4) SCALE: NOT TO SCALE

ERICSSON - RADIO 4460 B25+B66 WEIGHT (W/O MOUNTING HARDWARE) 17.0 x 15.1 x 11.9

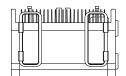

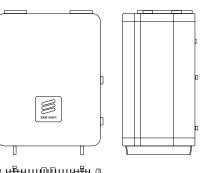

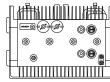

ERICSSON RADIO 4460 B25+B66 SCALE: NOT TO SCALE

T - Mobile-SBA COMMUNICATIONS CORP. 5900 BROKEN SOUND PKWY NW BOCA RATON, FL 33487



LOCATION:

162 MATTIE RIDGELL LN LILLINGTON, NC 27546

LILLINGTON NC14882-A-01 T-MOBILE:


SOUTH LILLINGTON


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SITE TYPE:


190' FLAG POLE T-MOBILE ANCHOR


	REV	DATE	DESCRIPTION
	0	7/17/22	FOR CONSTRUCTION
	1	11/30/22	FOR CONSTRUCTION
ITPUT 2	2	12/8/22	JX REV. 2
1			
<b>′</b>			



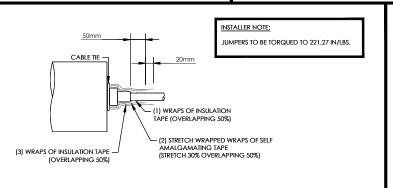

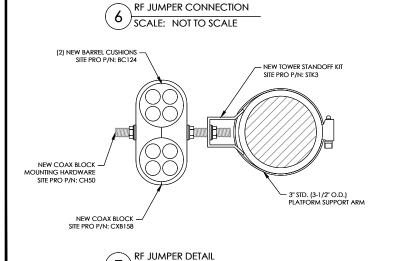SCALE: NOT TO SCALE

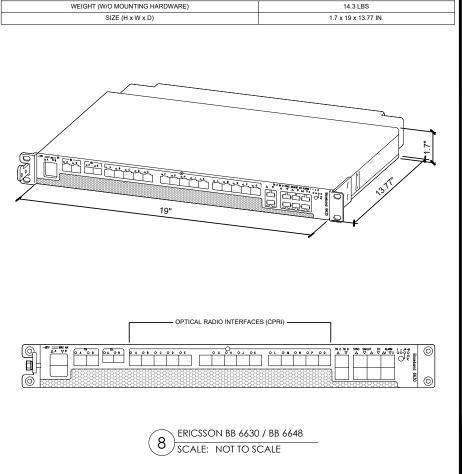

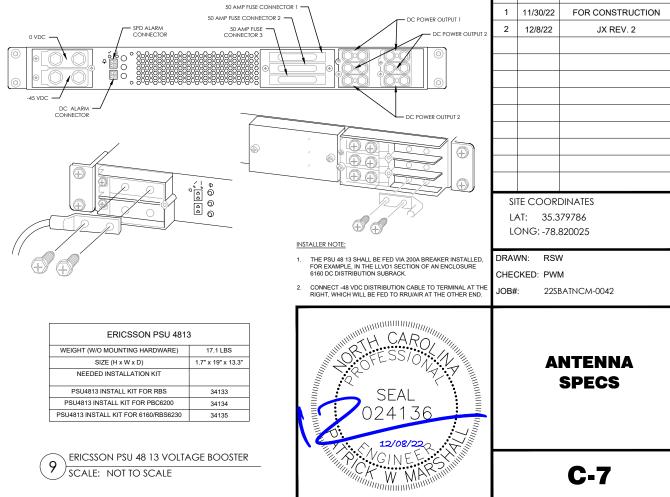

### -EQUIPMENT NOTES-

### **DEMO NOTES:**


- 1. REWORK ALL TERMINATION, ELECTRICAL CONNECTORS, CONDUCTORS, CONDUITS, ETC., TO FACILITATE NEW WORK.
- VERIFY LOCATION IN THE FIELD OF ALL UNDERGROUND UTILITIES PRIOR TO EXCAVATING. COORDINATE WITH PUBLIC UTILITIES AS NECESSARY TO COMPLETE REQUIRED WORK AS INDICATED IN THE CONTRACT DOCUMENTS. THE CONTRACTOR SHALL BE RESPONSIBLE FOR THE REPAIR / REPLACEMENT OF ALL DAMAGED UTILITIES AT THE EXPENSE OF THE CONTRACTOR.
- 3. DEMOLITION IS INCLUDED TO GIVE A COMMON BASIS FOR QUOTATIONS AND MAY NOT SHOW EVERY ITEM TO BE DEMOLISHED. IT IS THE CONTRACTOR'S RESPONSIBILITY TO VISIT THE SITE TO DETERMINE THE EXACT EXTENT OF WORK, COORDINATION, DEMOLITION, TEMPORARY FACILITIES, UTILITIES, ETC. NECESSARY TO COMPLETE THE PROJECT AS INDICATED ON THE CONTRACT DOCUMENTS.
- 4. PROTECT NETWORK EQUIPMENT, RECTIFIERS, FIBER CABLE, RACEWAYS, UTILITIES, BUILDING SYSTEMS, ETC. FROM DAMAGE.
- EQUIPMENT DESIGNATED TO BE RELOCATED SHALL BE CLEANED, STORED AND PROTECTED FROM DAMAGE UNTIL
  REINSTALLED. REPLACE ALL EQUIPMENT DAMAGED DURING RELOCATING.
- 6. PROVIDE TEMPORARY POWER TO ALL ESSENTIAL SYSTEMS AS REQUIRED TO FACILITATE DEMOLITION. PROVIDE TEMPORARY COOLING UNITS AS REQUIRED.
- 7. MAINTAIN CIRCUIT CONTINUITY TO EXISTING CIRCUITS AND EQUIPMENT TO REMAIN OR TO BE RELOCATED.
- 8. WHERE ALLOWED BY CODE IT IS PERMISSIBLE TO REUSE EXISTING CONDUIT. PROVIDE NEW CONDUIT AND CONDUCTORS FOR NEW CIRCUITS AND THE EXTENSION OF EXISTING CIRCUITS.
- 9. PROVIDE EQUIPMENT PROTECTION ABOVE ALL NETWORK EQUIPMENT (INCLUDING BUT NOT LIMITED TO CABLING, BUS, CABLE TRAY, EQUIPMENT BAYS, RECTIFIERS, BATTERIES, INVERTERS, DISTRIBUTION PANELS, ETC.) WHEN WORKING ABOVE ALL EQUIPMENT. ALL PROTECTION SHALL BE COORDINATED WITH THE SWITCH MANAGER TO ENSURE THAT THE PROTECTION WILL NOT BLOCK ACCESS TO EQUIPMENT OR CAUSE OVERHEATING. PROVIDE TEMPORARY COOLING AS REQUIRED.
- 10. PROVIDE APPROPRIATE SEALING AND PATCHING OF ANY BUILDING PENETRATIONS AFTER REMOVAL OF ELECTRICAL DEVICES, EQUIPMENT, ETC. MATCH EXISTING WALLS. SEE ARCHITECTURE.


### **GENERAL NOTES:**

- 1. IT IS CONTRACTOR'S RESPONSIBILITY TO VISIT THE SITE & DETERMINE THE EXACT EXTENT OF WORK, COORDINATION, DEMOLITION, TEMPORARY FACILITIES, UTILITIES, ETC. NECESSARY TO COMPLETE THE PROJECT AS INDICATED ON THE CONTRACT DOCUMENTS.
- 2. VERIFY LOCATION IN THE FIELD OF ALL UNDERGROUND UTILITIES PRIOR TO EXCAVATING. COORDINATE WITH PUBLIC UTILITIES AS NECESSARY TO COMPLETE REQUIRED WORK AS INDICATED IN THE CONTRACT DOCUMENTS. THE CONTRACTOR SHALL BE RESPONSIBLE FOR THE REPAIR/REPLACEMENT OF ALL DAMAGED UTILITIES AT THE EXPENSE OF THE CONTRACTOR.
- 3. PROVIDE SEPARATE INSULATED GROUNDING CONDUCTOR IN ALL FEEDER & BC.
- 4. PROVIDE 2-HOLE LUGS CAPABLE OF ACCEPTING MULTIPLE CRIMPS FOR ALL POWER & GROUNDING CONNECTIONS TO A BUS OR WHERE FEASIBLE. USE MANUFACTURER'S COMPRESSION TOOL WITH PROPER DIE FOR EACH CONNECTOR. MANUFACTURER'S EMBOSSED CODING SYSTEM IS REQUIRED. A UNIVERSAL OR DIE-LESS TYPE CRIMPING TOOL SHALL NOT BE USED. PROVIDE LUGS WITH INSPECTOR HOLE FOR ALL INTERIOR INSTALLATIONS. PROVIDE CLOSED LUGS (NO INSPECTION HOLE) FOR EXTERIOR OR UNDERGROUND CONNECTIONS.
- 5. FEEDER CIRCUITS, GROUND LEADS, & DEDICATED EQUIPMENT CIRCUITS SHALL NOT BE SPLICED.
- 6. VERIFY LASHING REQUIREMENTS FOR SERVICE ENTRANCE & MAIN DISTRIBUTION EQUIPMENT WITH MANUFACTURER. INSTALL LASHING PER MANUFACTURER'S REQUIREMENTS.

### **COMPRESSION LUG NOTES:**

REFER TO SPECIFICATION SECTION 260519 & NSTD516 REGARDING REQUIREMENTS FOR A SAMPLE COMPRESSION LUG SUBMITTAL ON ALL PROJECTS. FAILURE TO PROVIDE CORRECT LUGS & SUBMIT A SAMPLE COMPRESSION LUG TO VZW PRIOR TO INSTALLATION OF ANY LUGS MAY RESULT IN REJECTION OF THE INSTALLATION & REPLACEMENT OF ALL LUGS & ASSOCIATED CABLE, WHERE REQUIRED, AT NO COST TO VZW.

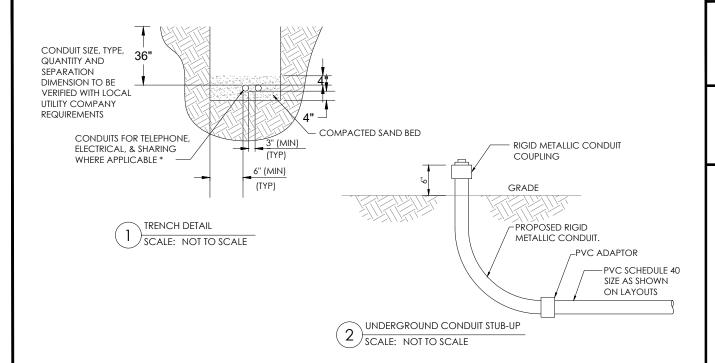

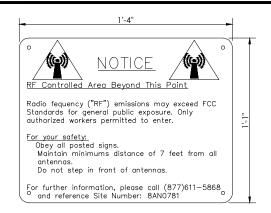

RF NOTICE SIGN HITE METAL SIGN W/ BLACK LETTERING)



EMERGENCY SIGN RED METAL SIGN W/ WHITE LETTERING) **T** - Mobile-



SBA COMMUNICATIONS CORP. 5900 BROKEN SOUND PKWY NW



LOCATION:

162 MATTIE RIDGELL LN LILLINGTON, NC 27546

LILLINGTON
NC14882-A-01

**SOUTH LILLINGTON** 

5RA0183A

SITE TYPE:

190' FLAG POLE T-MOBILE ANCHOR

	T-MOBILE ANCHOR				
REV	DATE	DESCRIPTION			
0	7/17/22	FOR CONSTRUCTION			
1	11/30/22	FOR CONSTRUCTION			
CI.	TE COOPI	DINIATES			

SITE COORDINATES LAT: 35.379786 LONG: -78.820025

DRAWN: RSW CHECKED: PWM


SIGNS TO BE PROVIDED AND INSTALLED BY CONTRACTOR.

· SIGNS TO BE INSTALLED AT ROOFTOP ENTRANCE OR ANY OTHER MANDATED AREA

JOB#: 22SBATNCM-0042

**EQUIPMENT NOTES** 

E-1

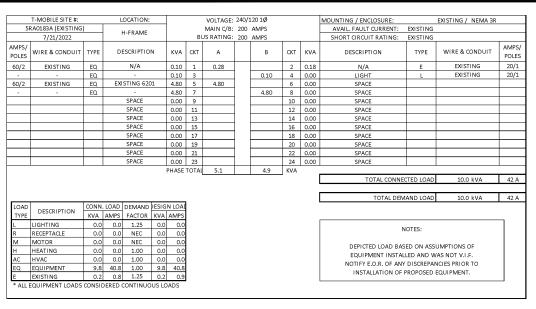


EXISTING PANEL SCHEDULE

SCALE: NOT TO SCALE

	T-MOBILE SITE #:		LOCATION:			VOLTAGE:	240/	120 1Ø			MOUNTING / ENCLOSURE:		EXISTING / NEMA 3R	
5R	A0183A (PROPOSED	)	H-FRAME			MAIN C/B:	200	AMPS			AVAIL. FAULT CURRENT:	EXISTING		
	7/21/2022		TI-T TOATVIL		В	US RATING:	200	AMPS			SHORT CIRCUIT RATING:	EXISTING		
AMPS/ POLES	WIRE & CONDUIT	TYPE	DESCRIPTIO	N KVA	скт	Α		В	СКТ	KVA	DESCRIPTION	TYPE	WIRE & CONDUIT	AMPS
60/2	EXISTING	EQ	N/A	0.10	1	0.28			2	0.18	N/A	E	EXISTING	20/:
-	-	EQ	-	0.10	3			0.10	4	0.00	LIGHT	L	EXISTING	20/:
100/2	3#3, 1#8G, 1"C	EQ	EXISTING 62	01 5.80	5	9.80			6	4.00	(P) 6160	EQ	2#3/0, 1#6G, 2"C	150,
-		EQ	-	5.80	7			9.80	8	4.00	SPACE	EQ	-	
			SPACE	0.00	9				10	0.00	SPACE	EQ		-
			SPACE	0.00	11				12	0.00	SPACE	EQ		
			SPACE	0.00	13	0.18			14	0.18	(P) 6160 GFI	R	2#12, 1#12G, 1/2"C	20/
			SPACE	0.00	15				16	0.00	SPACE			
			SPACE	0.00	17				18	0.00	SPACE			
			SPACE	0.00	19				20	0.00	SPACE			
			SPACE	0.00	21				22	0.00	SPACE			
			SPACE	0.00	23				24	0.00	SPACE			
				PHASE	TOTAL	10.3		9.9	KVA					
											TOTAL CONNE	CTED LOAD	20.2 kVA	84
											TOTAL DEM	AND LOAD	20.2 kVA	84
LOAD TYPE	DESCRIPTION		LOAD DEMAND AMPS FACTOR	KVA AMPS										
L	LIGHTING	0.0	0.0 1.25	0.0 0.0	-									
R	RECEPTACLE	0.2	0.8 NEC	0.2 0.8	-							NOTES:		
М	MOTOR	0.0	0.0 NEC	0.0 0.0										
н	HEATING	0.0	0.0 1.00	0.0 0.0	1						DEPICTED LOAD BAS			
	HVAC	0.0	0.0 1.00	0.0 0.0	1						EQUIPMENT INSTAL			
AC					1						NOTIFY E.O.R. OF ANY DISCREPANCIES PRIOR TO			
_	EQUIPMENT	19.8	82.5 1.00	19.8 82.5	4						INSTALLATION OF			

PROPOSED PANEL SCHEDULE
SCALE: NOT TO SCALE

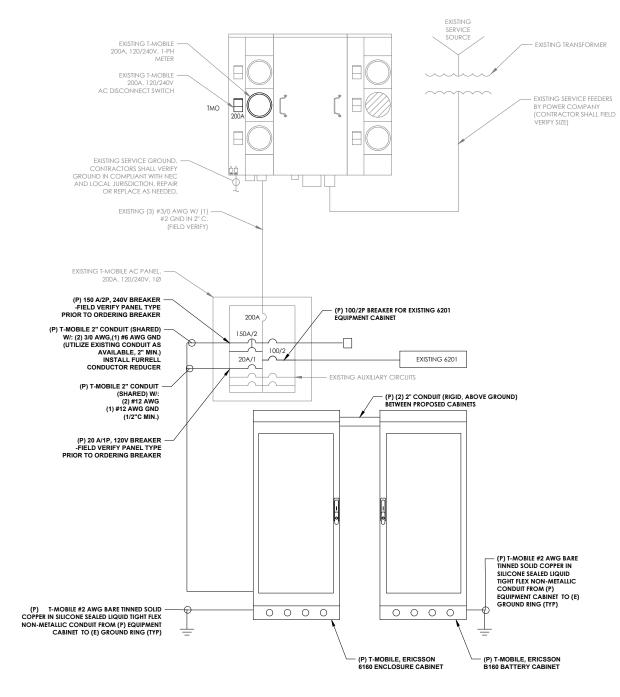

ONE-LINE DIAGRAM
SCALE: NOT TO SCALE

### GENERAL ELECTRICAL NOTES

- 1. NO SITE SPECIFIC LOAD STUDY WAS ACQUIRED. DEMAND LOADING KVA SHOWN AS ASSUMPTIONS PER MANUFACTURER SPECIFICATION DOCUMENTS & INDUSTRY STANDARD. WHEN OVERAGES ARE VERIFIED ON SITE, ALL DISCREPANCY SHALL BE BROUGHT TO THE ENGINEER OF RECORD PRIOR TO COMMENCING WORK.
- 2. ELECTRICAL SERVICE SHALL BE 200A, 240/120v, 1 P, 3W
- 3. FOR COMPLETE INTERNAL WIRING AND ARRANGEMENT, REFER TO VENDER PRINTS PROVIDED BY EQUIPMENT MANUFACTURER.
- 4. CONTRACTOR SHALL VERIFY AVAILABLE FAULT CURRENT WITH POWER COMPANY AND ENSURE ALL ELECTRICAL EQUIPMENT IS SUITABLE FOR AVAILABLE FAULT CURRENT.CONTRACTOR SHALL COORDINATE WITH UTILITY COMPANY AND CALCULATE SHORT CIRCUIT FAULT CURRENT AND ARC FLASH AND PROVIDE LABELS ON ELECTRICAL EQUIPMENT PER THE N.E.C. AND LOCAL JURISDICTION. CONTRACTOR SHALL PROVIDE EQUIPMENT RATED FOR FAULT CURRENT.
- 5. CONTRACTOR SHALL COORDINATE UTILITY SERVICES WITH LOCAL UTILITY COMPANIES. VERIFY ALL REQUIREMENTS WITH UTILITY COMPANY STANDARDS. THE MAXIMUM 12-MONTH DEMAND LOAD WAS NOT AVAILABLE AT TIME OF PRINTING. CONTRACTOR SHALL COORDINATE WITH POWER CO., OBTAIN MAXIMUM DEMAND LOAD, MULTIPLY VALUE BY 1.25, ADD ALL NEW LOADS & VERIFY NEW MAXIMUM DEMAND LOAD DOES NOT OVERLOAD ANY PORTION OF THE EXISTING ELECTRICAL SYSTEM. CONTACT EOR IF OVERLOAD IS POSSIBLE BEFORE START OF WORK.
- 6. ONE-LINE DIAGRAM IS SCHEMATIC ONLY AND NOT INDICATIVE OF ACTUAL EQUIPMENT LAYOUT. CONTRACTOR IS RESPONSIBLE FOR LOADING ON ALL PANELS AND FEEDERS PER THE N.E.C. CONTRACTOR SHALL ENSURE CONTINUITY OF EXISTING CIRCUITS TO REMAIN. ELECTRICAL CONTRACTOR SHALL VERIFY THAT ALL EXISTING AND PROPOSED LOADS PLACED ON EXISTING PANELS DO NOT EXCEED THE MAXIMUM LOADING REQUIRED PER THE LATEST EDITION OF THE N.E.C. NOTIFY EOR IF OVERLOAD IS POSSIBLE
- 7. 6230 ENCLOSURE CONFIGURATION INCLUDES (6) 3500W RECTIFIERS. LOAD PROVIDED IN PANEL SCHEDULE IS BASED ON THIS CONFIGURATION PLUS ADDITIONAL (1) PRE-WIRED CIRCUITS. IF ADDITIONAL RECTIFIERS ARE REQUIRED, ENGINEER OF RECORD SHALL BE CONTACTED TO DETERMINE ADEQUACY OF EXISTING PANEL FOR ADDITIONAL LOAD
- 8. CONTRACTOR SHALL FIELD VERIFY EXISTING AC PANEL MODEL AND ENSURE SUFFICIENT BREAKER SPACE IS AVAILABLE. CONTACT EOR IF DISCREPANCIES ARE FOUND.
- 9. CONTRACTOR TO FIELD VERIFY ALL EQUIPMENT RATINGS AND WIRE SIZES. IF ANY DISCREPANCIES EXIST, CONTACT ENGINEER PRIOR TO ROUGH IN.



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SBA COMMUNICATIONS CORP. 5900 BROKEN SOUND PKWY NW BOCA RATON, FL 33487



LOCATION:

162 MATTIE RIDGELL LN LILLINGTON, NC 27546

LILLINGTON NC14882-A-01

T-MOBILE:

SOUTH LILLINGTON

5RA0183A

SITE TYPE:

190' FLAG POLE T-MOBILE ANCHOR

REV	DATE	DESCRIPTION
0	7/17/22	FOR CONSTRUCTION
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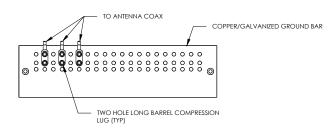
SITE COORDINATES LAT: 35.379786 LONG: -78.820025

DRAWN: RSW CHECKED: PWM

JOB#: 22SBATNCM-0042


PANEL SCHEDULE & ONE-LINE DIAGRAM

**E-2** 




- DOUBLING UP "OR STACKING" OF CONNECTIONS IS NOT PERMITTED.
   EXTERIOR ANTIOXIDANT JOINT COMPOUND TO BE USED ON ALL EXTERIOR CONNECTIONS.
   GROUND BAR SHALL NOT BE ISOLATED FROM TOWER. MOUNT DIRECTLY TO TOWER STEEL.

### ANTENNA GROUND BAR DETAIL SCALE: NOT TO SCALE

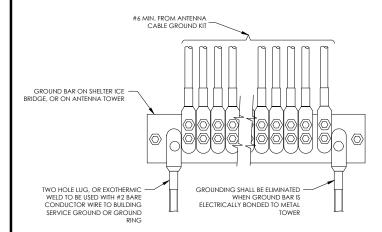


### GROUNDWIRE INSTALLATION SCALE: NOT TO SCALE

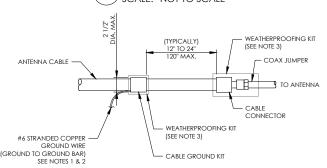


- DO NOT INSTALL CABLE GROUND KIT AT A BEND AND ALWAYS DIRECT GROUND WIRE DOWN TO GROUND BAR.
   GROUND BAR.
   GROUNDING KIT SHALL BE TYPE AND PART NUMBER AS SUPPLIED OR RECOMMENDED BY CABLE MANUFACTURER.
- WEATHER PROOFING SHALL BE TWO-PART TAPE KIT, COLD SHRINK SHALL NOT BE USED.

CABLE GROUND KIT CONNECTION SCALE: NOT TO SCALE

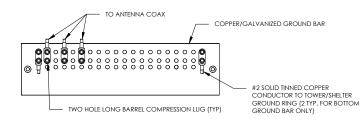


- EXTERIOR ANTIOXIDANT JOINT COMPOUND TO BE USED ON ALL EXTERIOR CONNECTIONS.
   GROUND BAR SHALL NOT BE ISOLATED FROM TOWER. MOUNT DIRECTLY TO TOWER STEEL (TOWER ONLY).
   GROUND BAR SHALL BE ISOLATED FROM BUILDING OR SHELTER.

### TOWER/SHELTER GROUND BAR DETAIL SCALE: NOT TO SCALE

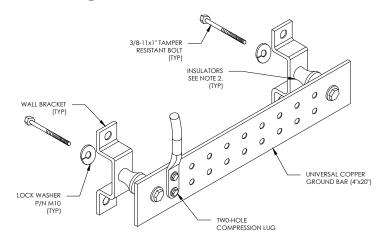


- 1. DOWN LEAD (HOME RUN) CONDUCTORS ARE NOT TO BE INSTALLED ON CROWN CASTLE USA INC. TOWER, PER THE GROUNDING DOWN CONDUCTOR POLICY QAS-STD-10091. NO MODIFICATION OR DRILLING TO TOWER STEEL IS ALLOWED IN ANY FORM OR FASHION, CAD-WELDING ON THE TOWER AND/OR
- 2. OMIT INSULATOR WHEN MOUNTING TO TOWER STEEL OR PLATFORM STEEL USE INSULATORS WHEN ATTACHING TO BUILDING OR SHELTERS.

### GROUND BAR DETAIL SCALE: NOT TO SCALE

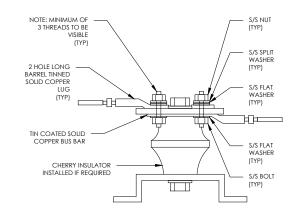





WIRE SIZE	BURNDY LUG	BOLT SIZE
#6 GREEN INSULATED	YA6C-2TC38	3/8" - 16 NC SS 2 BOLT
#2 SOLID TINNED	YA3C-2TC38	3/8" - 16 NC SS 2 BOLT
#2 STRANDED	YA2C-2TC38	3/8" - 16 NC SS 2 BOLT
#2/0 STRANDED	YA26-2TC38	3/8" - 16 NC SS 2 BOLT
#4/0 STRANDED	YA28-2N	1/2" - 16 NC SS 2 BOLT

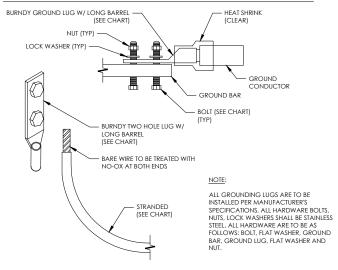


### MECHANICAL LUG CONNECTION 3) SCALE: NOT TO SCALE

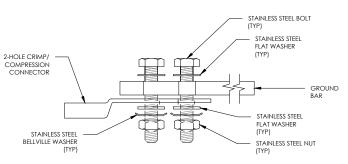

### SINGLE CONNECTOR AT GROUND BARS

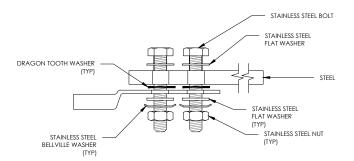

### SINGLE CONNECTOR AT STEEL OBJECTS

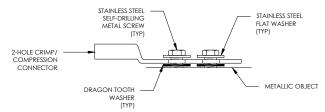

SINGLE CONNECTOR AT METALLIC/STEEL OBJECTS

HARDWARE DETAIL FOR EXTERIOR CONNECTIONS SCALE: NOT TO SCALE

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SBA COMMUNICATIONS CORP. 5900 BROKEN SOUND PKWY NW BOCA RATON, FL 33487



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### **GROUNDING DETAILS**

**G-1**