PROJECT SUMMARY

SITE NAME: UTILITY SERVICES HOLLY SPRINGS

SITE NUMBER: 5RA0965A

SITE ADDRESS: 6908 COKESBURY RD

HOLLY SPRINGS, NC 27540

COUNTY: HARNETT COUNTY

STRUCTURE OWNER: HARNETT REGIONAL WATER

700 MCKINNEY PARKWAY LILLINGTON, NC 27546

STRUCTURE MANAGER: UTILITY SERVICE COMMUNICATIONS 535 GENERAL COURTNEY HODGES BLVD

PO BOX 1350 PERRY, GA 31069

SITE COORDINATES: 1A

LATITUDE: 35°
LONGITUDE: 78°
ELEVATION: TBI

35° 33' 51.699" N (NAD 83) 78° 52' 15.4986" W (NAD 83) TBD' (NAVD 88)

OCCUPANCY: UNMANNED

CONSTRUCTION TYPE: COLOCATE

TELEPHONE COMPANY: TBD

POWER COMPANY: DUKE ENERGY PHONE: (800) 777-9898

POLICE DEPARTMENT: HOLLY SPRINGS POLICE DEPARTMENT PHONE: (919) 552-7110

APPROVALS

SIGNATURE

DATE

LICENSOR'S PROJECT MANAGER:

LICENSEE PROJECT MANAGER:

APPROVED

By David Everspaugh at 5:15 pm, Jan 26, 2022

STRUCTURAL REVIEW


CONTRACTOR SHALL ATTAIN AND VERIFY STRUCTURAL EVALUATION REPORT OF EXISTING TOWER FOR EXACT PLACEMENT OF ANTENNAS AND COAX CABLES. CONTRACTOR SHALL COMPLY WITH THE REQUIREMENTS OF THE STRUCTURAL EVALUATION REPORT AND NOTIFY SIGNAL POINT CONSTRUCTION MANAGER IN THE CASE OF ANY DISCREPANCIES. ANY STRUCTURAL MODIFICATION, IF REQUIRED, SHALL BE DONE PRIOR TO THE INSTALLATION OF ANTENNAS.

THE INFORMATION CONTAINED IN THIS SET OF DOCUMENTS IS PROPRIETARY BY NATURE. ANY USE OR DISCLOSURE OTHER THAN THAT WHICH RELATES TO THE CLIENT IS STRICTLY PROHIBITED.


T · · Mobile ·

SITE NUMBER: 5RA0965A SITE NAME: UTILITY SERVICES HOLLY SPRINGS 6908 COKESBURY RD HOLLY SPRINGS, NC 27540

VICINITY MAP

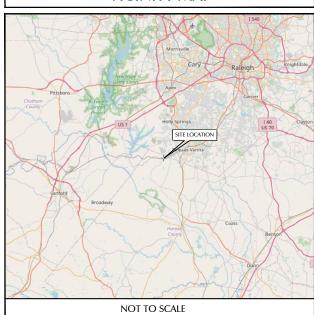

LOCATION MAP

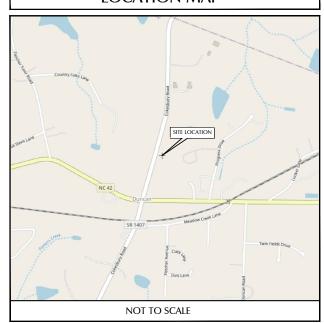

DRIVING DIRECTIONS

FROM CHARLOTTE, NC:

MERGE ONTO 1-77 N/US-21 N. USE THE RIGHT 2 LANES TO TAKE EXIT 13A TO MERGE ONTO 1-85 N TOWARD GREENSBORD. KEEP LEFT AT THE FORK TO STAY ON 1-85 N. TAKE EXIT 126A-126B TO MERGE ONTO US-421 S TOWARD SANFORD. KEEP LEFT OS TAY ON US-421 S. TAKE EXIT 148 FOR COLON RD. TURN RIGHT ONTO COLON RD. TURN RIGHT ONTO RIDDLE RD. TURN RIGHT ONTO LOWER MONCURE RD. TURN LEFT ONTO LICK CREEK RD. TURN LEFT ONTO POPLAR SPRINGS CHURCH RD. CONTINUE STRAGET ONTO NC-42 E. TURN LEFT ONTO CRESBURY RD. DESTINATION WILL BE ON THE RIGHT.

PROJECT TEAM

SURVEYOR: NAME: N/A ADDRESS: N/A CONTACT: N/A PHONE: N/A

PHONE: (615) 268-3557

A&E ENGINEER:
NAME: TELECAD WIRELESS SITE DESIGN
ADDRESS: 1961 NORTHPOINT BLVD. SUITE 130
HIXSON, TN 37343
CONTACT: FLOYD WHITE

GEOTECHNICAL/SOILS ENGINEERING: NAME: N/A ADDRESS: N/A CONTACT: N/A PHONE: N/A

CARRIER:

NAME: T-MOBILE

ADDRESS: T.B.D. CONTACT: T.B.D.



SHEET INDEX

NO.	DESCRIPTION			
T1	TITLE SHEET			
T2	APPENDIX B - BUILDING CODE SUMMARY			
GN1	GENERAL NOTES			
C1	OVERALL SITE PLAN			
C2	ENLARGED SITE PLAN			
C3	EQUIPMENT PAD FOUNDATION DETAILS			
СЗА	GENERATOR DETAILS			
C4	STRUCTURE ELEVATION & ANTENNA PLAN			
C4A	MOUNT DETAILS			
C4B	MOUNT DETAILS			
C4C	MOUNT DETAILS			
C4D	MOUNT DETAILS			
C5	SITE DETAILS			
C6	CABINET DETAILS			
C6A	CABINET DETAILS			
C7	ICE BRIDGE & EQUIPMENT DETAILS			
E1	OVERALL ELECTRICAL SITE PLAN			
E1A	ENLARGED ELECTRICAL SITE PLAN			
E2	EQUIPMENT GROUNDING PLAN			
E3	ELECTRICAL SPECIFICATIONS NOTES			
E4	ELECTRICAL DETAILS			
E5	GROUNDING DETAILS			
E6	ELECTRICAL DETAILS			
E6A	ONE LINE DIAGRAM & PANEL SCHEDULE			
E6B	EQUIPMENT H-FRAME RACK DETAIL			
E7	GROUNDING SINGLE LINE			

CODE COMPLIANCE

- UNIFORM BUILDING CODE.
 BUILDING OFFICIALS & CODE
- ADMINISTRATORS (BOCA)

 3 LINIFORM MECHANICAL CODE
- UNIFORM MECHANICAL CODE.
 INTERNATIONAL BUILDING CODE
 (IRC)
- 5. ANSI/EIA-222-G LIFE SAFETY CODE
- NFPA-101.
 6. UNIFORM PLUMBING CODE.
 7. NATIONAL ELECTRIC CODE.
- 8. LOCAL BUILDING CODE.
 9. CITY/COUNTY ORDINANCES



CALL 811 OR (800) 632-4949

CONTRACTOR TO CALL NORTH CAROLINA ONE-CALL SYSTEMS AT LEAST (2) WORKING DAYS PRIOR TO DIGGING.

SHEET SCALE FACTOR:

PLOT SIZE: 11"x17": "TO SCALE" 24"x36": 2X SCALE AS NOTED

T··Mobile·



1961 NORTHPOINT BLVD, SUITE 130 HIXSON, TN 37343 PH: 423-843-9500 FAX: 423-843-9509

THE INFORMATION CONTAINED IN THIS SET OF DOCUMENTS IS PROPRIETARY BY NATURE. ANY USE OR DISCLOSURE OTHER THAN THAT WHICH RELATES TO THE CLIENT IS STRICTLY PROHIBITED.

A&E PROJECT #:	N/A
DRAWN BY:	BNS
CHECKED BY:	DLS

	REVISIONS				
◬	01/26/2022	CONSTRUCTION ISSUE			
Æ	01/18/2022	PRELIMINARY REVIEW			
◬	01/11/2022	PRELIMINARY REVIEW			
◬	01/07/2022	PRELIMINARY REVIEW			
A	01/03/2022	PRELIMINARY REVIEW			
\triangle	12/15/2021	PRELIMINARY REVIEW			
NO.	DATE	DESCRIPTION			



PROJECT No

UTILITY SERVICES HOLLY SPRINGS

N/A

SITE NUMBER: 5RA0965A

310 103037

SITE ADDRESS

DESIGN TYPE

6908 COKESBURY RD HOLLY SPRINGS, NC 27540

COLOCATE

TITLE SHEET

DRAWING NO.


⁻1 |


BUILDII	(EXCEPT 1 ANI (Reproduce	2-FAMILY DW the following da					
	ct: T-MOBILE						
Owner/Authori Owned By:		DAY Phone # City/County	(_423)_20	8 - 67 Pri	03 E-Ma vate	ail COREY.DAY@TEL	☐ State
	ment Jurisdiction:				unty <u>HARNE</u>	Π	_ State
CONTACT: S	TEVE CARPI	ENTER, P.I	E. (#0257: LICENS		TELEPHONI	= # E MAII	<u> </u>
Architectural Civil	TELECAD WIRE		PENTER 02572	25 (4		STEVE.CARPENTI	ER@TELECADENG
Electrical Fire Alarm Plumbing	TELECAD WIRE	LESS FLOYD WE	HITE 03290	60 (15) 268-3557	FLOYD.WHITE@1	ELECADENG.COM
Mechanical Sprinkler-Stan Structural Retaining Wall	BY OTHERS)		
Other	d include firms and in	ndividuals such a	s truss, preca	st, pre-er	j gineered, in	terior designers,	etc.)
2018 NC BUIL		st Time Interior C Shell/Core - Conta procedures and re Phased Construct	act the local in equirements tion - Shell/Co	re- Cont	jurisdiction t	for possible addit	
2018 NC EXIS	ETING BUILDING CO	ODE: EXISTING: Alteration	Prescri	iptive [Repair [☐ Chapter 14 ☐ Level III ☐ Change of Use	е
RENOVA	JCTED: (date) TED: (date) DRY (Table 1604.5):	PRO	POSED OCC	PANCY(S) (Ch. 3): <u>s</u> '(S) (Ch. 3):	-2 LOW	
	(Propose			□ïv		
BASIC BUILD Construction (check all that Sprinklers: Standpipes: Fire District: Special Inspe	Type: I-A	ass ☐I ☐ Flood Haz o## ☐ Yes (Co	ard Area:	□NFPA □Wet ■No al inspect	□Dry □Yes ion jurisdictio	V-A V-B FPA 13D	
		pro	ocedures and	requirem	ents.)		_/
2018 NC Adminis	strative Code and Polici	es			Revise	d 6/15/2020	
FLOOR 3rd Floor	EXISTING (SC		ilding Area T NEW (SQ FT)	able		SUB-OTAL	
2nd Floor Mezzanine	-	-					
1st Floor Basement							
	upancy Classificati	on(s):	N / A	= \			
Primary Occu Assembly Business Education Factory Hazardou Institution Mercantile Residentis Storage Utility and Accessory Incidental Ass Special Vises Special Vises Special Vises Special Vises Special Vises Special Vises	A-1 A-2 A-1 A-2 A-1 A-2 A-1 A-2 B-1 Moderate B-1 Condition I-2 Condition I-3 Condition I-3 Condition I-4 B-2 B-4 B-7 B-7 B-7 B-7 B-7 B-7 B-7	F-2 Low H-2 Def year H-2 Def ye	High-piled closed Replantions: aration: irred type of code height and as to the entire n, so determinate area calculation area for each or area for each of the resort area.	st H 5 d 5 d aair Gara Hr. E 5 building led, shall ions for e 6 tios of th use sl	ge Exception: In for the blu Itions for ea The most r apply to the ach story, the actual floo allall not exce	iliding shall be de ho of the applica setricitive type of entire building entire building area of the coo area of pich us	cupancy shall e divided by
Primary Occi Assembly Business Education Factory Hazardou Institution Mercantiti Storage Utility and Accessory Incidental Prov Incidental Pro	A-1 A-2 A-1 A-2 A-1 A-2 A-2 A-1 A-2 A-2 A-3 A-1 A-2 A-3 A-1 A-2 A-3 A-1 A-2 A-3 A-4 A-1 A-2 A-3 A-4 A-4 A-4 A-7 A-7 A-7 A-7 A-7	R-3 R-4 S-2 Low R-3 R-4 S-2 Low R-3 S-2 Low S-2 Low S-2 Low S-2 Low S-2 Low S-2 Low S-3 R-4 S-4 S-4 S-4 S-4 S-4 S-4 S-4 S-4 S-4 S	e 3 Combu	st H 5 d 5 d aair Gara Hr. E 5 building led, shall ions for e 6 tios of th use sl	ge Exception: In for the bustions for ea The most in apply to the ach story, the ach story, the Second actual floor Second all not exce 1 by B	iliding shall be de hot of the applica setticities type of entire building. he area of the oo. area of such us ed 1.	cupancy shall e divided by
Primary Occu Assembly Business Education Factory Hazardou Institution Mercantile Residentis Storage Utility and Accessory Incidental Ass Special Vises Special Vises Special Vises Special Vises Special Vises Special Vises	A-1 A-2 A-1 A-2 A-1 A-2 A-1 A-2 A-1 A-2 B-1 A-1 Condition I-2 Condition I-3 Condition I-3 Condition I-3 Condition I-3 Condition I-4 A-1 A-2 B-1 A-2 B-2 B-2 B-2 B-3 B-3 B-3 B-4 B-4 B-4 B-4 B-4	F-2 Low H-2 Def year H-2 Def ye	e 3 Combu	Hr. E do de	ge Exception: In for the blu Itions for ea The most r apply to the ach story, the actual floo allall not exce	ilding shall be de hof the applica chort of the applica setticities type of entire building of entire the entire that the entir	cupancy shall e divided by
Primary Occi Assembly Business Education Factory Hazardou Institution Mercantile Residentis Storage Utility and Accessory O Incidental Ass Special Prov Ince Occup Incidental Ass Special Prov Incidental Pro	A-1 A-2 A-1 A-2 A-1 A-2 A-1 A-2 A-2 A-1 A-1 A-2 A-2 A-3 A-1 A-2 A-3 A-1 A-3 A-2 A-3 A-1 A-3 A-2 A-3 A-3 A-3 A-3 A-3 A-3	R-3 R-4 S-2 Low H-2 Defly first 1 2 1 2 1 2 1 2 1 2 1 2 1 2 1 2 1 2 1 2	e 3 Combu 3	Hr. E do de	ge cxception: In for the bustions for ea. The most riapply to the ach story, it is actual floo aliall not except \$\leq 1\$ YB (C) OR FRONTAGE	iliding shall be de hof the applicace sesticitive type of entire building of entire building of the control of	cupancy shall e divided by
Primary Occi Assembly Business Education Factory Hazardou Institution Mercantilit Storage Utility and Accessory Incidental Storage Inci	A-1 A-2 A-1 A-2 A-1 A-2 A-1 A-2 A-2 A-1 A-1 A-2 A-2 A-3 A-1 A-2 A-3 A-1 A-3 A-1 A-3 A-1 A-3 A-1 A-3 A-1 A-3 A-2 A-3 A-1 A-3 A-2 A-3 A-3 A-3 A-3 A-1 A-3 A-3 A-3 A-3 A-3 A-3 A-3 A-3	F-2 Low H-2 Dely grat H-2 Dely	e 3 Combu 3	ast Haring State of the State o	ge Exception: In for the builtions for ea The most rapply to the actual floo and story, the actual floo and story, the CONFRONTAGE REASE1.5 (C) (C) (C) (C) (C) (C) (C) (C) (C) (C	iliding shall be de hof the applicace sesticitive type of entire building of entire building of the control of	cupancy shall be divided by

eight in Feet (Table 504.3) 2

Height in Stories (Table 504.4) 3

e code reference if the "Shown on Plans" quantity is not based on Table 504.3 or 504.4. naximum height of air traffic control towers must comply with Table 412.3.1. naximum height of open parking garages must comply with Table 406.5.4.

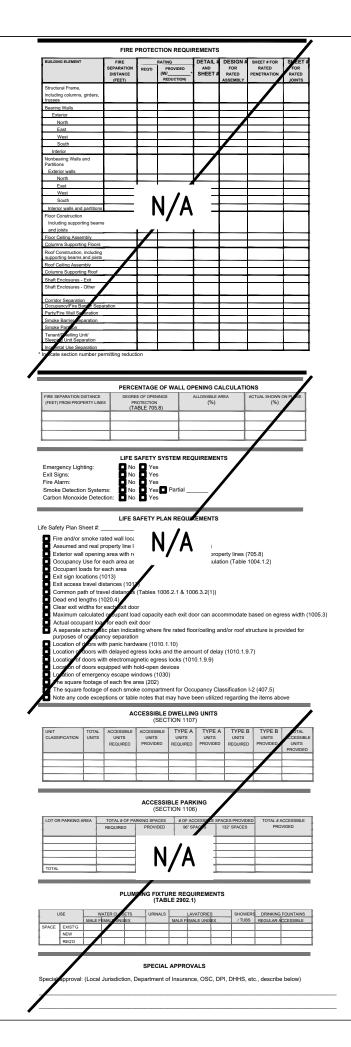

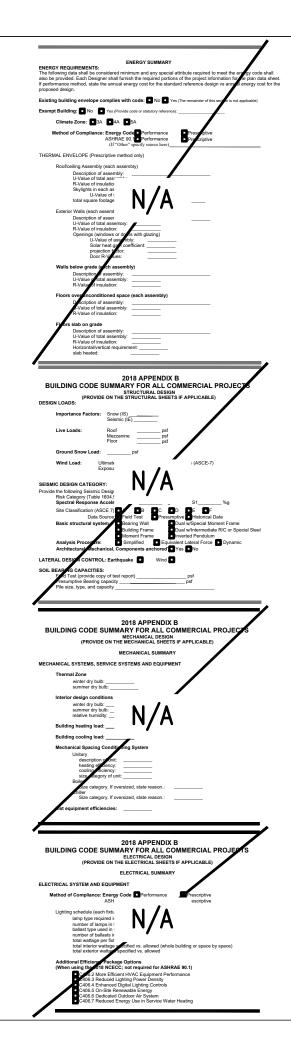

T··Mobile·



1961 NORTHPOINT BLVD, SUITE 130 HIXSON, TN 37343 PH: 423-843-9500 FAX: 423-843-9509

THE INFORMATION CONTAINED IN THIS SET OF DOCUMENTS IS PROPRIETARY BY NATURE. ANY USE OR DISCLOSURE OTHER THAN THAT WHICH RELATES TO THE CLIENT IS STRICTLY PROHIBITED.

A&E PROJECT #:	N/A
DRAWN BY:	BNS
CHECKED BY:	DLS

	REVISIONS				
◬	01/26/2022	CONSTRUCTION ISSUE			
Æ	01/18/2022	PRELIMINARY REVIEW			
⚠	01/11/2022	PRELIMINARY REVIEW			
◬	01/07/2022	PRELIMINARY REVIEW			
A	01/03/2022	PRELIMINARY REVIEW			
\triangle	12/15/2021	PRELIMINARY REVIEW			
NO.	DATE	DESCRIPTION			



PROJECT No.

N/A

SITE NAME:

UTILITY SERVICES HOLLY SPRINGS

SITE NUMBER:

5RA0965A

SITE ADDRESS:

6908 COKESBURY RD HOLLY SPRINGS, NC 27540

DESIGN TYPE:

COLOCATE

HEET TITLE:

APPENDIX B - BUILDING CODE SUMMARY

DRAWING NO.

T2

GENERAL NOTES

- 1. PRIOR TO THE START OF CONSTRUCTION, THE CONTRACTOR SHALL BE RESPONSIBLE FOR ENSURING THAT ALL REQUIRED PERMITS AND APPROVALS HAVE BEEN OBTAINED. NO CONSTRUCTION OR FABRICATION SHALL BEGIN UNTIL THE CONTRACTOR HAS RECEIVED AND THOROUGHLY REVIEWED ALL PLANS AND OTHER DOCUMENTS APPROVED BY ALL APPLICABLE PERMITTING AUTHORITIES.
- ALL WORK SHALL BE PERFORMED IN ACCORDANCE WITH THESE PLANS AND THE CODES, REGULATIONS, AND STANDARDS OF ALL APPLICABLE GOVERNING AUTHORITIES.
- 3. THE GENERAL CONTRACTOR SHALL VERIFY THAT ALL EXISTING TOPOGRAPHY AND HORIZONTAL GEOMETRY IS AS INDICATED ON THESE DRAWINGS. NO ADDITIONAL COMPENSATION SHALL BE PAID TO THE CONTRACTOR FOR DAMAGE OR REPAIR TO THESE FACILITIES CAUSED BY THE CONTRACTOR'S WORK FORCE. IMMEDIATELY NOTIFY THE LESSEE'S CONSTRUCTION MANAGER OF ANY DISCREPANCIES OR INTERFERENCE WHICH AFFECT THE WORK OF THIS CONTRACT.
- 4. THE CONTRACTOR SHALL MAINTAIN ADEQUATE DRAINAGE AT ALL TIMES. DO NOT ALLOW WATER TO STAND OR POND. ANY DAMAGE TO STRUCTURES OR WORK ON THE SITE CAUSED BY INADEQUATE MAINTENANCE OF DRAINAGE PROVISIONS WILL BE THE RESPONSIBILITY OF THE CONTRACTOR AND ANY COST ASSOCIATED WITH REPAIRS FOR SUCH DAMAGE WILL BE AT THE CONTRACTOR'S EXPENSE.
- 5. ALL WASTE MATERIAL SHALL BE PROPERLY DISPOSED OF OFF-SITE OR AS DIRECTED BY THE LESSEE'S CONSTRUCTION MANAGER AND IN ACCORDANCE WITH JURISDICTIONAL AUTHORITIES.
- 6. ANY PROPERTY DAMAGE CAUSED BY THE CONTRACTOR OR HIS OPERATIONS SHALL BE CORRECTED AND/OR RESTORED TO THE SATISFACTION OF THE PROPERTY OWNER(S) AND THE LESSEE'S CONSTRUCTION MANAGER AT NO ADDITIONAL COST TO THE OWNER.
- 7. CONTRACTOR SHALL MAINTAIN 20' HORIZONTAL CLEARANCE FROM CENTERLINE OF EXISTING POWER LINES OR AS REQUESTED BY THE POWER COMPANY.
- 8. NOTIFY THE LESSEE'S REPRESENTATIVES TWENTY-FOUR HOURS PRIOR TO CONSTRUCTION TO ALLOW THE LESSEE'S REPRESENTATIVES TO LOOK AT THE SITE PRIOR TO EXCAVATION.
- 9. THE CONTRACTOR SHALL INCLUDE ALL WORK REQUIRED TO CO-LOCATE ON THE EXISTING TOWER INCLUDING ALL NECESSARY SITE IMPROVEMENTS, FOUNDATIONS, ELECTRICAL IMPROVEMENTS, SNAP INS, H-FRAME, AND OTHER ACCESSORIES FOR COMPLETE INSTALLATION.
- 10. THE CONTRACTOR IS RESPONSIBLE FOR THE INSTALLATION OF THE FOLLOWING EQUIPMENT THAT WILL BE SUPPLIED BY THE LESSEE: ANTENNAS, COAX CABLES, ICE BRIDGE, WAVEGUIDE LADDER, METER, AND EQUIPMENT CABINETS/SHELTER. THE EQUIPMENT CABINETS/SHELTER SHALL BE TRANSPORTED TO THE SITE BY THE CONTRACTOR.
- 11. ALL CONCRETE SHALL BE NORMAL WEIGHT AND SHALL CONFORM TO THE ACI 301 AND THE FOLLOWING:
 - -MINIMUM COMPRESSION STRENGTH 3,000 PSI
 - -AIR ENTRAPMENT RANGE 3% TO 6%
 - -SLUMP GREATER THAN 3", BUT NOT TO EXCEED 6".
- 12. CONTRACTOR TO NOTIFY THE LESSEE'S TESTING REPRESENTATIVE FORTY-EIGHT HOURS BEFORE CONCRETE POURS.

13. CONTRACTOR TO PROVIDE RED LINE CONSTRUCTION DRAWINGS TO TOWER OWNER AND LESSEE AT COMPLETION OF JOB.

UTILITY NOTES

- 1. APPLY FOR THE UTILITY SERVICE (ELECTRIC) NO LATER THAN THE NEXT BUSINESS DAY FOLLOWING AWARD OF CONTRACT. COORDINATE WITH THE ELECTRIC UTILITY COMPANY FOR EXACT TRANSFORMER LOCATION, METERING REQUIREMENTS, AND SERVICE ROUTING. COORDINATE WITH THE TELEPHONE UTILITY COMPANY FOR EXACT TELEPHONE REQUIREMENTS AND ROUTING OF SERVICE.
- 2. ALL UTILITY RELATED WORK SHALL BE PERFORMED IN ACCORDANCE WITH APPLICABLE UTILITY REQUIREMENTS. FIELD VERIFY EXISTING UTILITY LOCATIONS PRIOR TO CONSTRUCTION.
- 3. THE CONTRACTOR SHALL CONTACT UTILITIES AND LOCATOR SERVICE A MINIMUM OF 72 HOURS PRIOR TO THE START OF CONSTRUCTION.
- 4. CONTRACTOR SHALL PROVIDE TRENCHING AND CONDUITS AS SHOWN OR AS REQUIRED BY LOCAL UTILITY.
- 5. NO PENETRATIONS TO THE TOWER FOUNDATION OF ANY KIND.

LEGEND

EXISTING		NEW
х 100.5	SPOT ELEVATION	712.9
95	CONTOUR LINE	98
—— sp———	STORM DRAIN	sp
==	CATCH BASIN	
R\W	RIGHT OF WAY	
•	IRON PIN SET (IPS) 5/8" REBAR	
•	IRON PIN FOUND (IPF)	
•	BENCHMARK	
	CONCRETE MON. FOUND	
	CONCRETE MON. SET	
©	CENTERLINE	
——— ОНТ ———	OVERHEAD TELEPHONE	
UGT	UNDERGROUND TELEPHONE	
OHP	OVERHEAD POWER	
———— UGP ————	UNDERGROUND POWER	
Ø	UTILITY POLE	
•	LIGHT POLE	
——— w ———	WATER LINE	
\bowtie	WATER VALVE	
UGG	NATURAL GAS LINE	
G ⋈	GAS VALVE	
st	SANITARY SEWER	NOTE: THIS IS A GENERAL LEGEND.
M	MANHOLE	SOME ITEMS MAY NOT APPLY TO THIS SITE.

T··Mobile·



1961 NORTHPOINT BLVD, SUITE 130 HIXSON, TN 37343 PH: 423-843-9500 FAX: 423-843-9509

THE INFORMATION CONTAINED IN THIS SET OF DOCUMENTS IS PROPRIETARY BY NATURE. ANY USE OR DISCLOSURE OTHER THAN THAT WHICH RELATES TO THE CLIENT IS STRICTLY PROHIBITED.

A&E PROJECT #:	N/A
DRAWN BY:	BNS
CHECKED BY:	DLS

		REVISIONS			
	◬	01/26/2022	CONSTRUCTION ISSUE		
	Æ	01/18/2022	PRELIMINARY REVIEW		
	◬	01/11/2022	PRELIMINARY REVIEW		
	◬	01/07/2022	PRELIMINARY REVIEW		
l	A	01/03/2022	PRELIMINARY REVIEW		
l	\triangle	12/15/2021	PRELIMINARY REVIEW		
l	NO.	DATE	DESCRIPTION		



PROJECT	No.
	N/A
SITE NAME	:
U	TILITY SERVICES
ŀ	HOLLY SPRINGS
SITE NUME	BER:
	5RA0965A
SITE ADDF	RESS:
69	08 COKESBURY RD
HOLL	Y SPRINGS, NC 27540
DESIGN TY	·· =·
	COLOCATE


SHEET TITLE:

GENERAL

NOTES

GN1

NO. REVISION:

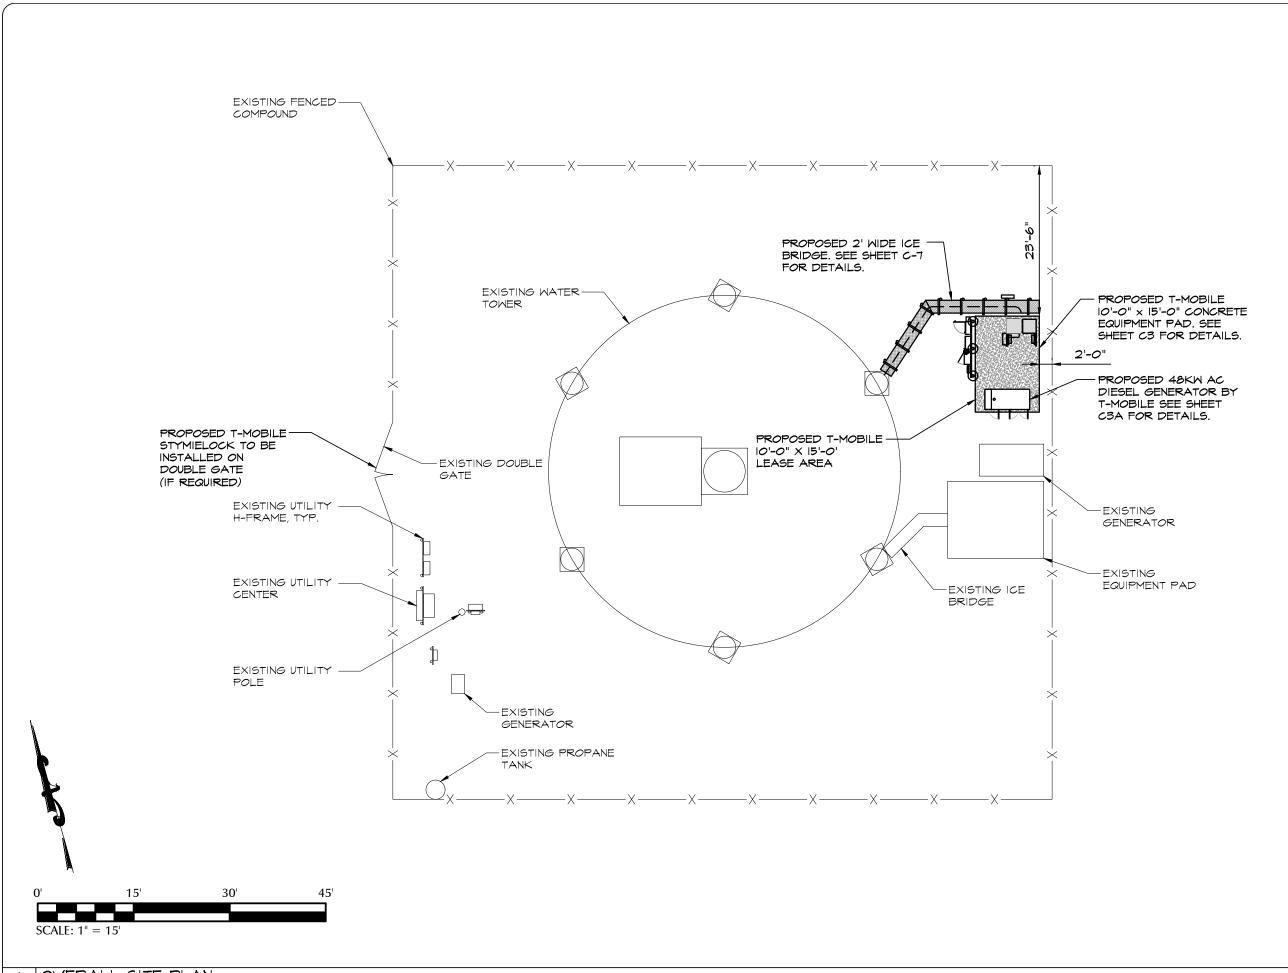

T··Mobile·



1961 NORTHPOINT BLVD, SUITE 130 HIXSON, TN 37343 PH: 423-843-9500 FAX: 423-843-9509

THE INFORMATION CONTAINED IN THIS SET OF DOCUMENTS IS PROPRIETARY BY NATURE. ANY USE OR DISCLOSURE OTHER THAN THAT WHICH RELATES TO THE CLIENT IS STRICTLY PROHIBITED.

A&E PROJECT #:	N/A
DRAWN BY:	BNS
CHECKED BY:	DLS

	REVISIONS			
l				
l	◬	01/26/2022	CONSTRUCTION ISSUE	
	Æ	01/18/2022	PRELIMINARY REVIEW	
l	⚠	01/11/2022	PRELIMINARY REVIEW	
l	◬	01/07/2022	PRELIMINARY REVIEW	
l	A	01/03/2022	PRELIMINARY REVIEW	
l	\triangle	12/15/2021	PRELIMINARY REVIEW	
l	NO.	DATE	DESCRIPTION	



PROJECT No.

SITE NAME:

UTILITY SERVICES HOLLY SPRINGS

N/A

SITE NUMBER:

5RA0965A

SITE ADDRESS:

6908 COKESBURY RD HOLLY SPRINGS, NC 27540

DESIGN TYPE:

COLOCATE

SHEET TITLE:


OVERALL SITE PLAN


DRAWING NO.

T 1

REVISION:

OVERALL SITE PLAN

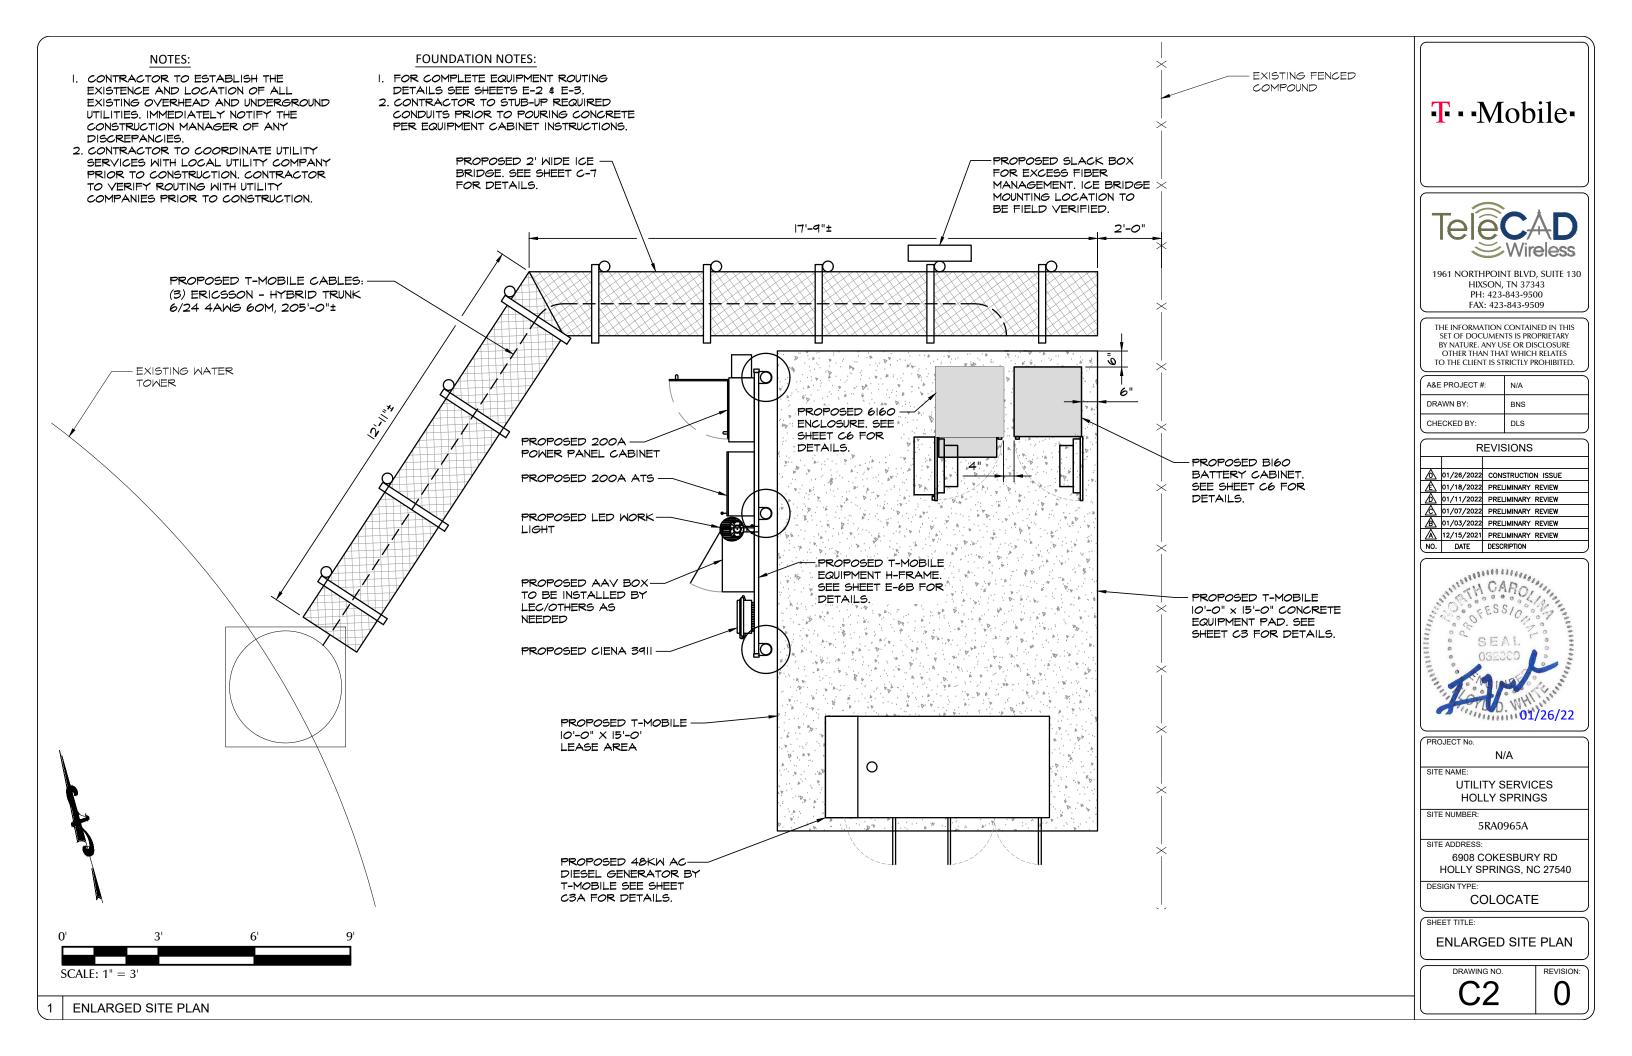

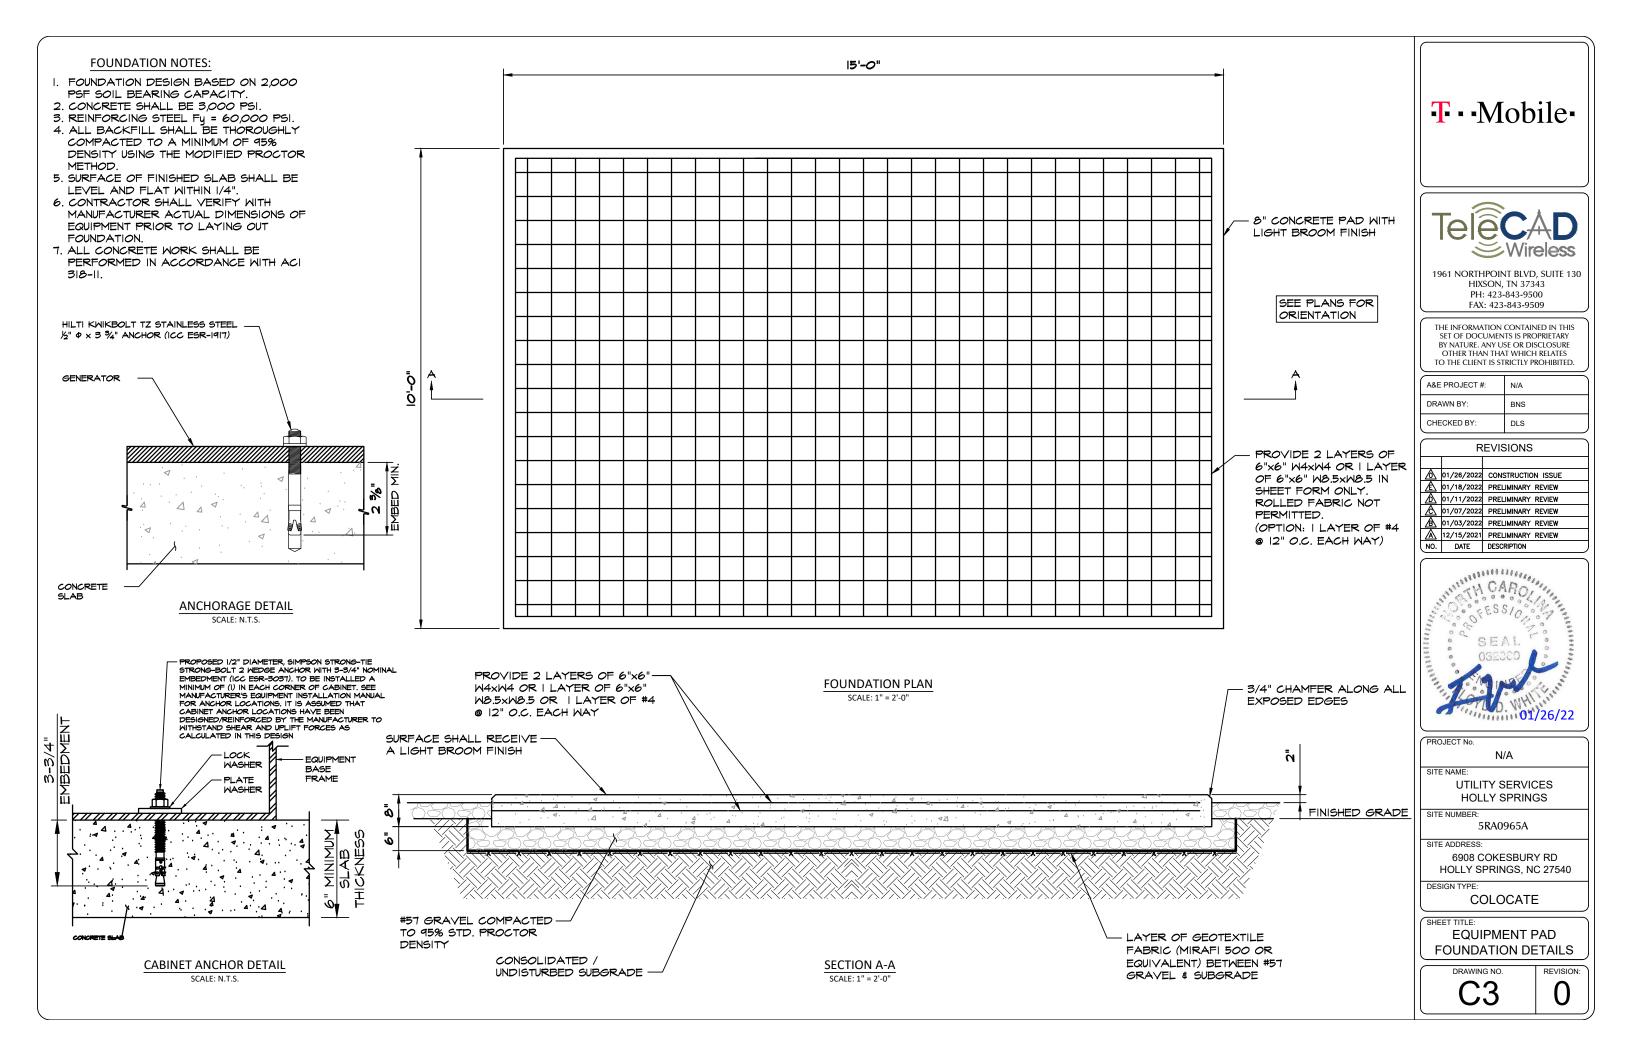

GENERAC INDUSTRIAL

EPA Certified Stationary Emergency

Standard Features

ENGINE SYSTEM

- Cold Weather Kit
- Oil Drain Extension
- Fan Guard
- Stainless Steel Flexible Exhaust Connection
- Factory Filled Oil & Coolant

Fuel System

Primary Fuel Filter

Cooling System

- Closed Coolant Recovery System
- Factory-Installed Radiator
- 50/50 Ethylene Glycol Antifreeze
- Radiator Drain Extension
- Can Operate at up to 122°F (50°C) Ambient

Electrical System

- Battery Charging Alternator
- Battery Cables
- Battery Tray
- Rubber-Booted Engine Electrical Connections
- Solenoid Activated Starter Motor
- Smart Battery Charger

ALTERNATOR SYSTEM

- Class H Insulation Material
- 2/3 Pitch
- Skewed Stator Sealed Bearings
- Low Temperature Rise (<120°C)
- Low THD (<5%)

GENERATOR SET

- Sound Attenuated Aluminum Enclosure
- Internal Genset Vibration Isolation
- Separation of Circuits High/Low Voltage
- Wrapped Exhaust Piping Standard Factory Testing
- 5 Year Limited Warranty
- Ready to Accept Full Load in <10 Seconds
- E-Stop

TANKS

- 48 Hour Run Time Tank
- UL 142 Listed Tank

CONTROL SYSTEM

Temperature



- Two-Line Plain Text LCD Display
- Programmable Start Delay Between 10-30
 Safety Fused

- 1 minute Engine Cool-Down
- Smart Battery Charger
- Under Protection
- High Temperature Shutdown

- 10 second Engine Start Sequence
- 5 second Engine Warm Up
- Starter Lock-Out
- Automatic Voltage Regulation with Over and
- · Automatic Low Oil Pressure Shutdown
- Overspeed Shutdown

- Overcrank Protection
- · Failure to Transfer Protection
- · Low Battery Protection
- 50 Even Run Log
- Future Set Capable Exerciser

· Common External Fault Capability

- Incorrect Wiring Protection
- Internal Fault Protection
- Governor Failure Protection

Optional Shipped Loose and Field Install Kits

GENERATOR SET

Paint Kit

General

O Scheduled Maintance Kit

CONTROL SYSTEM

- Mobile Link [™] and Adapter Kit
- TANKS O Spill Box
- 90% Fuel AlarmTank Risers
- Spill Box Drainback Kit
 Vent Extension Support Kit
- 5 Day Run Time Tank
 Overfill Prevention Valve
- Fuel Fill Drop Tube
 Lockable Fuel Cap

APPLICATION AND ENGINEERING DATA

ENGINE SPECIFICATIONS

Make	Generac	
Cylinder #	4	
Туре	In-Line	
Displacement - in ³ (L)	3.4 (207.48)	
Bore - in (mm)	3.86 (98)	
Stroke - in (mm)	4.45 (113)	
Compression Ratio	18.5:1	
Intake Air Method	Turbocharged/Aftercooled	

Cast Iron OHV

Engine Governing

Cylinder Head

Piston Type

Governor	Electronic
Frequency Regulation (Steady State)	±0.25%

Lubrication System

Oil Pump Type	Gear	
Oil Filter Type	Full Flow Spin-On Canister	
Crankcase Capacity with Filters- ot (L)	7.4 (7.0)	

Cooling System

Cooling System Type	Closed Recovery
Fan Type	Pusher
Fan Speed- rpm	2,029
Fan Diameter - in (mm)	22 (559)

Fuel System

Fuel Type	Ultra Low Sulfur Diesel Fuel
Fuel Specification	ASTM
Fuel Pump Type	Mechanical Engine Driven Gear
Injector Type	Mechanical
Fuel Supply Lin (mm/in)	7.94/0.31 (ID)
Fuel Return Line (mm/in)	7.94/0.31 (ID)
Eugl Eltoring (migrong)	26

Engine Electrical System

System Voltage	12 VDC	
Battery Charger Alternator	Standard	
Battery Size	Group 27F	
Battery Voltage	12 VDC	
Ground Polarity	Negative	

ALTERNATOR SPECIFICATIONS

Standard Model	Generac	Standard Excitation	Direct
Poles	4	Bearings	Single Sealed
Field Type	Rotating	Coupling	Flexible Disc
Insulation Class - Rotor	Н	Prototype Short Circuit Test	Yes
Insulation Class - Stator	Н	Voltage Regulator Type	Full Digital
Total Harmonic Distortion	<5%	Number of Sensed Phases	2
Telephone Interference Easter (TIE)	~60	Regulation Accuracy (Steady State)	+1.0%

OPERATING DATA

POWER RATINGS

Standby

Single-Phase 120/480 VAC @0.1pf

48 kW

Amps: 200

MOTOR STARTING CAPABILITIES (sKVA)

sKVA vs. Voltage Dip at 30%

120/240 V	Single-Phase	at 0.4nf	189

FUEL CONSUMPTION RATES*

	Percent Load	Diesel gal/hr (L/hr)
25%		1.35 (5.11)
	50%	2.15 (8.14)
	75%	3.06 (11.58)
	100%	3.98 (15.07)

^{*} Fuel supply installation must accommodate fuel consumption rates at 100% load.

COOLING

		Standby	
Air Flow (Radiator and Alternator)	ft³/min (m³/min)	2824 (80)	
Coolant System Capacity	gal (L)	2.8 (10.6)	
Heat Rejection to Coolant	BTU/hr (MJ/hr)	135,900 (143.4)	
Temperature Deration	3% for every 5°C above 25°C or 1.7% for every 5°F over 7		
Altitude Deration	1% for every 100 m above 915 or 3% for every 1000 ft over 3000 ft		
Maximum Radiator Racknessure	in H ₌ O (kPa)	0.50 (0.12)	

COMBUSTION AIR REQUIREMENTS

	Standby
Flow at Rated Dower ft3/min (m3/min)	190 (5.38)

ENGINE				EXHAUST		
			Standby			Standby
	Rated Engine Speed	rpm	1,800	Exhaust Flow (Rated Output)	ft³/min (m³/min)	448 (12.7)
	Horsepower at rated kW	HP	85	Exhaust Temp (Rated Output - Post Silencer)	°F (°C)	1120 (604.4)

Deration — Operational characteristics consider maximum ambient conditions. Derate factors may apply under atypical site conditions.

Please consult a Generac Power Systems Industrial Dealer for additional details. All performance ratings in accordance with ISO3046, BS5514, ISO8528 and DIN6271 standards. Standby - See Bulletin 0187500SSB

T··Mobile·



1961 NORTHPOINT BLVD, SUITE 130 HIXSON, TN 37343 PH: 423-843-9500 FAX: 423-843-9509

THE INFORMATION CONTAINED IN THIS SET OF DOCUMENTS IS PROPRIETARY BY NATURE. ANY USE OR DISCLOSURE OTHER THAN THAT WHICH RELATES TO THE CLIENT IS STRICTLY PROHIBITED.

	A&E PROJECT #:	N/A
	DRAWN BY:	BNS
	CHECKED BY:	DLS

	R	EVISIONS				
\triangle	01/26/2022	CONSTRUCTION ISSUE				
Æ	01/18/2022	PRELIMINARY REVIEW				
Φ	01/11/2022	PRELIMINARY REVIEW				
\triangle	01/07/2022	PRELIMINARY REVIEW				
A	01/03/2022	PRELIMINARY REVIEW				
\mathbb{A}	12/15/2021	PRELIMINARY REVIEW				
NO.	DATE	DESCRIPTION				



N/A
SITE NAME:
UTILITY SERVICES
HOLLY SPRINGS

PROJECT No.

SITE ADDRESS:

SITE NUMBER: 5RA0965A


HOLLY SPRINGS, NC 27540 DESIGN TYPE:

COLOCATE SHEET TITLE:

6908 COKESBURY RD

GENERATOR DETAILS



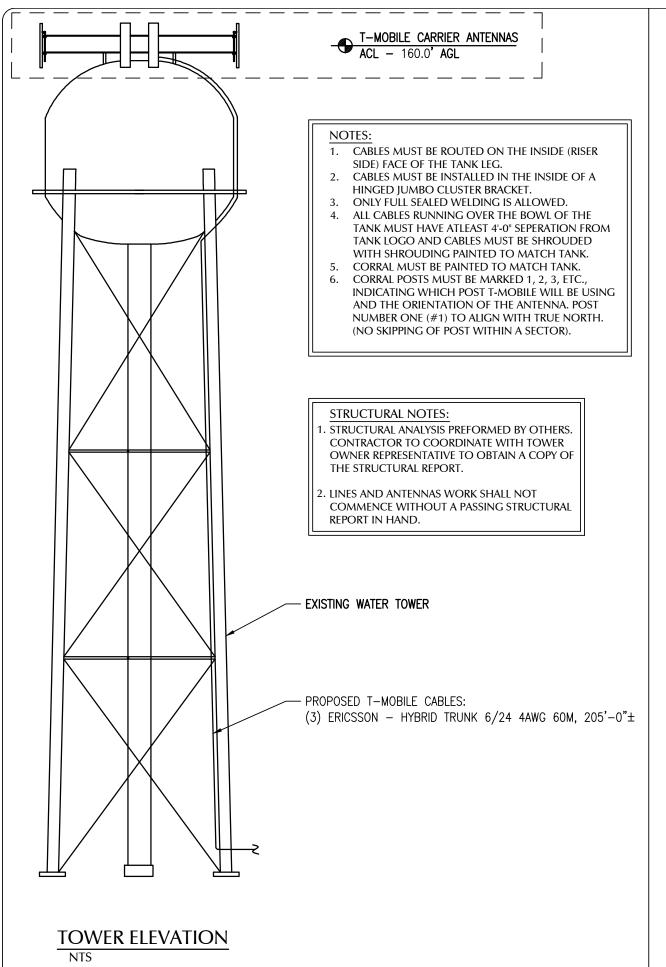

ANTENNA EQUIPMENT SCHEDULE

SECTOR	CTOR ANTENNA POSITION ANTENNA TYPE			AZIMUTH RAD	ANTENNA MODEL NUMBER	QUANTITY	
			CENTER				
ALPHA	A-1	P2	L600 N600	60°	160'	RFS - APXVALL24_43-U-NA20	1
ALPHA	A-2	Р3	L2100 L1900,G1900	60°	160'	RFS - APXVLL19P_43-C-A20	1
BETA	B-1	P8	L600 N600	180°	160'	RFS - APXVALL24_43-U-NA20	1
BETA	B-2	P10	L2100 L1900,G1900	180°	160'	RFS - APXVLL19P_43-C-A20	1
GAMMA	C-1	P16	L600 N600	300°	160'	RFS - APXVALL24_43-U-NA20	1
GAMMA	C-2	P17	L2100 L1900,G1900	300°	160'	RFS - APXVLL19P_43-C-A20	1

ANTENNA POSITION RFDS POST		REMOTE RADIO UN	DC CABLES			
		RRUS MAKE AND MODEL	RRUS	LENGTH	AWG	COUNT
			COUNT			
A-1 P2 A-2 P3		ERICSSON 4480 B71+B85	1	205'	4AWG	1
		ERICSSON 4460 B25+B66	1	205	4AWG	1
B-1	P8	ERICSSON 4480 B71+B85	1	205'	4AWG	1
B-2	P10	ERICSSON 4460 B25+B66	1	205	4AWG	1
C-1	P16	ERICSSON 4480 B71+B85	1	2051	4AWG	1
C-2	P17	ERICSSON 4460 B25+B66	1	205'	4AWG	1

T··Mobile·



1961 NORTHPOINT BLVD, SUITE 130 HIXSON, TN 37343 PH: 423-843-9500 FAX: 423-843-9509

THE INFORMATION CONTAINED IN THIS SET OF DOCUMENTS IS PROPRIETARY BY NATURE. ANY USE OR DISCLOSURE OTHER THAN THAT WHICH RELATES TO THE CLIENT IS STRICTLY PROHIBITED.

A&E PROJECT #:	N/A
DRAWN BY:	BNS
CHECKED BY:	DLS

l		R	EVISIONS
l			
	◬	01/26/2022	CONSTRUCTION ISSUE
	Æ	01/18/2022	PRELIMINARY REVIEW
	◬	01/11/2022	PRELIMINARY REVIEW
	◬	01/07/2022	PRELIMINARY REVIEW
	Æ	01/03/2022	PRELIMINARY REVIEW
	\mathbb{A}	12/15/2021	PRELIMINARY REVIEW
ı	NO.	DATE	DESCRIPTION



01/26/22
PROJECT No.
N/A
SITE NAME:
UTILITY SERVICES
HOLLY SPRINGS
SITE NUMBER:

5RA0965A

SITE ADDRESS:

6908 COKESBURY RD HOLLY SPRINGS, NC 27540

DESIGN TYPE:

COLOCATE


SHEET TITLE:

SCALE: N.T.S.

STRUCTURE ELEVATION & ANTENNA PLAN


C4


1 0

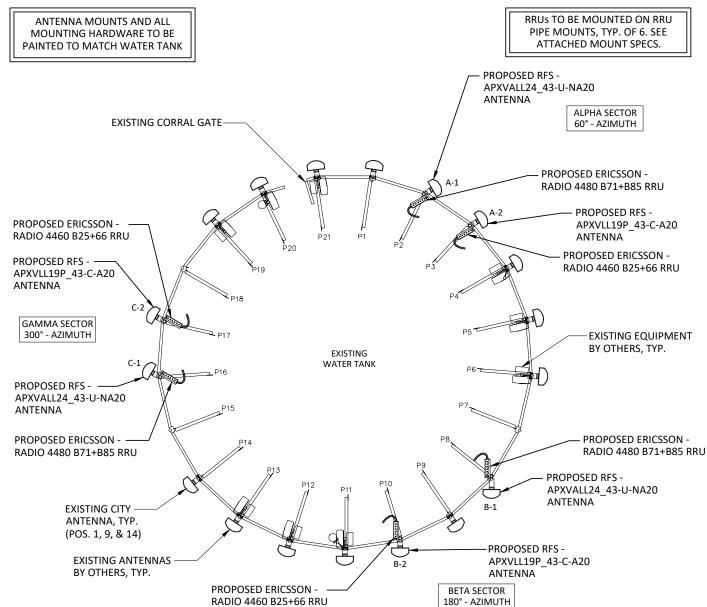


PROPOSED ANTENNA LAYOUT

NOT TO SCALE

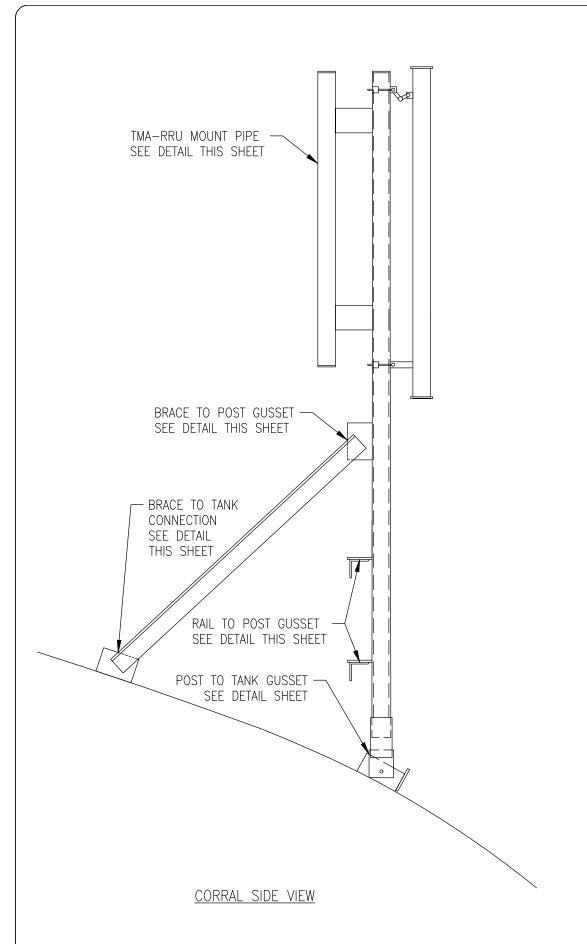


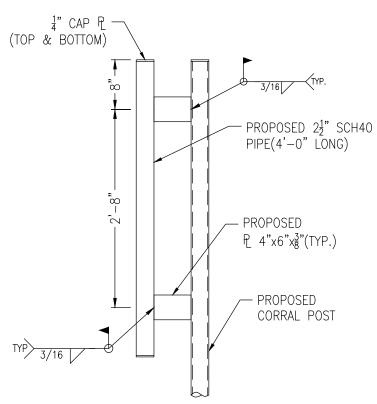


TMA/RRU MOUNTING DETAIL

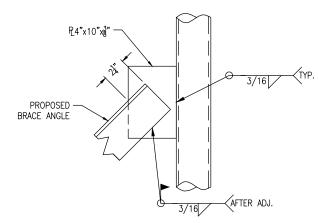


BRACE TO POST GUSSET

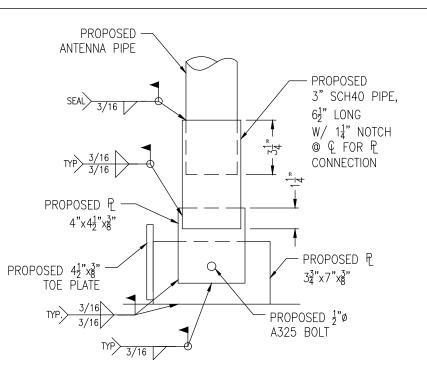

POST TO TANK GUSSET

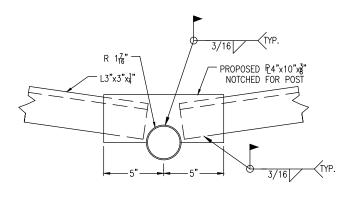

RAIL TO POST GUSSET

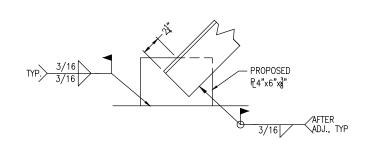

BRACE TO TANK CONNECTION

T · · Mobile ·



1961 NORTHPOINT BLVD, SUITE 130 HIXSON, TN 37343 PH: 423-843-9500 FAX: 423-843-9509

THE INFORMATION CONTAINED IN THIS SET OF DOCUMENTS IS PROPRIETARY BY NATURE. ANY USE OR DISCLOSURE OTHER THAN THAT WHICH RELATES TO THE CLIENT IS STRICTLY PROHIBITED.

A&E PROJECT #:	N/A
DRAWN BY:	BNS
CHECKED BY:	DLS

REVISIONS					
\triangle	01/26/2022	CONSTRUCTION ISSUE			
Æ	01/18/2022	PRELIMINARY REVIEW			
Φ	01/11/2022	PRELIMINARY REVIEW			
\triangle	01/07/2022	PRELIMINARY REVIEW			
A	01/03/2022	PRELIMINARY REVIEW			
\mathbb{A}	12/15/2021	PRELIMINARY REVIEW			
NO.	DATE	DESCRIPTION			



IECT No.	
	N/A

SITE NAME

UTILITY SERVICES HOLLY SPRINGS

SITE NUMBER: 5RA0965A

510 10 50 57 1

SITE ADDRESS:

6908 COKESBURY RD HOLLY SPRINGS, NC 27540

DESIGN TYPE:

COLOCATE

SHEET TITLE:

MOUNT DETAILS

C4A

0

REVISION:

MOUNTING DETAILS


SCALE: N.T.S.

PROPOSED 3"x6"x4" STEEL FLAT BAR B/PIPE ₩ PROPOSED HOISTING SUPPORT BRACKET (LOCATED ONLY AT TOP OF MESSENGER PIPE NEAR CATWALK) EXISTING TANK LEG PROPOSED CLUSTER SUPPORT BRACKET (TYP.) PROPOSED 2 3 x 20' LONG -MESSENGER PIPE (TYPICAL.) 2'-3" (TYP.) B/PIPE PROPOSED MESSENGER PIPE THREADED COUPLING (TYPICAL.)

COAX CABLE TANK LEG SUPPORT ELEVATION

NOTES:

- 1. CLUSTER MOUNT TO BE ATTACHED TO INSIDE OF WATER TANK LEG, SEE DETAIL ON THIS SHEET. THE INSIDE FACE OF THE LEG BEING MORE PARTICULARLY DEFINED AS THE EXTERIOR PORTION OF THE CROSS-SECTION OF THE LEG THAT FACES TOWARDS THE CENTER OF THE TANK AND EXTENDS FROM HORIZONTAL STRUT CONNECTION TO HORIZONTAL STRUT CONNECTION.
- 2. ALL METAL (EXPOSED), AND MOUNTS SHALL BE PAINTED TO MATCH THE WATER TANK PER OWNER;S PAIN SPECIFICATIONS.
- 3. ORIENT COAX MOUNT TO CLEAR EXISTING BRACING.
- 4. THE CONTRACTOR SHALL REMOVE GALVANIZATION FROM PIPE AS NECESSARY TO PREVENT ZINC CONTAMINATION OF WELD.
- 5. THE CONTRACTOR SHALL WELD A TAB TO THE MESSENGER PIPE A MAXIMUM OF 1'-0" FROM THE BOTTOM OF THE LOWEST MESSENGER PIPE AND A MAXIMUM OF 1'-0" FROM THE TOP OF THE HIGHEST MESSENGER PIPE.

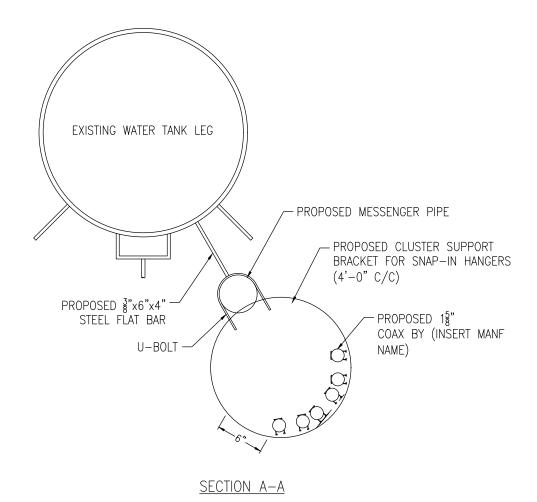

T··Mobile·



1961 NORTHPOINT BLVD, SUITE 130 HIXSON, TN 37343 PH: 423-843-9500 FAX: 423-843-9509

THE INFORMATION CONTAINED IN THIS SET OF DOCUMENTS IS PROPRIETARY BY NATURE. ANY USE OR DISCLOSURE OTHER THAN THAT WHICH RELATES TO THE CLIENT IS STRICTLY PROHIBITED.

A&E PROJECT #:	N/A
DRAWN BY:	BNS
CHECKED BY:	DLS
	DRAWN BY:

REVISIONS		
◬	01/26/2022	CONSTRUCTION ISSUE
Æ	01/18/2022	PRELIMINARY REVIEW
⚠	01/11/2022	PRELIMINARY REVIEW
\triangle	01/07/2022	PRELIMINARY REVIEW
A	01/03/2022	PRELIMINARY REVIEW
\blacksquare	12/15/2021	PRELIMINARY REVIEW
NO.	DATE	DESCRIPTION
_		



N/A

SITE NAME:

UTILITY SERVICES
HOLLY SPRINGS
SITE NUMBER:

5RA0965A

SITE ADDRESS:

SHEET TITLE:

6908 COKESBURY RD HOLLY SPRINGS, NC 27540

ESIGN TYPE:

COLOCATE


MOUNT DETAILS

DRAWING NO


REVISION:


SCALE: N.T.S.

MOUNTING DETAILS

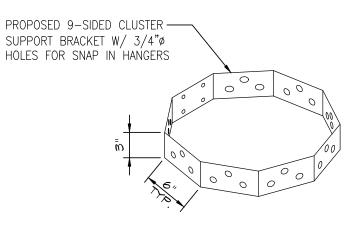


CLUSTER SUPPORT DETAIL

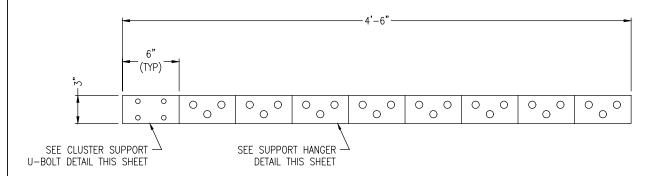


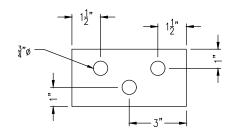


SUPPORT HANGER HOLE DETAIL

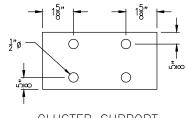


CLUSTER SUPPORT U-BOLT DETAIL

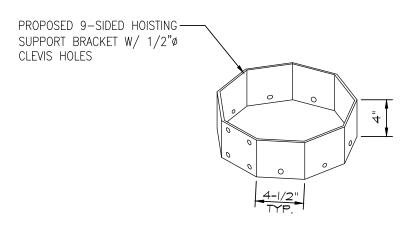

HOISTING BRACKET DETAIL

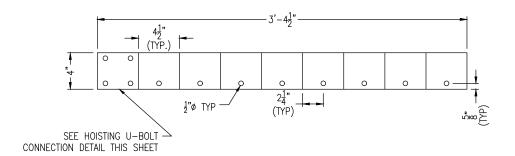

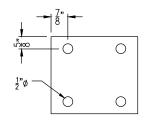

HOISTING U-BOLT DETAIL

T · · Mobile ·



1961 NORTHPOINT BLVD, SUITE 130 HIXSON, TN 37343 PH: 423-843-9500 FAX: 423-843-9509

THE INFORMATION CONTAINED IN THIS SET OF DOCUMENTS IS PROPRIETARY BY NATURE. ANY USE OR DISCLOSURE OTHER THAN THAT WHICH RELATES TO THE CLIENT IS STRICTLY PROHIBITED.

A&E PROJECT #:	N/A
DRAWN BY:	BNS
CHECKED BY:	DLS

[REVISIONS			
◬	01/26/2022	CONSTRUCTION ISSUE		
Æ	01/18/2022	PRELIMINARY REVIEW		
҈	01/11/2022	PRELIMINARY REVIEW		
\triangle	01/07/2022	PRELIMINARY REVIEW		
A	01/03/2022	PRELIMINARY REVIEW		
\mathbb{A}	12/15/2021	PRELIMINARY REVIEW		
NO.	DATE	DESCRIPTION		



PROJECT No. N/A

SITE NAME:

UTILITY SERVICES HOLLY SPRINGS

SITE NUMBER: 5RA0965A

SITE ADDRESS:

6908 COKESBURY RD HOLLY SPRINGS, NC 27540


DESIGN TYPE:

COLOCATE

MOUNT DETAILS

SHEET TITLE:

SCALE: N.T.S.

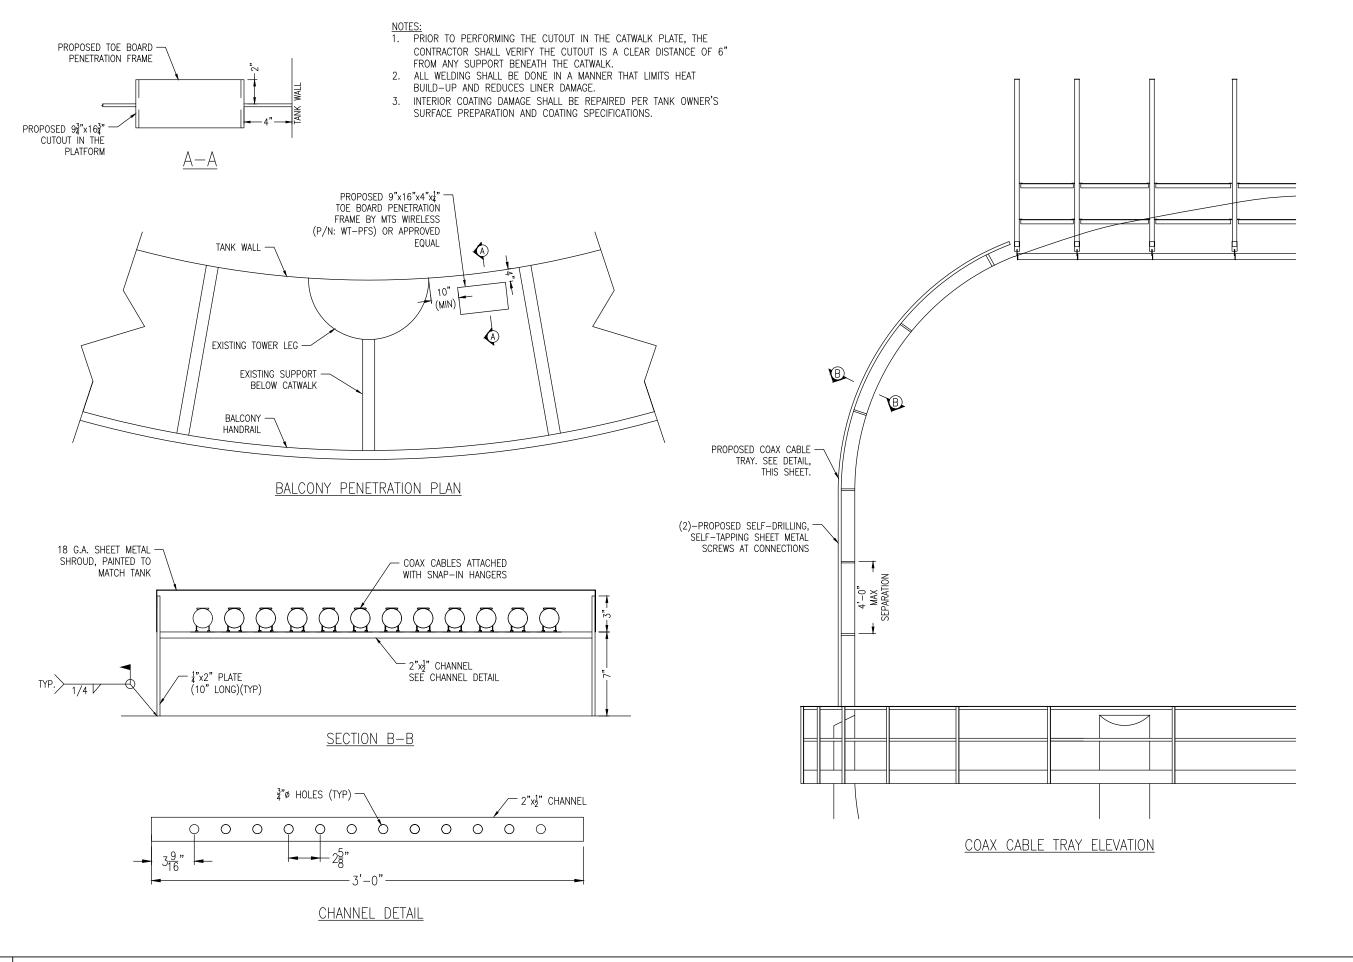

T··Mobile·



1961 NORTHPOINT BLVD, SUITE 130 HIXSON, TN 37343 PH: 423-843-9500 FAX: 423-843-9509

THE INFORMATION CONTAINED IN THIS SET OF DOCUMENTS IS PROPRIETARY BY NATURE. ANY USE OR DISCLOSURE OTHER THAN THAT WHICH RELATES TO THE CLIENT IS STRICTLY PROHIBITED.

A&E PROJECT #:	N/A
DRAWN BY:	BNS
CHECKED BY:	DLS

REVISIONS			
◬	01/26/2022	CONSTRUCTION ISSUE	
Æ	01/18/2022	PRELIMINARY REVIEW	
⚠	01/11/2022	PRELIMINARY REVIEW	
\triangle	01/07/2022	PRELIMINARY REVIEW	
A	01/03/2022	PRELIMINARY REVIEW	
\blacksquare	12/15/2021	PRELIMINARY REVIEW	
NO.	DATE	DESCRIPTION	



PROJECT No.

SITE NUMBER:

N/A SITE NAME:

> UTILITY SERVICES **HOLLY SPRINGS**

5RA0965A

SITE ADDRESS:

6908 COKESBURY RD HOLLY SPRINGS, NC 27540

DESIGN TYPE: COLOCATE


SHEET TITLE:

MOUNT DETAILS


NOTE: SIGNS TO BE MOUNTED ON THE FRONT SIDE OF THE 6160 CABINET.



EMERGENCY SIGN (RED METAL SIGN W/ WHITE LETTERING)

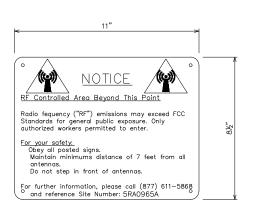

RF NOTICE SIGN (WHITE METAL SIGN W/ BLACK LETTERING)

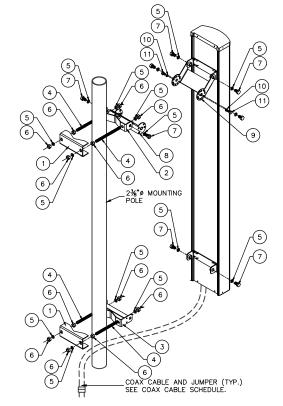

ANTENNA ATTACHMENT HARDWARE:				
ITEM	PART NO.	QTY.	DESCRIPTION	
1	601553-1	2	BRACKET, CLAMP	
2	601539-1	1	ADAPTER, POLE	
3	802355-4	1	ADAPTER, POLE LOWER	
4	ROD190003	4	½" × 7" THREADED ROD	
5	WSH150003	12	½" SPLIT WASHER	
6	NUT150001	12	½" HEX HEAD NUT	
7	BLT140002	6	½" x 1" HEX HEAD BOLT	
8	601730-1	1	BRACKET, DOWNTILT POLE	
9	601735-1	1	BRACKET, DOWNTILT, ANTENNA	
10	WSH150006	2	∜6" SPLIT WASHER	
11)	BLT140004	2	%6" HEX HEAD BOLT	

OVERALL WEIGHT: 10.75 LBS.

T · · Mobile ·



1961 NORTHPOINT BLVD, SUITE 130 HIXSON, TN 37343 PH: 423-843-9500 FAX: 423-843-9509

THE INFORMATION CONTAINED IN THIS SET OF DOCUMENTS IS PROPRIETARY BY NATURE. ANY USE OR DISCLOSURE OTHER THAN THAT WHICH RELATES TO THE CLIENT IS STRICTLY PROHIBITED.

A&E PROJECT #:	N/A
DRAWN BY:	BNS
CHECKED BY:	DLS

REVISIONS			
◬	01/26/2022	CONSTRUCTION ISSUE	
Æ	01/18/2022	PRELIMINARY REVIEW	
◬	01/11/2022	PRELIMINARY REVIEW	
◬	01/07/2022	PRELIMINARY REVIEW	
Æ	01/03/2022	PRELIMINARY REVIEW	
\triangle	12/15/2021	PRELIMINARY REVIEW	
NO.	DATE	DESCRIPTION	



PROJECT No.

N/A

SITE NAME:

UTILITY SERVICES HOLLY SPRINGS

SITE NUMBER:

5RA0965A

SITE ADDRESS:

6908 COKESBURY RD HOLLY SPRINGS, NC 27540

DESIGN TYPE:

COLOCATE

SHEET TITLE:

SITE DETAILS

DRAWING NO

ENCLOSURE 6160 AC



MECHANICAL SPECIFICATION

Weight 145 kg (excluding active equipment)

320 lbs (excluding active equipment)

1600 x 650 x 650 mm (incl. Base frame) Dimension (H x W x D)

63 x 26 x 26 in. (incl. Base frame)

150 mm Base frame height

6 in.

Mounting position Ground Enclosure material Aluminum

Color Power paint NCS 2002-B

Door Front access

Rack type 19" (IEC 60297-3-100) Pad lock or Cylinder Locking type

ENCLOSURE BIGO



Capacity

— VRLA 12V: 100Ah / 150Ah / 170Ah / 190Ah / 210Ah

— Li-Ion: 24U 19" / 23"

— Sodium-Nickel: 3x FIAMM

Electrical specification

— DC Output: -48VDC/200A Battery breakers: 2x 125/2p

— Alarms: Door open, Climate failure, MCB Connection

Mechanical specification

Weight: 134kg

— Dimensions: 63 x 26 x 26 in. (incl. Base frame)

Base frame height: 6 in.

Galvanized steel (180g/m²) — Material: — Color: Powder paint NCS 2002-B

— Door: Front access Locking type: Pad lock / cylinder

Emergency fan

VRLA/Sodium IP44 Li-Ion IP55

500W @L35/L35

15-100%

DC

UTILITY SERVICES **HOLLY SPRINGS**

N/A

T · · Mobile ·

1961 NORTHPOINT BLVD, SUITE 130 HIXSON, TN 37343 PH: 423-843-9500 FAX: 423-843-9509 THE INFORMATION CONTAINED IN THIS SET OF DOCUMENTS IS PROPRIETARY BY NATURE. ANY USE OR DISCLOSURE OTHER THAN THAT WHICH RELATES TO THE CLIENT IS STRICTLY PROHIBITED.

N/A

BNS

DLS

REVISIONS

01/26/2022 CONSTRUCTION ISSUE 01/11/2022 PRELIMINARY REVIEW 01/07/2022 PRELIMINARY REVIEW
 ⚠
 01/03/2022
 PRELIMINARY REVIEW

 ⚠
 12/15/2021
 PRELIMINARY REVIEW

 NO.
 DATE
 DESCRIPTION

A&E PROJECT #:

DRAWN BY:

CHECKED BY:

5RA0965A

SITE ADDRESS:

PROJECT No.

SITE NAME:

SITE NUMBER

6908 COKESBURY RD HOLLY SPRINGS, NC 27540

COLOCATE

SHEET TITLE: **CABINET DETAILS**

REVISION:



Environmental specification

Ingress protection:

 Relative humidity: Climate system

Air Conditioner

— Fan type:

Cooling capacity:


Convection cooling

2 ENCLOSURE BIGO DETAILS


MIROC Excess Fiber Box


MIC0688


PART #	DESCRIPTION	
MIC0647	16" x 19" PVC Slack Box	1
MIC0654	Cable Support Post (2" x 6")	4
MIC0673	Lower Cable Support Post (1" x 6")	2
MIC0663	#10 x 3/8" Phil Pan Screw	
MIC0665	14" Cable Tie	
MIC0674	Slack Box T-Hook	
BS3834	Stainless Steel Hex Head Bolt, 3/8"-16 x 3/4"	
WFS381	Stainless Steel Fender Washer, 3/8" x 1"	
NS38	Stainless Steel Hex Nut, 3/8"	
_	MIC0647 MIC0654 MIC0673 MIC0663 MIC0665 MIC0674 BS3834 WFS381	MIC0647 16" x 19" PVC Slack Box MIC0654 Cable Support Post (2" x 6") MIC0673 Lower Cable Support Post (1" x 6") MIC0663 # 10 x 3/8" Phil Pan Screw MIC0665 14" Cable Tie MIC0674 Slack Box T-Hook BS3834 Stainless Steel Hex Head Bolt, 3/8"-16 x 3/4" WFS381 Stainless Steel Fender Washer, 3/8" x 1"

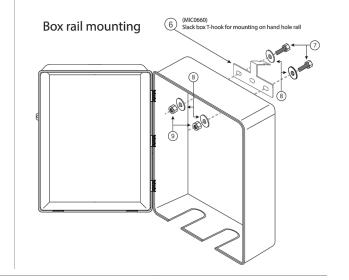

Pan screw locations

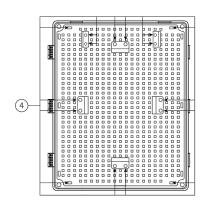


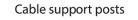

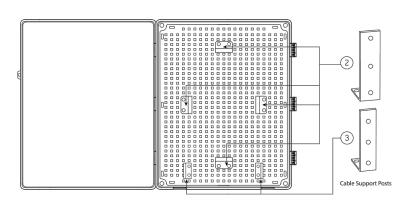


505.343.5371

Box assembled

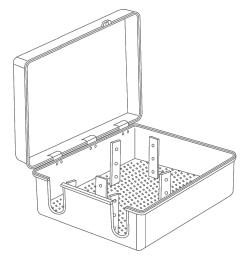


For technical support & product info

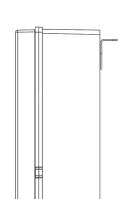

www.miroc.com

Side view

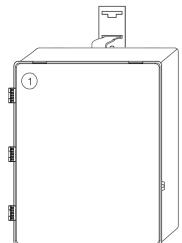

sales@miroc.com

Mounting on rail

PROJECT No.

UTILITY SERVICES HOLLY SPRINGS

N/A

T··Mobile·

1961 NORTHPOINT BLVD, SUITE 130 HIXSON, TN 37343 PH: 423-843-9500 FAX: 423-843-9509

THE INFORMATION CONTAINED IN THIS SET OF DOCUMENTS IS PROPRIETARY

BY NATURE. ANY USE OR DISCLOSURE OTHER THAN THAT WHICH RELATES TO THE CLIENT IS STRICTLY PROHIBITED.

N/A

BNS

DLS

REVISIONS

↑ 01/26/2022 CONSTRUCTION ISSUE
↑ 01/18/2022 PRELIMINARY REVIEW
↑ 01/11/2022 PRELIMINARY REVIEW

| 01/07/2022 | PRELIMINARY REVIEW | 01/03/2022 | PRELIMINARY REVIEW | 12/15/2021 | PRELIMINARY REVIEW | NO. | DATE | DESCRIPTION |

A&E PROJECT #:

DRAWN BY:

CHECKED BY:

SITE NUMBER: 5RA0965A

5101050

SITE ADDRESS:

6908 COKESBURY RD HOLLY SPRINGS, NC 27540

DESIGN TYPE:


COLOCATE

SHEET TITLE:

CABINET DETAILS

DRAWING NO.


C6A

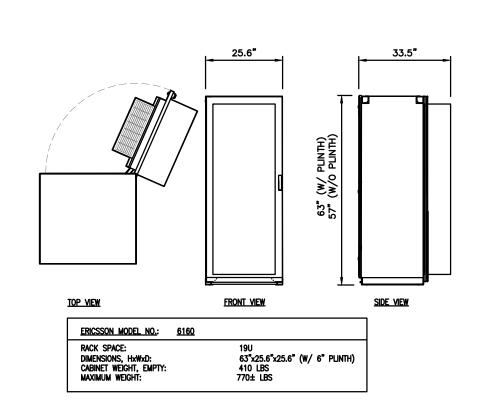

4 Σ Σ Σ

12"

ELEVATION

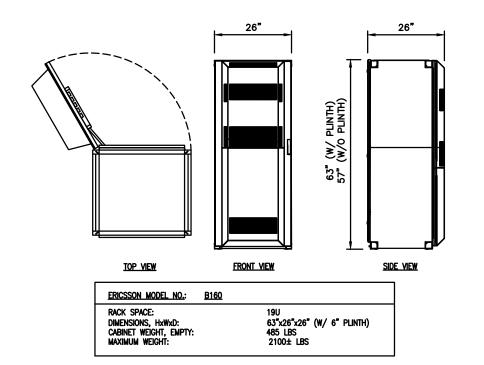

GALVANIZED STEEL

ICE BRIDGE

SUPPORT POST

T · · Mobile ·



1961 NORTHPOINT BLVD, SUITE 130 HIXSON, TN 37343 PH: 423-843-9500 FAX: 423-843-9509

THE INFORMATION CONTAINED IN THIS SET OF DOCUMENTS IS PROPRIETARY BY NATURE. ANY USE OR DISCLOSURE OTHER THAN THAT WHICH RELATES TO THE CLIENT IS STRICTLY PROHIBITED.

A&E PROJECT #:	N/A
DRAWN BY:	BNS
CHECKED BY:	DLS

l	REVISIONS					
l						
l	◬	01/26/2022	CONSTRUCTION ISSUE			
l	Æ	01/18/2022	PRELIMINARY REVIEW			
l	⚠	01/11/2022	PRELIMINARY REVIEW			
l	◬	01/07/2022	PRELIMINARY REVIEW			
1	Æ	01/03/2022	PRELIMINARY REVIEW			
1	\triangle	12/15/2021	PRELIMINARY REVIEW			
l	NO.	DATE	DESCRIPTION			

PROJECT No.

N/A

SITE NAME: UTILITY SERVICES **HOLLY SPRINGS**

SITE NUMBER: 5RA0965A

SITE ADDRESS:

6908 COKESBURY RD HOLLY SPRINGS, NC 27540

DESIGN TYPE:

COLOCATE

ICE BRIDGE & EQUIPMENT **DETAILS**

DRAWING NO.

REVISION:

- 1/2" x 305/8" x 5" GALVANIZED U-BOLT WAVEGUIDE CHANNEL -ASSEMBLY (TYP) 12" BRIDGE SUPPORT P/N WB-LB12-3 = 24" BRIDGE SUPPORT P/N WB-LB24-3 MTS WAVEGUIDE BRIDGE MTS: WB-K210B FIELD VERIFY REQ'D HEIGHT (OR APPROVED EQUAL) VERTICAL TRAPEZE KIT 3" GALVANIZED -MTS: WB-T24-3 STEEL POST CAP - 3-1/2" O.D. PIPE (SCH 40) GALVANIZED 12" DIA ROUND HYBRID CABLES FOUNDATION FROM COVP BOX TOP OF GRAVEL VERTICAL TRAPEZE KIT FINISH GRADE MTS: WB-T24-3 3-1/2" SCH 40

MIRAFI FABRIC 500X

(OR APPROX EQ)

2 BIGO CABINET DETAIL

VS CADWELD #3 AWG -

GROUND RING

GROUND WIRE 6" ABOVE

GRADE FROM POST TO

3 ICE BRIDGE DETAIL

| 6160 CABINET DETAIL

N.T.S

N.T.S



- 1. PROVIDE AND INSTALL WARNING TAPE FOR ELECTRIC SERVICE CONDUIT 2' BELOW GRADE. SEE CONDUIT SECTION ON SHEET E4.
- CONTRACTOR TO PAY FOR THE SERVICE AS DIRECTED BY THE UTILITY COMPANY.
- CONTRACTOR TO USE RIGID METAL CONDUIT WHERE CONDUITS CROSS ACCESS ROADS. CONTRACTOR TO BOND RGS CONDUIT WITH GROUNDING CLAMP TO THE GROUND RADIAL IN
- CONTRACTOR SHALL COORDINATE WITH ELECTRIC AND TELEPHONE UTILITY COMPANIES FOR SERVICES.
- CONTRACTOR TO PAY ALL FEES FOR SERVICES REQUIRED.
- 6. CONTRACTOR TO BE ADVISED THAT EXISTING UNDERGROUND


- GALVANIZED STEEL CONDUIT.

15'

SCALE: 1'' = 15'

45'

BOXES FOR POWER AND TELCO CONDUIT RUNS AS REQUIRED BY

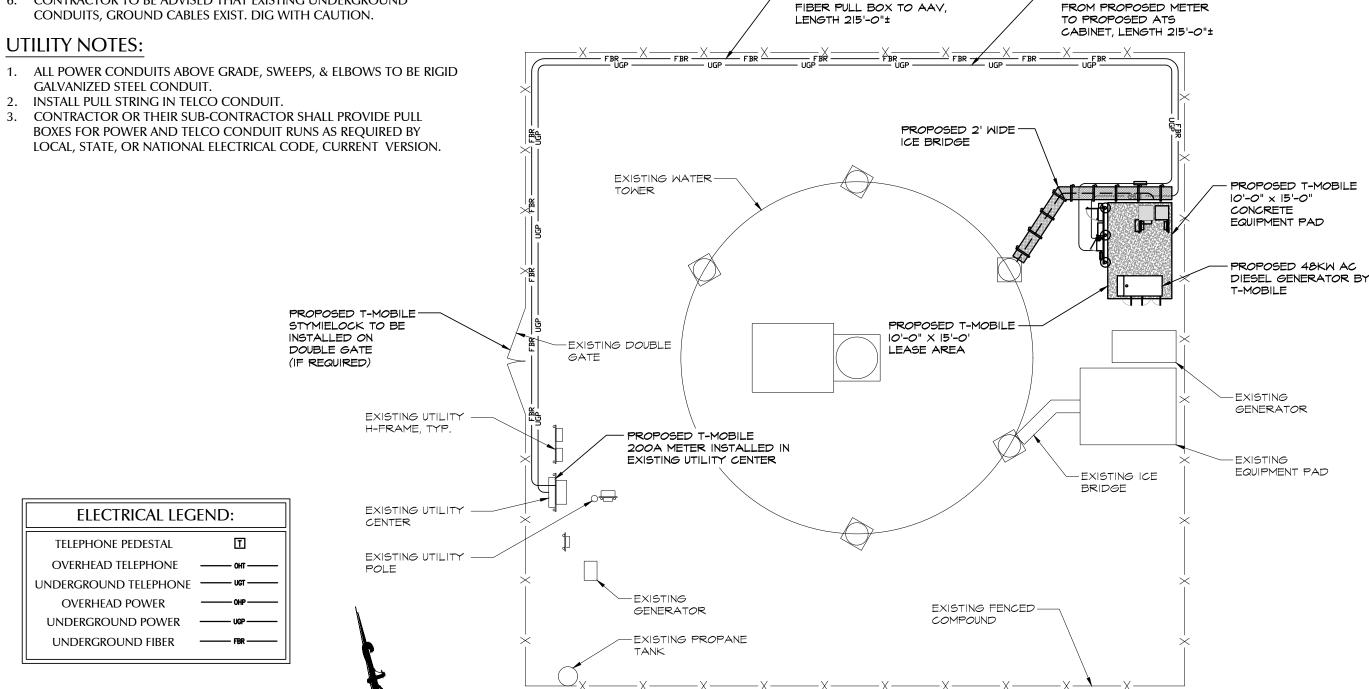

PROPOSED 3" PVC

CONDUIT FOR FIBER FROM

PROPOSED 2" PVC

CONDUIT FOR POWER

T · · Mobile ·



1961 NORTHPOINT BLVD, SUITE 130 HIXSON, TN 37343 PH: 423-843-9500 FAX: 423-843-9509

THE INFORMATION CONTAINED IN THIS SET OF DOCUMENTS IS PROPRIETARY BY NATURE. ANY USE OR DISCLOSURE OTHER THAN THAT WHICH RELATES TO THE CLIENT IS STRICTLY PROHIBITED

A&E PROJECT #:	N/A
DRAWN BY:	BNS
CHECKED BY:	DLS

	REVISIONS		
◬	01/26/2022	CONSTRUCTION ISSUE	
Æ	01/18/2022	PRELIMINARY REVIEW	
◬	01/11/2022	PRELIMINARY REVIEW	
\triangle	01/07/2022	PRELIMINARY REVIEW	
Æ	01/03/2022	PRELIMINARY REVIEW	
\triangle	12/15/2021	PRELIMINARY REVIEW	
NO.	DATE	DESCRIPTION	



PROJECT No N/A

SITE NAME

UTILITY SERVICES **HOLLY SPRINGS**

SITE NUMBER 5RA0965A

SITE ADDRESS

6908 COKESBURY RD HOLLY SPRINGS, NC 27540

COLOCATE

OVERALL ELECTRICAL SITE PLAN


DRAWING NO


GENERAL NOTES:

- 1. CONTRACTOR TO INSTALL PULL BOX EVERY THIRD 90° TURN (MAX).
- 2. NO CONDUITS WILL ROUTE ON TOP OF CONCRETE PAD, ALL CONDUITS TO BE RAN BEFORE CONCRETE PAD IS INSTALLED.

DRAWING NOTES:

- 1. PROPOSED PPC CABINET
- PROPOSED AAV CABINET
- 3. PROPOSED 6160 CABINET
- 4. PROPOSED B160 BATTERY CABINET
- 5. PROPOSED 200A, 120/240V, 1Ø, 3 WIRE METER WITH SERVICE DISCONNECT (120/240V, FUSED AT 200A) IN EXISTING MULTIGANG METER BANK.
- PROPOSED 2" PVC CONDUIT FOR POWER FROM PROPOSED METER TO PROPOSED ATS CABINET
- 7. PROPOSED 3" PVC CONDUIT FOR FIBER FROM FIBER PULL BOX TO AAV
- 8. PROPOSED 2" PVC CONDUIT FOR FIBER FROM AAV TO 6160 CABINET. CONTRACTOR TO RUN CONDUIT UNDERGROUND BEFORE CONCRETE PAD
- 9. PROPOSED 2" PVC CONDUIT FOR POWER FROM PPC TO 6160 CABINET. CONTRACTOR TO RUN CONDUIT UNDERGROUND BEFORE CONCRETE PAD IS INSTALLED.
- 10. CONTRACTOR TO COORDINATE POWER/TELCO SERVICE WITH LOCAL UTILITY COMPANY. STUB UP LOCATIONS TO BE DETERMINED BY LOCAL UTILITY COMPANIES.
- 11. PROPOSED PULL BOX (TYP). SEE GENERAL NOTE.
- 12. PROPOSED 1" CONDUIT WITH PULLSTRING FROM GENERATOR TO 6160 CABINET FOR GENERATOR CONTROLS. CONTRACTOR TO RUN CONDUIT UNDERGROUND BEFORE CONCRETE PAD IS INSTALLED.
- 13. PROPOSED 1 1/2" POWER CONDUIT FROM GENERATOR TO ATS FOR POWER. CONTRACTOR TO RUN CONDUIT UNDERGROUND BEFORE CONCRETE PAD
- 14. PROPOSED 48kw AC DIESEL GENERATOR
- 15. PROPOSED 3" PVC CONDUIT FOR POWER FROM PROPOSED ATS TO PROPOSED PPC CABINET
- 16. PROPOSED ATS
- 17. PROPOSED (2) 2" PVC CONDUITS FOR ALARM AND POWER SUPPLY.
- 18. PROPOSED 1" POWER CONDUIT FROM PPC TO GEN FOR BLOCK HEATER AND BATTERY CHARGER. CONTRACTOR TO RUN CONDUIT UNDERGROUND BEFORE CONCRETE PAD IS INSTALLED.

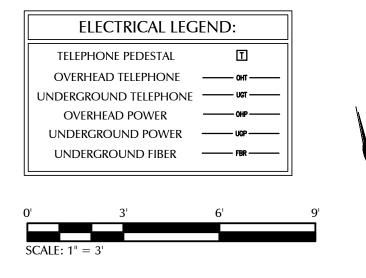

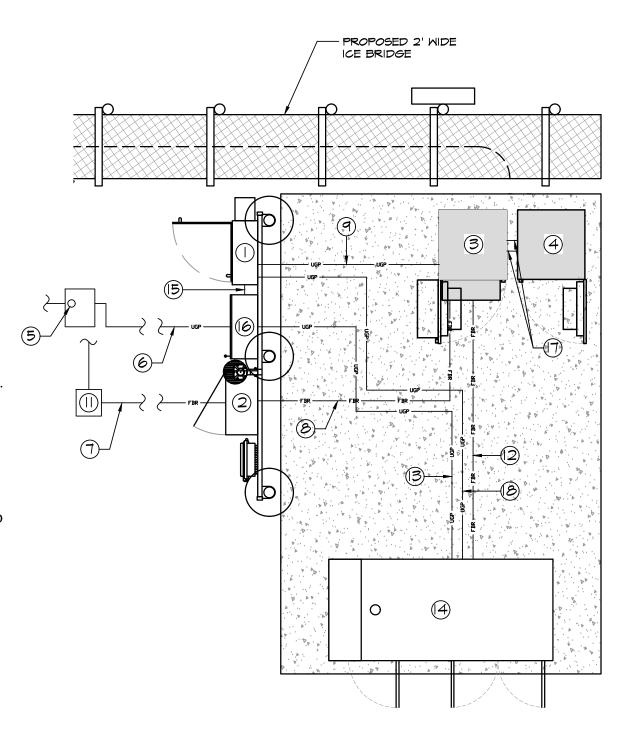

T · · Mobile ·



EXISTING FENCED

COMPOUND

1961 NORTHPOINT BLVD, SUITE 130 HIXSON, TN 37343 PH: 423-843-9500 FAX: 423-843-9509

THE INFORMATION CONTAINED IN THIS SET OF DOCUMENTS IS PROPRIETARY BY NATURE. ANY USE OR DISCLOSURE OTHER THAN THAT WHICH RELATES TO THE CLIENT IS STRICTLY PROHIBITED

	A&E PROJECT #:	N/A
	DRAWN BY:	BNS
l,	CHECKED BY:	DLS

REVISIONS			
\triangle	01/26/2022	CONSTRUCTION ISSUE	
Æ	01/18/2022	PRELIMINARY REVIEW	
⚠	01/11/2022	PRELIMINARY REVIEW	
◬	01/07/2022	PRELIMINARY REVIEW	
Æ	01/03/2022	PRELIMINARY REVIEW	
\triangle	12/15/2021	PRELIMINARY REVIEW	
NO.	DATE	DESCRIPTION	



PROJECT No SITE NAME

N/A

UTILITY SERVICES **HOLLY SPRINGS**

SITE NUMBER 5RA0965A

SITE ADDRESS

6908 COKESBURY RD HOLLY SPRINGS, NC 27540

COLOCATE


ENLARGED ELECTRICAL SITE PLAN

GROUNDING NOTES:

- 1. INSTALL GROUND RING 2 FEET MIN. OUTSIDE OF PAD FOUNDATION AND 6" BELOW GROUND RING. GROUND RING CONSISTS OF 4/0 BARE COPPER WIRE. T-MOBILE REPRESENTATIVE TO INSPECT GROUNDING BEFORE BACKFILLING.
- 2. INSTALL GROUND RING BEFORE PAD IS SET.
- 3. GROUND EACH CABINET FRAME WITH #2 AWG SOLID TINNED COPPER WITH 2 HOLE LUG, 2 PER CABINET BOND TO MASTER GROUND RING.
- 4. EXOTHERMIC WELD ALL CONNECTIONS TO BURIED GROUND RING WITH PARALLEL WELDS.
- 5. GROUND ALL EXTERIOR EXPOSED METAL OBJECTS. USE TWO HOLE MECHANICAL CONNECTORS (T & B 32007) FOR CONNECTION TO FLAT METAL SURFACES. PROVIDE STAINLESS STEEL HARDWARE AND LOCKWASHERS ON ALL MECHANICAL CONNECTIONS. APPLY ANTI-OXIDE COMPOUND TO CONNECTIONS.
- 6. MAKE ALL GROUNDING CONNECTIONS AS SHORT AS POSSIBLE. MINIMUM BENDING RADIUS IS 12".
- 7. CLEAN ALL SURFACES AND BRUSH WITH BRONZE BRUSH PRIOR TO MAKING GROUND CONNECTIONS. PAINT ALL EXOTHERMIC WELDS TO GALVANIZED OBJECTS WITH GALVANIZED PAINT.
- 8. T-MOBILE GROUND RING MUST TEST AT 5 OHMS OR LESS INDEPENDENT OF MASTER RING.

CONSTRUCTION NOTES:

- A. GROUND ALL EXTERIOR EXPOSED METAL OBJECTS. USE TWO HOLE MECHANICAL CONNECTORS (T & B 32007) FOR CONNECTION TO FLAT METAL SURFACES. PROVIDE STAINLESS STEEL HARDWARE AND LOCKWASHERS ON ALL MECHANICAL CONNECTIONS. APPLY ANTI-OXIDE COMPOUND TO CONNECTIONS.
- B. EXOTHERMIC WELDS TO BE USED FOR BONDING OF ALL EXTERIOR SUPPORT STRUCTURES.
- C. ALL ICE BRIDGE SECTIONS TO BE JUMPERED W/ #6 STRANDED.

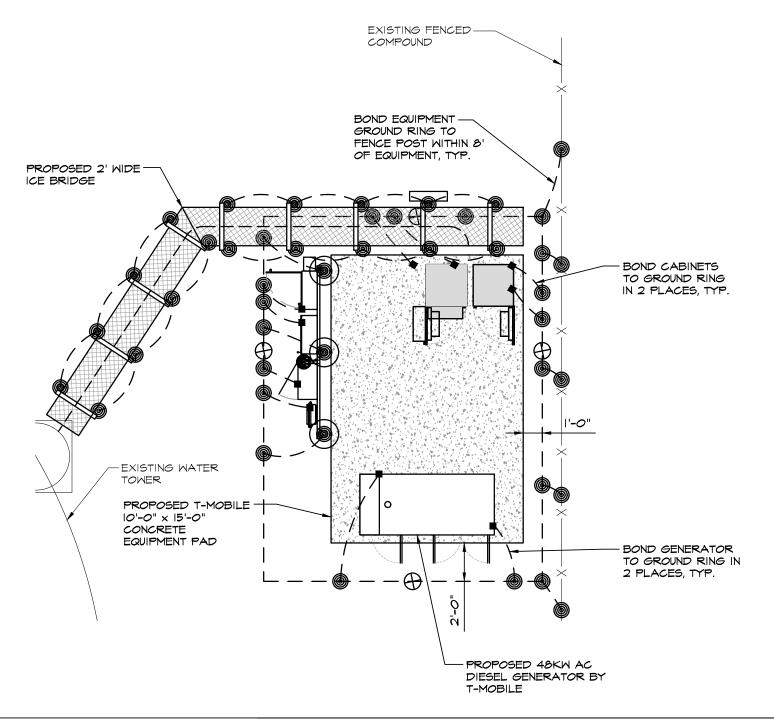

T··Mobile·



1961 NORTHPOINT BLVD, SUITE 130 HIXSON, TN 37343 PH: 423-843-9500 FAX: 423-843-9509

THE INFORMATION CONTAINED IN THIS SET OF DOCUMENTS IS PROPRIETARY BY NATURE. ANY USE OR DISCLOSURE OTHER THAN THAT WHICH RELATES TO THE CLIENT IS STRICTLY PROHIBITED.

A&E PROJECT #:	N/A
DRAWN BY:	BNS
CHECKED BY:	DLS

		REVISIONS		
	◬	01/26/2022	CONSTRUCTION ISSUE	
	Æ	01/18/2022	PRELIMINARY REVIEW	
	◬	01/11/2022	PRELIMINARY REVIEW	
	◬	01/07/2022	PRELIMINARY REVIEW	
l	A	01/03/2022	PRELIMINARY REVIEW	
l	\triangle	12/15/2021	PRELIMINARY REVIEW	
l	NO.	DATE	DESCRIPTION	



PROJECT No.

TE NAME:

UTILITY SERVICES HOLLY SPRINGS

SITE NUMBER: 5RA0965A

SITE ADDRESS:

6908 COKESBURY RD HOLLY SPRINGS, NC 27540

DESIGN TYPE:

COLOCATE

SHEET TITLE:

EQUIPMENT GROUNDING PLAN

DRAWING NO.

E2

0

#2 SOLID BARE COPPER GROUND
CABLE RUN 6" BELOW FROST LINE

5/8" x 10' COPPER CLAD STEEL GROUND

EXOTHERMIC WELD WITH INSPECTION SLEEVE

ROD ROD

GROUNDING LEGEND:

MECHANICAL CONNECTION

EXOTHERMIC WELD

ELECTRICAL SPECIFICATIONS:

- 1. SCOPE: PROVIDE LABOR, MATERIALS, AND EQUIPMENT, ETC., REQUIRED TO COMPLETE THE INSTALLATION SHOWN ON THE DRAWINGS.
- 2. CODES AND STANDARDS: INSTALLATION SHALL COMPLY WITH APPLICABLE LAWS AND ORDINANCES, UTILITY COMPANY REGULATIONS, AND APPLICABLE REQUIREMENTS OF THE LATEST EDITIONS OF:
 - 1. UNIFORM BUILDING CODE.
 - 2. BUILDING OFFICIALS & CODE ADMINISTRATORS (BOCA)
 - 3. UNIFORM MECHANICAL CODE.
 - 4. INTERNATIONAL BUILDING CODE MICHIGAN ADDITION (IBC)
 - 5. ANSI/EIA-222-G LIFE SAFETY CODE NFPA-101.
 - 6. UNIFORM PLUMBING CODE.
 - 7. NATIONAL ELECTRIC CODE.
 - 8. LOCAL BUILDING CODE.
 - 9. CITY/COUNTY ORDINANCES.
- 3. PERMITS: OBTAIN AND PAY FOR REQUIRED PERMITS, LICENSES, FEES, INSPECTIONS, ETC.
- 4. COORDINATION: COORDINATE WORK WITH OTHER TRADES.
- 5. SUBMITTALS: SUBMIT BROCHURES FOR APPROVAL ON MAJOR SYSTEM COMPONENTS.
- EXISTING SERVICES: DO NOT INTERRUPT EXISTING SERVICES WITHOUT WRITTEN PERMISSION OF THE OWNER.
- 7. EQUIPMENT: CONNECT ELECTRICALLY OPERATED EQUIPMENT.
- 8. RECORD DRAWINGS: MAINTAIN A RECORD OF ALL CHANGES AND SUBSTITUTIONS BETWEEN WORK AS SPECIFIED AND INSTALLED. RECORD CHANGES ON A CLEAN SET OF CONTRACT DOCUMENTS WHICH SHALL BE TURNED OVER TO THE OWNER UPON COMPLETION OF THE PROJECT.
- 9. IDENTIFICATION: IDENTIFY SERVICE DISCONNECTING MEANS WITH PERMANENT NAME PLATE.
- 10. GUARANTEE/WARRANTY: GUARANTEE INSTALLATION TO BE FREE OF DEFECTS, SHORTS, GROUNDS, ETC., FOR A PERIOD OF ONE YEAR. FURNISH WARRANTY SO THE DEFECTIVE MATERIALS AND/OR WORKMANSHIP WILL BE REPAIRED/REPLACED IMMEDIATELY UPON NOTIFICATION AT NO COST TO THE OWNER FOR THE PERIOD OF THE WARRANTY.
- 11. CUTTING AND PATCHING: PROVIDE CUTTING REQUIRED TO DO THE WORK. DO NOT CUT MAJOR STRUCTURAL ELEMENTS WITHOUT APPROVAL. PATCHING SHALL BE OF QUALITY EQUAL TO AND OF MATCHING APPEARANCE OF EXISTING CONSTRUCTION.
- DITCHING AND BACKFILL: PROVIDE FOR ALL UNDERGROUND INSTALLED CONDUIT AND/OR CABLES.
- 13. RACEWAYS: UNDERGROUND CONDUIT SHALL BE SCHEDULE 80 PVC CONDUIT (MEET NEMA TC2 1990). EXPOSED CONDUIT SHALL BE RIGID GALVANIZED STEEL CONDUIT. UNDERGROUND PVC CONDUIT SHALL TRANSITION TO RIGID GALVANIZED STEEL CONDUIT BEFORE RISING ABOVE GRADE. PLUG AND CAP EACH END OF SPARE AND EMPTY CONDUITS AND PROVIDE TWO SEPARATE PULL STRINGS 200 LB. TEST POLYETHYLENE CORD. ALL CONDUIT BENDS SHALL BE A MINIMUM OF 24" RADIUS. GRS CONDUITS WHEN SPECIFIED, SHALL MEET UL-6 FOR GALVANIZED STEEL. ALL FITTINGS SHALL BE SUITABLE FOR USE WITH THREADED RIGID CONDUIT.
- 14. SUPPORTS: AS REQUIRED BY THE NEC.

- 15. CONDUCTORS: USE 98% CONDUCTIVITY COPPER WITH TYPE THHN OR EQUIVALENT 90°C INSULATION, 600 VOLT, COLOR CODED. USE SOLID CONDUCTORS FOR WIRE UP TO AND INCLUDING NO. 10 AWG. USE STRANDED CONDUCTORS FOR WIRE ABOVE NO. 10 AWG.
- 16. CONNECTORS FOR POWER CONDUCTORS: USE COMPRESSION TYPE INSULATED CONNECTORS FOR #10 AWG AND SMALLER. USE SOLDERLESS MECHANICAL TERMINAL LUGS FOR #8 AWG AND LARGER.
- 17. GROUNDING: MAIN GROUNDING CONDUCTORS SHALL BE A MINIMUM OF #2 AWG SOLID TINNED COPPER. GROUNDING LEADS ON ANTENNA SUPPORT STRUCTURES SHALL BE A MINIMUM OF #2 AWG SOLID BARE COPPER AND SHALL BE TINNED WHERE THEY ARE INSTALLED AGAINST THE STRUCTURE. GROUND BARS SHALL BE 1/4" THICK, 4" WIDE, LENGTH AS REQUIRED. GROUND RESISTANCE TO BE 5 OHM MAXIMUM. PROVIDE ADDITIONAL GROUNDING PLATES AS REQUIRED.
- 18. TELEPHONE SERVICE: PROVIDE EMPTY CONDUITS WITH PULL WIRES (10' ON EACH SIDE OF CONDUIT).
- 19. SERVICE: 240/120, SINGLE PHASE, 3 WIRE, 200 AMP FROM THE METER.

T··Mobile·



1961 NORTHPOINT BLVD, SUITE 130 HIXSON, TN 37343 PH: 423-843-9500 FAX: 423-843-9509

THE INFORMATION CONTAINED IN THIS SET OF DOCUMENTS IS PROPRIETARY BY NATURE. ANY USE OR DISCLOSURE OTHER THAN THAT WHICH RELATES TO THE CLIENT IS STRICTLY PROHIBITED.

A&E PROJECT #:	N/A
DRAWN BY:	BNS
CHECKED BY:	DLS

	REVISIONS		
◬	01/26/2022	CONSTRUCTION ISSUE	
Æ	01/18/2022	PRELIMINARY REVIEW	
Φ	01/11/2022	PRELIMINARY REVIEW	
◬	01/07/2022	PRELIMINARY REVIEW	
A	01/03/2022	PRELIMINARY REVIEW	
\triangle	12/15/2021	PRELIMINARY REVIEW	
NO.	DATE	DESCRIPTION	



PROJECT No

SITE NAME:

UTILITY SERVICES HOLLY SPRINGS

N/A

SITE NUMBER:

5RA0965A

SITE ADDRESS

6908 COKESBURY RD HOLLY SPRINGS, NC 27540

DESIGN TY


COLOCATE


SHEET TITLE:

ELECTRICAL SPECIFICATIONS NOTES


DRAWING NO

-3

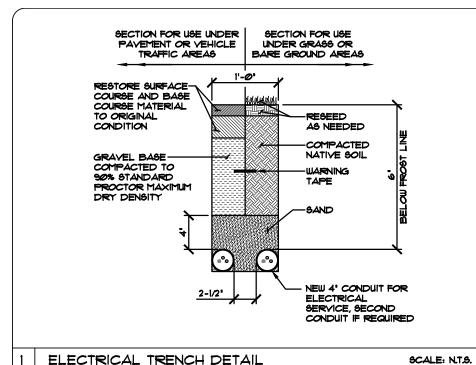

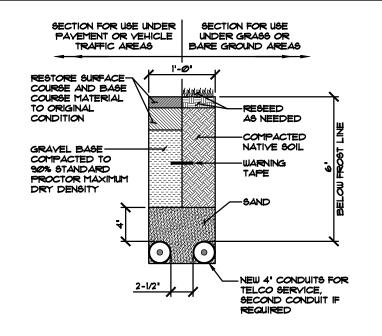

TELEPHONE TRENCH DETAIL

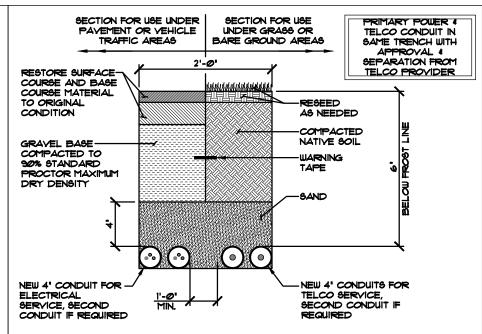

JOINT UTILITY TRENCH DETAIL

T · · Mobile ·



1961 NORTHPOINT BLVD, SUITE 130 HIXSON, TN 37343 PH: 423-843-9500 FAX: 423-843-9509

THE INFORMATION CONTAINED IN THIS SET OF DOCUMENTS IS PROPRIETARY BY NATURE. ANY USE OR DISCLOSURE OTHER THAN THAT WHICH RELATES TO THE CLIENT IS STRICTLY PROHIBITED.

SCALE: N.T.S.	A&E PROJECT #:	N/A
	DRAWN BY:	BNS
	CHECKED BY:	DLS

REVISIONS		
◬	01/26/2022	CONSTRUCTION ISSUE
Æ	01/18/2022	PRELIMINARY REVIEW
⚠	01/11/2022	PRELIMINARY REVIEW
\triangle	01/07/2022	PRELIMINARY REVIEW
Æ	01/03/2022	PRELIMINARY REVIEW
\triangle	12/15/2021	PRELIMINARY REVIEW
NO.	DATE	DESCRIPTION



PROJECT No N/A

SITE NAME

SCALE: N.T.S.

UTILITY SERVICES HOLLY SPRINGS SITE NUMBER

5RA0965A

SITE ADDRESS: 6908 COKESBURY RD

HOLLY SPRINGS, NC 27540

DESIGN TYPE COLOCATE

SHEET TITLE:


ELECTRICAL DETAILS


DRAWING NO.

REVISION:

NOTES:


- **EXCAVATE TO REQUIRED DEPTH**
- **VERIFY ALL TRENCHING REQUIREMENTS WITH** SERVING UTILITIES.
- CALL BEFORE YOU DIG. CONTACT SERVING UTILITIES.

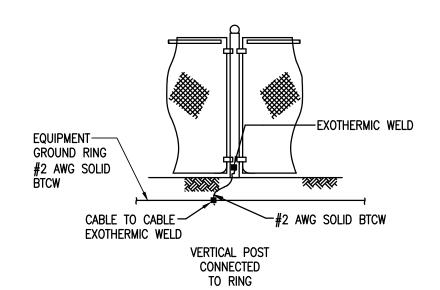

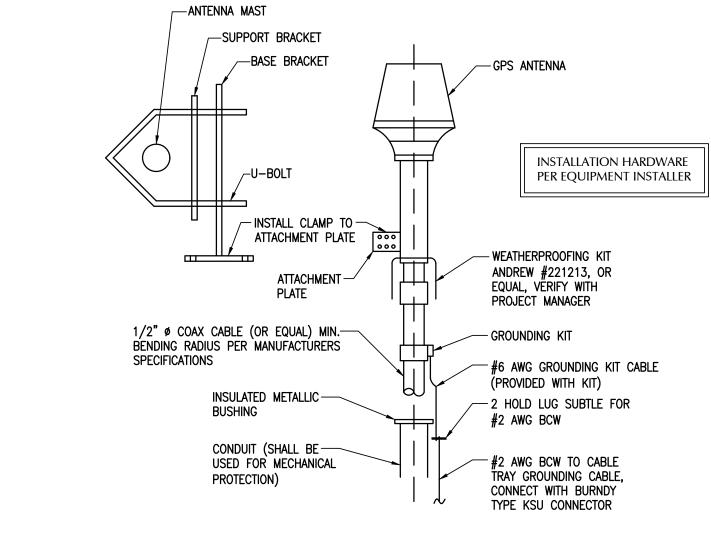

SCALE: N.T.S.


3

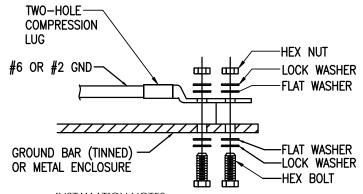

INSTALLATION NOTES:

- 1. BOLTS, WASHERS, AND NUTS SHALL BE STAINLESS STEEL.
- 2. SELECT BOLT LENGTH TO PROVIDE A MINIMUM OF TWO EXPOSED THREADS.
- 3. BURNISH MOUNTING SURFACE TO REMOVE PAINT IN THE AREA OF LUG CONTACT.
- 4. APPLY ANTI-OXIDANT COMPOUND TO MATING SURFACE OF LUG & WIPE CLEAN EXCESS COMPOUND.
- 5. USE 1/4" HARDWARE FOR ATTACHMENT TO METAL ENCLOSURES & 3/8" FOR ATTACHMENT TO GROUND BARS.
- 6. ALL BOLTS MUST HAVE AT LEAST 2 THREAD ENGAGEMENT.


GROUNDING CONNECTION TO GROUND BAR OR FLAT SURFACE

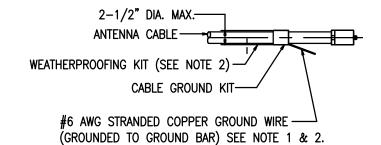

GROUND KIT NOTES:


- 1. DO NOT INSTALL CABLE GROUND KIT AT A BEND AND ALWAYS DIRECT GROUND WIRE DOWN TO GROUND BAR.
- 2. GROUNDING KIT AND WEATHER PROOFING KIT SHALL BE OF THE SAME TYPE AND PART NUMBER AS SUPPLIED OR RECOMMENDED BY CABLE MANUFACTURER.


CONNECTION OF CABLE GROUND KIT TO ANTENNA CABLE

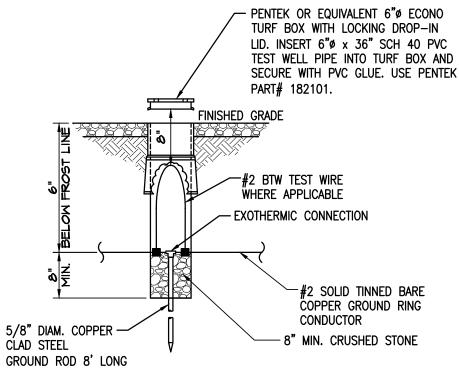

INSPECTION SLEEVE DETAIL NTS

INSTALLATION OF GROUND WIRE TO GROUND BAR NTS

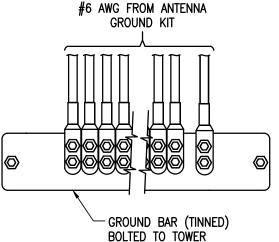

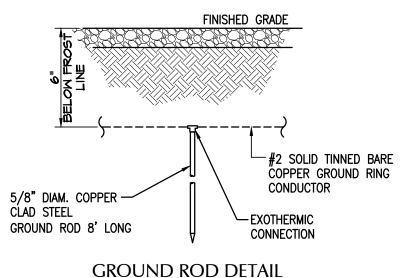

T · · Mobile ·



1961 NORTHPOINT BLVD, SUITE 130 HIXSON, TN 37343 PH: 423-843-9500 FAX: 423-843-9509

THE INFORMATION CONTAINED IN THIS SET OF DOCUMENTS IS PROPRIETARY BY NATURE. ANY USE OR DISCLOSURE OTHER THAN THAT WHICH RELATES TO THE CLIENT IS STRICTLY PROHIBITED

A&E PROJECT #:	N/A
DRAWN BY:	BNS
CHECKED BY:	DLS

		REVISIONS		
١				
١	◬	01/26/2022	CONSTRUCTION ISSUE	
١	Æ	01/18/2022	PRELIMINARY REVIEW	
١	⚠	01/11/2022	PRELIMINARY REVIEW	
١	◬	01/07/2022	PRELIMINARY REVIEW	
١	Æ	01/03/2022	PRELIMINARY REVIEW	
١	\triangle	12/15/2021	PRELIMINARY REVIEW	
١	NO.	DATE	DESCRIPTION	



PROJECT No. N/A

SITE NAME:

UTILITY SERVICES **HOLLY SPRINGS**

SITE NUMBER 5RA0965A


SITE ADDRESS:

6908 COKESBURY RD HOLLY SPRINGS, NC 27540

COLOCATE

SHEET TITLE:

GROUNDING DETAILS

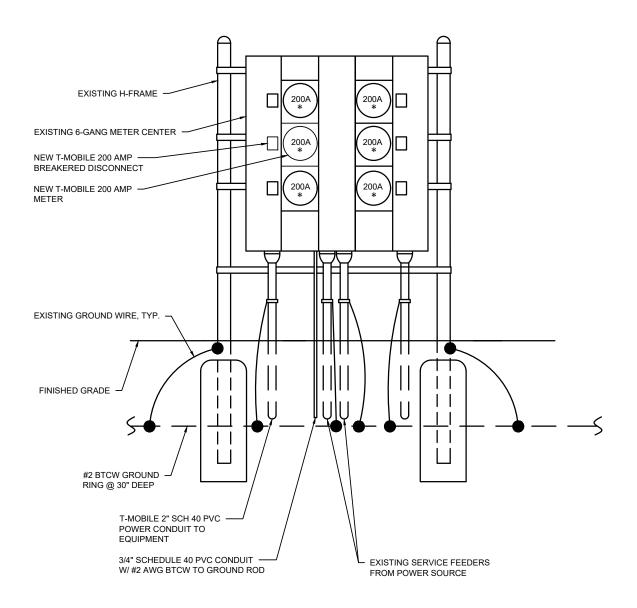

6-GANG METER CENTER

FRONT VIEW

T··Mobile-



1961 NORTHPOINT BLVD, SUITE 130 HIXSON, TN 37343 PH: 423-843-9500 FAX: 423-843-9509

THE INFORMATION CONTAINED IN THIS SET OF DOCUMENTS IS PROPRIETARY BY NATURE. ANY USE OR DISCLOSURE OTHER THAN THAT WHICH RELATES TO THE CLIENT IS STRICTLY PROHIBITED.

A&E PROJECT #:	N/A
DRAWN BY:	BNS
CHECKED BY:	DLS

	REVISIONS					
◬	01/26/2022	CONSTRUCTION ISSUE				
Æ	01/18/2022	PRELIMINARY REVIEW				
⚠	01/11/2022	PRELIMINARY REVIEW				
A	01/07/2022	PRELIMINARY REVIEW				
Æ	01/03/2022	PRELIMINARY REVIEW				
\triangle	12/15/2021	PRELIMINARY REVIEW				
NO.	DATE	DESCRIPTION				



PROJECT No.

N/A

SITE NAME:

UTILITY SERVICES HOLLY SPRINGS

SITE NUMBER: 5RA0965A

310 10 303

SITE ADDRESS:

6908 COKESBURY RD HOLLY SPRINGS, NC 27540

DESIGN TYPE:

COLOCATE

SHEET TITLE:

ELECTRICAL DETAILS

E6

REVISION:


SCALE: N.T.S.

KEYED COMPONENT NOTES:

- EXISTING UTILITY TRANSFORMER.
- EXISTING METER CENTER WITH (4) AVAILABLE METER SOCKETS.
- NEW 200 AMP MAIN BREAKER COMPATIBLE WITH EXISTING SERVICE EQUIPMENT, BY CONTRACTOR.
- NEW 200 AMP, 2-POLE, SOLID NEUTRAL AUTOMATIC TRANSFER SWITCH.
- NEW 200 AMP, 120/240V, 3W, DISTRIBUTION PANEL.
- NEW EMERGENCY 48KW BACK UP GENERATOR.

KEYED CONDUIT NOTES:

- (1) EXISTING CONDUIT & CONDUCTORS.
- EXISTING SERVICE GROUNDING.
- NEW 2" CONDUIT MINIMUM WITH (3) #3/O COPPER THWN CONDUCTORS \$ (1) #2 COPPER GROUND.
- NEW 2" CONDUIT MINIMUM WITH (3) #3/O COPPER THWN CONDUCTORS AND (1) #2 COPPER GROUND.

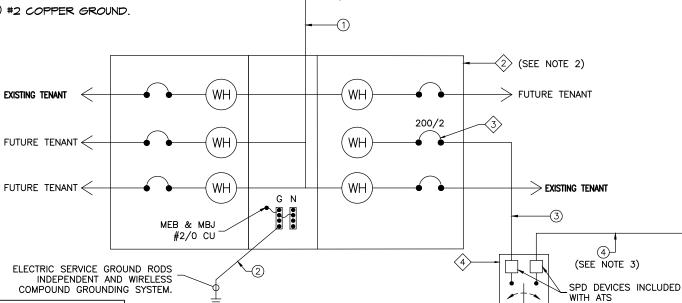

#2 STRANDED INSULATED COPPER TO

MGB. LABEL AS "LEAD #13"

\$\langle\frac{1}{1}\$ SINGLE-PHASE UTILITY TRANSFORMER

					POWE	R PANE	L (PROF	OSED)					
	MAIN BREAKER (A)	200		VC	LTAGE	120/240	V, 1 Pi	H, 3W					
POS	DESCRIPTION	BKR	ON / OFF	C / NC	VA	L1 (VA)	L2 (VA)	VA	C / NC	ON / OFF	BKR	DESCRIPTION	POS
1	TVSS	60	ON	С	0	0		0	С	ON			2
3	1 1033	"	ON	С	0		9000	9000	С	ON	150	ERICSSON 6160	4
5	TELCO GFCI	20	ON	NC	180	9180		9000	С	ON	130	ERICSSON 0100	6
7	GEN BLOCK HEATER	20	ON	NC	1500		1500	0	С	ON			8
9	GEN BATTERY CHARGER	20	ON	NC	1000	1180		180	NC	ON	20	6160 GFCI	10
11	VACANT	-					360	360	NC	ON	20	WORK LIGHT	12
13	VACANT	-	-	-		0			-	-	-	VACANT	14
15	VACANT	-	-	-			0		-	-	-	VACANT	16
17	VACANT	-	-	-		0			-	-	-	VACANT	18
19	VACANT	-	-	-			0		-	-	-	VACANT	20
21	VACANT	-	-	-		0			-	-	-	VACANT	22
23	VACANT	-	-	-			0		-	-	-	VACANT	24
	PHASE TOT	ALS (V	4)	•		10,360	10,860	AMP	ERES P	ER PHA	SE CAN	NOT EXCEED MAIN BREAK	KER
	PHASE CURRENT (A) 105 10		109	RATING									
	PANEL TO	TAL (VA)			21,	220	L	.EGEND	C=COI	OUNITA	US, NC=NON-CONTINUOUS	
	F	PANEL	CAPACI	TY AT 80	0% (VA)	38,4	00.0						
	PANEL LOADING (100% N	OD-NC	JOUNITN	IS) (VA)	3,2	20.0						
	PANEL LOAD	ING (12	100 %č	JOUNITN	IS) (VA)	22,5	0.00						
		TOTAL	PANEL	LOADI	VG (VA)	25,7	'20.0						

AC PANEL SCHEDULE

NTS

PANEL SPARE CAPACITY (VA) 12,680.0

ONE LINE DIAGRAM

I. ALL CONDUIT NOT SPECIFIED OTHERWISE SHALL BE SCHD. 40 PVC BELOW GRADE, IMC ABOVE. 2. CONTRACTOR TO VERIFY THAT THE AVAILABLE FAULT CURRENT DOES NOT EXCEED THE LIMITS OF THE ELECTRICAL COMPONENTS.

T · · Mobile ·




1961 NORTHPOINT BLVD, SUITE 130 HIXSON, TN 37343 PH: 423-843-9500 FAX: 423-843-9509

THE INFORMATION CONTAINED IN THIS SET OF DOCUMENTS IS PROPRIETARY BY NATURE. ANY USE OR DISCLOSURE OTHER THAN THAT WHICH RELATES TO THE CLIENT IS STRICTLY PROHIBITED

A&E PROJECT #:	N/A
DRAWN BY:	BNS
CHECKED BY:	DLS

REVISIONS						
◬	01/26/2022	CONSTRUCTION ISSUE				
Æ	01/18/2022	PRELIMINARY REVIEW				
҈Ѧ	01/11/2022	PRELIMINARY REVIEW				
◬	01/07/2022	PRELIMINARY REVIEW				
Æ	01/03/2022	PRELIMINARY REVIEW				
\triangle	12/15/2021	PRELIMINARY REVIEW				
NO.	DATE	DESCRIPTION				
		△ 01/26/2022 △ 01/18/2022 △ 01/11/2022 △ 01/07/2022 △ 01/03/2022 △ 12/15/2021				

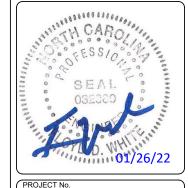

SITE NAME:

UTILITY SERVICES HOLLY SPRINGS

N/A

SITE NUMBER 5RA0965A

SITE ADDRESS:

6908 COKESBURY RD HOLLY SPRINGS, NC 27540

DESIGN TYPE:

COLOCATE

PANEL SCHEDULE

ONE LINE DIAGRAM &

E6A

UTILITY NOTE:

-3 (SEE NOTE 3)

)200/2

ONE LINE DIAGRAM

1. GC TO INSTALL BRASS NAMES PLATES SECURED WITH POP RIVETS ON ALL T-MOBILE ITEMS (HOFFMAN BOX, METER BASE, DISCONNECT, ETC.)

6


200/2

SCALE: N.T.S.

AC PANEL SCHEDULE

NOTES:

- ALL EQUIPMENT SHALL BE GROUNDED
- ALL ELECTRICAL ENCLOSURES TO BE NEMA 3R RATED
- SEE SITE PLAN FOR GENERAL ROUTING OF ALL CONDUITS. DETERMINE EXACT ROUTINGS IN FIELD.
- ELECTRICAL EQUIPMENT SHALL BE A MIN. 3'-O" FROM ANY STRUCTURE.
- ALL COVERPLATES TO BE WEATHERPROOF.
- 6. INSTALL CAPS ON ALL OPEN POST
- INSTALL UNISTRUT BEHIND SUPPORT POST AS SHOWN
- ALL LBs MUST BE RIGID METALLIC
- 9. IF CAM LOCK GENERATOR CONNECTOR IS ON THE RIGHT SIDE OF THE PPC REVERSE H-FRAME LAYOUT

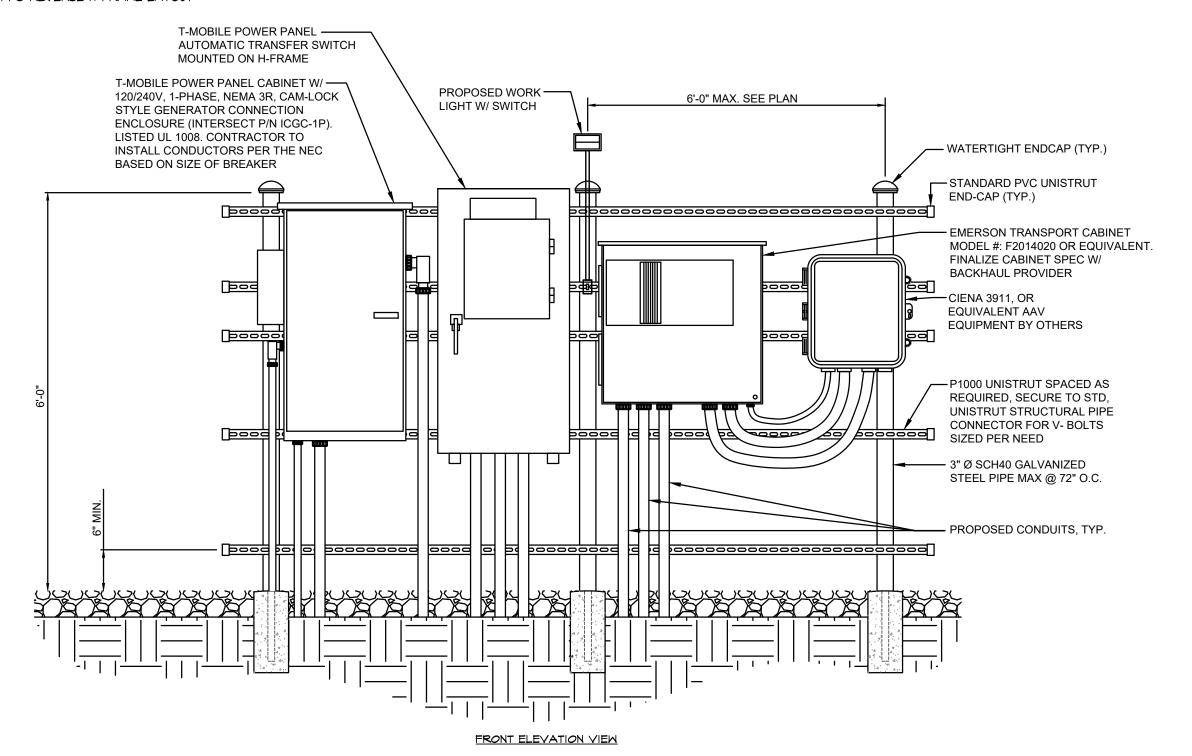

T··Mobile·



1961 NORTHPOINT BLVD, SUITE 130 HIXSON, TN 37343 PH: 423-843-9500 FAX: 423-843-9509

THE INFORMATION CONTAINED IN THIS SET OF DOCUMENTS IS PROPRIETARY BY NATURE. ANY USE OR DISCLOSURE OTHER THAN THAT WHICH RELATES TO THE CLIENT IS STRICTLY PROHIBITED

A&E PROJECT #:	N/A
DRAWN BY:	BNS
CHECKED BY:	DLS

	REVISIONS					
◬	01/26/2022	CONSTRUCTION ISSUE				
Æ	01/18/2022	PRELIMINARY REVIEW				
⚠	01/11/2022	PRELIMINARY REVIEW				
◬	01/07/2022	PRELIMINARY REVIEW				
Æ	01/03/2022	PRELIMINARY REVIEW				
\triangle	12/15/2021	PRELIMINARY REVIEW				
NO.	DATE	DESCRIPTION				



PROJECT No

N/A

SITE NAME:

UTILITY SERVICES HOLLY SPRINGS

SITE NUMBER 5RA0965A

SITE ADDRESS:

6908 COKESBURY RD HOLLY SPRINGS, NC 27540

DESIGN TYPE:


COLOCATE

EQUIPMENT H-FRAME RACK DETAIL

DRAWING NO. E₆B

REVISION:

SCALE: N.T.S.

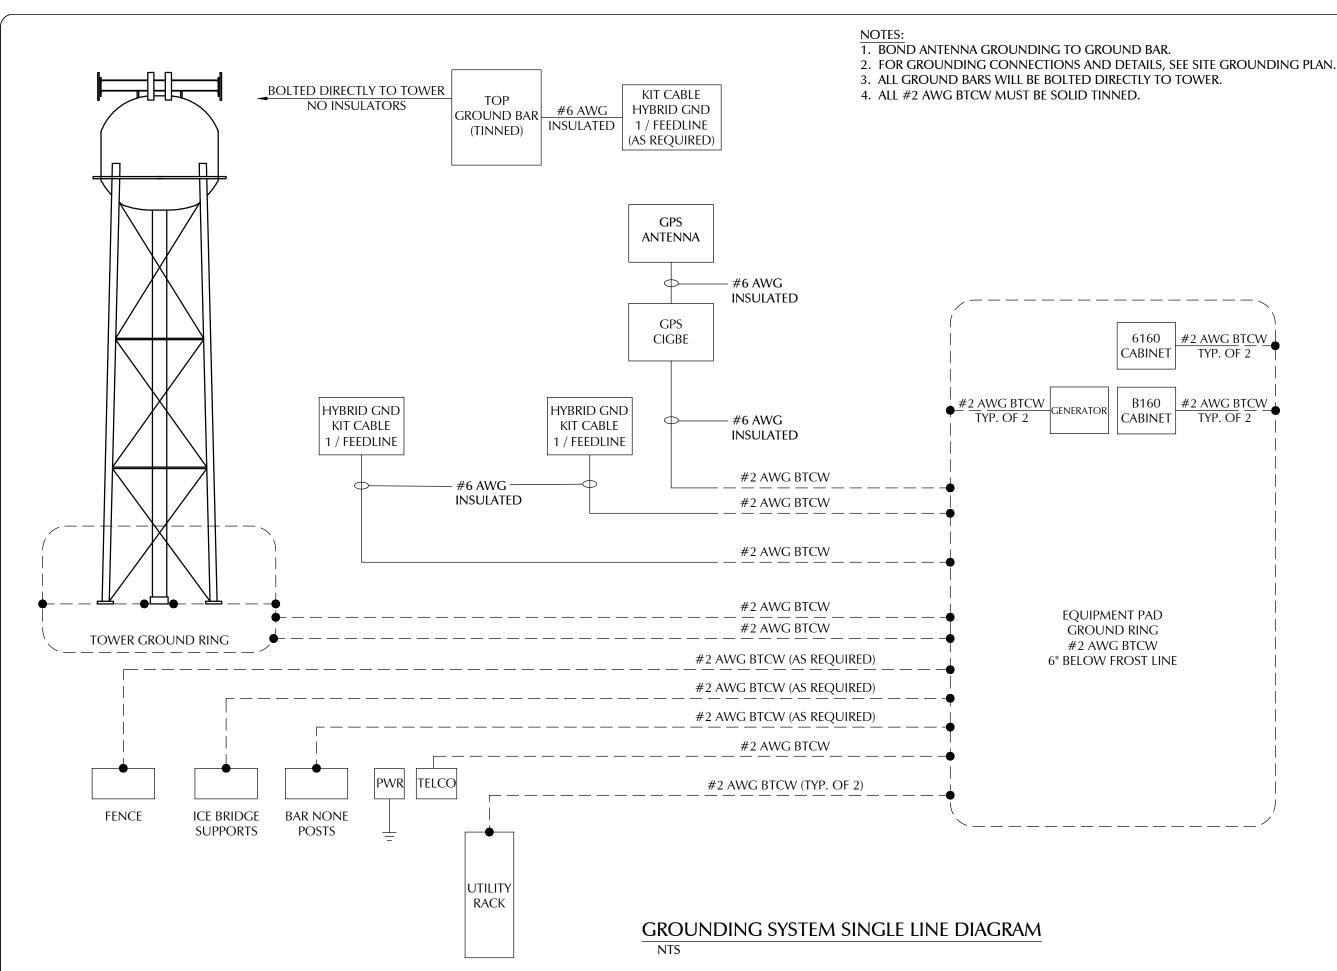

T··Mobile·



1961 NORTHPOINT BLVD, SUITE 130 HIXSON, TN 37343 PH: 423-843-9500 FAX: 423-843-9509

THE INFORMATION CONTAINED IN THIS SET OF DOCUMENTS IS PROPRIETARY BY NATURE. ANY USE OR DISCLOSURE OTHER THAN THAT WHICH RELATES TO THE CLIENT IS STRICTLY PROHIBITED

A&E PROJECT #:	N/A
DRAWN BY:	BNS
CHECKED BY:	DLS

(REVISIONS					
◬	01/26/2022	CONSTRUCTION ISSUE				
Æ	01/18/2022	PRELIMINARY REVIEW				
₼	01/11/2022	PRELIMINARY REVIEW				
A	01/07/2022	PRELIMINARY REVIEW				
Æ	01/03/2022	PRELIMINARY REVIEW				
\triangle	12/15/2021	PRELIMINARY REVIEW				
NO.	DATE	DESCRIPTION				



SITE NAME:

UTILITY SERVICES **HOLLY SPRINGS**

N/A

SITE NUMBER 5RA0965A

SITE ADDRESS:

6908 COKESBURY RD HOLLY SPRINGS, NC 27540

COLOCATE

SHEET TITLE:

GROUNDING SINGLE LINE

REVISION:

SCALE: N.T.S.