STATE LOCATION

SITE LOCATION



PROJECT TEAM

PROJECT CONTACT:

NAME U.S. CELLULAR CORPORATION **ADDRESS** CITY, STATE, ZIP

8410 W BRYN MAWR SUITE 700 CHICAGO, IL 60631 MICHAEL SZLAMCZYNSKI

SITE ACQUISITION:

CONTACT

NAME **ADDRESS** CITY, STATE, ZIP

TOWER ENGINEERING PROFESSIONALS 10700 SIKES PLACE, SUITE 360 CHARLOTTE, NC 28277

CONTACT NEAL FLOYD PHONE (980) 202-5546

TOWER OWNER:

NAME US CELLULAR CORPORATION 8410 W. BRYN MAWR, SUITE 700 **ADDRESS** CITY, STATE, ZIP CHICAGO, IL 60631

CONTACT MICHAEL SZLAMCZYNSKI

CIVIL ENGINEER:

NAME TOWER ENGINEERING PROFESSIONALS, INC. **ADDRESS** 326 TRYON ROAD

RALEIGH, NC 27603-3530 CITY, STATE, ZIP CONTACT JOHN H. BEST III, P.E. **PHONE** (919) 661-6351

W3 AMENDMENT DRAWINGS

ARLINGTON

556470

SITE ADDRESS:

11884 US HWY 421 NORTH BROADWAY, NC (HARNETT COUNTY)

PROJECT INFORMATION

LATITUDE: N 35° 26' 15.6" * LONGITUDE: W 79° 01' 11.8" * GROUND ELEVATION: 140.8'± (AMSL) ** * INFORMATION PROVIDED BY USCC ** INFORMATION FROM GOOGLE EARTH

TOWER TYPE: **280' GUYED** LOADING TYPE: **DX1010A ACCESS ISSUES:** N/A **GATE COMBO:** 0243



Know what's **below**. Call before you dig.

INDEX OF SHEETS

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STRUCTURAL NOTE

STRUCTURAL STATUS:

- TOWER SA PASSING (JULY 22, 2021)
- MOUNT SA FAILING (JUNE 30, 2020)
- MOUNT MODIFICATION PASSING (OCTOBER 15, 2020)

SCOPE OF WORK

TOWER SCOPE:

- EXISTING EQUIPMENT TO REMAIN:
 (3) KMW AM-X-CD-17-65-00T-RET LTE PANEL ANTENNAS
 - ANTEL BXA-80090/8 CDMA PANEL ANTENNA
 - (2) ANTEL BXA-80063/8CF CDMA PANEL ANTENNAS
- (6) FH 1%" CDMA COAX (1) RAYCAP RUSDC-6267-PF-48
- (1) 1¼" HYBRID CABLE (3) ERICSSON RRUS-11 B5 RRUS

- (3) DENGYO OCT8-2LX2HX-BW65 LTE PANEL ANTENNAS (2) ERICSSON RRU 4449 B12/B71 RRUs (2) ERICSSON RRU 4415 B66 RRUs
- 1) RAYCAP RUSDC-6267-PF-48
- (1) 11/4" HYBRID CABLE

- PROPOSED LTE JUMPERS:

 (4) FIBER JUMPERS FROM RAYCAP TO B12/B71 RRUs

 (4) FIBER JUMPERS FROM RAYCAP TO B66 RRUs

 (2) FIBER JUMPERS FROM RAYCAP TO B5 RRUs
- FIBER JUMPERS FROM B5 TO B5 RRUS
- 4) POWER JUMPERS FROM RAYCAP TO B12/B71 RRUS) POWER JUMPERS FROM RAYCAP TO B66 RRUS
- (3) POWER JUMPERS FROM RAYCAP TO B5 RRUS

- (8) 光" JUMPERS FROM B12/B71 RRUS TO ANTENNAS (8) 光" JUMPERS FROM B66 RRUS TO ANTENNAS (6) 光" JUMPERS FROM B5 RRUS TO ANTENNAS (2) RET JUMPERS FROM B12/B71 RRUS TO ANTENNAS
- RET JUMPERS FROM B66 RRUS TO ANTENNAS
- (3) RET JUMPERS FROM B5 RRUS TO ANTENNAS

TOP TOWER GROUND BAR:
CANNOT ACCOMMODATE ADDITIONAL GROUND LEADS.
PROPOSED GROUND BAR REQUIRED.

MIDDLE TOWER GROUND BAR:
CAN ACCOMMODATE ADDITIONAL GROUND LEAD.

BOTTOM TOWER GROUND BAR:
CAN ACCOMMODATE ADDITIONAL GROUND LEAD.

EQUIPMENT PAD SCOPE:

CAN ACCOMMODATE ADDITION OF (1) HYBRID CABLE, (1) GPS ANTENNA AND (1) GPS CABLE.

ICE BRIDGE GROUND BAR:
CAN ACCOMMODATE ADDITIONAL GROUND LEAD.

(1) EXISTING LTE CABINET AND (1) MICROWAVE CABINET TO BE REMOVED. (1) PROPOSED ERICSSON RBS 6120 TO BE INSTALLED.

EXISTING EQUIPMENT: EQUIPMENT RACK SCOPE: RAYCAP RUSDC-6267-PF-48 AND (1) 18"x18" JUNCTION BOX TO

PROPOSED EQUIPMENT:
(1) PROPOSED RAYCAP RUSDC-6267-PF-48

EQUIPMENT RACK GROUND BAR:

CAN ACCOMMODATE ADDITIONAL GROUND LEADS.

ANTENNA AZIMUTHS:

ANTENNAS TO BE ROTATED TO DESIGN AZIMUTHS. AZIMUTH CHANGES MUST BE PRE SCHEDULED WITH USCC FOR POTENTIAL E911 TESTING.

BEACON IS NESTED. CONTRACTOR TO INSTALL BEACON EXTENSION BY FLASH TECHNOLOGIES (P/N:11000016652). SEE SHEET C-6 FOR

LIGHTNING ROD MOUNT PIPE NESTS BEACON. CONTRACTOR TO REMOVE LIGHTNING ROD AND MOUNT PIPE, AND INSTALL 8' LIGHTNING ROD. SEE SHEET C-6 FOR DETAILS.

ANTENNA MOUNT:

EXISTING ANTENNA MOUNT HAS INSUFFICIENT CAPACITY TO SUPPORT PROPOSED LOADING AND REQUIRES MODIFICATION PRIOR TO LTE INSTALL. SEE TEP APPURTENANCE MOUNT MODIFICATION ANALYSIS FOR MODIFICATION DETAILS

DECOMMISSIONED EQUIPMENT REMOVAL:

POST-INTEGRATION

- EQUIPMENT REMOVAL:

 *(3) ERICSSON RRUS-11 B12 RRUs

 *(6) KAELUS COMBINERS
- *(1) ELTEK EQUIPMENT CABINET

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U.S. Cellular


PROJECT INFORMATION:

PLANS PREPARED FOR:

556470 ARLINGTON

11884 US HWY 421 NORTH BROADWAY, NC (HARNETT COUNTY)

PLANS PREPARED BY:

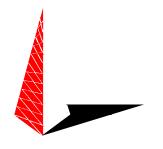

TOWER ENGINEERING PROFESSIONALS

326 TRYON ROAD RALEIGH, NC 27603-3530 OFFICE: (919) 661-6351 www.tepgroup.net

N.C. LICENSE # C-1794



REV	DATE	ISSUED FOR:
6	03-26-21	PRELIMINARY
7	04-14-21	CONSTRUCTION
8	08-03-21	CONSTRUCTION

DRAWN BY: JGC CHECKED BY:

SHEET TITLE:

TITLE SHEET

SHEET NUMBER:

REVISION:

BIRD'S EYE AERIAL OVERVIEW



SITE OVERVIEW




COMPOUND SIGNAGE

NOTES:

1. SURVEY DATED APRIL 8, 2002 BY THE EAST GROUP, P.A.

2. SURVEY SHOWN ON THIS PAGE WAS PROVIDED BY USCC AND IS NOT CARRIED UNDER SIGNATURE AND SEAL OF TOWER ENGINEERING PROFESSIONALS' SURVEYING SERVICES AND/OR ITS LAND SURVEYING PROFESSIONALS.

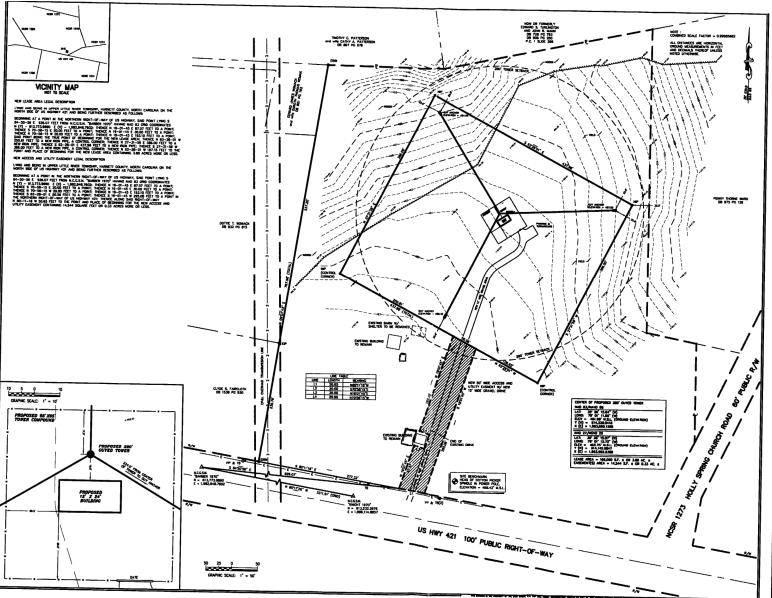

PLANS PREPARED FOR:



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PLANS PREPARED BY:

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DISTANCES.

12) ZONNO FOR THIS PROPERTY IS RA-30.

13) AN 8° FALL FONCE IS TO SURROUND THE TONE
COMPOUND AND THE CUTY ANCHORS. THE PERMETE
OF THE FERSILED COMPOUND TO BE LANGEAPED IN
ACCORDANCE WITH SECTION B.B OF THE COMMUNICATION
ACCORDANCE WITH SECTION B.B OF THE COMMUNICATION
ACCORDANCE WITH SECTION B.B OF THE COMMUNICATION
ACCORDANCE ORGANICATE OF MANIETT COUNTY.

GROUP, P.A.

PROPOSED US CELLULAR
TELE-COMMUNICATIONS SITE

THORNE SITE


WERE THE RIVER THESE, HARRETT CO. IN

AS-BUILT TOPO SURVEY

AND SITE PLAN

(ARLINGTON SEARCH RING)


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REV	DATE	ISSUED FOR:
5	01-18-21	PRELIMINARY
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7	04-14-21	CONSTRUCTION

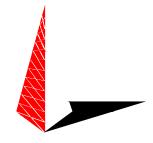DRAWN BY: JGC CHECKED BY: JHB

SHEET TITLE:

SITE SURVEY

SHEET NUMBER:

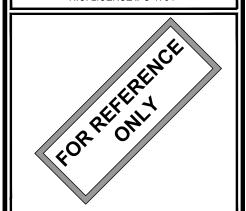REVISION:

C-1

TEP#: 43045,453871

SITE SURVEY
SCALE: N.T.S




COMPOUND VIEW "A"



COMPOUND VIEW "B"



COMPOUND VIEW "C"

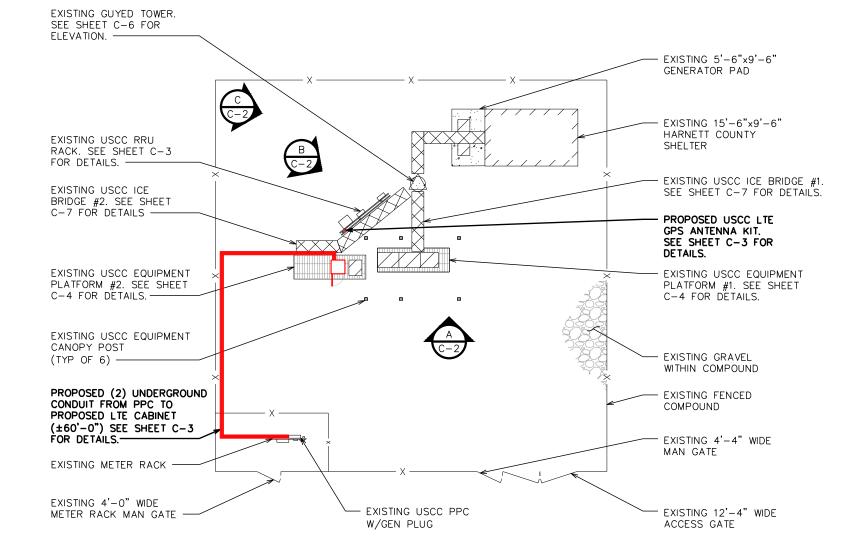

PLANS PREPARED FOR:

U.S. Cellular


PROJECT INFORMATION:

556470 **ARLINGTON**

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11884 US HWY 421 NORTH BROADWAY, NC (HARNETT COUNTY)

PLANS PREPARED BY:

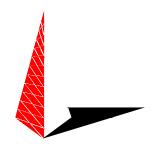

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7	04-14-21	CONSTRUCTION

DRAWN BY: JGC CHECKED BY:

SHEET TITLE:

COMPOUND **DETAILS**

SHEET NUMBER:


SCALE IN FEET

REVISION:

TEP#: 43045.45387

COMPOUND DETAIL

SCALE: $\frac{1}{6}$ " = 1'-0"

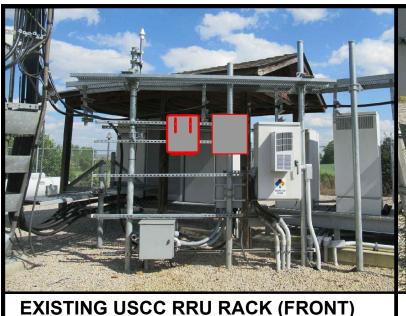


EXISTING USCC RRU RACK (BACK)

1. LOCATION OF ANTENNA
MUST HAVE CLEAR VIEW
OF SOUTHERN SKY AND
CANNOT HAVE ANY
BLOCKAGES EXCEEDING
25% OF THE SURFACE
AREA OF A HEMISPHERE
A R O U N D THE G P S
ANTENNA.

NOTES:

2. ALL GPS ANTENNA
LOCATIONS MUST BE
ABLE TO RECEIVE CLEAR
SIGNALS FROM A
MINIMUM OF FOUR (4)
SATELLITES. VERIFY WITH
HANDHELD GPS BEFORE
FINAL LOCATION OF GPS
ANTENNA.

GPS ANTENNA KIT DETAIL

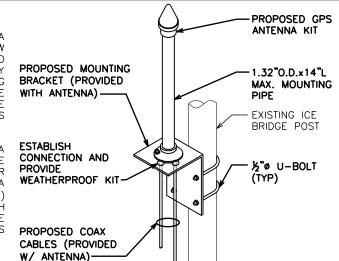

PLANS PREPARED FOR:

U.S. Cellular

8410 W BRYN MAWR SHITE 700

8410 W BRYN MAWR SUITE 700 CHICAGO, IL 60631 (773) 399-8900

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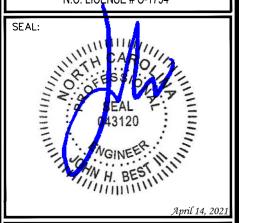
PLANS PREPARED BY:



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7 04-14-21 CONSTRUCTION
6 03-26-21 PRELIMINARY
5 01-18-21 PRELIMINARY
REV DATE ISSUED FOR:

DRAWN BY: JGC CHECKED BY: JHB

SHEET TITLE:

RRU RACK DETAILS

SHEET NUMBER:

REVISION:


TEP#: 43045.45387


NOTES:

- . CONTRACTOR TO ADJUST EXISTING UNISTRUTS AS NEEDED.
- 2. THE HYBRID JUMPERS SHOULD BE PROTECTED WITH INNERDUCT IF THEY ENTER THE CABINET HIGH. IF THEY ENTER THE CABINET LOW, THEN USE A LIQUID TIGHT FLEXIBLE METAL CONDUIT.

SCALE: N.T.S.

3. CONTRACTOR TO ADJUST EXISTING RRU LOCATIONS IN ORDER TO PROVIDE SPACE FOR PROPOSED RAYCAP AS NEEDED.

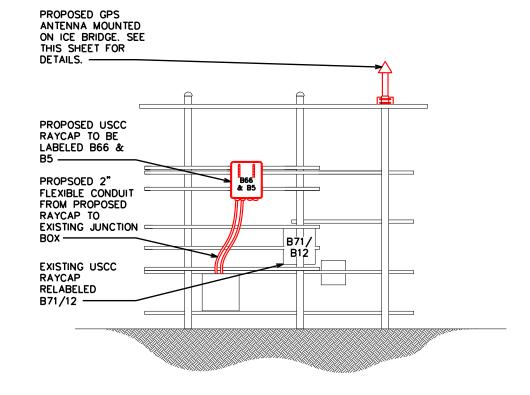


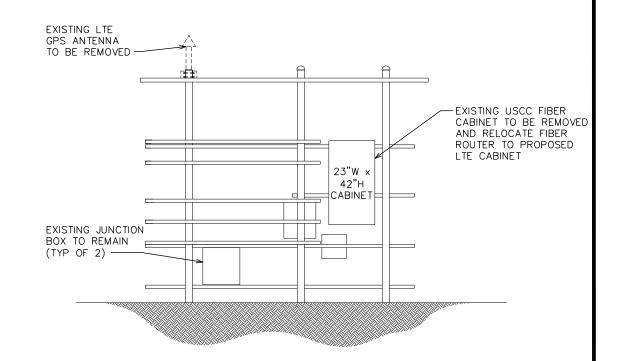

EXISTING RRU RACK ELEVATION

SCALE: N.T.S.

PROPOSED RRU RACK ELEVATION

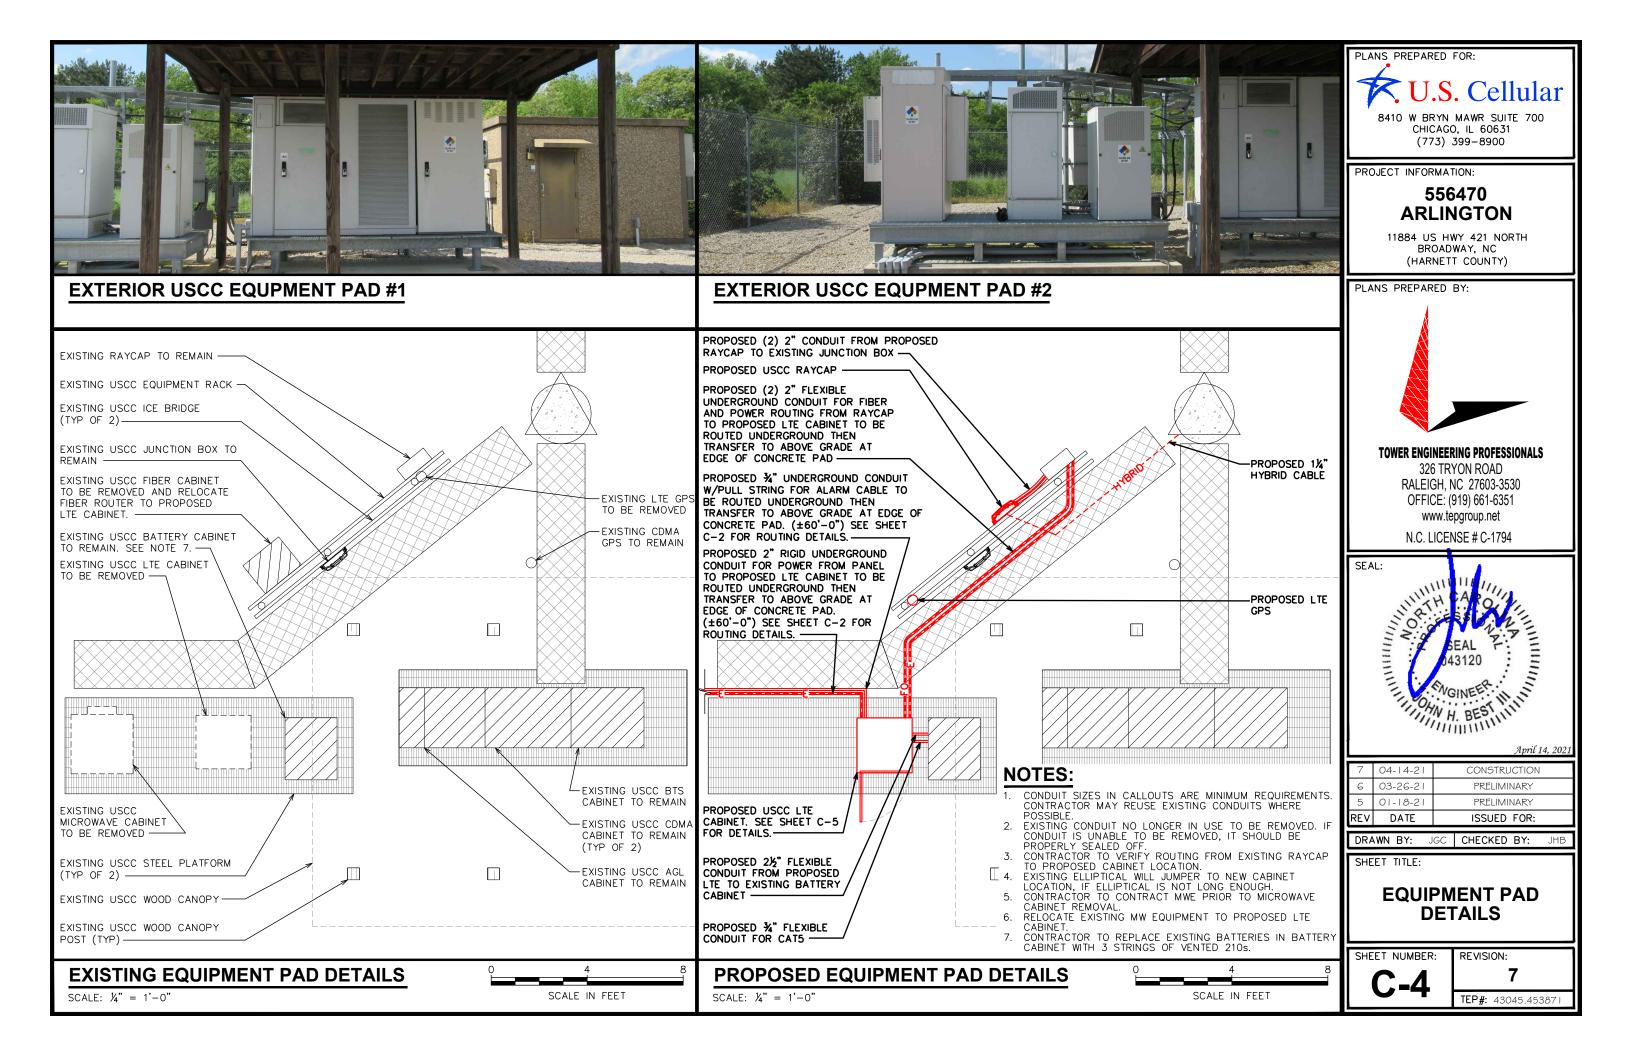

DESCRIPTION: RADIO BASE STATION MANUFACTURER: ERICSSON

MODEL: RBS 6120

DIMENSIONS: 60"x27.56"x27.56" (HxWxD)

WEIGHT: 837.8 LBS

CLEARANCE REQUIREMENTS FRONT: 47.24" (1200mm) REAR: 7.87" (200mm) LEFT: 3.94" (100mm) RIGHT: 3.94" (100mm)


DESCRIPTION: GLOBAL BASE FRAME (GBF)


MANUFACTURER: ERICSSON


MODEL: 5/BYB 701 01

DIMENSIONS: 10.38"x27.09"x27.56" (HxWxD)

WEIGHT: 80.5 LBS

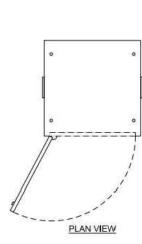

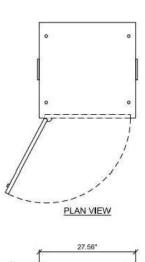

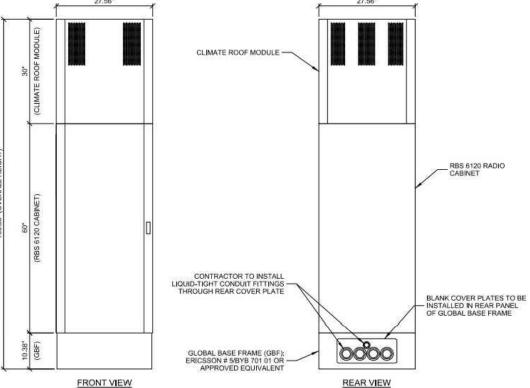






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11884 US HWY 421 NORTH BROADWAY, NC (HARNETT COUNTY)


PLANS PREPARED BY:



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7	04-14-21	CONSTRUCTION
6	03-26-21	PRELIMINARY
5	01-18-21	PRELIMINARY
REV	DATE	ISSUED FOR:

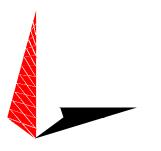DRAWN BY: JGC CHECKED BY:

SHEET TITLE:

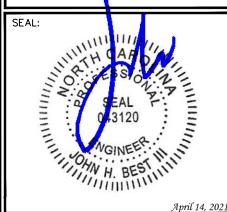CABINET SPEC SHEET

SHEET NUMBER:

REVISION:

TEP#: 43045.45387

LTE CABINET DETAILS

EUPEN HYBRID CABLE LENGTH PROPOSED RAYCAP QUANTITY ON RACK: 1 EXISTING RAYCAP QUANTITY ON RACK: 1 ICE BRIDGE LENGTH: 21-FT RAYCAP CENTERLINE + 12-FT BUFFER: 279-FT

TOTAL EST. LENGTH OF HYBRID CABLE (ROUNDED UP): 350-FT

300-FT

278

0

APPURTENANCES

PROPOSED USCC

શ્ર

EXISTING

님

0

GUYED TOWER

JUMPER INFO

TOTAL ESTIMATED LENGTH OF HYBRID CABLE:

JUMPE	ER QUANTITIES						
FIBER JUMPERS:	11						
COAX JUMPERS:	22						
RET JUMPERS: 6							
½" JUMPER LENGTH FRO	M B12/B71 RRUS TO ANTENNAS						
ALPHA SECTOR:	25-FT						
BETA SECTOR:	25-FT						
GAMMA SECTOR:	25-FT						
½" JUMPER LENGTH FF	ROM B66 RRUS TO ANTENNAS						
½" JUMPER LENGTH FR	ROM B66 RRUS TO ANTENNAS 25-FT						
	I						
ALPHA SECTOR:	25-FT						
ALPHA SECTOR: BETA SECTOR: GAMMA SECTOR:	25-FT 25-FT						
ALPHA SECTOR: BETA SECTOR: GAMMA SECTOR:	25-FT 25-FT 25-FT						
ALPHA SECTOR: BETA SECTOR: GAMMA SECTOR: ½" JUMPER LENGTH F	25-FT 25-FT 25-FT ROM B5 RRUs TO ANTENNAS						

	RRU TO ANTENNA
ALPHA SECTOR:	10-M
BETA SECTOR:	10-M
GAMMA SECTOR:	10-M

EXISTING LTE PANEL TO REMAIN: EXISTING CDMA PANEL TO REMAIN:

PROPOSED 8' LIGHTNING ROD. SEE NOTE 6 THIS SHEET. EXISTING BEACON. SEE NOTE 5 THIS SHEET. PROPOSED BEACON EXTENSION.

SEE C-12 FOR DETAILS.

€ OF USCC ANTENNAS @ 278'-0": (3) EXISTING LTE ANTENNAS AND (3) EXISTING CDMA ANTENNAS TO REMAIN. (3) PROPOSED LTE ANTENNAS TO BE INSTALLED.

SEE SHEET C-10 FOR MORE DETAILS.

OF USCC EQUIPMENT @ 267'-0": (3) EXISTING RRUS-11 B5 RRUS AND (1) RAYCAP TO REMAIN. (2) 4449 B12/B71 RRUs, (2) 4415 B66 RRUS, AND (1) RAYCAP TO BE INSTALLED ON EXISTING RRU MOUNTS. (3) RRUS-11 B12 RRUs AND (6) KAELUS COMBINERS TO BE REMOVED POST-INTEGRATION. SEE SHEET C-11 FOR MORE DETAILS.

EXISTING ANTENNAS BY OTHERS TO REMAIN (TYP)

EXISTING USCC MICROWAVE TO REMAIN

EXISTING GUYED TOWER

RET JUMPER INFO

	RRU TO ANTENNA
ALPHA SECTOR:	10-M
BETA SECTOR:	10-M
GAMMA SECTOR:	10-M

PROPOSED LTE PANEL TO BE INSTALLED:


0'-0" (REF.)

NOTES:

- 1. PROPOSED EQUIPMENT TO BE INSTALLED PRIOR TO LTE DECOMMISSION.
- 2. USCC CENTERLINE OVER 200-FT REQUIRES THE USE OF A MIDDLE GROUND BAR.
- 3. EXISTING T/APPURTENANCE = 296'-6"
- 4. PROPOSED T/APPURTENANCE = 288'-0"
- 5. BEACON IS NESTED BY EXISTING AND PROPOSED ANTENNAS. CONTRACTOR TO INSTALL ADJUSTABLE BEACON EXTENSION BRACKET FOR MITIGATION. CONTRACTOR TO ENSURE T/ANTENNAS AND T/MOUNT DOES NOT EXTEND ABOVE BEACON.
- 6. LIGHTNING ROD MOUNT PIPE ALSO NESTS BEACON. CONTRACTOR TO REMOVE LIGHTNING ROD AND MOUNT PIPE, AND INSTALL PROPOSED 8' LIGHTNING ROD. CONTRACTOR TO ENSURE 2' CLEARANCE ABOVE NEXT HIGHEST APPURTENANCE.

PROPOSED TOWER ELEVATION

SCALE: 1" = 50'

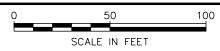

B/BASEPLATE

EXISTING TOWER ELEV.

EXISTING GAMMA SECTOR

EXISTING ALPHA SECTOR



EXISTING BETA SECTOR





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PROJECT INFORMATION:

556470 **ARLINGTON**

11884 US HWY 421 NORTH BROADWAY, NC (HARNETT COUNTY)


PLANS PREPARED BY:



TOWER ENGINEERING PROFESSIONALS

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N.C. LICENSE # C-1794

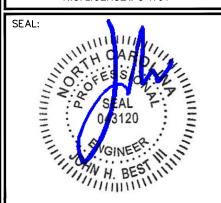

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5	01-18-21	PRELIMINARY
0)	03-26-21	PRELIMINARY
7	04-14-21	CONSTRUCTION

DRAWN BY: JGC CHECKED BY:

SHEET TITLE:

TOWER ELEVATION


SHEET NUMBER:

REVISION:



ANALOG COAX (IF APPLICABLE) TO BE REMOVED IS LABELED WITH GREEN TAPE.



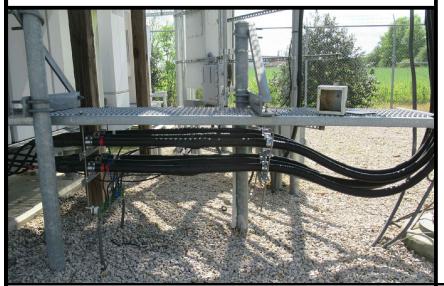

EXISTING ICE BRIDGE #1 ELEVATION


PROPOSED HYBRID

EXISTING EWG

EXISTING ICE BRIDGE #1 CONFIGURATION

EXISTING USCC FH 1%" COAX TO REMAIN

(TYP OF 6) -

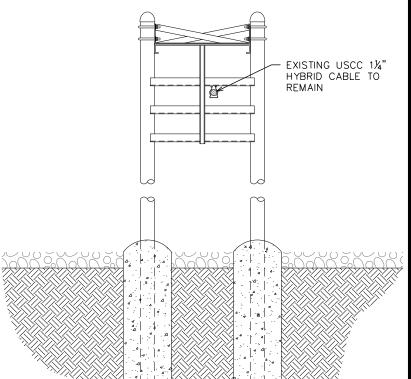


EXISTING ICE BRIDGE #2 CONFIGURATION

NOTE: NO PROPOSED CHANGES Ø Ø Ø 9 9 9 · [-]

PROP. ICE BRIDGE #1 CONFIGURATION

SCALE: N.T.S.

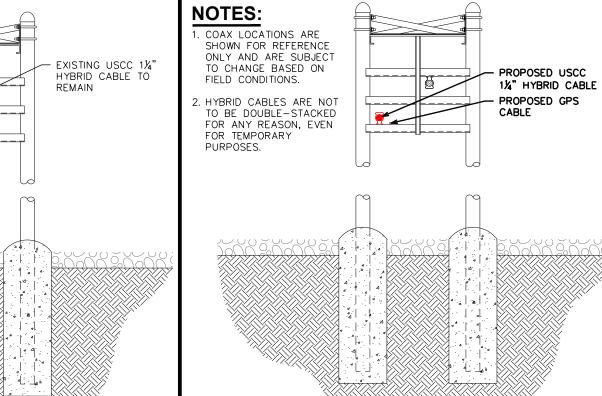

PROP. ICE BRIDGE #2 CONFIGURATION

SCALE: N.T.S.




PROJECT INFORMATION:

556470 **ARLINGTON**

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11884 US HWY 421 NORTH BROADWAY, NC (HARNETT COUNTY)




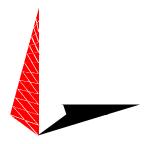

TOWER ENGINEERING PROFESSIONALS

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N.C. LICENSE # C-1794

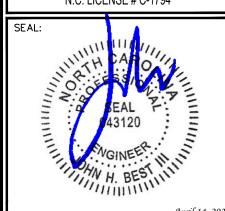

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-/	04-14-21	CONSTRUCTION

DRAWN BY: JGC CHECKED BY:

SHEET TITLE:

HATCH PLATE & ICE BRIDGE **DETAILS**


SHEET NUMBER:

REVISION:

TEP#: 43045.45387

EXISTING ICE BRIDGE #2 ELEVATION

SCALE: N.T.S.

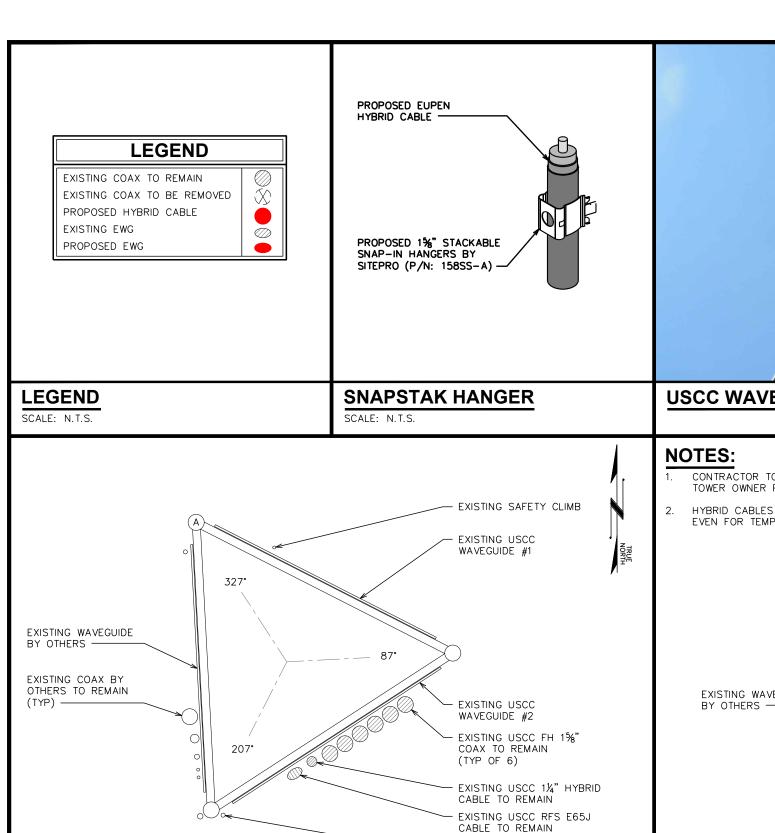


PLANS PREPARED FOR: PROJECT INFORMATION: PLANS PREPARED BY:

USCC WAVEGUIDE #2

CONTRACTOR TO VERIFY COAX LOCATION WITH STRUCTURAL ANALYSIS AND TOWER OWNER PRIOR TO INSTALLATION.

HYBRID CABLES ARE NOT TO BE DOUBLE-STACKED FOR ANY REASON, EVEN FOR TEMPORARY PURPOSES.

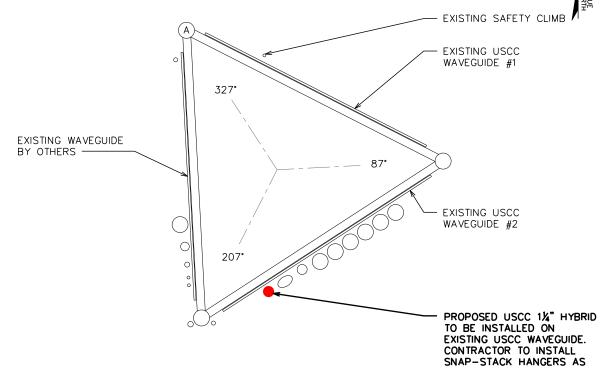

NEEDED. SEE THIS SHEET FOR DETAILS.

SHEET NUMBER:

REVISION:

COAX LAYOUT

U.S. Cellular

8410 W BRYN MAWR SUITE 700 CHICAGO, IL 60631

(773) 399-8900

556470

ARLINGTON

11884 US HWY 421 NORTH BROADWAY, NC

(HARNETT COUNTY)

TOWER ENGINEERING PROFESSIONALS

326 TRYON ROAD

RALEIGH, NC 27603-3530 OFFICE: (919) 661-6351

www.tepgroup.net

N.C. LICENSE # C-1794

SEAL 043120 SEAL O43120 SEAL O

SEAL:

04-14-21

03-26-2

01-18-2

DATE

DRAWN BY:

SHEET TITLE:

REV

TEP#: 43045.45387

CONSTRUCTION

PRELIMINARY

PRELIMINARY

ISSUED FOR:

CHECKED BY:

EXISTING COAX LAYOUT


SCALE: 1" = 1'


SCALE IN FEET

GROUND TO LIGHTNING ROD

PROPOSED COAX LAYOUT

SCALE IN FEET

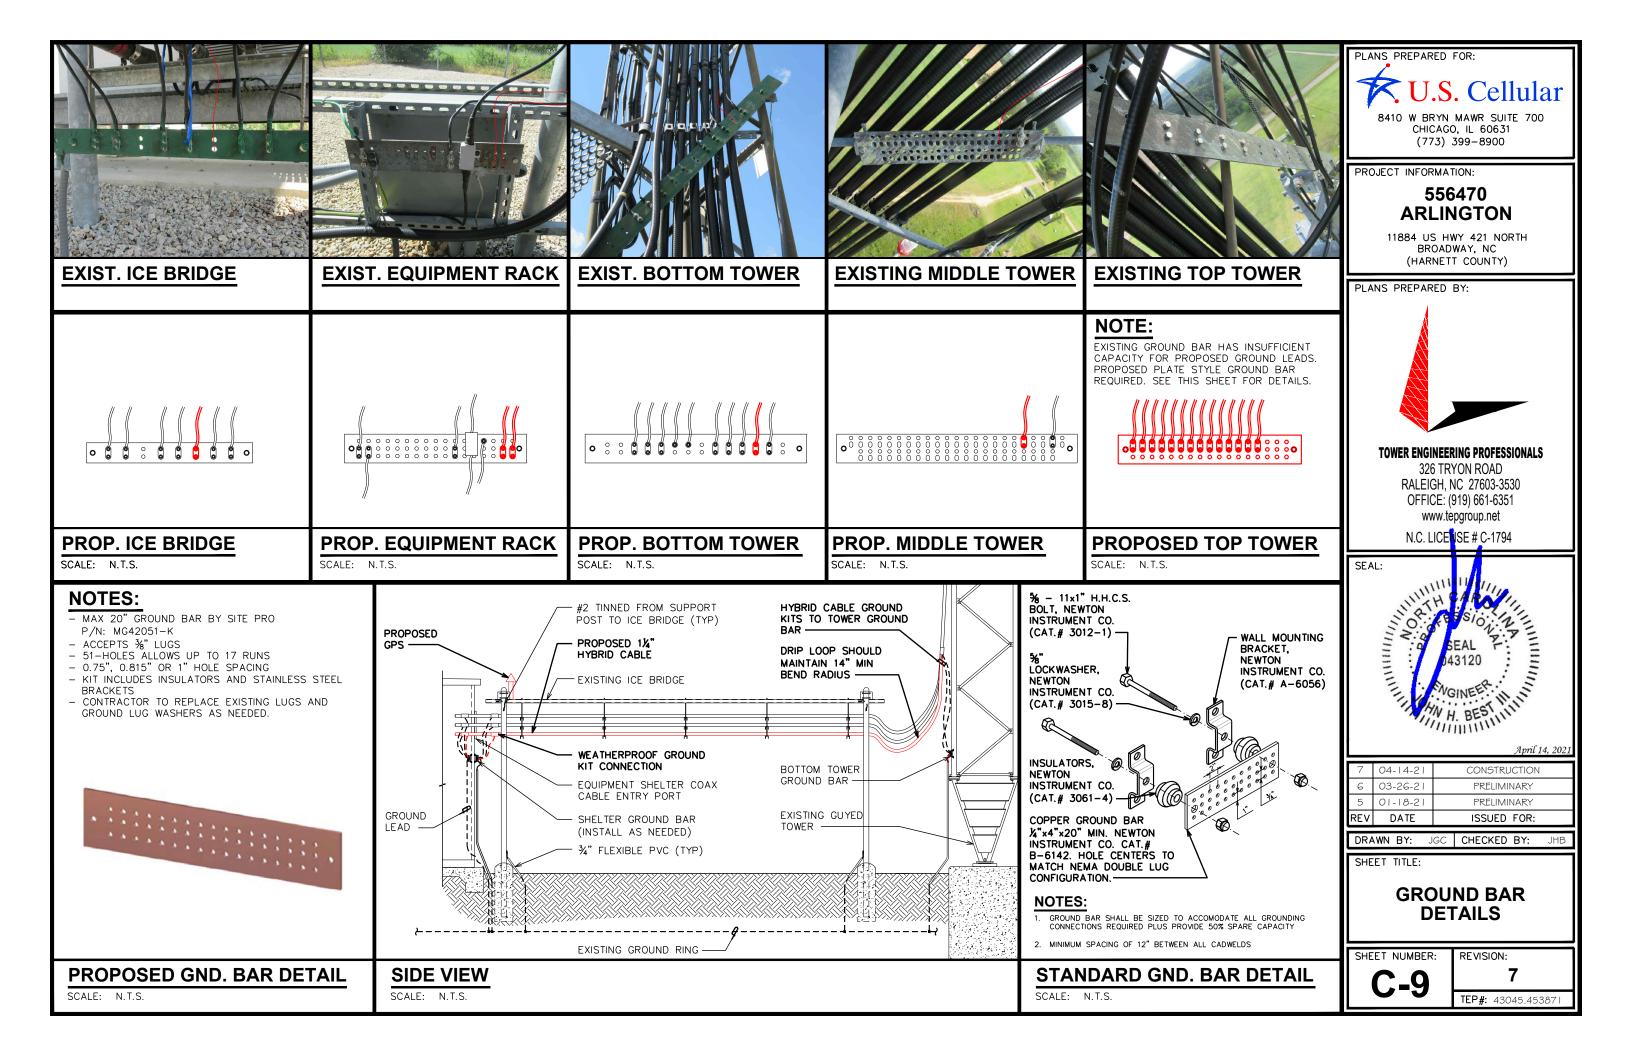

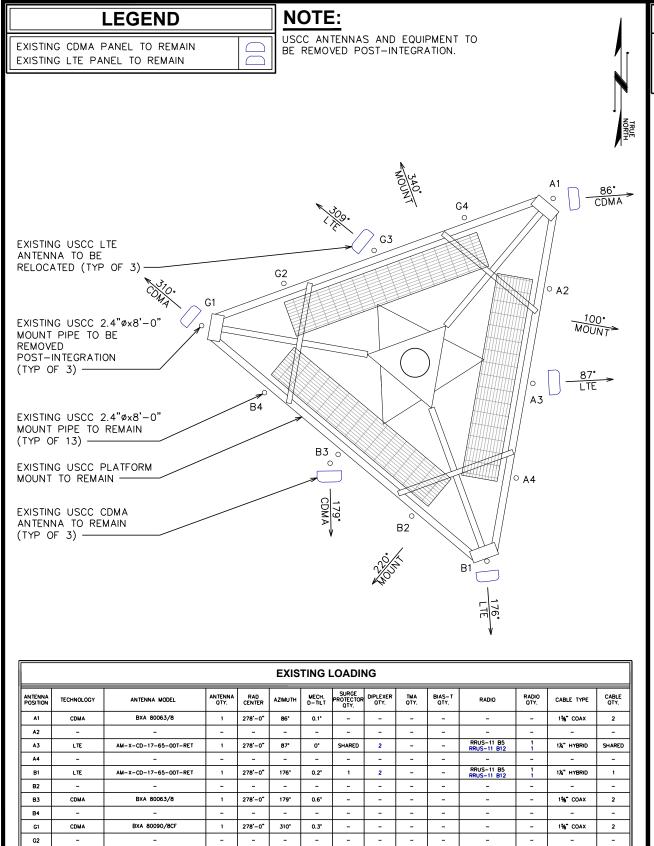

309*

0.6*

SHARED

2

3 6 0 0

EXISTING CDMA PANEL ANTENNA EXISTING LTE PANEL ANTENNA PROPOSED LTE PANEL ANTENNA

LEGEND


			_	
CABLE TYPE	CABLE QTY.			ANTENI POSITIO
1% COAX	2			A1
-	-			A2
I¼" HYBRID	SHARED			А3
-	-			A4
ル HYBRID	1			B1
-	-			B2
1%" COAX	2			В3
-	-			B4
1%" COAX	2			GI
-	-			G2
以" HYBRID	SHARED			G3
-	-			G4
		:	۱ ا	
	7			TOTAL
				RED TE

PROPOSED ANTENNA ASSIGNMENT

SCALE: $\frac{1}{2}$ " = 1'-0" SCALE IN FEET

NOTES:

- EXISTING MOUNT HAS INSUFFICIENT CAPACITY TO SUPPORT PROPOSED LOADING AND REQUIRES MODIFICATION. SEE TEP APPURTENANCE MOUNT MODIFICATION ANALYSIS DATED OCTOBER 15, 2020 FOR MODIFICATION DETAILS.
- MOUNT ANTENNAS & EQUIPMENT PER MANUFACTURERS SPECIFICATIONS.
- 3. CDMA & LTE ADJUSTMENTS REQUIRED.

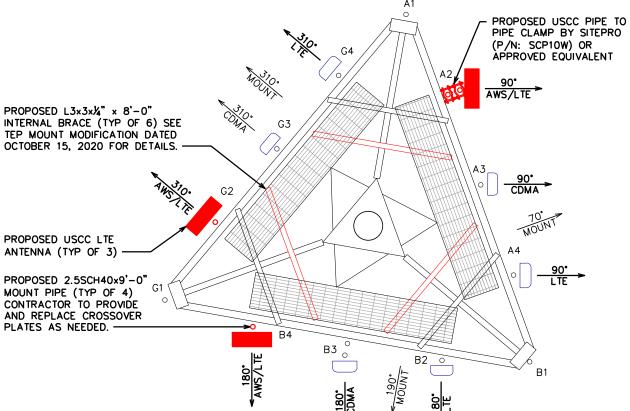

	PROPOSED LOADING																
ANTENNA POSITION	TECH	ANTENNA MODEL	ANTENNA QTY.	RAD CENTER	AZI M UTH	MECH. D-TILT	LB ELEC. D-TILT	MB ELEC. D-TILT	SURGE PROTECTOR QTY.	B71/B12 RADIO	RADIO QTY.	B66 RADIO	RADIO QTY.	B5 RADIO	RADIO QTY.	CABLE TYPE	CABLE QTY.
A1	-	-	-	-	-	-	-	-	-	-	-	-	-	-	-	-	-
A2	AWS/LTE	OCT8-2LX2HX-BW65	1	278'-0"	90*	0*	2*	2*	1	RRU 4449	1	RRU 4415	1	-	-	1¼" HYBRID	1
A3	CDMA	BXA 80090/8CF	1	278*-0*	90*	0*	-	-	-	-	-	-	-		-	1%" COAX	2
A4	LTE	AM-X-CD-17-65-00T-RET	1	278'-0"	90°	0.	2*	-	SHARED	-	-	-	-	RRUS-11	1	1¼" HYBRID	SHARED
B1	-	-	-	-	-	-	-	-	-	-	-	-	-	-	-	-	-
B2	LTE	AM-X-CD-17-65-00T-RET	1	278'-0"	180°	0*	2*	-	1	-	-	-	-	RRUS-11	1	1¼" HYBRID	SHARED
В3	CDMA	BXA 80063/8	1	278'-0"	180*	0°	-	-	-	-	-	-	-	-	-	1%" COAX	2
B4	AWS/LTE	OCT8-2LX2HX-BW65	1	278'-0"	180*	0*	2*	2*	SHARED	RRU 4449	SHARED	RRU 4415	SHARED	-	-	1¼" HYBRID	SHARED
G1	-	-	-	-	-	-	-	-	-	-	-	-	-	-	-	-	-
G2	AWS/LTE	OCT8-2LX2HX-BW65	1	278'-0"	310*	0.	2*	2*	SHARED	RRU 4449	1	RRU 4415	1	-	-	1¼" HYBRID	1
G3	CDMA	BXA 80063/8CF	1	278'-0"	310*	•	-	-	-	-	-	-	-	-	-	1%" COAX	2
G4	LTE	AM-X-CD-17-65-00T-RET	1	278'-0"	310°	0*	2*	-	SHARED	-	-	-	-	RRUS-11	1	1次" HYBRID	SHARED
TOTALS:	TOTALS: 9 2 2 2 3 8																

RED. TEXT DENOTES PROPOSED EQUIPMENT

RED. TEXT DENOTES PROPOSED EQUIP


PLANS PREPARED FOR:

8410 W BRYN MAWR SUITE 700 CHICAGO, IL 60631 (773) 399-8900

PROJECT INFORMATION:

556470 **ARLINGTON**

11884 US HWY 421 NORTH BROADWAY, NC (HARNETT COUNTY)

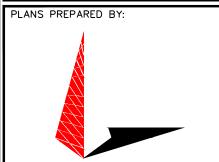

TOWER ENGINEERING PROFESSIONALS

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N.C. LICENSE # C-1794



April 14, 202.

REV	DATE	ISSUED FOR:
5	01-18-21	PRELIMINARY
0)	03-26-21	PRELIMINARY
7	04-14-21	CONSTRUCTION

DRAWN BY: JGC CHECKED BY:

SHEET TITLE:

ANTENNA MOUNTING DETAILS

SHEET NUMBER:

REVISION:

TEP#: 43045.45387

EXISTING ANTENNA ASSIGNMENT


G3

TOTALS:

LTE

BLUE TEXT DENOTES EQUIPMENT TO BE REMOVED




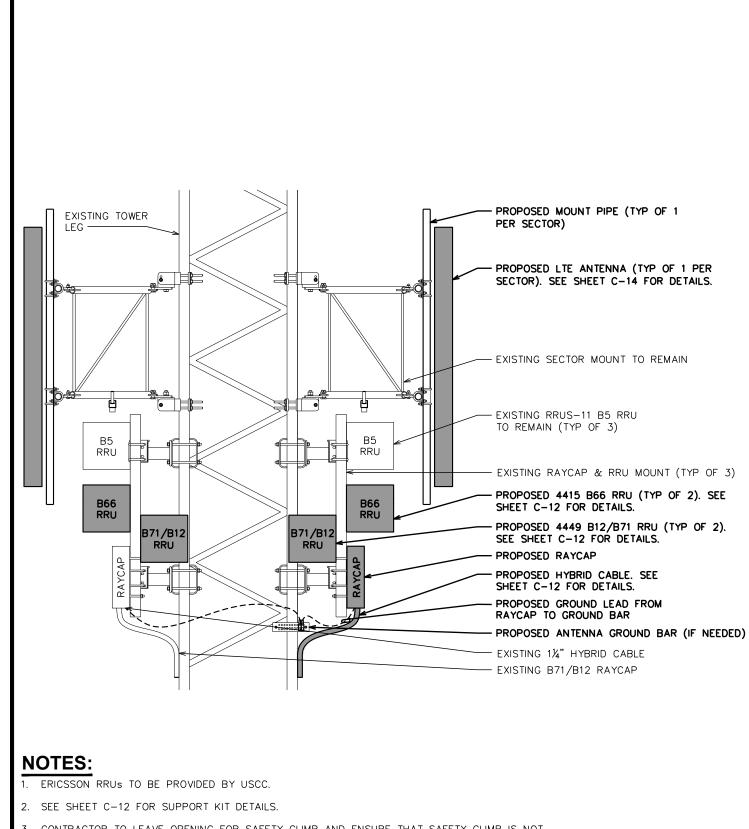

- 3. CONTRACTOR TO LEAVE OPENING FOR SAFETY CLIMB AND ENSURE THAT SAFETY CLIMB IS NOT OBSTRUCTED/COMPROMISED.
- 4. TOWER TOP FIBER/POWER CONNECTIONS FROM RAYCAP TO RADIOS SHOULD BE SHIELDED IN 1" INNERDUCT (75' PROVIDED IN HYBRID KIT).


RAYCAP & RRU MOUNTING DETAIL (ELEVATION)

SCALE: N.T.S

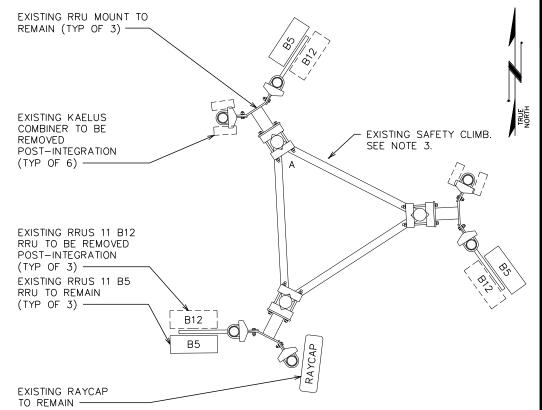

EXISTING RAYCAP & RRU MOUNTING DETAIL (PLAN)

SCALE: N.T.S.

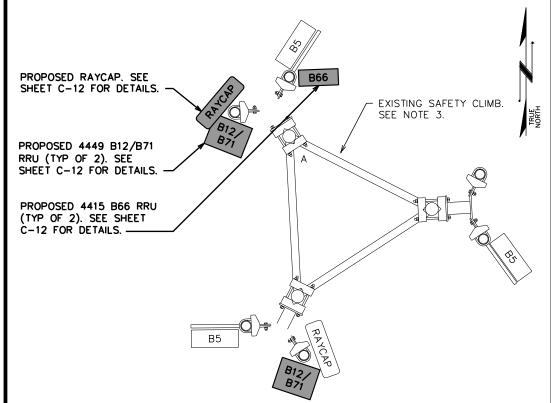

PROPOSED RAYCAP & RRU MOUNTING DETAIL (PLAN)

SCALE: N.T.S.




PROJECT INFORMATION:

556470 ARLINGTON

(773) 399-8900

11884 US HWY 421 NORTH BROADWAY, NC (HARNETT COUNTY)

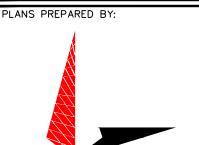

TOWER ENGINEERING PROFESSIONALS

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April 14, 20.

REV	DATE	ISSUED FOR:
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6	03-26-21	PRELIMINARY
-7	04-14-21	CONSTRUCTION


DRAWN BY: JGC CHECKED BY: JHB

SHEET TITLE:


RAYCAP & RRU SPEC SHEET


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REVISION:




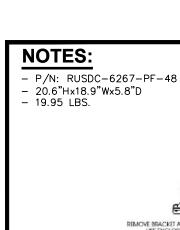



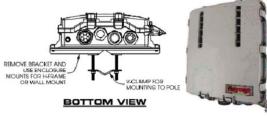

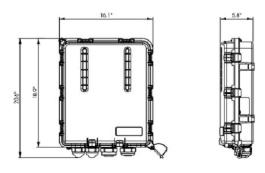SIDE VIEW FRONT VIEW

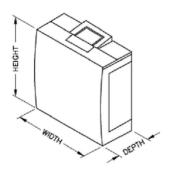

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H	3	1			
	1.				

RRU SPEC SHEET

1. DUAL ERS BRACKET ERICSSON P/N:

POLE, WALL, ANGLE TOWER, OR

ALL HARDWARE INCLUDED.

INSTALL PER MANUFACTURER

SXK 109 1973/2, WEIGHT: 3.75 LBS

CAN BE USED TO ATTACH TWO STANDARD OR HEAVY ERS UNITS TO

SCALE: N.T.S.

NOTES:

SQUARE TUBE.

RECOMMENDATIONS.

ERICSSON	4449
HEIGHT	14.96"
WIDTH	13.19"
DEPTH	5.39"
WEIGHT	44 LB

ERICSSON RRUS-11

ERICSSON 4415

19.7"

17.0"

7.2"

50.2 LB

14.96" 13.19"

5.39"

44 LB

HEIGHT

WIDTH

DEPTH

WEIGHT


HEIGHT

DEPTH

WEIGHT

NOTES:

- 1¼" FIBER OPTIC CABLE WITH 48V ENERGY FEEDER IN CORRUGATED ALUMINUM SHIELDING WITH UV RESISTANT PE JACKET.
- MINIMUM BENDING RADIUS: 360mm (14")
- MAXIMUM PULLING STRENGTH: 150daN MAXIMUM HANGER SPACING: 1,0m
- APPROX WEIGHT: 2300kg/km (1.55LB/FT)
- SHIPPED W/4' PROTECTED JACKET (2.25" O.D.) AT
- NON-ARMORED ENDS ARE 3" IN LENGTH (2' O.D.)

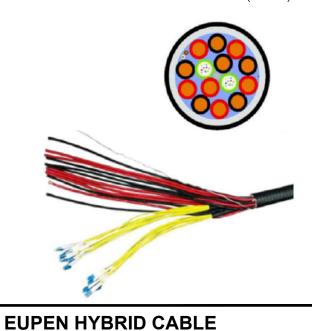

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PLANS PREPARED FOR:

PROJECT INFORMATION:

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TOWER ENGINEERING PROFESSIONALS

326 TRYON ROAD RALEIGH, NC 27603-3530 OFFICE: (919) 661-6351 www.tepgroup.net

N.C. LICENSE # C-1794

PLANS PREPARED BY:

SEAL: W H. BEST

REV	DATE	ISSUED FOR:		
5	01-18-21	PRELIMINARY		
6	03-26-21	PRELIMINARY		
7	04-14-21	CONSTRUCTION		

DRAWN BY: JGC CHECKED BY:

SHEET TITLE:

RADIO SPEC SHEET AND MOUNTING DETAILS

SHEET NUMBER:

REVISION:

TEP#: 43045.45387

SCALE: N.T.S. NOTES:

 BEACON EXTENSION BRACKET (P/N:11000016652) BY FLASH TECHNOLOGY WEIGHT: 45 LBS (20.4 KG)

36-66" EXTENDABLE LENGTH

INSTALL PER MANUFACTURER RECOMMENDATIONS.



DUAL ERS KIT

DOUBLE UNIT

SINGLE UNIT

RRU SUPPORT KIT

RAYCAP SPEC SHEET

SCALE: N.T.S.

NOTES:

1. SINGLE SUPPORT KIT:

- WEIGHT: 11 LBS

FOR DUAL MOUNT:

- WEIGHT: 4.4 LBS

RECOMMENDATIONS

- ERICSSON P/N SXK1072839/1

ADDITION TO SINGLE SUPPORT KIT

- ERICSSON P/N SXK1072839/2


3. ALL HARDWARE INCLUDED 4. INSTALL PER MANUFACTURER

2. EXPANSION KIT ORDERED IN

SCALE: N.T.S.

SCALE: N.T.S.

BEACON EXTENSION BRACKET

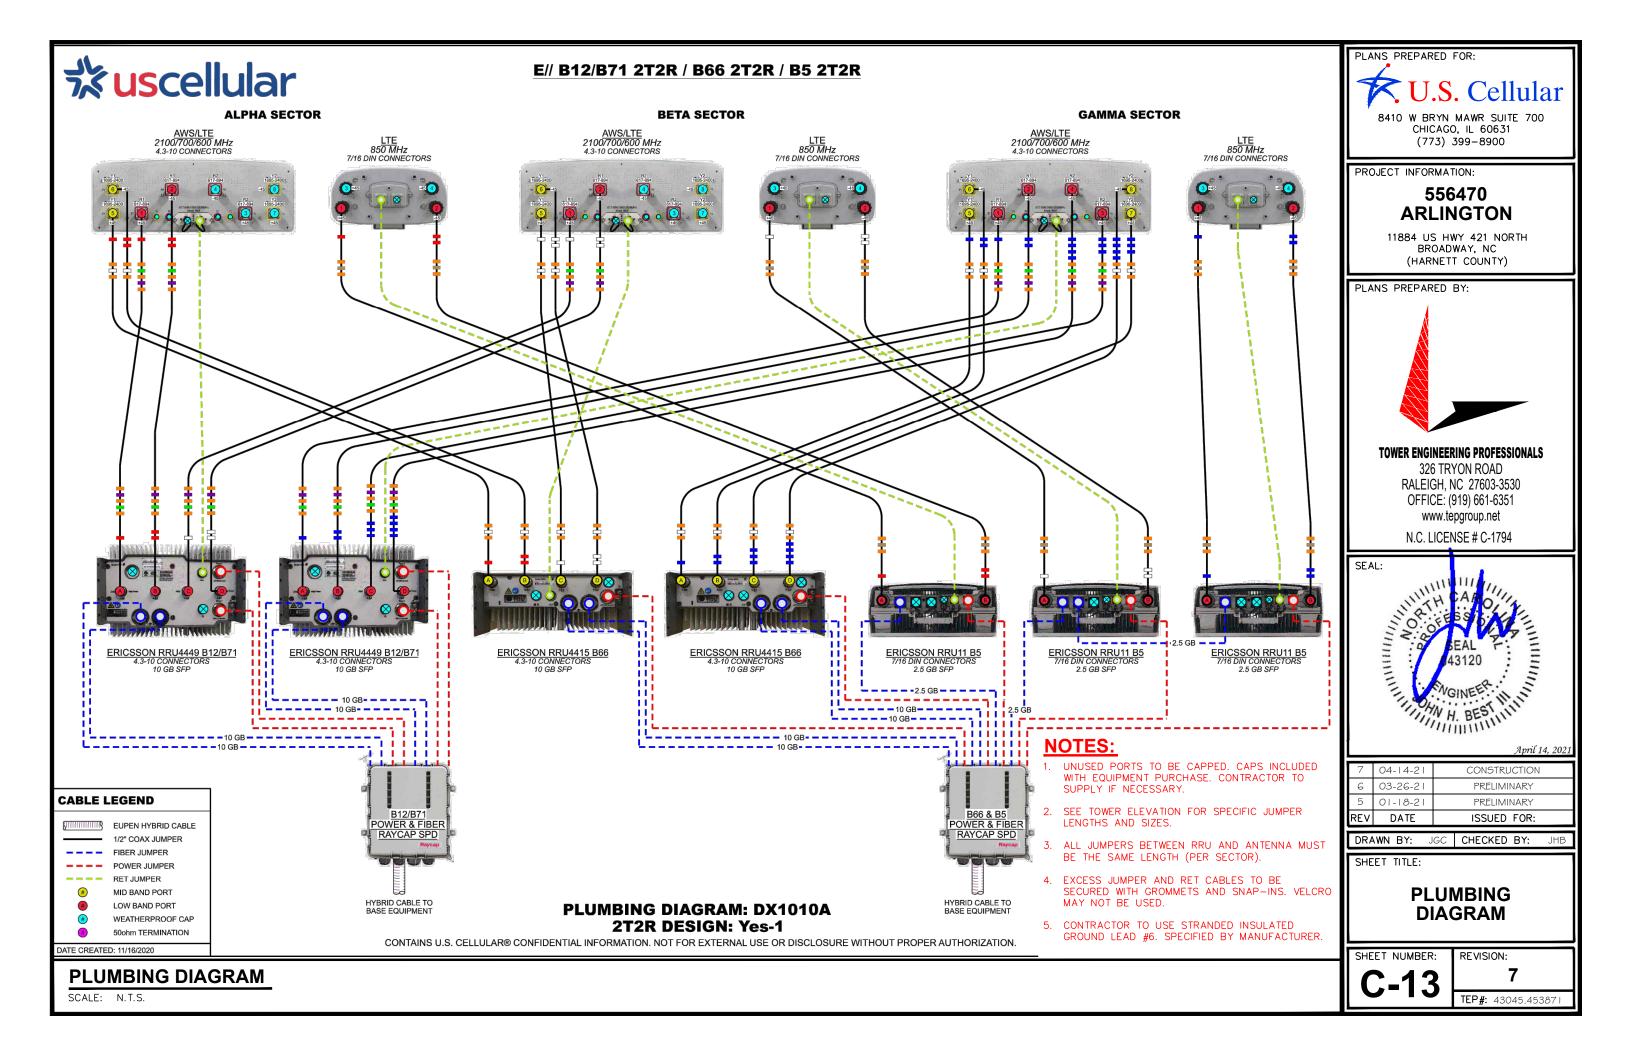



Base Station Antennas

Fraguency Dongs	617-894x2
Frequency Range	1695-2400x2
Polarization	±45°
Half-Power Beam Width	65°
Electrical Downtilt	2° - 12°x4

DEN GYO

Type OCT8-2LX2HX-BW65

AISG

Antenna

AISG

Integrated RET Properties

Protocols

Connectors

Hardware

Torque Max

interface

Input voltage range

Power consumption

Adjustment time(full range)

Lightning Protection Rating

Adjustment Cycles

Base Station Antennas

Compliant to AISG 2.0/3GPP

+10~+30VDC(pin 6)

<2W(stand by);<13W(motor activated)

2 x 8 pin connector acc. To IEC 60130-9

Acc.to AISG Daisy chain in:male

Daisy chain out:female

Two motor shaft(Embedded motor)

RS485A/B(pin5/pin3);Power supply(pin6);
DC return(pin7)Acc.to AISG

40 sec(typically,depending on antenna)

≥10000 ≥160mN.m

IEC 61000-4-5 Current Pulse Profile,8/20 µs 10 Repetitions Min.@ 6kA

IEC 61312-1 Annex B Current Pulse Profile, 10/350 μs,200 Repetitions Min. @ 0.6KA

Frequency Range	617-894x2 1695-2400x2		
Polarization	±45°		
Half-Power Beam Width	65°		
Electrical Downtilt	2° - 12°x4		

Type OCT8-2LX2HX-BW65

Base Station Antenna

8-ports 617-894 / 617-894 /1695-2400 /1695-2400 MHz 65°, 16 / 16 / 18 / 18 dBi, 2°-12° / 2°-12° / 2°-12° / 2 - 12 °Tilt Antenna With 4 Integrated RCUs.


Electrical Specifications

Electrical Spec	cifications						
Frequency Range(MHz)			2x617-894		2x1695-2400		
Frequency Range(IVITIZ)		617-698	698-824	824-894	1695-1920	1920-2180	2300-2400
Polarization					±45°		
Horizontal 3dB Beamwidth(°)		70	63	60	66	63	58
Vertical 3dB Bean	nwidth(°)	10.4	9.1	8.0	5.5	5	4.3
Gain (dBi)		15.0	15.5	16.0	17.6	18.0	18.1
Electrical Downtilt			2°-12°	•		2°-12°	•
Upper Sidelobe Suppression(dB)	First	≥16	≥16	≥16	≥16	≥16	≥16
Front-to-Back Ratio Total Power, ±30° (dB)		≥23	≥24	≥25	≥25	≥25	≥25
Cross polar	Main direction(dB)	≥17	≥17	≥17	≥17	≥17	≥17
ratio	±60° (dB)	≥7	≥7	≥7	≥7	≥7	≥7
Isolation ports		≥25 dB					
Isolation Frequence	су	≥30 dB					
VSWR		< 1.5					
Intermodulation IN	//3	< -150 dBc(2x43dBm carrier)					
Impedance		50 Ω					
Max. Power per Input (at 50°C ambient temperature)			500 W 300 W				
Lightning Protection	on		DC Ground				





COMPREHENSIVE TILT CONFIGURATION

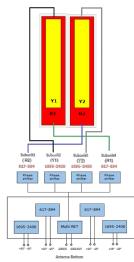

			٥		
● 895-3400MHz -45"		● 615-45 618 Pz. -45°	● 615-854MHz -45*		• 1685.5400MHz -45"
¥1 ■ 1895-3400MHz +457	● 817-894MHz +45°	RI		© 617-554MHz. +45°	● 1885-2400MHz. +45"
m joj	O RI	Y1 R1 Mult	995-2400MHz	Y2 R2	Y2

Mechanical Specifications

Redome Material	Fiberglass		
Connector Type and Location	4.3-10x8 ,Bottom iRCU in:1 x 8 pin male iRCU out:1 x 8 pin female		
Dimensions, HxWxD(mm)/(inches)	2438 x 499 x 180 / 95.9 x 19.6 x 7.1		
Packing Size(mm)/(inches)	2750 x 620 x 325 / 108.3 x 24.4 x 12.8		
Weight ,w/o Mounting kit(kg)/(lbs)	47 / 103.4		
Weight, with Mounting kit(kg)/(lbs)	53 / 116.6		
Packing Weight(kg)/(lbs)	63 / 138.6		
Max. Wind Velocity(mph)	150		
Mounting hardware	¢ 50 mm ~ ¢ 115 mm		
Operational Temperature(°C)	-40 to +65		
Operational Humidity(%)	<95		
Wind Load at 100mph (Frontal/lateral/Rearside(N))	1416/280/1027		

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OCT8-2LX2HX-BW65 Rev.3

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OCT8-2LX2HX-BW65 Rev.3

PLANS PREPARED FOR:

U.S. Cellular


8410 W BRYN MAWR SUITE 700 CHICAGO, IL 60631 (773) 399-8900

PROJECT INFORMATION:

556470 ARLINGTON

11884 US HWY 421 NORTH BROADWAY, NC (HARNETT COUNTY)


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April 14, 202

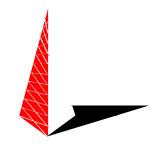REV	DATE	ISSUED FOR:		
5	01-18-21	PRELIMINARY		
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7	04-14-21	CONSTRUCTION		

DRAWN BY: JGC CHECKED BY: JHB

SHEET TITLE:


ANTENNA SPEC SHEET

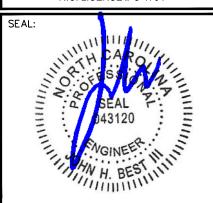SHEET NUMBER:

REVISION:

TEP#: 43045.453871

DENGYO OCT8-2LX2HX-BW65

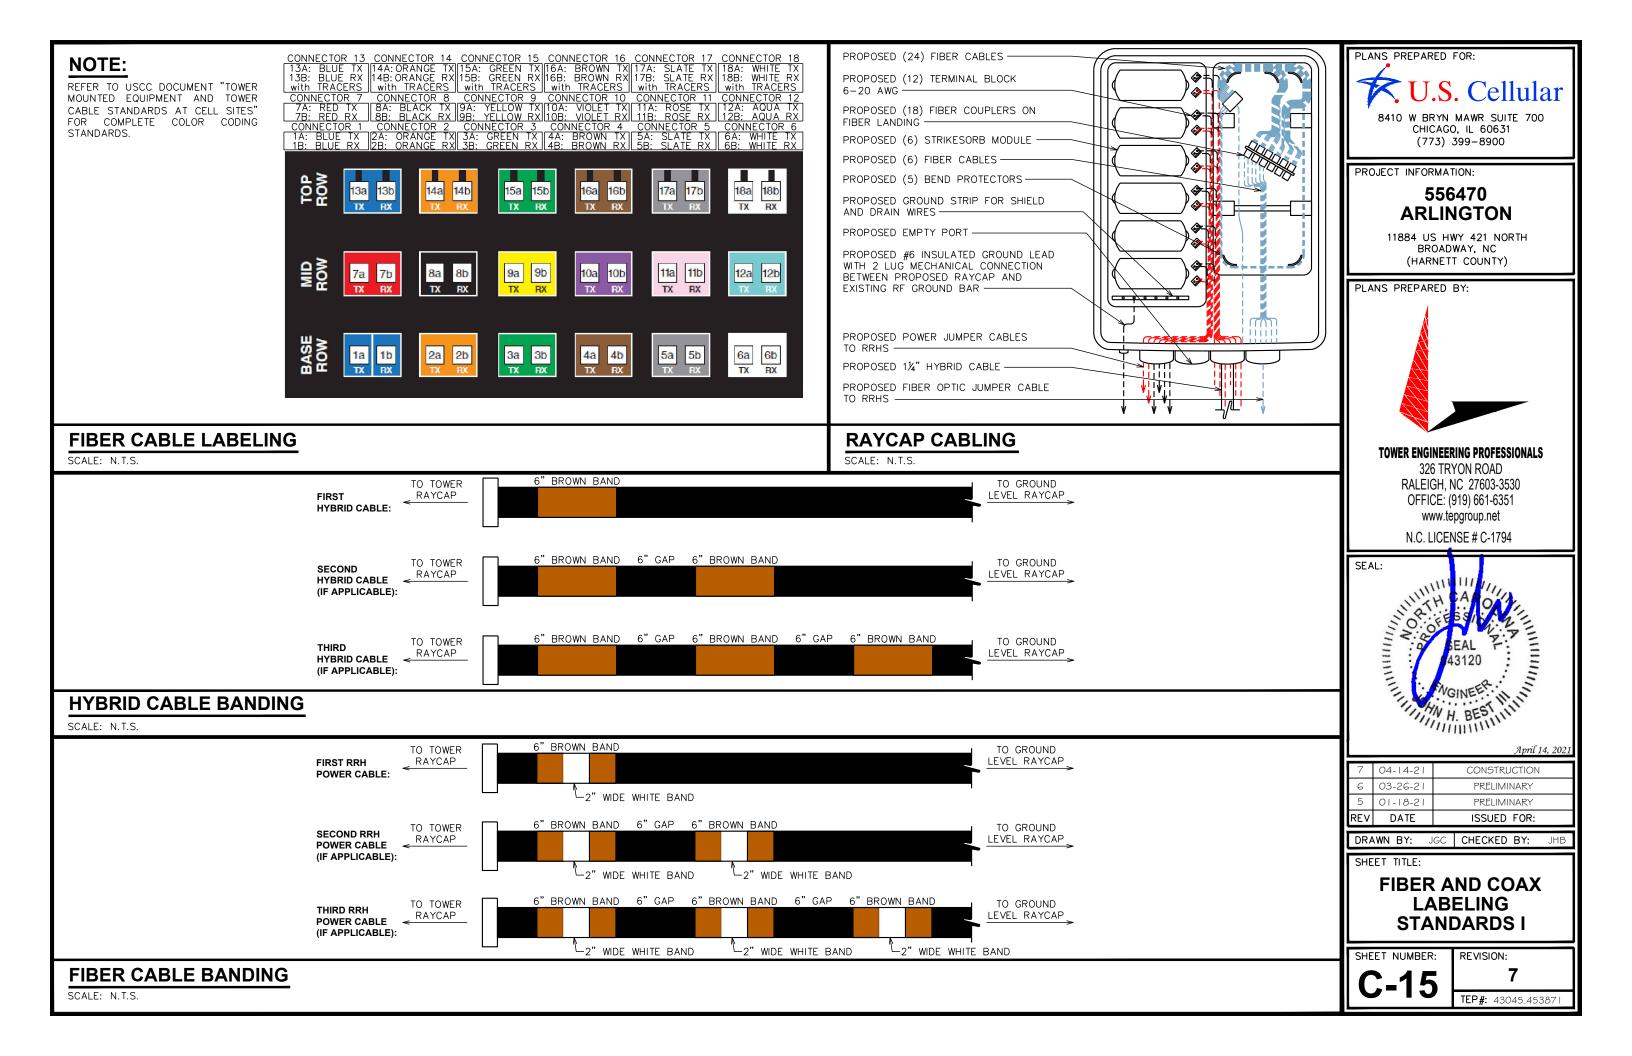

Sector Band Assignments (Most Common Case: Single Technology within the Sector)						
Sector Band	Assigned Color	Line 1	Line 2	Line 3	Line 4	
Alpha (Sector 1)	red	1 red band	2 red bands	3 red bands	4 red bands	
Beta (Sector 2)	white	1 white band	2 white bands	3 white bands	4 white bands	
Gamma (Sector 3)	blue	1 blue band	2 blue bands	3 blue bands	4 blue bands	
Delta (Sector 4, if applicable)	green	1 green band	2 green bands	3 green bands	4 green bands	
Epsilon (Sector 5, if applicable)	violet	1 violet band	2 violet bands	3 violet bands	4 violet bands	
Zeta (Sector 6, if applicable)	brown	1 brown band	2 brown bands	3 brown bands	4 brown bands	

LTE

B48 (CBRS)

USC COAX Color Code Standard

LTE

B71

FREQUENCY BAND

FREQUENCY BAND
GREEN
BROWN
BLUE
WHITE
GREY
VIOLET
RED


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DRAWN BY: JGC CHECKED BY: JHB

SHEET TITLE

FIBER AND COAX LABELING STANDARDS II


SHEET NUMBER:

VISION:

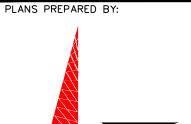TEP#: 43045.453871

LTE LTE LTE B4 & B66

ctor 2 Sector 3	Sector 1 Sector 2 Sector 3			RET SECTOR E	BAND
			SECTOR	LINE 1 - FIRST TECHNOLOGY	LINE 2 - FIRST TECHNOLOGY
			ALPHA	(1) RED BAND	(2) RED BAND
			ВЕТА	(1) WHITE BAND	(2) WHITE BAND
			GAMMA	(1) BLUE BAND	(2) BLUE BAND

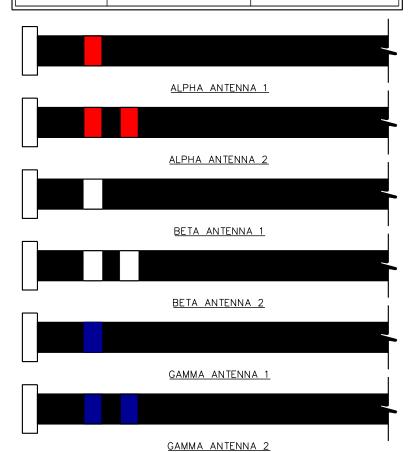

TO ANTENNA 1" E	3" TECHNOLOGY BAND, SEE TECHNOLOGY BAND CHART	

COAX CABLE BANDING

LTE

B5

LTE


B46 (LAA)

SCALE: N.T.S.

RET CABLE BANDING

NOTES:

- CONTRACTOR TO VERIFY CABINET AMPERAGE RATING. PROPOSED CIRCUIT BREAKER AND CONDUCTORS TO FEED NEW CABINET SHOULD BE SIZED PER CABINET RATING.
- 2. MAX RUN LENGTH FROM THE POWER PANEL TO THE LTE CABINET IS 180'-O" (ASSUMING 150A FEED)
- 3. THIS SITE IS DESIGNED IN ACCORDANCE WITH THE 2020 NATIONAL ELECTRIC CODE.

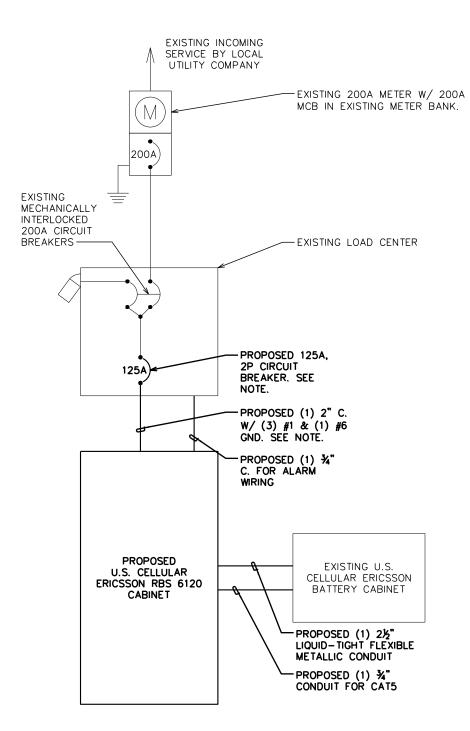



(773) 399-8900

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11884 US HWY 421 NORTH BROADWAY, NC (HARNETT COUNTY)


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N.C. LICENSE # C-1794



7 04-14-21 CONSTRUCTION
6 03-26-21 PRELIMINARY
5 01-18-21 PRELIMINARY
REV DATE ISSUED FOR:

DRAWN BY: JGC CHECKED BY: JHB

SHEET TITLE:

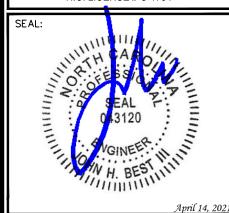ONE-LINE DIAGRAM

SHEET NUMBER:

REVISION:

TEP#: 43045.45387

PROPOSED ERICSSON RBS + BATTERY CABINET ONE-LINE DIAGRAM

GENERAL NOTES:


- 1. ALL REFERENCES TO OWNER IN THESE DOCUMENTS SHALL BE CONSIDERED U.S. CELLULAR OR ITS DESIGNATED REPRESENTATIVE.
- 2. ALL WORK PRESENTED ON THESE DRAWINGS MUST BE COMPLETED BY THE CONTRACTOR UNLESS NOTED OTHERWISE. THE CONTRACTOR MUST HAVE CONSIDERABLE EXPERIENCE IN PERFORMANCE OF WORK SIMILAR TO THAT DESCRIBED HEREIN. BY ACCEPTANCE OF THIS ASSIGNMENT, THE CONTRACTOR IS ATTESTING THAT HE DOES HAVE SUFFICIENT EXPERIENCE AND ABILITY, THAT HE IS KNOWLEDGEABLE OF THE WORK TO BE PERFORMED AND THAT HE IS PROPERLY LICENSED AND PROPERLY REGISTERED TO DO THIS WORK IN THE STATE OF NORTH CAROLINA.
- 3. STRUCTURE IS DESIGNED IN ACCORDANCE WITH ANSI/TIA-222-H, AND THE REQUIREMENTS OF THE NORTH CAROLINA STATE BUILDING CODE, 2018 EDITION.
- 4. WORK SHALL BE COMPLETED IN ACCORDANCE WITH THE NORTH CAROLINA STATE BUILDING CODE, 2018 EDITION.
- 5. UNLESS SHOWN OR NOTED OTHERWISE ON THE CONTRACT DRAWINGS, OR IN THE SPECIFICATIONS, THE FOLLOWING NOTES SHALL APPLY TO THE MATERIALS LISTED HEREIN, AND TO THE PROCEDURES TO BE USED ON THIS PROJECT.
- 6. ALL HARDWARE ASSEMBLY MANUFACTURER'S INSTRUCTIONS SHALL BE FOLLOWED EXACTLY AND SHALL SUPERCEDE ANY CONFLICTING NOTES ENCLOSED HEREIN.
- 7. IT IS THE CONTRACTOR'S SOLE RESPONSIBILITY TO DETERMINE ERECTION PROCEDURE AND SEQUENCE TO INSURE THE SAFETY OF THE STRUCTURE AND ITS COMPONENT PARTS DURING ERECTION AND/OR FIELD MODIFICATIONS. THIS INCLUDES, BUT IS NOT LIMITED TO, THE ADDITION OF TEMPORARY BRACING, GUYS OR TIE DOWNS THAT MAY BE NECESSARY. SUCH MATERIAL SHALL BE REMOVED AND SHALL REMAIN THE PROPERTY OF THE CONTRACTOR AFTER THE COMPLETION OF THE PROJECT.
- 8. ALL DIMENSIONS, ELEVATIONS, AND EXISTING CONDITIONS SHOWN ON THE DRAWINGS SHALL BE FIELD VERIFIED BY THE CONTRACTOR PRIOR TO BEGINNING ANY MATERIALS ORDERING, FABRICATION OR CONSTRUCTION WORK ON THIS PROJECT. CONTRACTOR SHALL NOT SCALE CONTRACT DRAWINGS IN LIEU OF FIELD VERIFICATIONS. ANY DISCREPANCIES SHALL BE IMMEDIATELY BROUGHT TO THE ATTENTION OF THE OWNER AND THE OWNER'S ENGINEER. THE DISCREPANCIES MUST BE RESOLVED BEFORE THE CONTRACTOR IS TO PROCEED WITH THE WORK. THE OWNER SHALL HAVE A SET OF APPROVED. PLANS AVAILABLE AT THE SITE AT ALL TIMES WHILE WORK IS BEING PERFORMED. A DESIGNATED RESPONSIBLE EMPLOYEE SHALL BE AVAILABLE FOR CONTACT BY GOVERNING AGENCY INSPECTORS. THE CONTRACT DOCUMENTS DO NOT INDICATE THE METHOD OF CONSTRUCTION. THE CONTRACTOR SHALL SUPERVISES AND DIRECT THE WORK AND SHALL BE SOLELY RESPONSIBLE FOR ALL CONSTRUCTION MEANS, METHODS, TECHNIQUES, SEQUENCES, AND PROCEDURES. OBSERVATION VISITS TO THE SITE BY THE OWNER AND/OR THE ENGINEER SHALL NOT INCLUDE INSPECTION OF THE PROTECTIVE MEASURES OR THE PROCEDURES.
- 9. ALL MATERIALS AND EQUIPMENT FURNISHED SHALL BE NEW AND OF GOOD QUALITY, FREE FROM FAULTS AND DEFECTS AND IN CONFORMANCE WITH THE CONTRACT DOCUMENTS. ANY AND ALL SUBSTITUTIONS MUST BE PROPERLY APPROVED AND AUTHORIZED IN WRITING BY THE OWNER AND ENGINEER PRIOR TO INSTALLATION. THE CONTRACTOR SHALL FURNISH SATISFACTORY EVIDENCE AS TO THE KIND AND QUALITY OF THE MATERIALS AND EQUIPMENT BEING SUBSTITUTED.
- 10. THE CONTRACTOR SHALL BE RESPONSIBLE FOR INITIATING, MAINTAINING, AND SUPERVISING ALL SAFETY PRECAUTIONS AND PROGRAMS IN CONNECTION WITH THE WORK. THE CONTRACTOR IS RESPONSIBLE FOR INSURING THAT THIS PROJECT AND RELATED WORK COMPLIES WITH ALL APPLICABLE LOCAL, STATE, AND FEDERAL SAFETY CODES AND REGULATIONS GOVERNING THIS WORK
- 11. ACCESS TO THE PROPOSED WORK SITE MAY BE RESTRICTED. THE CONTRACTOR SHALL COORDINATE INTENDED CONSTRUCTION ACTIVITY, INCLUDING WORK SCHEDULE AND MATERIALS ACCESS, WITH THE RESIDENT LEASING AGENT FOR APPROVAL.
- 12. BILL OF MATERIALS AND PART NUMBERS LISTED ON CONSTRUCTION DRAWINGS ARE INTENDED TO AID CONTRACTOR. CONTRACTOR SHALL VERIFY PARTS AND QUANTITIES WITH MANUFACTURER PRIOR TO BIDDING AND/OR ORDERING MATERIALS.
- 13. ALL PERMITS THAT MUST BE OBTAINED ARE THE RESPONSIBILITY OF THE CONTRACTOR. THE CONTRACTOR WILL BE RESPONSIBLE FOR ABIDING BY ALL CONDITIONS AND REQUIREMENTS OF THE PERMITS.
- 14. 24 HOURS PRIOR TO THE BEGINNING OF ANY CONSTRUCTION, THE CONTRACTOR MUST NOTIFY THE APPLICABLE JURISDICTIONAL (STATE, COUNTY OR CITY) ENGINEER.
- 15. THE CONTRACTOR SHALL REWORK (DRY, SCARIFY, ETC.) ALL MATERIAL NOT SUITABLE FOR SUBGRADE IN IT PRESENT STATE. AFTER REWORKING, IF THE MATERIAL REMAINS UNSUITABLE, THE CONTRACTOR SHALL UNDERCUT THIS MATERIAL AND REPLACE WITH APPROVED MATERIAL. ALL SUBGRADES SHALL BE PROOFROLLED WITH A FULLY LOADED TANDEM AXLE DUMP TRUCK PRIOR TO PAVING. ANY SOFTER MATERIAL SHALL BE REWORKED OR REPLACED.

STRUCTURAL STEEL NOTES:

- 1. THE FABRICATION AND ERECTION OF STRUCTURAL STEEL SHALL CONFORM TO THE AISC SPECIFICATIONS AND MANUAL OF STEEL CONSTRUCTION, 14TH EDITION.
- 2. UNLESS OTHERWISE NOTED, ALL STRUCTURAL ELEMENTS SHALL CONFORM TO THE FOLLOWING REQUIREMENTS:
 - A. STRUCTURAL STEEL, ASTM DESIGNATION A36 OR GR50.
 - B. ALL BOLTS, ASTM A325 TYPE I GALVANIZED HIGH STRENGTH BOLTS.
 - C. ALL NUTS, ASTM A563 CARBON AND ALLOY STEEL NUTS.
 - D. ALL WASHERS, ASTM F436 HARDENED STEEL WASHERS.
- 3. ALL CONNECTIONS NOT FULLY DETAILED ON THESE PLANS SHALL BE DETAILED BY THE STEEL FABRICATOR IN ACCORDANCE WITH AISC SPECIFICATIONS AND MANUAL OF STEEL CONSTRUCTION, 13TH EDITION.
- 4. HOLES SHALL NOT BE FLAME CUT THRU STEEL UNLESS APPROVED BY THE ENGINEER.
- 5. HOT-DIP GALVANIZE ALL ITEMS UNLESS OTHERWISE NOTED, AFTER FABRICATION WHERE PRACTICABLE. GALVANIZING: ASTM A123, ASTM, A153/A153M OR ASTM A653/A653M, G90, AS APPLICABLE.
- 6. REPAIR DAMAGED SURFACES WITH GALVANIZING REPAIR METHOD AND PAINT CONFORMING TO ASTM A780 OR BY APPLICATION OF STICK OR THICK PASTED MATERIAL SPECIFICALLY DESIGNED FOR REPAIR OF GALVANIZING. CLEAN AREAS TO BE REPAIRED AND REMOVE SLAG FROM WELDS. HEAT SURFACES TO WHICH STICK OR PASTE MATERIAL IS APPLIED, WITH A TORCH TO A TEMPERATURE SUFFICIENT TO MELT THE METALLICS IN STICK OR PASTED; SPREAD MOLTEN MATERIAL UNIFORMLY OVER SURFACES TO BE COATED AND WIPE OFF EXCESS MATERIAL.
- 7. A NUT LOCKING DEVICE SHALL BE INSTALLED ON ALL PROPOSED AND/OR REPLACED BOLTS.
- 8. ALL PROPOSED AN/OR REPLACED BOLTS SHALL BE OF SUFFICIENT LENGTH TO EXCLUDE THE THREADS FROM THE SHEAR PLANE.
- 9. ALL PROPOSED AND/OR REPLACED BOLTS SHALL BE OF SUFFICIENT LENGTH SUCH THAT THE END OF THE BOLT BE AT LEAST FLUSH WITH THE FACE OF THE NUT. IT IS NOT PERMITTED FOR THE BOLT END TO BE BELOW THE FACE OF THE NUT AFTER TIGHTENING IS COMPLETED.
- 10. ALL ASSEMBLY AND ANCHOR BOLTS ARE TO BE TIGHTENED TO A "SNUG TIGHT" CONDITION AS DEFINED IN SECTION 8.1 OF THE AISC, "SPECIFICATION FOR STRUCTURAL JOINTS USING ASTM A325 OR A490 BOLTS", DATED JUNE 30, 2004.
- 11. FLAT WASHERS ARE TO BE INSTALLED WITH BOLTS OVER SLOTTED HOLES.
- 12. DO NOT OVER TORQUE ASSEMBLY BOLTS. GALVANIZING ON BOLTS, NUTS, AND STEEL PARTS MAY ACT AS A LUBRICANT, THUS OVER TIGHTENING MAY OCCUR AND MAY CAUSE BOLTS TO CRACK AND SNAP OFF.
- 13. PAL NUTS ARE TO BE INSTALLED AFTER NUTS ARE TIGHT AND WITH EDGE LIP OUT. PAL NUTS ARE NOT REQUIRED WHEN SELF-LOCKING NUTS ARE PROVIDED.
- 14. GALVANIZED ASTM A325 BOLTS SHALL NOT BE REUSED.
- 15. ALL WELDING SHALL BE IN ACCORDANCE WITH THE AWS D1.1: 2010, STRUCTURAL WELDING CODE-REINFORCING STEEL. ALL WELDERS SHALL DISPLAY PROPER CERTIFICATION OF QUALIFICATION.

GROUNDING NOTES:

- ALL CADWELD CONNECTIONS TO GALVANIZED MATERIAL SHALL BE PROPERLY PREPARED TO ASSURE A SATISFACTORY CADWELD.
- 2. CADWELD CONNECTION SHALL BE COATED WITH COLD GALVANIZING SPRAY.
- 3. ALL VERTICAL JUMPERS SHALL NOT BE WELDED WITHIN TWO FT OF THE GROUND ROD.
- 4. SECTOR GROUNDING DIAGRAM:

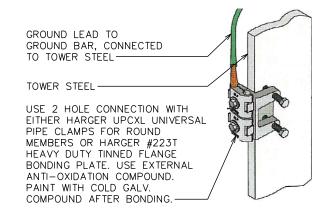




(773) 399-8900

PROJECT INFORMATION:

556470 ARLINGTON

11884 US HWY 421 NORTH BROADWAY, NC (HARNETT COUNTY)



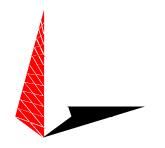

TOWER ENGINEERING PROFESSIONALS

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N.C. LICENSE # C-1794



April 14, 202.

REV	DATE	ISSUED FOR:	
5	01-18-21	PRELIMINARY	
6	03-26-21	PRELIMINARY	
7	04-14-21	CONSTRUCTION	

DRAWN BY: JGC CHECKED BY: JHB

SHEET TITLE:

GENERAL NOTES

SHEET NUMBER:

REVISION:

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