



AMERICAN TOWER®

ATC SITE NAME: MCNEIL CEMETARY NC

ATC SITE NUMBER: 21278

T-MOBILE SITE NAME: ATC CO MCNEIL

CEMETARY

T-MOBILE SITE NUMBER: 5RA0215A SITE ADDRESS: 14180 NC 210 SOUTH

SPRING LAKE, NC, 28390

T-MOBILE ANCHOR ANTENNA AMENDMENT PLAN 67D5A998C ODE+6160 CONFIGURATION



LOCATION MAP



| COMPLIANCE CODE | IPLIANCE CODE PROJECT SUMMARY | | PROJECT DESCRIPTION | | SHEET INDEX | | | | | | | |
|--|--|--|---|----------------------|---|----------|--|-------|--------------|--|--|--|
| ALL WORK SHALL BE PERFORMED AND MATERIALS INSTALLED IN ACCORDANCE WITH THE CURRENT EDITIONS OF THE | SITE AD | DRESS: | THE PROPOSED PROJECT INCLUDES MODIFYING GROUND BASED AND TOWER MOUNTED EQUIPMENT AS INDICATED PER BELOW: | SHEET NO: | DESCRIPTION: | REV: | DATE: | BY: | | | | |
| FOLLOWING CODES AS ADOPTED BY THE LOCAL GOVERNMENT AUTHORITIES. NOTHING IN THESE PLANS IS | 14180 NC 2 | 210 SOUTH | TOWER WORK: | G-001 | TITLE SHEET | 0 | 05/07/21 | RG | | | | |
| TO BE CONSTRUED TO PERMIT WORK NOT CONFORMING TO | SPRING LAK | G LAKE, NC, 28390 | REMOVE (3) AIR21 KRC118046-1 B2P B4A ANTENNA(s), (3) KRY 112 489/2 TMA(s), (1) 1 3/8" HYBRID CABLE, (1) 1 5/8" FIBER, AND (1) 1 5/8" | G-002 | GENERAL NOTES | 0 | 05/07/21 | RG | | | | |
| THESE CODES. | COUNTY: | HARNETT | COAX CABLE | G-003 | APPENDIX B | 0 | 05/07/21 | RG | | | | |
| 2018 NORTH CAROLINA BUILDING CODE (NCBC) 2017 NATIONAL ELECTRIC CODE (NEC) WITH NC | <u>GEOGRAPHIC</u> | COORDINATES: | INSTALL (3) APX17DWV-17DWV-S-E-A20 ANTENNA(s), (3) AIR6449 B41 | | APPENDIX B | 0 | | | | | | |
| AMENDMENTS | | 35.22349444 | ANTENNA(s), (3) RADIO 4424 B25 RRH(s), (3) RADIO 4415 B66A RRH(s) AND (3) 1 1/4" HYBRID CABLE | G-004 | | | 05/07/21 | RG | | | | |
| LOCAL BUILDING CODE CITY/COUNTY ORDINANCES | | -78.93970000 | EXISTING (3) APXVAARR24 43-U-NA20 ANTENNA(s), (3) RADIO 4449 | G-005 | APPENDIX B | 0 | 05/07/21 | RG | | | | |
| . OH HOODIN I CINDINANCES | GROUND ELEVA | GROUND ELEVATION: 180' AMSL | B71+B85 RRH(s), AND (5) 1 5/8" COAX CABLE(s) TO REMAIN | G-006 | APPENDIX B | 0 | 05/07/21 | RG | | | | |
| | ZONING INFORMATION: | GROUND WORK: | G-007 | APPENDIX B | 0 | 05/07/21 | RG | | | | | |
| | | JURISDICTION: HARNETT COUNTY | INSTALL (1) ENCLOSURE 616 CABINET, (1) B160 BATTERY CABINET, (1) CSR IXRE V2 ROUTER, (1) BB 6648, AND (1) 6'-0" X 6'-4" | C-101 | DETAILED SITE PLAN | 0 | 05/07/21 | RG | | | | |
| | PARCEL #: _010513 0193 | CONCRETE PAD | C-102 | DETAILED GROUND PLAN | 0 | 05/07/21 | RG | | | | | |
| | PROJEC | PROJECT TEAM | EXISTING (1) RBS 6201 ODE CABINET, (1) DUG20, (2) BB 6630, AND (6) RUS01 B2 TO REMAIN | C-201 | TOWER ELEVATION | 0 | 05/07/21 | RG | | | | |
| | TOWER OWNER: | APPLICANT: | THE PROPOSED PROJECT DOES NOT INCLUDE ELECTRICAL SCOPE | C-401 | ANTENNA INFORMATION & SCHEDULE | 0 | 05/07/21 | RG | | | | |
| | AMERICAN TOWER T-MOBILE | PROJECT NOTES | C-501 | CONSTRUCTION DETAILS | 0 | 05/07/21 | RG | | | | | |
| | 10 PRESIDENTIAL WAY WOBURN, MA 01801 | 2105 WATER RIDGE PKWY CHARLOTTE, NC 28217 | THE FACILITY IS UNMANNED. | E-501 | GROUNDING DETAILS | 0 | 05/07/21 | RG | | | | |
| UTILITY COMPANIES | ENGINEER: | | | | A TECHNICIAN WILL VISIT THE SITE APPROXIMATELY ONCE A MONTH FOR ROUTINE INSPECTION AND MAINTENANCE. | R-601 | SUPPLEMENTAL | | | | | |
| POWER COMPANY: SOUTH RIVER EMC | KIMLEY-HORN | | THE PROJECT WILL NOT RESULT IN ANY SIGNIFICANT LAND DISTURBANCE OR EFFECT OF STORM WATER DRAINAGE. | R-602 | SUPPLEMENTAL | | | | | | | |
| PHONE: (800) 338-5530 TELEPHONE COMPANY: CENTURY LINK | & ASSOCIATES, INC. 421 FAYETTEVILLE ST. STE 600 | | | | | | 4. NO SANITARY SEWER, POTABLE WATER OR TRASH | R-603 | SUPPLEMENTAL | | | |
| PHONE: (855) 707-4993 | RALEIGH, NC 27601 COA: F-0102 | | DISPOSAL IS REQUIRED. 5. HANDICAP ACCESS IS NOT REQUIRED. | R-604 | SUPPLEMENTAL | | | | | | | |
| | COA: F-0102 PROPERTY OWNER: | | | | | | | | | | | |
| | WILLIAM LASATER | | PROJECT LOCATION DIRECTIONS | | | | | | | | | |
| Carolina 811 | 18 ANGUS LN SPRING LAKE, NC 28390 | | FROM RALEIGH: TAKE HWY 401 SOUTH 30 MILES TO LILLINGTON, STAY ON HWY 401 SOUTH THRU LILLINGTON. TURN RIGHT ONTO N MAIN ST/NC-210 S 16 MILES DOWN HWY 210. SITE SITS BEHIND A MINI ROADSIDE FLEA MARKET ON THE RIGHT SIDE OF ROAD. | | | | | | | | | |





COA: F-0102 421 FAYETTEVILLE ST, SUITE 600 RALEIGH, NC 27601

| REV. | DESCRIPTION | BY | DATE |
|---------------------|-------------------------|-----------|----------|
| A. | PRELIM | RG | 04/26/21 |
| <u> 6</u> | ISSUED FOR CONSTRUCTION | <u>RG</u> | 05/07/21 |
| \triangle | | | |
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| $\overline{\wedge}$ | | | |

ATC SITE NUMBER:

21278


ATC SITE NAME:

MCNEIL CEMETARY NC

T-MOBILE SITE NAME:

ATC CO MCNEIL CEMETARY

SITE ADDRESS: 14180 NC 210 SOUTH SPRING LAKE, NC, 28390

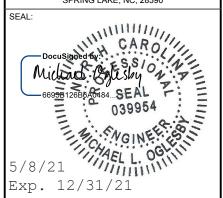

T··Mobile

| DATE DRAWN: | 05/07/21 |
|--------------|------------------------|
| ATC JOB NO: | XXXX |
| CUSTOMER ID: | ATC CO MCNEIL CEMETARY |
| CUSTOMER #: | 5RA0215A |
| | |

TITLE SHEET

SHEET NUMBER:

G-001

GENERAL CONSTRUCTION NOTES:

- OWNER FURNISHED MATERIALS, T-MOBILE "THE COMPANY" WILL PROVIDE AND THE CONTRACTOR WILL INSTALL
 - A. BTS EQUIPMENT FRAME (PLATFORM) AND ICEBRIDGE SHELTER (GROUND BUILD/CO-LOCATE ONLY)
 - AC/TELCO INTERFACE BOX (PPC)
 - ICE BRIDGE (CABLE TRAY WITH COVER) (GROUND BUILD/CO-LOCATE ONLY, GC TO FURNISH AND INSTALL FOR ROOFTOP INSTALLATION)
 - D. TOWERS, MONOPOLES
 - TOWER LIGHTING
 - GENERATORS & LIQUID PROPANE TANK
 - ANTENNA STANDARD BRACKETS, FRAMES AND PIPES FOR MOUNTING
 - ANTENNAS (INSTALLED BY OTHERS)
 - TRANSMISSION LINE
 - TRANSMISSION LINE JUMPERS
 - TRANSMISSION LINE CONNECTORS WITH WEATHERPROOFING KITS
 - TRANSMISSION LINE GROUND KITS
 - HANGERS
 - HOISTING GRIPS
 - O. BTS EQUIPMENT
- THE CONTRACTOR IS RESPONSIBLE TO PROVIDE ALL OTHER MATERIALS FOR THE COMPLETE INSTALLATION OF THE SITE INCLUDING, BUT NOT LIMITED TO, SUCH MATERIALS AS FENCING, STRUCTURAL STEEL SUPPORTING SUB-FRAME FOR PLATFORM, ROOFING LABOR AND MATERIALS GROUNDING RINGS GROUNDING WIRES COPPER-CLAD OR XIT CHEMICAL GROUND ROD(S), BUSS BARS, TRANSFORMERS AND DISCONNECT SWITCHES WHERE APPLICABLE, TEMPORARY ELECTRICAL POWER CONDUIT LANDSCAPING COMPOUND STONE CRANES CORE DRILLING SLEEPERS AND RUBBER MATTING, REBAR, CONCRETE CAISSONS, PADS AND/OR AUGER MOUNTS, MISCELLANEOUS FASTENERS, CABLE TRAYS, NON-STANDARD ANTENNA FRAMES AND ALL OTHER MATERIAL AND LABOR REQUIRED TO COMPLETE THE JOB ACCORDING TO THE DRAWINGS AND SPECIFICATIONS. IT IS THE POSITION OF T-MOBILE TO APPLY FOR PERMITTING AND CONTRACTOR RESPONSIBLE FOR PICKUP AND PAYMENT OF REQUIRED
- ALL WORK SHALL CONFORM TO ALL CURRENT APPLICABLE FEDERAL, STATE, AND LOCAL CODES, INCLUDING ANSI/EIA/TIA-222, AND COMPLY WITH ATC CONSTRUCTION
- CONTRACTOR SHALL CONTACT LOCAL 811 FOR IDENTIFICATION OF UNDERGROUND
- CONTRACTOR SHALL BE RESPONSIBLE FOR COORDINATING ALL REQUIRED INSPECTIONS.
- ALL DIMENSIONS TO, OF, AND ON EXISTING BUILDINGS, DRAINAGE STRUCTURES, AND SITE IMPROVEMENTS SHALL BE VERIFIED IN FIELD BY CONTRACTOR WITH ALL DISCREPANCIES REPORTED TO THE ENGINEER.
- DO NOT CHANGE SIZE OR SPACING OF STRUCTURAL ELEMENTS
- DETAILS SHOWN ARE TYPICAL: SIMILAR DETAILS APPLY TO SIMILAR CONDITIONS UNLESS
- THESE DRAWINGS DO NOT INCLUDE NECESSARY COMPONENTS FOR CONSTRUCTION SAFETY WHICH SHALL BE THE SOLE RESPONSIBILITY OF THE CONTRACTOR
- CONTRACTOR SHALL BRACE STRUCTURES UNTIL ALL STRUCTURAL ELEMENTS NEEDED FOR STABILITY ARE INSTALLED. THESE ELEMENTS ARE AS FOLLOWS: LATERAL BRACING,
- CONTRACTOR SHALL DETERMINE EXACT LOCATION OF EXISTING UTILITIES. GROUNDS DRAINS, DRAIN PIPES, VENTS, ETC, BEFORE COMMENCING WORK
- INCORRECTLY FABRICATED, DAMAGED, OR OTHERWISE MISFITTING OR NONCONFORMING MATERIALS OR CONDITIONS SHALL BE REPORTED TO THE T-MOBILE REP PRIOR TO REMEDIAL OR CORRECTIVE ACTION, ANY SUCH REMEDIAL ACTION SHALL REQUIRE WRITTEN APPROVAL BY THE T-MOBILE REP PRIOR TO PROCEEDING.
- EACH CONTRACTOR SHALL COOPERATE WITH THE T-MOBILE REP, AND COORDINATE HIS WORK WITH THE WORK OF OTHERS.
- CONTRACTOR SHALL REPAIR ANY DAMAGE CAUSED BY CONSTRUCTION OF THIS PROJECT TO MATCH EXISTING PRE-CONSTRUCTION CONDITIONS TO THE SATISFACTION
- ALL CABLE/CONDUIT ENTRY/EXIT PORTS SHALL BE WEATHERPROOFED DURING 15. INSTALLATION LISING A SILICONE SEALANT
- WHERE EXISTING CONDITIONS DO NOT MATCH THOSE SHOWN IN THIS PLAN SET. CONTRACTOR SHALL NOTIFY THE T-MOBILE REP AND ENGINEER OF RECORD
- CONTRACTOR SHALL ENSURE ALL SUBCONTRACTORS ARE PROVIDED WITH A COMPLETE AND CURRENT SET OF DRAWINGS AND SPECIFICATIONS FOR THIS PROJECT
- CONTRACTOR SHALL REMOVE ALL RUBBISH AND DEBRIS FROM THE SITE AT THE END OF
- CONTRACTOR SHALL COORDINATE WORK SCHEDULE WITH AMERICAN TOWER CORPORATION (ATC) AND TAKE PRECAUTIONS TO MINIMIZE IMPACT AND DISRUPTION OF OTHER OCCUPANTS OF THE FACILITY.
- CONTRACTOR SHALL FURNISH T-MOBILE AND AMERICAN TOWER CORPORATION (ATC) /ITH A PDF MARKED UP AS-BUILT SET OF DRAWINGS UPON COMPLETION OF WOR
- PRIOR TO SUBMISSION OF BID CONTRACTOR SHALL COORDINATE WITH T-MOBILE REP TO DETERMINE WHAT, IF ANY, ITEMS WILL BE PROVIDED. ALL ITEMS NOT PROVIDED SHALL BE PROVIDED AND INSTALLED BY THE CONTRACTOR. CONTRACTOR WILL INSTALL

- 22. PRIOR TO SUBMISSION OF BID. CONTRACTOR SHALL COORDINATE WITH T-MORII F REP TO DETERMINE IF ANY PERMITS WILL BE OBTAINED BY CONTRACTOR. ALL REQUIRED PERMITS NOT OBTAINED BY T-MOBILE MUST BE OBTAINED, AND PAID FOR, BY THE
- 23. CONTRACTOR SHALL INSTALL ALL SITE SIGNAGE IN ACCORDANCE WITH T-MOBILE SPECIFICATIONS AND REQUIREMENTS.
- CONTRACTOR SHALL SUBMIT ALL SHOP DRAWINGS TO T-MOBILE FOR REVIEW AND 24. APPROVAL PRIOR TO FABRICATION
- ALL EQUIPMENT SHALL BE INSTALLED ACCORDING TO MANUFACTURER'S SPECIFICATIONS AND LOCATED ACCORDING TO T-MOBILE SPECIFICATIONS, AND AS SHOWN IN THESE PLANS
- THE CONTRACTOR SHALL SUPERVISE AND DIRECT THE PROJECT DESCRIBED HEREIN. THE CONTRACTOR SHALL BE SOLELY RESPONSIBLE FOR ALL THE CONSTRUCTION MEANS, METHODS, TECHNIQUES, SEQUENCES AND PROCEDURES AND FOR COORDINATING ALL PORTIONS OF THE WORK UNDER THE CONTRACT.
- CONTRACTOR SHALL NOTIFY T-MOBILE REP A MINIMUM OF 48 HOURS IN ADVANCE OF POURING CONCRETE OR BACKFILLING ANY UNDERGROUND UTILITIES, FOUNDATIONS OR SEALING ANY WALL, FLOOR OR ROOF PENETRATIONS FOR ENGINEERING REVIEW AND
- CONTRACTOR SHALL BE RESPONSIBLE FOR SITE SAFETY INCLUDING COMPLIANCE WITH ALL APPLICABLE OSHA STANDARDS AND RECOMMENDATIONS AND SHALL PROVIDE ALL NECESSARY SAFETY DEVICES INCLUDING PPE AND PPM AND CONSTRUCTION DEVICES. SUCH AS WELDING AND FIRE PREVENTION, TEMPORARY SHORING, SCAFFOLDING, TRENCH BOXES/SLOPING, BARRIERS, ETC.
- THE CONTRACTOR SHALL PROTECT AT HIS OWN EXPENSE ALL EXISTING FACILITIES AND SUCH OF HIS NEW WORK LIABLE TO INJURY DURING THE CONSTRUCTION PERIOD. ANY DAMAGE CAUSED BY NEGLECT ON THE PART OF THIS CONTRACTOR OR HIS REPRESENTATIVES, OR BY THE ELEMENTS DUE TO NEGLECT ON THE PART OF THIS CONTRACTOR OR HIS REPRESENTATIVES, EITHER TO THE EXISTING WORK, OR TO HIS WORK OR THE WORK OF ANY OTHER CONTRACTOR, SHALL BE REPAIRED AT HIS EXPENSE TO THE OWNER'S SATISFACTION.
- ALL WORK SHALL BE INSTALLED IN A FIRST CLASS. NEAT AND WORKMANLIKE MANNER BY MECHANICS SKILLED IN THE TRADE INVOLVED. THE QUALITY OF WORKMANSHIP SHALL BE SUBJECT TO THE APPROVAL OF THE T-MOBILE REP. ANY WORK FOUND BY THE T-MOBILE REP TO BE OF INFERIOR QUALITY AND/OR WORKMANSHIP SHALL BE REPLACED AND/OR REWORKED AT CONTRACTOR EXPENSE UNTIL APPROVAL IS
- 31. IN ORDER TO ESTABLISH STANDARDS OF QUALITY AND PERFORMANCE, ALL TYPES OF MATERIALS LISTED HEREINAFTER BY MANUFACTURER'S NAMES AND/OR
 MANUFACTURER'S CATALOG NUMBER SHALL BE PROVIDED BY THESE MANUFACTURERS

 10. DO NOT WELD OR TACK WELD REINFORCING STEEL. AS SPECIFIED.
- T-MOBILE FURNISHED FOLIPMENT SHALL BE PICKED-UP AT THE T-MOBILE WAREHOUSE NO LATER THAN 48HR AFTER BEING NOTIFIED INSURED, STORED, UNCRATE, PROTECTED AND INSTALLED BY THE CONTRACTOR WITH ALL APPURTENANCES REQUIRED TO PLACE THE EQUIPMENT IN OPERATION, READY FOR USE. THE CONTRACTOR SHALL BE RESPONSIBLE FOR THE EQUIPMENT AFTER PICKING IT UP
- T-MOBILE OR HIS ARCHITECT/ENGINEER RESERVES THE RIGHT TO REJECT ANY 33. EQUIPMENT OR MATERIALS WHICH, IN HIS OWN OPINION ARE NOT IN COMPLIANCE WITH THE CONTRACT DOCUMENTS, EITHER BEFORE OR AFTER INSTALLATION AND THE EQUIPMENT SHALL BE REPLACED WITH EQUIPMENT CONFORMING TO THE REQUIREMENTS OF THE CONTRACT DOCUMENTS BY THE CONTRACTOR AT NO COST TO T-MOBILE OR THEIR ARCHITECT/ENGINEER

SPECIAL CONSTRUCTION ANTENNA INSTALLATION NOTES:

- WORK INCLUDED:
 - ANTENNA AND COAXIAL CABLES ARE FURNISHED BY T-MOBILE UNDER A SEPARATE CONTRACT. THE CONTRACTOR SHALL ASSIST ANTENNA INSTALLATION CONTRACTOR IN TERMS OF COORDINATION AND SITE ACCESS. ERECTION SUBCONTRACTOR SHALL BE RESPONSIBLE FOR THE PROTECTION OF
 - B. INSTALL ANTENNA AS INDICATED ON DRAWINGS AND T-MOBILE SPECIFICATIONS.
 - C. INSTALL GALVANIZED STEEL ANTENNA MOUNTS AS INDICATED ON DRAWINGS.
 - D. INSTALL FURNISHED GALVANIZED STEEL OR ALUMINUM WAVEGUIDE AND PROVIDE PRINTOUT OF THAT TEST.
 - CONTRACTOR SHALL PROVIDE FOUR (4) SETS OF SWEEP TESTS USING ANRITZU-PACKARD 8713B RF SCALAR NETWORK ANALYZER. SUBMIT FREQUENCY DOMAIN REFLECTOMETER(FDR) TESTS RESULTS TO THE PROJECT MANAGER. SWEEP TESTS SHALL BE AS PER ATTACHED RFS "MINIMUM FIELD TESTING RECOMMENDED FOR ANTENNA AND HELIAX COAXIAL CABLE SYSTEMS" DATED 10/5/93 TESTING SHALL BE PERFORMED BY AN INDEPENDENT TESTING SERVICE AND BE BOUND AND SUBMITTED WITHIN ONE WEEK OF WORK COMPLETION.
 - INSTALL COAXIAL CABLES AND TERMINATING BETWEEN ANTENNAS AND EQUIPMENT PER MANUFACTURER'S RECOMMENDATIONS, WEATHERPROOF ALL CONNECTIONS BETWEEN THE ANTENNA AND EQUIPMENT PER MANUFACTURER'S REQUIREMENTS. TERMINATE ALL COAXIAL CABLE THREE (3) FEET IN EXCESS OF ENTRY PORT LOCATION UNLESS OTHERWISE STATED.
 - G. ANTENNA AND COAXIAL CABLE GROUNDING:
- ALL EXTERIOR #6 GREEN GROUND WIRE "DAISY CHAIN" CONNECTIONS ARE O BE WEATHER SEALED WITH RFS CONNECTORS/SPLICE WEATHERPROOFING KIT #221213 OR EQUAL.
- ii. ALL COAXIAL CABLE GROUNDING KITS ARE TO BE INSTALLED ON STRAIGHT

RUNS OF COAXIAL CABLE (NOT WITHIN BENDS).

CONCRETE AND REINFORCING STEEL NOTES:

- DESIGN AND CONSTRUCTION OF ALL CONCRETE ELEMENTS SHALL CONFORM TO THE LATEST EDITIONS OF ALL APPLICABLE CODES INCLUDING: ACI 301 "SPECIFICATIONS FOR STRUCTURAL CONCRETE FOR BUILDINGS", ACI 117 "SPECIFICATIONS FOR TOLERANCES FOR CONCRETE CONSTRUCTION AND MATERIALS", AND ACI 318 "BUILDING CODE REQUIREMENTS FOR REINFORCED CONCRETE."
- 3. MIX DESIGN SHALL BE APPROVED BY T-MOBILE REP PRIOR TO PLACING CONCRETE.
- CONCRETE SHALL BE NORMAL WEIGHT, 6 % AIR ENTRAINED (+/- 1.5%) WITH A SLUMP RANGE OF 3-6" AND HAVE A MINIMUM 28-DAY COMPRESSIVE STRENGTH OF 4000 PSI UNLESS OTHERWISE NOTED.
- THE FOLLOWING MATERIALS SHALL BE USED:

PORTLAND CEMENT: ASTM C150, TYPE 2

ASTM A185, PLAIN STEEL WELDED WIRE FABRIC REINFORCEMENT:

REINFORCEMENT BARS ASTM A615, GRADE 60, DEFORMED NORMAL WEIGHT AGGREGATE: ASTM C33

WATER. ASTM C 94/C 94N

WELDED WIRE FABRIC: ASTM A185

ADMIXTURES:

-WATER-REDUCING AGENT: ASTM C 494/C 494M, TYPE A

-AIR-ENTERING AGENT: ASTM C 260/C 260M

-SUPERPLASTICIZER: ASTM C494, TYPE F OR TYPE G -RETARDING: ASTM C 494/C 494M, TYPE B

- MINIMUM CONCRETE COVER FOR REINFORCING STEEL SHALL BE NO LESS THAN 3"
- A 3/4" CHAMFER SHALL BE PROVIDED AT ALL EXPOSED EDGES OF CONCRETE IN ACCORDANCE WITH ACI 301 SECTION 4.2.4, UNLESS NOTED OTHERWISE
- INSTALLATION OF CONCRETE EXPANSION/WEDGE ANCHOR SHALL BE PER MANUFACTURER'S WRITTEN RECOMMENDED PROCEDURE. THE ANCHOR BOLT, DOWEL, OR ROD SHALL CONFORM TO MANUFACTURER'S RECOMMENDATION FOR EMBEDMENT DEPTH OR AS SHOWN ON THE DRAWINGS. NO REBAR SHALL BE CUT WITHOUT PRIOR APPROVAL FROM AN ATC ENGINEER WHEN DRILLING HOLES IN CONCRETE.
- ADMIXTURES SHALL CONFORM TO THE APPROPRIATE ASTM STANDARD AS REFERENCED IN "METHOD 1" OF ACI 301.
- ALL DOWELS, ANCHOR BOLTS, EMBEDDED STEEL, ELECTRICAL CONDUITS, PIPE SLEEVES, GROUNDS AND ALL OTHER EMBEDDED ITEMS AND FORMED DETAILS SHALL BE IN PLACE BEFORE START OF CONCRETE PLACEMENT
- REINFORCEMENT SHALL BE COLD BENT WHENEVER BENDING IS REQUIRED.
- 13. DO NOT PLACE CONCRETE IN WATER, ICE, OR ON FROZEN GROUND.
- FOR COLD-WEATHER (ACI 306) AND HOT-WEATHER (ACI 301M) CONCRETE PLACEMENT, CONFORM TO APPLICABLE ACI CODES AND RECOMMENDATIONS. IN EITHER CASE, MATERIALS CONTAINING CHI ORIDE CALCIUM SALTS ETC SHALL NOT BE USED. PROTECT FRESH CONCRETE FROM WEATHER FOR 7 DAYS, MINIMUM.
- 15. ALL CONCRETE SHALL HAVE A "SMOOTH FORM FINISH.
- SPLICING OF REINFORCEMENT IS PERMITTED ONLY AT LOCATIONS SHOWN IN THE CONTRACT DRAWINGS OR AS ACCEPTED BY THE ENGINEER. LINI ESS OTHERWISI SHOWN OR NOTED REINFORCING STEEL SHALL BE SPLICED TO DEVELOP ITS FULL TENSILE CAPACITY (CLASS A) IN ACCORDANCE WITH ACI 318.
- 17. DETAILING OF REINFORCING STEEL SHALL CONFORM TO "ACI MANUAL OF STANDARD PRACTICE FOR DETAILING REINFORCED CONCRETE STRUCTURES" (ACI 315)
- ALL SLAB CONSTRUCTION SHALL BE CAST MONOLITHICALLY WITHOUT HORIZONTAL CONSTRUCTION JOINTS, UNLESS SHOWN IN THE CONTRACT DRAWINGS.
- LOCATION OF ALL CONSTRUCTION JOINTS ARE SUBJECT TO THE REQUIREMENTS OF THE CONTRACT DOCUMENTS, CONFORMANCE WITH ACI 318, AND ACCEPTANCE OF THE ENGINEER. DRAWINGS SHOWING LOCATION OF DETAILS OF THE PROPOS CONSTRUCTION JOINTS SHALL BE SUBMITTED WITH REINFORCING STEEL PLACEMENT
- SPLICES OF WWE AT ALL SPLICED EDGES. SHALL BE SUCH THAT THE OVERLAP MEASURED BETWEEN OUTERMOST CROSS WIRES OF EACH FABRIC SHEET IS NOT LESS THAN THE SPACING OF THE CROSS WIRE PLUS 2 INCHES, NOR LESS THAN 6"
- 21 BAR SUPPORTS SHALL BE ALL-GALVANIZED METAL WITH PLASTIC TIPS
- ALL REINFORCEMENT SHALL BE SECURELY TIED IN PLACE TO PREVENT DISPLACEMENT BY CONSTRUCTION TRAFFIC OR CONCRETE. TIE WIRE SHALL BE OF SUFFICIENT STRENGTH FOR INTENDED PURPOSE, BUT NOT LESS THAN NO. 18 GAUGE.
- 23. SLAB ON GROUND: COMPACT STRUCTURAL FILL TO 95% DENSITY AND THEN PLACE 6"

ALL DISCREPANCIES FROM WHAT IS SHOWN ON THESE CONSTRUCTION DRAWINGS SHALL BE COMMUNICATED TO ATC ENGINEERING IMMEDIATELY FOR CORRECTION OR RE-DESIGN. AILURE TO COMMUNICATE DIRECTLY WITH ATC ENGINEERING OR ANY CHANGES FROM THE DESIGN CONDUCTED WITHOUT PRIOR APPROVAL FROM ATC ENGINEERING SHALL BE THE SOLE RESPONSIBILITY OF THE GENERAL CONTRACTOR.

AMERICAN TOWER®



COA: F-0102 **421 FAYETTEVILLE ST. SUITE 600** RALEIGH, NC 27601

DESCRIPTION BY DATE PRELIM RG 04/26/21 0 ISSUED FOR CONSTRUCTION RG 05/07/21

ATC SITE NUMBER:

21278

ATC SITE NAME:

MCNEIL CEMETARY NC

T-MOBILE SITE NAME:

ATC CO MCNEIL CEMETARY

SITE ADDRESS 14180 NC 210 SOUTH SPRING LAKE, NC. 28390



T-Mobile

DATE DRAWN: | 05/07/21 ATC JOB NO: XXXX CUSTOMER ID: ATC CO MCNEIL CEMETARY CUSTOMER #: | 5RA0215A

GENERAL NOTES

SHEET NUMBER

G-002

0

2018 APPENDIX B **BUILDING CODE SUMMARY FOR ALL COMMERCIAL PROJECTS**

(EXCEPT 1 AND 2-FAMILY DWELLINGS AND TOWNHOUSES)

(Reproduce the following data on the building plans sheet 1 or 2)

| Name of Project: | T- MOBILE - MCNEIL CEMI | ETERY NC | | | | |
|--------------------------------|--|---|--------------------------------|-------------------------|--|----------|
| 3 | NC 210 SOUTH, SPRING LAK | | | Zip | Code <u>28390</u> | |
| | ed Agent: AMERICAN TOWERS, LL | |) 468 - 0112 | | fail AE@AMERICANTOWER.COM | |
| Owned By: | ☐ Cit | y/County | X Private | | State | |
| Code Enforceme | _ | y | X County HAF | RNETT | State | |
| | _ | | | | | |
| CONTACT: | | - : | | | | |
| DESIGNER | FIRM | NAME | LICENSE# | TELEPHONE # | E-MAIL | |
| Architectural Civil | KIMLEY-HORN & ASSOCIATES, INC. | MICHAEL OGLESBY, PE | | () | MICHAEL OCLEODYSVIMIEV II | IODNI CO |
| Electrical | KIMILET-HORN & ASSOCIATES, INC. | WIICHAEL OGLESBY, PE | 039954 | (<u>919</u>) 677-2054 | MICHAEL.OGLESBY@KIMLEY-H | JORN.CO |
| Fire Alarm | | | | | | |
| Plumbing | | | | () | | |
| Mechanical | · | | | () | | |
| Sprinkler-Standp Structural | ipe | | | | | |
| Retaining Walls | >5' High | | | () | | |
| Other | | | | | | |
| ("Other" should | include firms and individu | als such as truss, pr | recast, pre-engine | ered, interior d | lesigners, etc.) | |
| 2018 NC BUILI | ☐ 1 st Tir ☐ Shell/ proced ☐ Phase | me Interior Comple | tion local inspection junts | t the local insp | possible additional ection jurisdiction for | |
| 2018 NC EXIST | ING BUILDING CODE | : EXISTIN | tive | Repair | Chapter 14 | |
| | | Alter | | Level II | Level III | |
| | | Alter | Astoric Proper | rty | ☐ Change of Use | |
| CONSTRU | CTED: (date) | ALTH | A OCCUPANC | Y(S) (Ch. 3): | | |
| RENOVAT | ED: (date)/ | / \ \ \ \ \ \ \ \ \ \ \ \ \ \ \ \ \ \ \ | ED OCCUPANO | CY(S) (Ch. 3): | | |
| RISK CATEGO | DRY (Table 1604.5): | sed: □ | = = | II □ IV II □ IV | | |
| | | | | | | |
| BASIC BUILDI | NG DATA | ~ | | | | |
| Construction Ty | | ∏ II-A | ☐ III-A | □IV | □ V-A | |
| (check all that ap | • = | □ II-B | ☐ III-B | _ | V-B | |
| Sprinklers: | ☐ No ☐ Partial ☐ Y | es | A 13 NFI | PA 13R 🔲 1 | NFPA 13D | |
| Standpipes: | ☐ No ☐ Yes Class | s 🗌 I 🔲 II | ☐ III ☐ Wes | t Dry | | |
| Fire District: | □ No □ Yes | Flood Hazard A | rea: No | Yes | | |
| Special Inspecti | ons Required: No | Yes (Contact th | e local inspection | jurisdiction fo | or additional | |
| | | procedure | s and requirement | <u>ts.)</u> | | |

2018 NC Administrative Code and Policies

| | | Gross Building Area Table | |
|--------------------------|---|---|---|
| FLOOR | EXISTING (SQ FT) | NEW (SQ FT) | SUB-TOTAL |
| 3 rd Floor | | | |
| 2 nd Floor | | 1 | F |
| Mezzanine | | | |
| 1st Floor | | | |
| Basement | | | |
| TOTAL | | | |
| | | ALLOWABLE AREA | |
| Primary Occup | | | e Select one Select one |
| Assembly | ☐ A-1 ☐ A-2 ☐ . | A-3 | |
| Business | | | |
| Educational | | ^ | |
| Factory | ☐ F-1 Moderate ☐ F | -2 Low | |
| Hazardous | ☐ H-1 Detonate ☐ H | -2 Low 1-2 Deflagrate H-3 C 2 2 2 2 R-3 S-7 gh-piled | 4 Health H-5 HPM |
| Institutional | I 🗌 I-1 Condition 🔲 1 | | \mathcal{O} / |
| | ☐ I-2 Condition ☐ 1 | | •/ |
| | ☐ I-3 Condition ☐ 1 | \Box^2 \Box / \triangleright \bigcirc / \triangle | 5 |
| | ☐ I-4 | | |
| Mercantile | | | |
| Residential | □ R-1 □ R-2 □ 1 | R-3 / | |
| Storage | S-1 Moderate | S-2 gh-piled | |
| | ☐ Parking Garage ☐ | | Barage |
| Utility and I | Miscellaneous | 7 | |
| Accessory Occu | ipancy Classification(s): | | |
| Incidental Uses | (Table 509): | | |
| Special Uses (C | hapter 4 – List Code Sec | etions): | |
| Special Provision | ons: (Chapter 5 – List Co | ode Sections): | |
| Mixed Occupar | ncy: No Y | es Separation: Hr. | Exception: |
| | n-Separated Use (508.3) - | | |
| ☐ Sep. | be su | | ch story, the area of the occupancy shall ne actual floor area of each use divided be shall not exceed 1. |
| | al Area of Occupancy A ble Area of Occupancy A | + <u>Actual Area of Occupa</u> Allowable Area of Occup | |
| | | | |

2018 NC Administrative Code and Policies





COA: F-0102 **421 FAYETTEVILLE ST, SUITE 600** RALEIGH, NC 27601

| REV | . DESCRIPTION | BY | DATE |
|---------------------|-------------------------|-----|----------|
| A | PRELIM | RG | 04/26/21 |
| \wedge | ISSUED FOR CONSTRUCTION | RG_ | 05/07/21 |
| \wedge | | | |
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| | | | |

ATC SITE NUMBER:

21278

ATC SITE NAME:

MCNEIL CEMETARY NC

T-MOBILE SITE NAME:

ATC CO MCNEIL CEMETARY

SITE ADDRESS: 14180 NC 210 SOUTH SPRING LAKE, NC, 28390



T · · Mobile ·

DATE DRAWN: 05/07/21 ATC JOB NO: XXXX CUSTOMER ID: ATC CO MCNEIL CEMETARY CUSTOMER #: 5RA0215A

DETAILED SITE PLAN

SHEET NUMBER:

REVISION: G-003

| STORY | DESCRIPTION AND | (A) | (B) | (C) | (D) |
|-------|-----------------|----------------|--------------------------|-------------------------|-----------------------------------|
| NO. | USE | BLDG AREA PER | TABLE 506.2 ⁴ | AREA FOR FRONTAGE | ALLOWABLE AREA PER |
| | | STORY (ACTUAL) | AREA | INCREASE ^{1,5} | STORY OR UNLIMITED ^{2,3} |
| | | | | | |
| | | | | | |
| | | | | | |
| | | | | | |

¹ Frontage area increases from Section 506.2 are computed thus:

| a. | Perimeter which fronts a | public way or open | space having 20 feet | minimum width = | (F) |
|----|--------------------------|--------------------|----------------------|-----------------|-----|

b. Total Building Perimeter

c. Ratio $(F/P) = ____(F/P)$

2018 NC Administrative Code and Policies

d. W = Minimum width of public way =

e. Percent of frontage increase $I_f = 100[F/P - 0.25] \times W/30 =$

² Unlimited area applicable under conditions of Section 507.

³ Maximum Building Area = total number of stories in the building x D (maximum3 stories) (506.2).

⁴ The maximum area of open parking garages must comply with Table 5.4. The maximum area of air traffic control towers must comply with Table 412.3.1.

BUILDING ⁵ Frontage increase is based on the unsprinklered area value in Tab ALLOWABY SHOWN ON PLANS CODE REFERENCE Building Height in Feet (Table 504.3) Building Height in Stories (Table 504.4) Provide code reference if the "Shown on Plans" qua able 504.3 or 504.4.

FIRE PROTECTION REQUIREMENTS

| BUILDING ELEMENT | FIRE | | RATING | DETAIL# | DESIGN# | SHEET # FOR | SHEET # |
|--|----------------------------|---------|--------------------------|----------------|--------------------------|-------------------|------------------------|
| BOLDING ELEVIENT | SEPARATION DISTANCE (FEET) | REQ'D | PROVIDED (W/* REDUCTION) | AND SHEET # | FOR RATED ASSEMBLY | RATED PENETRATION | FOR RATED JOINTS |
| Structural Frame, | | | | | | | |
| including columns, girders, trusses | | | | | | | |
| Bearing Walls | | | | | | | |
| Exterior | | | | | | | |
| North | | | | | | | |
| East | | | | | | | |
| West | | | | | | | |
| South | | | | | | | |
| Interior | | | | | | | |
| Nonbearing Walls and Partitions | | | AND TABLE | | | | |
| Exterior walls | | | | | | | |
| North | | | | | | | |
| East | | | L/.~ , | \bigcirc | | | |
| West | | | | Y / | | | |
| South | | / | | | | | |
| Interior walls and partitions | | | | | | | |
| Floor Construction | | 7 | \ \ \ \ \ \ | | | | |
| Including supporting beams | | / | .0`/ | | | | |
| and joists | | \ \ \ \ | | | | | |
| Floor Ceiling Assembly | | | ` | | | | |
| Columns Supporting Floors | | | <u> </u> | | | | |
| Roof Construction, including supporting beams and joists | | | | | | | |
| Roof Ceiling Assembly | | | | | | | |
| Columns Supporting Roof | | | | | | | |
| Shaft Enclosures - Exit | | | | | | | |
| Shaft Enclosures - Other | | | | | | | |
| Corridor Separation | | | | | | | |
| Occupancy/Fire Barrier Separat | 1011 | | | | | | |
| Party/Fire Wall Separation | | | | | | | |
| Smoke Barrier Separation | | | | | | | |
| Smoke Partition Tenant/Dwelling Unit/ Sleeping Unit Separation | | | | | | | |
| | | | | | | | |
| Incidental Use Separation | | Щ | | | L | | |

* Indicate section number permitting reduction

2018 NC Administrative Code and Policies

AMERICAN TOWER®



COA: F-0102 **421 FAYETTEVILLE ST, SUITE 600** RALEIGH, NC 27601

| REV. | DESCRIPTION | BY | DATE |
|---------------------|-------------------------|-----------|----------|
| A. | PRELIM | RG | 04/26/21 |
| <u></u> | ISSUED FOR CONSTRUCTION | <u>RG</u> | 05/07/21 |
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ATC SITE NUMBER:

21278

ATC SITE NAME:

MCNEIL CEMETARY NC

T-MOBILE SITE NAME:

ATC CO MCNEIL CEMETARY

SITE ADDRESS: 14180 NC 210 SOUTH SPRING LAKE, NC, 28390

5/8/21 NGINER E

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Exp. 12/31/21

DATE DRAWN: 05/07/21 ATC JOB NO: XXXX CUSTOMER ID: ATC CO MCNEIL CEMETARY CUSTOMER #: 5RA0215A

DETAILED SITE PLAN

SHEET NUMBER:

REVISION: G-004

PERCENTAGE OF WALL OPENING CALCULATIONS

| FIRE SEPARATION DISTANCE (FEET) FROM PROPERTY LINES | Degree of openings Protection (Table 705.8) | Allowable area (%) | ACTUAL SHOWN ON PLANS (%) |
|---|---|-----------------------|---------------------------|
| | | | |
| | | | |
| | | | |

| | LIFE SAFETY SYSTEM REQUIREMENTS | | | | |
|---|--|--|--|--|--|
| Emergency Lighting: | □ No □ Yes | | | | |
| Exit Signs: | □ No □ Yes | | | | |
| Fire Alarm: | □ No □ Yes | | | | |
| Smoke Detection Systems: | □ No □ Yes □ Partial | | | | |
| Carbon Monoxide Detection: | | | | | |
| | | | | | |
| | LIFE SAFETY PLAN Il locations (Char line locations) | | | | |
| Life Safety Plan Sheet #: | LIFE SAFETY PLAY | | | | |
| Fire and/or smoke rated wa | Il locations (Char | | | | |
| Assumed and real property | line locations plan) | | | | |
| Exterior wall opening area | | | | | |
| | Occupancy Use for each area as it react that lead calculation (Table 1004.1.2) | | | | |
| Occupant loads for each are | $=$ \cdot | | | | |
| Exit access travel distances | | | | | |
| Common path of travel dist | rances (Tables 1006.2.1 & 1006.3.2(1)) | | | | |
| Dead end lengths (1020.4) | * *** | | | | |
| ☐ Clear exit widths for each € | xit door | | | | |
| ☐ Maximum calculated occup | pant load capacity each exit door can accommodate based on egress width (1005.3) | | | | |
| Actual occupant load for ea | ch exit door | | | | |
| A separate schematic plan is purposes of occupancy separate schematic plan is | ndicating where fire rated floor/ceiling and/or roof structure is provided for aration | | | | |
| Location of doors with pan | ic hardware (1010.1.10) | | | | |
| Location of doors with dela | yed egress locks and the amount of delay (1010.1.9.7) | | | | |
| Location of doors with electronic | tromagnetic egress locks (1010.1.9.9) | | | | |
| Location of doors equipped | with hold-open devices | | | | |
| ☐ Location of emergency esc | ape windows (1030) | | | | |
| ☐ The square footage of each | fire area (202) | | | | |
| ☐ The square footage of each | smoke compartment for Occupancy Classification I-2 (407.5) | | | | |
| ☐ Note any code exceptions of | or table notes that may have been utilized regarding the items above | | | | |

2018 NC Administrative Code and Policies

ACCESSIBLE DWELLING UNITS

(SECTION 1107)

| TOTAL | ACCESSIBLE | ACCESSIBLE | Түре А | Түре А | Түре В | TYPE B | TOTAL |
|-------|------------|------------|----------|----------|----------|----------|------------------|
| Units | Units | Units | Units | Units | Units | Units | ACCESSIBLE UNITS |
| | REQUIRED | Provided | REQUIRED | Provided | REQUIRED | PROVIDED | PROVIDED |
| | | | | | | | |

ACCESSIBLE PARKING (SECTION 1106)

| LOT OR PARKING | TOTAL # OF PARKING SPACES | | # OF ACCESSIBLE SPACES PROVIDED | | | | TOTAL# |
|-------------------|---------------------------|----------|---------------------------------|---|-------------|---------------------|----------------------|
| AREA | REQUIRED | PROVIDED | REGULAR WITH | VAN SPACES WITH | | | ACCESSIBLE |
| | | | 5' ACCESS AISLE | 132" ACCESS | 8' ACCE | ESS | PROVIDED |
| | | | | AISLE | AISLI | Е | |
| | | | | | | | |
| | | | | | | | |
| TOTAL | | | / | $\mathcal{I} = \mathcal{L}_2 \mathcal{I}$ | | | |
| | | | | ~~~ | | | |
| | | | | \\\-_ | | | |
| | | | | | | | |
| <u> </u> | | PLUMRING | E FIXT | MENTS | | | |
| | | PLUMBING | G FIXT ZIP | EMENTS | : | | |
| | | PLUMBING | GFIXT NA. | MENTS | | | |
| USE | WATERC | | / ~ · | EMENTS | SHOWERS | DRINKING | FOUNTAINS |
| USE | WATERO MALE FEMA | LOSETS | | | | DRINKING REGULAR | FOUNTAINS ACCESSIBLE |
| USE SPACE EXIST'G | | LOSETS | | AVATORIES | SHOWERS | | |
| | | LOSETS | | AVATORIES | SHOWERS | | |

SPECIAL APPROVALS

Special approval: (Local Jurisdiction, Department of Insurance, OSC, DPI, DHHS, etc., describe below)

2018 NC Administrative Code and Policies





COA: F-0102 **421 FAYETTEVILLE ST, SUITE 600** RALEIGH, NC 27601

| EV. | DESCRIPTION | BY | DATE |
|------------------------|-------------------------|----|----------|
| Â. | PRELIM | RG | 04/26/21 |
| 6 | ISSUED FOR CONSTRUCTION | RG | 05/07/21 |
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| $\overline{\wedge}$ | | | |
| | | | |

ATC SITE NUMBER:

21278

ATC SITE NAME:

MCNEIL CEMETARY NC

T-MOBILE SITE NAME:

ATC CO MCNEIL CEMETARY

SITE ADDRESS: 14180 NC 210 SOUTH SPRING LAKE, NC, 28390



DATE DRAWN: 05/07/21 ATC JOB NO: XXXX CUSTOMER ID: ATC CO MCNEIL CEMETARY CUSTOMER #: 5RA0215A

DETAILED SITE PLAN

SHEET NUMBER:

G-005

ENERGY SUMMARY

ENERGY REQUIREMENTS:

The following data shall be considered minimum and any special attribute required to meet the energy code shall also be provided. Each Designer shall furnish the required portions of the project information for the plan data sheet. If performance method, state the annual energy cost for the standard reference design vs annual energy cost for the proposed design.

| Existing building envelope complies with code: No Yes (The remainder of this section is not applicable) |
|--|
| Exempt Building: No Yes (Provide code or statutory reference): |
| Climate Zone: 3A 4A 5A |
| Method of Compliance: Energy Code Performance Prescriptive ASHRAE 90.1 Performance Prescriptive (If "Other" specify source here |
| THERMAL ENVELOPE (Prescriptive method only) |
| ASHRAE 90.1 Performance (If "Other" specify source here THERMAL ENVELOPE (Prescriptive method only) Roof/ceiling Assembly (each assembly) Description of assembly: U-Value of total assembly: R-Value of insulation: Skylights in each assembly: U-Value of skylights in each assembly: U-Value of skylights in each assembly: |
| Exterior Walls (each assembly) |
| Description of assembly: U-Value of total assembly: R-Value of insulation: Openings (windows or doors with glazing) U-Value of assembly: Solar heat gain coefficient: projection factor: Door R-Values: |
| Walls below grade (each assembly) |
| Description of assembly: U-Value of total assembly: R-Value of insulation: |
| Floors over unconditioned space (each assembly) |
| Description of assembly: U-Value of total assembly: R-Value of insulation: |
| Floors slab on grade |
| Description of assembly: U-Value of total assembly: R-Value of insulation: Horizontal/vertical requirement: slab heated: |

2018 NC Administrative Code and Policies 2018 NC Administrative Code and Policies

2018 APPENDIX B BUILDING CODE SUMMARY FOR ALL COMMERCIAL PROJECTS STRUCTURAL DESIGN

(PROVIDE ON THE STRUCTURAL SHEETS IF APPLICABLE)

| DESIGN LOADS: | , |
|---|---|
| Importance Factors: | Snow (I _S) Seismic (I _E) |
| Live Loads: | Roof psf Mezzanine psf Floor psf |
| Ground Snow Load: | psf |
| | asic Wind Speed my CE-7) xposure Category |
| SEISMIC DESIGN CATEGOR Provide the following Seismic Do Risk Category (Table 1 Spectral Response Acc | esign Parameters: 604.5) I IV eleration S S S M |
| Site Classification (ASC Data Sc Basic structural system | Durce: Presumptive Historical Data Dual w/Special Moment Frame Dual w/Intermediate R/C or Special Steel Moment Frame Inverted Pendulum |
| Analysis Procedure: | ☐ Simplified ☐ Equivalent Lateral Force ☐ Dynamic |
| Architectural, Mechan | ical, Components anchored? Yes No |
| LATERAL DESIGN CONTRO | DL: Earthquake Wind |
| Field Test (provide copy Presumptive Bearing cap Pile size, type, and capa | of test report)psf pacitypsf |





COA: F-0102 421 FAYETTEVILLE ST, SUITE 600 RALEIGH, NC 27601

| BY | DATE |
|------|----------|
| RG | 04/26/21 |
| N RG | 05/07/21 |
| | |
| | |
| | |
| | RG |

ATC SITE NUMBER:

21278

ATC SITE NAME:

MCNEIL CEMETARY NC

T-MOBILE SITE NAME:

ATC CO MCNEIL CEMETARY

SITE ADDRESS: 14180 NC 210 SOUTH SPRING LAKE, NC, 28390

SEAL



T··Mobile

DATE DRAWN: 05/07/21
ATC JOB NO: XXXX

CUSTOMER ID: ATC CO MCNEIL CEMETARY

CUSTOMER #: 5RA0215A

DETAILED SITE PLAN

SHEET NUMBER:

REVISION:

2018 APPENDIX B BUILDING CODE SUMMARY FOR ALL COMMERCIAL PROJECTS

MECHANICAL DESIGN (PROVIDE ON THE MECHANICAL SHEETS IF APPLICABLE)

MECHANICAL SUMMARY

MECHANICAL SYSTEMS, SERVICE SYSTEMS AND EQUIPMENT

| Thermal Zone | |
|--|---------|
| winter dry bulb:summer dry bulb: | |
| Interior design conditions | |
| winter dry bulb: summer dry bulb: relative humidity: Building heating load: Building cooling load: | ر رو |
| Building heating load: | |
| Building cooling load: | |
| Mechanical Spacing Conditioning Sys | |
| Unitary | |
| description of unit: | |
| heating efficiency: | |
| cooling efficiency: size category of unit: | |
| Boiler | |
| Size category. If oversized, state reason.: | |
| Chiller | |
| Size category. If oversized, state reason.: | |
| | |

List equipment efficiencies:

2018 NC Administrative Code and Policies 2018 NC Administrative Code and Policies

2018 APPENDIX B BUILDING CODE SUMMARY FOR ALL COMMERCIAL PROJECTS ELECTRICAL DESIGN

(PROVIDE ON THE ELECTRICAL SHEETS IF APPLICABLE)

ELECTRICAL SUMMARY

| ELECTRICAL | SYSTEM AND | EQUIPMENT |
|------------|------------|-----------|
| | | |

| Method of Compliance: Energy Code ☐ Performance ASHRAE 90.1 ☐ Performance | ☐ Prescriptive ☐ Prescriptive |
|---|-------------------------------|
| Lighting schedule (each fixture type) | |
| lamp type required in fixture number of lamps in fixture ballast type used in the fixture number of ballasts in fixture total wattage per fixture total interior wattage specified vs. allowed total exterior wattage specified vs. allow | or space by space) |
| Additional Efficiency Package Options | , |
| | 2 90.1) |
| _ / / | mance |
| C406.3 Reduced Light / vy C406.4 Enhanced Dig | |
| C406.4 Elmanced Dig | |
| C406.6 Dedicated Outdoor A System | |
| C406.7 Reduced Energy Use in Service Water He | eating |





COA: F-0102 421 FAYETTEVILLE ST, SUITE 600 RALEIGH, NC 27601

| 26/21 |
|-------|
| 7/21 |
| |
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| |

ATC SITE NUMBER:

21278

ATC SITE NAME:


MCNEIL CEMETARY NC

T-MOBILE SITE NAME:

ATC CO MCNEIL CEMETARY

SITE ADDRESS: 14180 NC 210 SOUTH SPRING LAKE, NC, 28390

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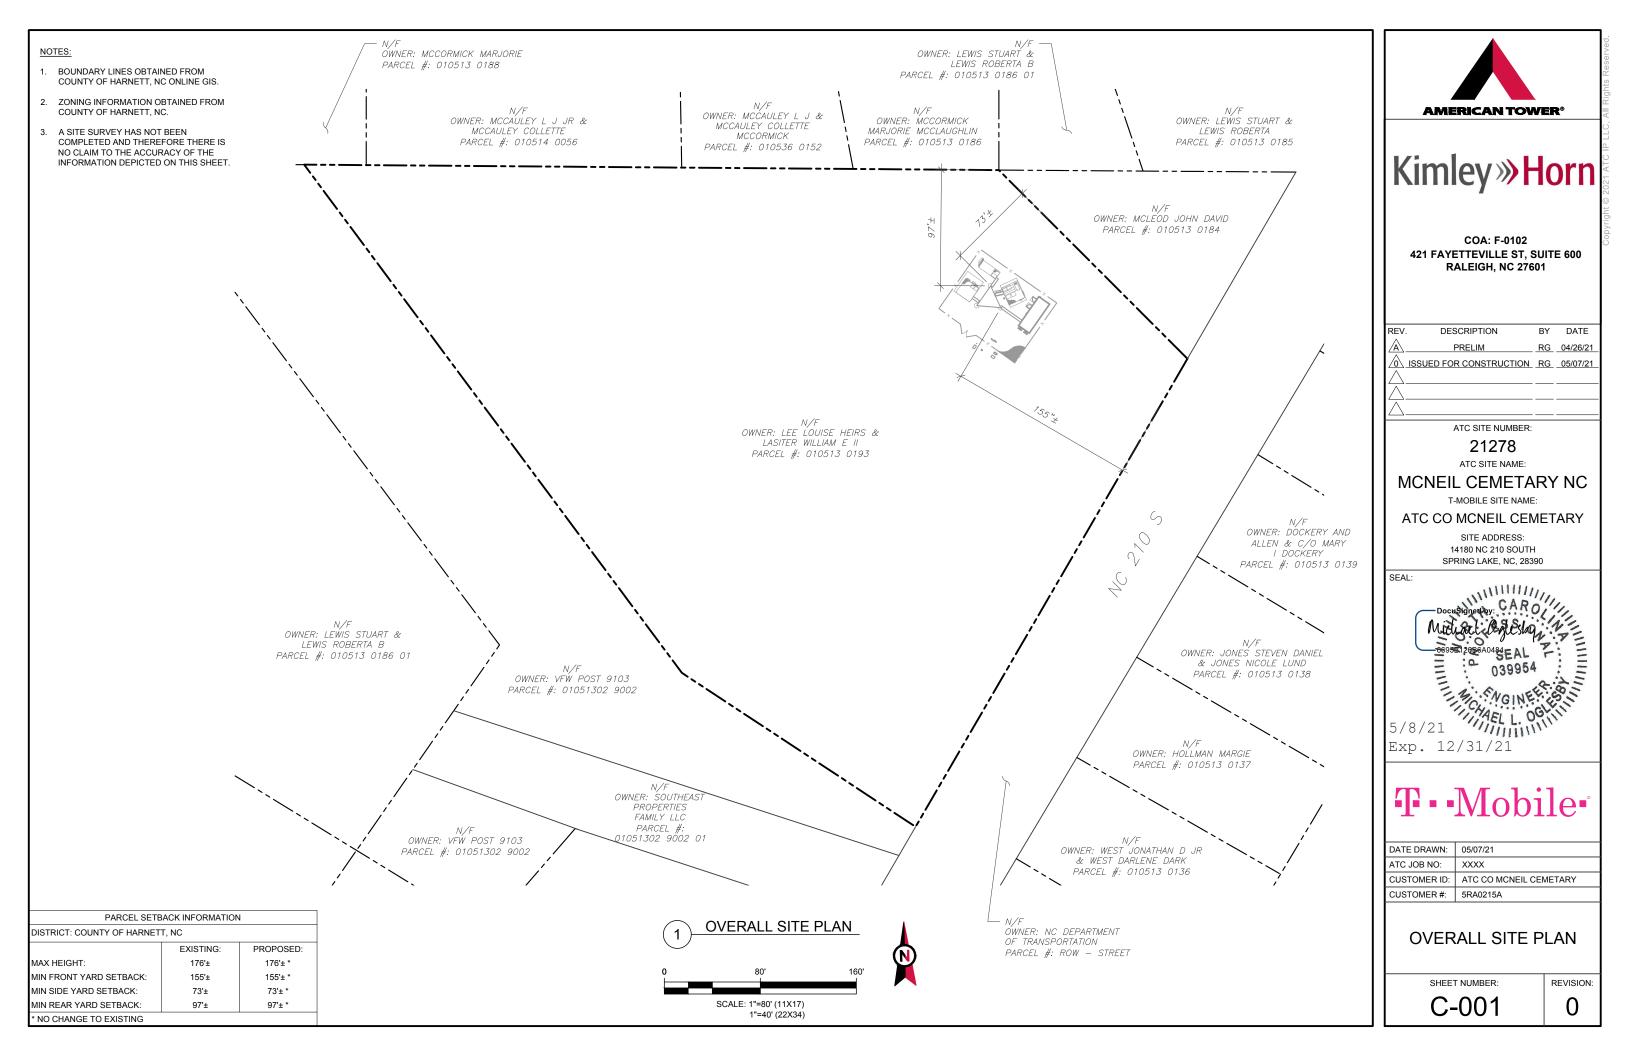
| ı | | DATE DRAWN: | 05/07/21 |
|---|--|--------------|------------------------|
| ı | | ATC JOB NO: | XXXX |
| | | CUSTOMER ID: | ATC CO MCNEIL CEMETARY |
| | | CUSTOMER #: | 5RA0215A |

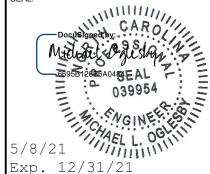DETAILED SITE PLAN

SHEET NUMBER:

REVISION:

G-007



SITE PLAN NOTES:

THIS SITE PLAN REPRESENTS THE BEST PRESENT KNOWLEDGE AVAILABLE TO THE ENGINEER AT THE TIME OF THIS DESIGN. THE CONTRACTOR SHALL VISIT THE SITE PRIOR TO CONSTRUCTION AND VERIFY ALL EXISTING CONDITIONS RELATED TO THE SCOPE OF WORK FOR THIS PROJECT. ICE BRIDGE, CABLE LADDER, COAX PORT, AND COAX CABLE ARE SHOWN FOR REFERENCE ONLY, CONTRACTOR SHALL CONFIRM THE EXACT LOCATION OF ALL

PROPOSED AND EXISTING EQUIPMENT AND STRUCTURES DEPICTED ON THIS PLAN. BEFORE UTILIZING EXISTING CABLE SUPPORTS, COAX PORTS, INSTALLING NEW

PORTS OR ANY OTHER EQUIPMENT, CONTRACTOR SHALL VERIFY ALL ASPECTS OF THE COMPONENTS MEET THE ATC SPECIFICATIONS.

NO ELECTRICAL SCOPE IS INCLUDED IN THIS PROJECT.

LEGEND

⊗ GROUNDING TEST WELL ATS AUTOMATIC TRANSFER SWITCH **BOLLARD** CSC CELL SITE CABINET D DISCONNECT ELECTRICAL **FIBER** GEN **GENERATOR** GENERATOR RECEPTACAL HH, V HAND HOLE, VAULT ΙB ICE BRIDGE KENTROX BOX LC LIGHTING CONTROL M METER PΒ PULL BOX


POWER POLE

TRANSFORMER CHAINLINK FENCE

TELCO.

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TRN

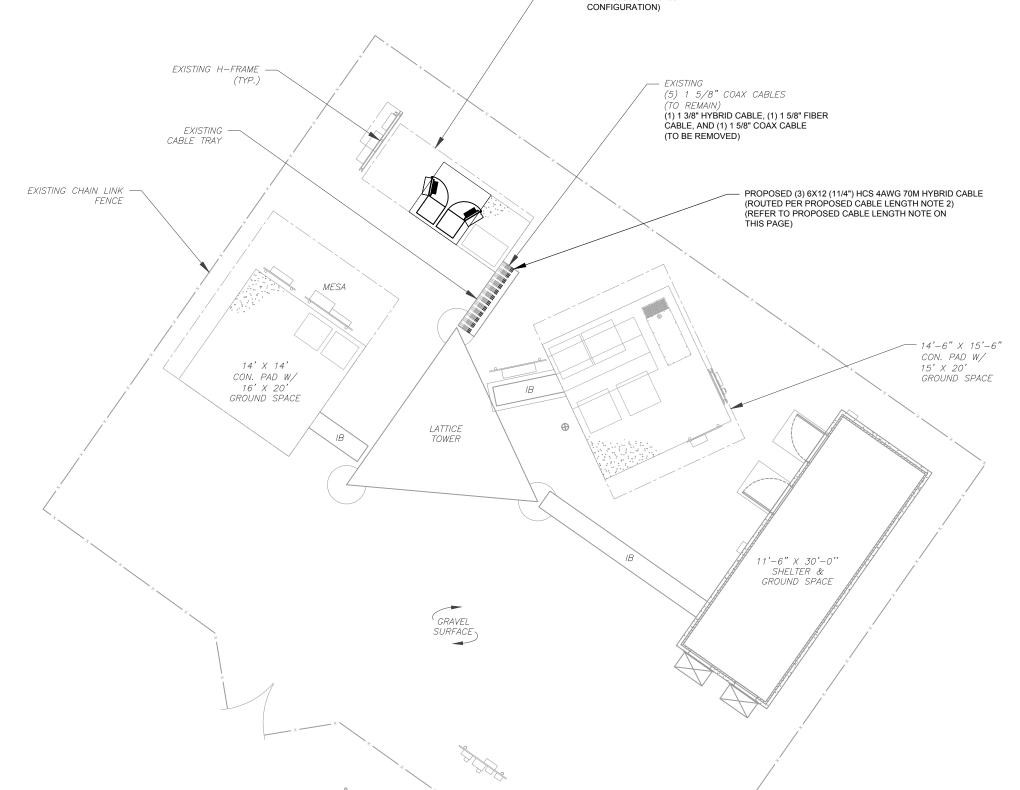

EXISTING T-MOBILE EQUIPMENT

W/ 7' X 17' GROUND SPACE (MODIFIED AS REQUIRED FOR


UPGRADE FROM 67D94G TO

67D5A998C ODE+6160

ON A 5'-0" X 6'-4" CON. PAD

PROPOSED CABLE LENGTH:

- ESTIMATED LENGTH OF PROPOSED CABLE IS 199'. ESTIMATED LENGTH OF CABLE WAS PROVIDED BY CUSTOMER OR CALCULATED BY ADDING THE RAD CENTER AND THE DISTANCE FROM THE SHELTER ENTRY PLATE TO THE TOWER (ALONG THE ICE BRIDGE) AND A SAFETY FACTOR MEASUREMENT OF 15% (OF THE TWO PREVIOUS VALUES), CDS DEFER TO GREATEST CABLE LENGTH.
- ROUTE PROPOSED CABLES ALONG SAME PATH AS EXISTING CABLES AND IN ACCORDANCE WITH STRUCTURAL ANALYSIS. WHERE POSSIBLE UTILIZE EXISTING CABLE SUPPORT STRUCTURES AS PROVIDED FOR CARRIER TO ADEQUATELY SECURE CABLES, USING EITHER APPROPRIATELY SIZED STAINLESS STEEL SNAP-INS OR MOUNTING HARDWARE AND BRACKETS AS SPECIFIED BY CABLE MANUFACTURER. OTHERWISE, ATTACH CABLES TO HORIZONTAL OR DIAGONAL TOWER MEMBERS USING PROPOSED STAINLESS STEEL ADAPTERS (DO NOT ATTACH TO TOWER LEG)

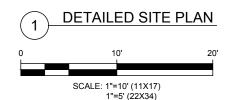







COA: F-0102 **421 FAYETTEVILLE ST. SUITE 600** RALEIGH, NC 27601

| REV | . DESCRIPTION | BY | DATE |
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| A | PRELIM | RG | 04/26/21 |
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| <u> </u> | | | |

ATC SITE NUMBER:

21278


ATC SITE NAME:

MCNEIL CEMETARY NC

T-MOBILE SITE NAME:

ATC CO MCNEIL CEMETARY

SITE ADDRESS: 14180 NC 210 SOUTH SPRING LAKE, NC. 28390

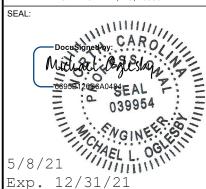


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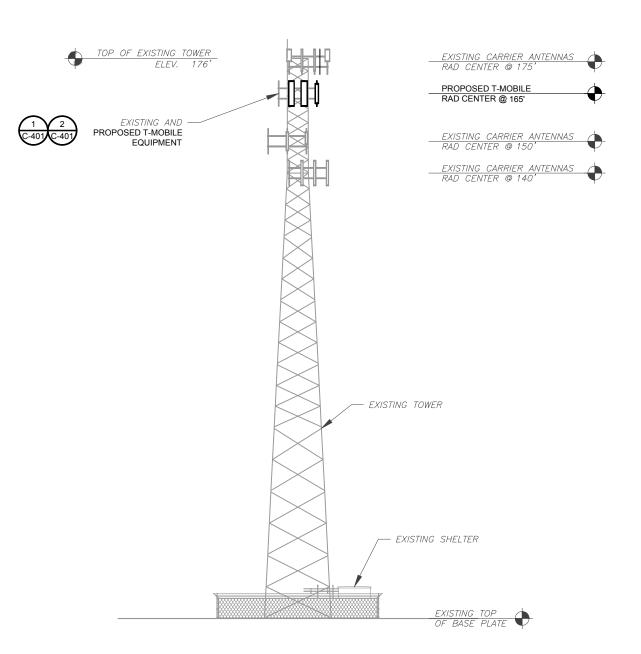
| DATE DRAWN: | 05/07/21 |
|--------------|------------------------|
| ATC JOB NO: | xxxx |
| CUSTOMER ID: | ATC CO MCNEIL CEMETARY |
| CUSTOMER #: | 5RA0215A |

DETAILED SITE PLAN

SHEET NUMBER:

C-101



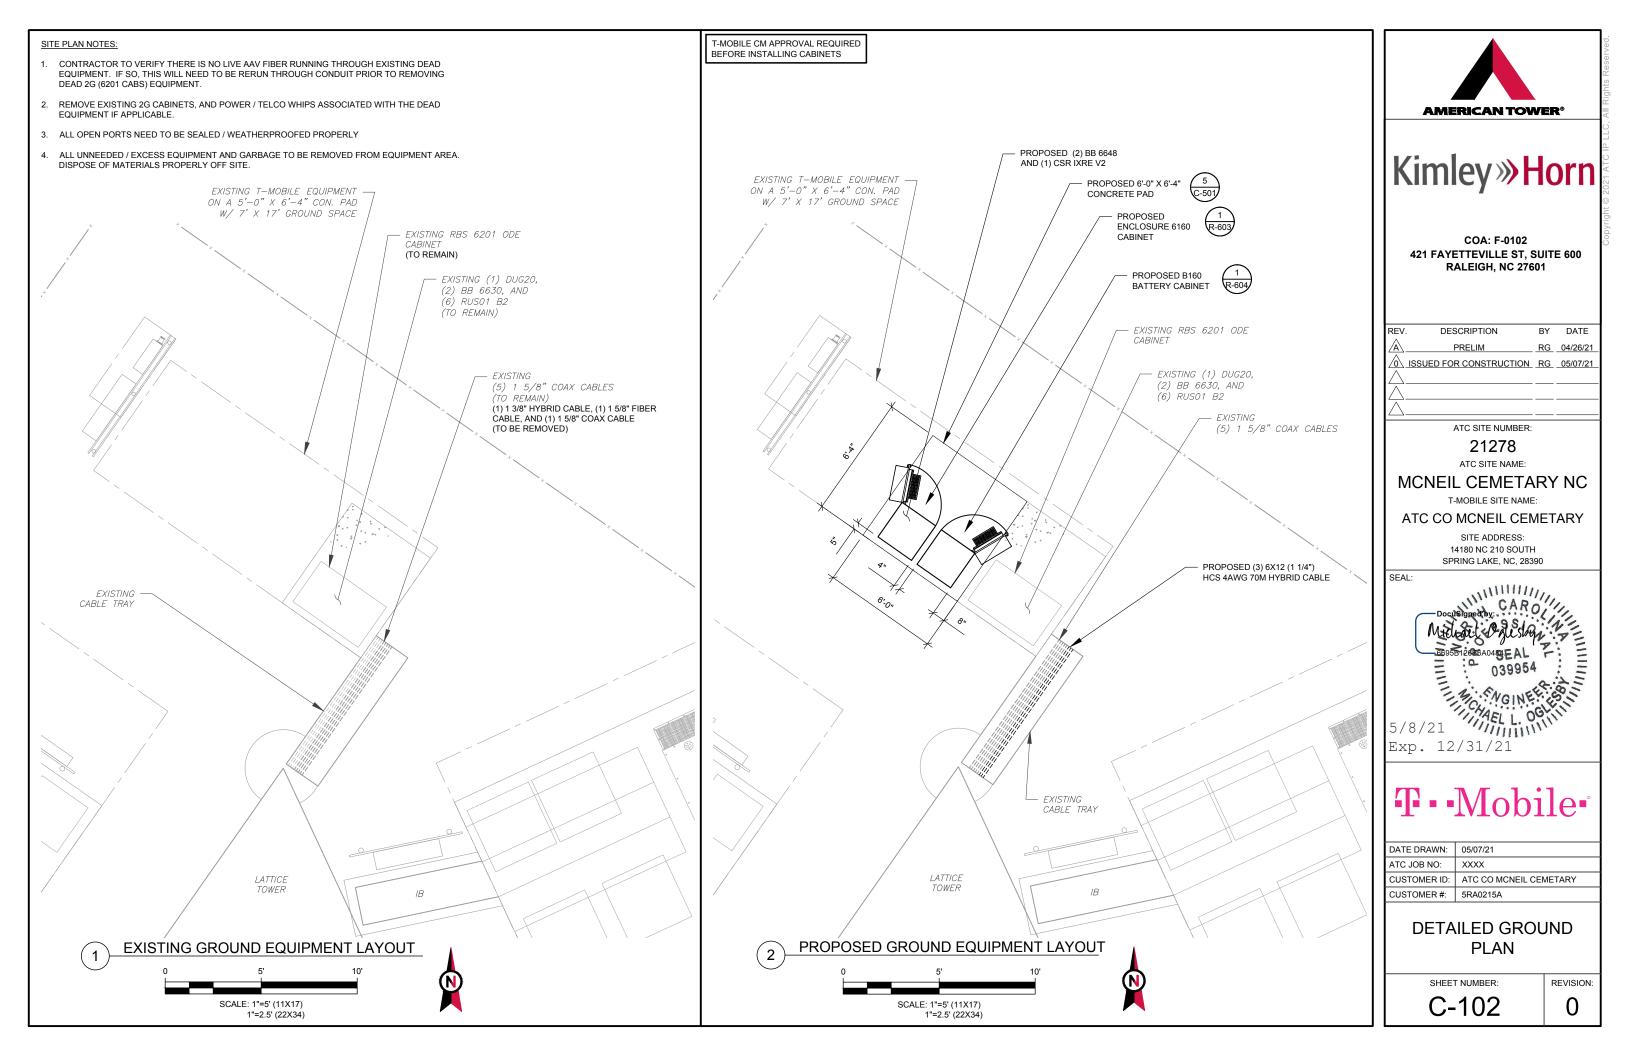

TOWER ELEVATION

SCALE: N.T.S.

ATC IS ANALYZING THE ANTENNA MOUNT UNDER A SEPARATE PROJECT. CONSTRUCTION IS NOT TO PROCEED UNTIL THE MOUNT ANALYSIS IS COMPLETE AND INDICATES THE ADDITIONAL LOADING DOES NOT OVERSTRESS THE MOUNT.

- TOWER NOTE:

 1. IT IS THE CONTRACTOR'S RESPONSIBILITY TO CONFIRM WITH THE PROJECT MANAGER THAT THEY HAVE THE MOST RECENT VERSION OF THE STRUCTURAL ANALYSIS BEFORE COMMENCING WORK. EXISTING AND PROPOSED TOWER APPURTENANCES, MOUNTS, AND ANTENNAS ARE SHOWN BASED ON THE STRUCTURAL ANALYSIS.
- 2. WHERE APPLICABLE, ALL NEW ANTENNAS, EQUIPMENT, MOUNTS, CABLING, ETC. SHALL BE PAINTED/SOCKED TO MATCH EXISTING EQUIPMENT IN ACCORDANCE WITH FAA, JURISDICTION, AND/OR OTHER LOCAL REQUIREMENTS.
- ROUTE PROPOSED CABLES ALONG SAME PATH AS EXISTING CABLES AND IN ACCORDANCE WITH STRUCTURAL ANALYSIS. WHERE POSSIBLE UTILIZE EXISTING CABLE SUPPORT STRUCTURES AS PROVIDED FOR CARRIER TO ADEQUATELY SECURE CABLES, USING EITHER APPROPRIATELY SIZED STAINLESS STEEL SNAP-INS OR MOUNTING HARDWARE AND BRACKETS AS SPECIFIED BY CABLE MANUFACTURER. OTHERWISE, ATTACH CABLES TO HORIZONTAL OR DIAGONAL TOWER MEMBERS USING PROPOSED STAINLESS STEEL ADAPTERS (DO NOT ATTACH TO TOWER LEG).
- 4. TOWER ELEVATIONS ARE MEASURED FROM TOP OF BASE PLATE TO MATCH STRUCTURAL ANALYSIS. ELEVATIONS DO NOT REFLECT TRUE ABOVE GROUND LEVEL (A.G.L.)





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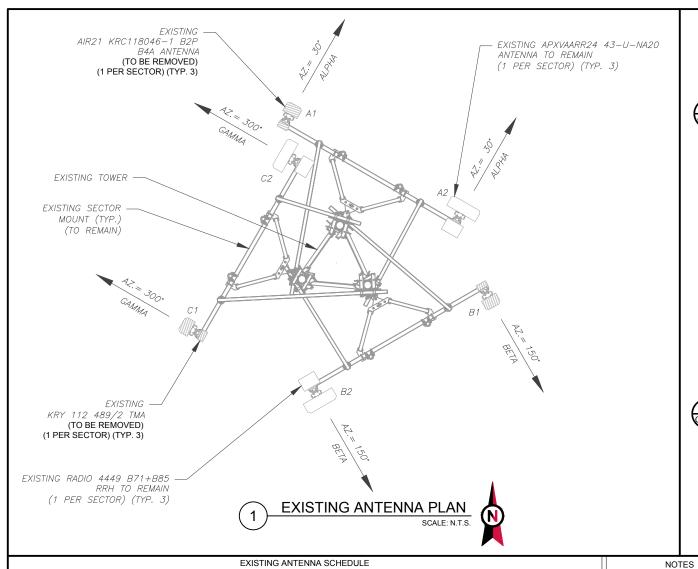
| | | DATE DRAWN: | 05/07/21 |
|---|-------------|--------------|------------------------|
| | | ATC JOB NO: | xxxx |
| | | CUSTOMER ID: | ATC CO MCNEIL CEMETARY |
| L | CUSTOMER #: | 5RA0215A | |


TOWER ELEVATION

SHEET NUMBER:

REVISION:

C-201



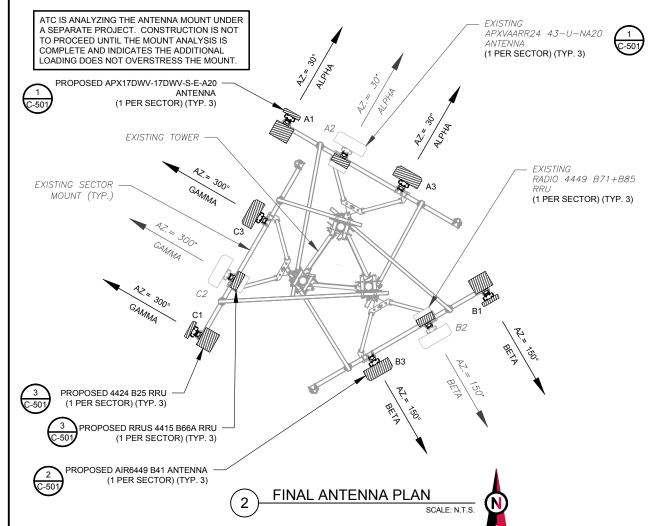

| | | | | E | EXISTING ANTENNA SCH | HEDULE | | | | Π |
|-----------|---|------|------------------------------------|--------------------------------|--------------------------|--------|-----|--------------------|-----|---|
| LOC | LOCATION ANTENNA SUMMARY NON ANTENNA SUMMARY 1. | | | | | | | | | |
| SECTOR | TOR RAD AZ POS ANTENNA BAND MECH/ELEC D-TILT STATUS | | ADDITIONAL TOWER MOUNTED EQUIPMENT | STATUS | | | | | | |
| AL DUA | 165' | 30° | A1 | AIR21 KRC118046-1 B2P-B4 | L2100/L1900/ G1900 | 0* | RMV | KRY 112 489/2 | RMV | |
| ALPHA | 163 | 30 | A2 | <i>APXVAARR24</i> 43-U-NA20 | L600/N600/L700/ L2100 | 0° | RMN | RADIO 4449 B71+B85 | RMN | |
| DETA | 105 | 150° | B1 | AIR21 KRC118046-1 B2P-B4 | L2100/L1900/ G1900 | 0* | RMV | KRY 112 489/2 | RMV | |
| BETA 165' | | 130 | B2 | <i>APXVAARR24</i> 43-U-NA20 | L600/N600/L700/ L2100 | 0* | RMN | RADIO 4449 B71+B85 | RMN | _ |
| CAMMA | 105' | 300° | C1 | AIR21 KRC118046-1 B2P-B4 | L2100/L1900/ G1900 | 0° | RMV | KRY 112 489/2 | RMV | |
| GAMMA | 165' | 300 | C2 | <i>APXVAARR24</i> 43-U-NA20 | L600/N600/L700/ L2100 | 0° | RMN | RADIO 4449 B71+B85 | RMN | |

| CONFIRM WITH T-MOBILE REP | LO | CATIO |
|--|--------|-------|
| FOR APPLICABLE UPDATES/REVISIONS AND MOST RECENT RFDS FOR NSN | SECTOR | RAD |
| CONFIGURATION (CONFIG). GC TO CAP ALL UNUSED PORTS. 2. CONFIRM SPACING OF PROPOSED EQUIP DOES NOT CAUSE TOWER CONFLICTS NOR IMPEDE TOWER CLIMBING | ALPHA | 165' |
| STATUS ABBREVIATIONS RMV: TO BE REMOVED | BETA | 165' |
| RMW: TO BE REMOVED RMM: TO REMAIN REL: TO BE RELOCATED ADD: TO BE ADDED | GAMMA | 165' |

| | SECTOR | RAD | AZ | POS | ANTENNA | BAND | MECH/ELEC D-TILT | STATUS | ADDITIONAL TOWER MOUNTED EQUIPMENT | STATUS | | | | | | | | | | | | | | | | | | |
|---|--------|------|----------|-----|----------------------------|--------------------------|---------------------|--------|---|------------|--|--|--|--|--|--|--|--|--|--|--|----|----------------------------|-------------|----|-----|----------------|-----|
| : | | | | A1 | APX17DWV-17DWV-S-E- A20 | L1900/G1900 | 0° | ADD | RADIO 4424 B25 | ADD | | | | | | | | | | | | | | | | | | |
| | ALPHA | 165' | 30° | A2 | APXVAARR24 43-U-NA20 | L600/N600/L700/ L2100 | 0° | RMN | RRUS 4415 B66 <i>RADIO 4449 B71+B85</i> | ADD RMN | | | | | | | | | | | | | | | | | | |
| ; | | | | A3 | AIR6449 B41 | L2500/N2500 | 0° | ADD | = | - | | | | | | | | | | | | | | | | | | |
| | | | | B1 | APX17DWV-17DWV-S-E- A20 | L1900/G1900 | 0° | ADD | RADIO 4424 B25 | ADD | | | | | | | | | | | | | | | | | | |
| 1 | BETA | 165' | 150° | B2 | APXVAARR24 43-U-NA20 | L600/N600/L700/ L2100 | 0° | RMN | RRUS 4415 B66 RADIO 4449 B71+B85 | ADD RMN | | | | | | | | | | | | | | | | | | |
| | | | | В3 | AIR6449 B41 | L2500/N2500 | 0° | ADD | - | - | | | | | | | | | | | | | | | | | | |
| | | | 65' 300° | | | | | | | | | | | | | | | | | | | C1 | APX17DWV-17DWV-S-E- A20 | L1900/G1900 | 0° | ADD | RADIO 4424 B25 | ADD |
| | GAMMA | 165' | | C2 | APXVAARR24 43-U-NA20 | L600/N600/L700/ L2100 | 0° | RMN | RRUS 4415 B66 <i>RADIO 4449 B71+B85</i> | ADD RMN | | | | | | | | | | | | | | | | | | |
| | | i | | C3 | AIR6449 B41 | L2500/N2500 | 0° | ADD | - | - | | | | | | | | | | | | | | | | | | |

FINAL ANTENNA SCHEDULE

ANTENNA SUMMARY

CABLE LENGTHS FOR JUMPERS

JUNCTION BOX TO RRU: 15'

RRU TO ANTENNA: 10'

| EXISTING FIBER DISTRIBUTION/O | VP BOX | EXISTING CABLING SUMMARY | | | |
|-------------------------------|--------|--------------------------|--------------------------|------------|--|
| MODEL NUMBER | STATUS | COAX | HYBRID | STATUS | |
| - | - | (1) 1 5/8" (5) 1 5/8" | _ | RMV RMN | |
| - | - | _ | (1) 1 3/8" (1) 1 5/8" | RMV RMV | |

| \bigcirc | EQUIPMENT SCHEDULES |
|------------|---------------------|
| (3) | |

| FINAL FIBER DISTRIBUTION / OVE | P BOX | FINAL CABLING SUMMARY | | | |
|--------------------------------|--------|-----------------------|------------|--------|--|
| MODEL NUMBER | STATUS | COAX | HYBRID | STATUS | |
| - | - | (5) 1 5/8" | _ | RMN | |
| - | - | - | (3) 1 1/4" | ADD | |





COA: F-0102 421 FAYETTEVILLE ST, SUITE 600 RALEIGH, NC 27601

| REV. | DESCRIPTION | BY | DATE |
|------------------|------------------------|----|----------|
| \mathbb{A}_{-} | PRELIM | RG | 04/26/21 |
| <u> </u> | SSUED FOR CONSTRUCTION | RG | 05/07/21 |
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| \triangle_{-} | | | |
| \triangle_{-} | | | |

ATC SITE NUMBER:

21278

ATC SITE NAME:


MCNEIL CEMETARY NC

T-MOBILE SITE NAME:

ATC CO MCNEIL CEMETARY

NON ANTENNA SUMMARY

SITE ADDRESS: 14180 NC 210 SOUTH SPRING LAKE, NC, 28390

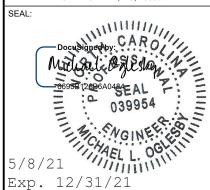


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| DATE DRAWN: | 05/07/21 |
|--------------|------------------------|
| ATC JOB NO: | XXXX |
| CUSTOMER ID: | ATC CO MCNEIL CEMETARY |
| CUSTOMER #: | 5RA0215A |


ANTENNA INFORMATION & SCHEDULE

SHEET NUMBER:

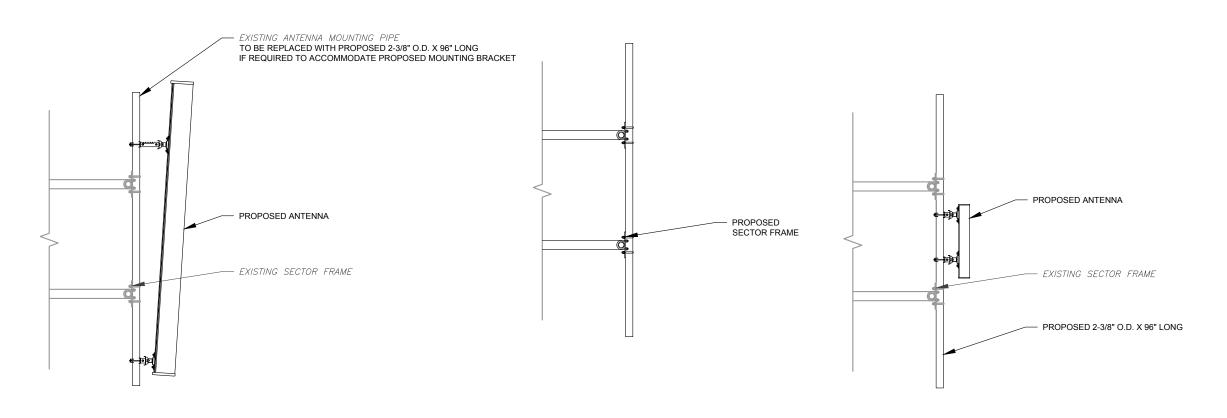

PROPOSED ANTENNA MOUNTING DETAIL - TYPICAL

PROPOSED 5G ANTENNA MOUNTING DETAIL - TYPICAL

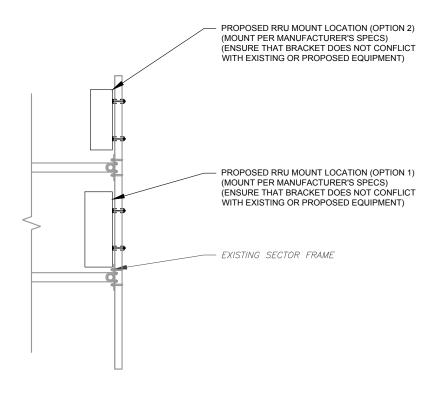

PROPOSED RRU MOUNTING DETAIL - TYPICAL

PROPOSED CABINET 10" THICK CONCRETE PAD PROPOSED 1/2" HILTI 3/4" CHAMFER OR TOOLED EDGE (AT MINIMUM MATCH EXISTING) #5 BARS AT 12" O.C. EACH WAY EXISTING CONCRETE PAD AGGREGATE BASE COURSE (ABC) CONCRETE PAD NOTES: NOTE: SHOULD EXISTING PAD EXCEED 12"

INSTALL HILTI KWIK BOLT ANCHORS STRICTLY PER INSTALLATION INSTRUCTIONS INCLUDED WITH PRODUCT OR FOUND ONLINE AT WWW.US.HILTI.COM. PROPER INSTALLATION IS CRITICAL FOR FULL PERFORMANCE

ALL BARS PERPENDICULAR TO EXISTING PAD TO BE DOWELED - INTO EXISTING CONCRETE WITH SIMPSON STRONG-TIE SET-XP EPOXY ADHESIVE (ICC ESR-2508). DOWELS TO BE CENTERED VERTICALLY IN EXISTING CONCRETE.

IN THICKNESS, CONTACT EOR. VERIFY EXACT PLACEMENT OF

EXISTING CONCRETE PAD. EXTEND PAD TO ACCOMMODATE PROPOSED CABINETS AS NEEDED.

CABINET ATTACHMENT DETAIL SCALE: NOT TO SCALE

CONCRETE PAD EXTENSION DETAIL

SCALE: NOT TO SCALE





COA: F-0102 **421 FAYETTEVILLE ST, SUITE 600** RALEIGH, NC 27601

| REV | . DESCRIPTION | BY | DATE |
|---------------------|-------------------------|----|----------|
| A | PRELIM | RG | 04/26/21 |
| \wedge | ISSUED FOR CONSTRUCTION | RG | 05/07/21 |
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ATC SITE NUMBER:

21278

ATC SITE NAME:

MCNEIL CEMETARY NC

T-MOBILE SITE NAME:

ATC CO MCNEIL CEMETARY

SITE ADDRESS: 14180 NC 210 SOUTH SPRING LAKE, NC. 28390

5/8/21

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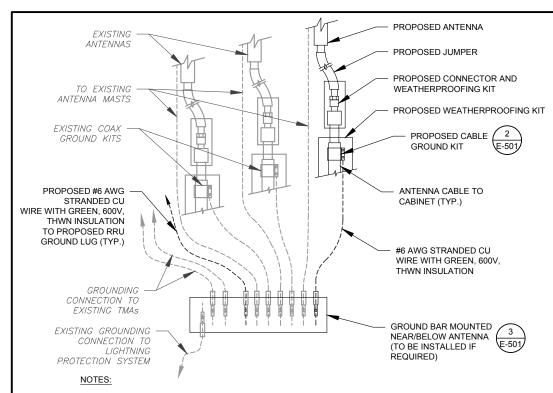
Exp. 12/31/21

| DATE DRAWN: | 05/07/21 |
|--------------|------------------------|
| ATC JOB NO: | xxxx |
| CUSTOMER ID: | ATC CO MCNEIL CEMETARY |
| CUSTOMER #: | 5RA0215A |

CONSTRUCTION **DETAILS**


SHEET NUMBER:

C-501



- 1. THIS DETAIL IS INTENDED TO SHOW THE GENERAL GROUNDING REQUIREMENTS. SLIGHT ADJUSTMENTS MAY BE REQUIRED BASED ON EXISTING SITE CONDITIONS. THE CONTRACTOR SHALL MAKE FIELD ADJUSTMENTS AS NEEDED AND INFORM THE CONSTRUCTION MANAGER OF ANY CONFLICTS.
- SITE GROUNDING SHALL COMPLY WITH T-MOBILE GROUNDING STANDARDS, LATEST EDITION, AND COMPLY WITH T-MOBILE GROUNDING CHECKLIST, LATEST VERSION. WHEN NATIONAL AND LOCAL GROUNDING CODES ARE MORE STRINGENT THEY SHALL GOVERN.



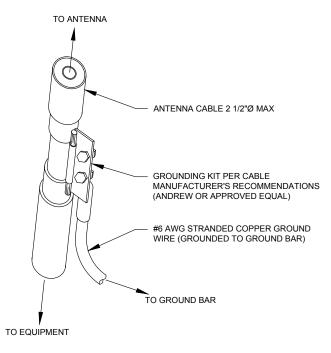

- GROUND KIT NOTES:


 1. DO NOT INSTALL CABLE GROUND KIT AT A BEND AND ALWAYS DIRECT GROUND WIRE DOWN TO GROUND BAR.
- 2. CONTRACTOR SHALL PROVIDE WEATHERPROOFING KIT (ANDREW PART NUMBER 221213) AND INSTALL/TAPE PER MANUFACTURER'S SPECIFICATIONS.



CABLE GROUND KIT CONNECTION DETAIL

- IT IS THE RESPONSIBILITY OF THE CONTRACTOR TO COORDINATE WITH THE T-MOBILE REPRESENTATIVE AND LOCAL UTILITY COMPANY FOR THE INSTALLATION OF CONDUITS, CONDUCTORS. BREAKERS, DISCONNECTS, OR ANY OTHER EQUIPMENT REQUIRED FOR ELECTRICAL SERVICE. ALL ELECTRICAL WORK SHALL BE PERFORMED IN ACCORDANCE WITH LATEST EDITION OF THE STATE AND NATIONAL CODES, ORDINANCES AND
- EQUIPMENT OR ELECTRICAL LOADING. PROPOSED WORK BASED ON INSTALLATION CONFIGURATION PROVIDED BY T-MOBILE. CONTRACTOR TO VERIFY EXISTING T-MOBILE PANEL HAS SUFFICIENT SPACE FOR PROPOSED BREAKER. PROPOSED CABLE AND CONDUIT SHALL BE MINIMUM SIZE PER BELOW IN CHART.
- REQUIREMENTS. THE T-MOBILE CONTRACTOR SHOULD REFERENCE DESIGN DOCUMENTS PROVIDED BY T-MOBILE FOR THIS CURRENT PROJECT CONFIGURATION, IN ACCORDANCE WITH LOCAL JURISDICTION REQUIREMENTS & NEC STANDARDS &


| OCPD SIZE | WIRE SIZE | GROUND SIZE | CONDUIT SIZE |
|-----------|-----------|-------------|--------------|
| 80A/2P | 2#3 AWG | #8 AWG | 1-1/4" |
| 100/2P | 2#2 AWG | #8 AWG | 1-1/4" |
| 125A/2P | 2#1 AWG | #8 AWG | 1-1/2" |
| 150A/2P | 2#1/0 AWG | #8 AWG | 1-1/2" |

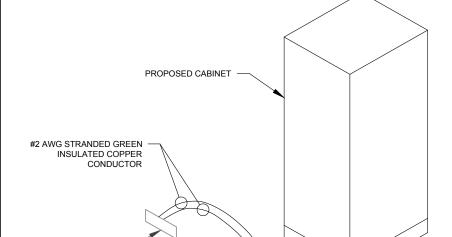

CABINET GROUNDING DETAIL

EXISTING SECTOR GROUND BAR (TYP.)

SCALE: N.T.S.

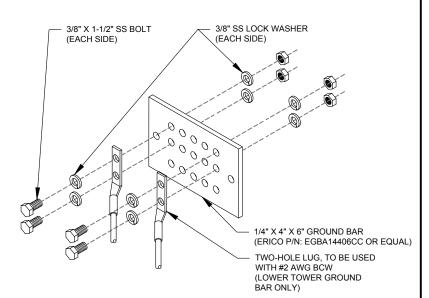

GROUND BAR NOTES:

- GROUND BAR KITS COME WITH ALL HARDWARE, NUTS, BOLTS, WASHERS, ETC. EXCEPT THE STRUCTURAL MOUNTING MEMBER(S).
- 2. GROUND BAR TO BE BONDED DIRECTLY TO TOWER.





Kimley » Horn

COA: F-0102 **421 FAYETTEVILLE ST. SUITE 600** RALEIGH, NC 27601

| | REV. | . DESCRIPTION | BY | DATE |
|---|-------------|-------------------------|----|----------|
| ı | A | PRELIM | RG | 04/26/21 |
| ı | <u> </u> | ISSUED FOR CONSTRUCTION | RG | 05/07/21 |
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ATC SITE NUMBER:

21278


ATC SITE NAME:

MCNEIL CEMETARY NC

T-MOBILE SITE NAME:

ATC CO MCNEIL CEMETARY

SITE ADDRESS: 14180 NC 210 SOUTH SPRING LAKE, NC. 28390

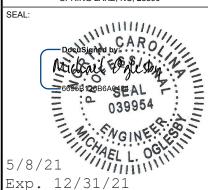




| DATE DRAWN: | 05/07/21 |
|--------------|------------------------|
| ATC JOB NO: | xxxx |
| CUSTOMER ID: | ATC CO MCNEIL CEMETARY |
| CUSTOMER #: | 5RA0215A |

GROUNDING DETAILS

SHEET NUMBER:

E-501

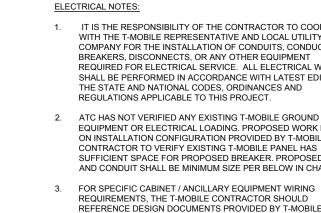

3/25/2021


5RA0215A_Anchor_9_2021-03-25

RAN Template: A&L Template: 67D5A998C_0DE+6160 67DS998C_1xAIR+1QP+1OP

5RA0215A_Anchor_9
Print Name: Standard
PORs: Anchor_Phase 3
Radio Upgrade_CMP4 AIR32

| | | Template: 67D5A998C ODE+6160 | |
|------------------------|---|---------------------------------|-------|
| Enclosure | 1 | 2 | 3 |
| Enclosure Type | (RBS 6201 ODE) | (Enclosure 6160) | B160 |
| Baseband | DUG20 BB 6630 BB 6630 L600 L2100 N600 | (BB 6648) (L2500) (N2500) | |
| Hybrid Cable System | (Ericsson 6x12 HCS 4AWG 70m (x 2)) (Ericsson 6x12 HCS 4AWG 60m) | (PSU 4813) | |
| Radio | (RUS01 B2 (x 6)) | | |
| Transport System | (CSR IXRe V2 (Gen2)) | | |
| RAN Scope of Worl | | | (144) |

1 CABINET CONFIGURATION
SCALE: NOT TO SCALE

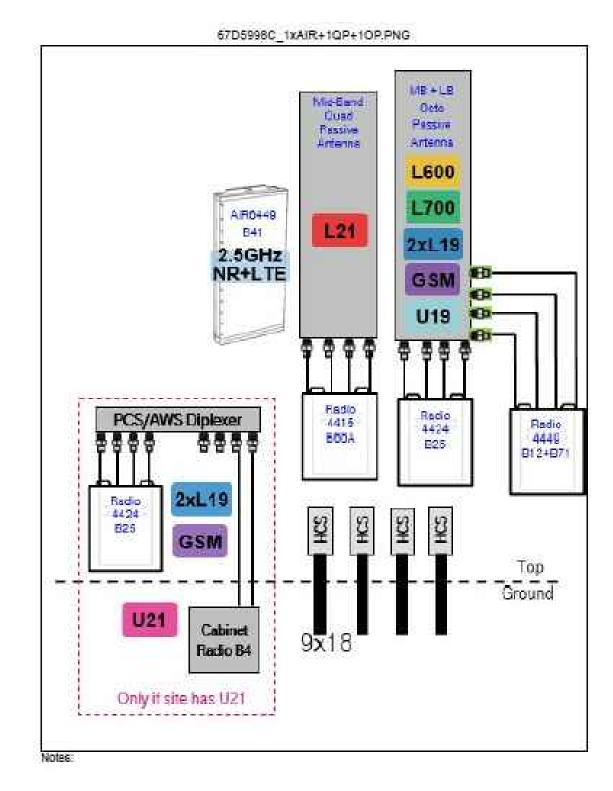


2 ANTENNA CONFIGURATION SCALE: NOT TO SCALE


NOTE: THIS SHEET CREATED BY OTHERS AND PROVIDED BY REQUEST OF CUSTOMER WITHOUT EDIT.

SUPPLEMENTAL

SHEET NUMBER:

R-601

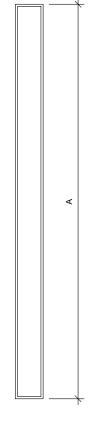


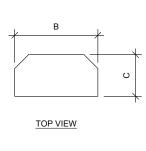

FRONT VIEW

1 ANTENNA SPECIFICATIONS FOR ILLUSTRATIVE PURPOSES ONLY - NOT TO SCALE

| ANTENNA SPECIFICATIONS | | | | | |
|------------------------|-------|-------|------|-----------------|--|
| ANTENNA MODEL | А | В | С | WEIGHT (LBS) | |
| APX17DWV-17DWVS-E-A20 | 75.8" | 13.3" | 3.1" | 39.6 | |
| AIR6449 B41 | 33.1" | 20.6" | 8.6" | 104.0 | |

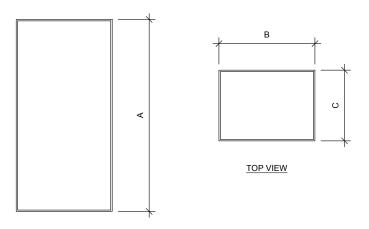

FRONT VIEW

RRU SPECIFICATIONS FOR ILLUSTRATIVE PURPOSES ONLY - NOT TO SCALE

| RRU SPECIFICATIONS | | | | | |
|--------------------|-------|-------|-------|-----------------|--|
| RRU MODEL | А | В | С | WEIGHT (LBS) | |
| 4424 B25 | 17.1" | 14.4" | 11.3" | 86 | |
| RRUS 4415 B66 | 15.0" | 13.2" | 5.4" | 46 | |

SUPPLEMENTAL

SHEET NUMBER:

BER: REVISION:

R-602



Enclosure 6160 AC

The Enclosure 6160 is a multi-purpose site cabinet designed to support a multitude of equipment such as ERS Baseband, Transport, Li-lon battery and 3PP vendor equipment. It also provides a highly capable power system and battery back-up - all in a streamlined design and minimized footprint to support cost efficient expansion of mobile broadband.

Being an all-in-one enclosure, the Enclosure 6160 is a very fitting choice for all types of sites where the capacity need is large or room for future expansion is needed. It is ideally used for modernizing existing sites or in greenfield scenarios to match both current and future needs.

With a robust design, IP65 compliance and a sealed Heat Exchanger (HEX) climate system the Enclosure 6160 ensures optimal environmental protection of the active equipment - enabling them for a long-lasting service. The complete system is also integrated and verified for the entire Ericsson Radio System and ensures best-in-class service.

The power system offers 31,5kW of power in total and provides 24kW of -48V DC power for both internal and external consumers.

The equipment space allows 19U of rack space ensuring well enough capacity for existing need and future expansion.

One of the main advantages of the Enclosure 6160 is its default integration with ENM - allowing for advanced remote monitoring and control such a fault management (alarms), inventory management and performance measurements. The cabinet also provides an open O&M interface for integration to 3PP O&M systems.



Preliminary technical specification for Enclosure 6160 AC CAPACITY 19U (19" rack) Rack space user equipment Hardware capabilities Power and CPRI support for multi-standard remote radios (RRU or AIR) ERS Baseband and Transport units Li-lon batteries 3PP equipment Additional power feed available as option MECHANICAL SPECIFICATION Weight 145 kg (excluding active equipment) 320 lbs (excluding active equipment) 1600 x 650 x 650 mm (incl. Base frame) Dimension (H x W x D) 63 x 26 x 26 in. (incl. Base frame) 150 mm Base frame height 6 in. Mounting position Ground Enclosure material Aluminum Color Power paint NCS 2002-B Door Front access Rack type 19" (IEC 60297-3-100) Locking type Pad lock or Cylinder POWER SYSTEM 3P+N+PE: 346/200-415/240 VAC Input voltage 2P+N+PE: 208/120-220/127 VAC 1P+N+PE: 200-250 VAC <33kW Input power 24kW Output load (-48VDC) Total capacity (-48VDC) 31.5kW AC SPD Class 2/Type 2 DC SPD Class 2/Type 2 9x PSU Slots Service outlet Optional Priority load 8x Circuit Breaker LLVD 1 6x Circuit Breaker LLVD 2 6x Circuit Breaker 3A / 5A / 10A / 15A / 20A / 25A / 30A / 40A / 50A / 60A / 80A / 100A CB ratings Battery Interface 2x Circuit Breaker Battery Circuit Breaker rating 125A 2pol (200A) PSU capacity 3500W


SUPPLEMENTAL


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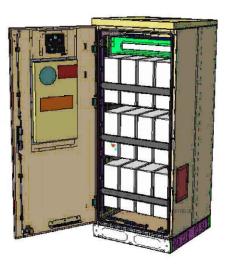
REVISION:

R-603


Enclosure B160



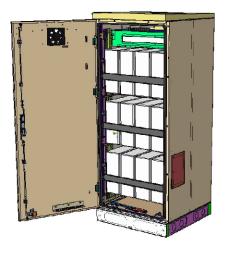

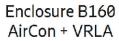

Enclosure B160 AirCon + Li-Ion

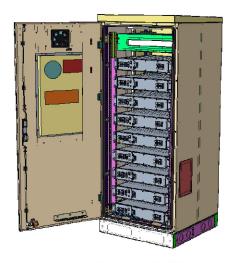

Enclosure B160 **Convection Cooling** + VRLA

3

PA1 | 2019-02-03 | Ericsson Confidential | Page 1

Enclosure B160

Capacity

100Ah / 150Ah / 170Ah / 190Ah / 210Ah — VRLA 12V:

— Li-Ion: 24U 19" / 23" 3x FIAMM — Sodium-Nickel:

Electrical specification

— DC Output: -48VDC/200A Battery breakers: 2x 125/2p

Door open, Climate failure, MCB Connection — Alarms:

Mechanical specification

— Weight: 134kg

63 x 26 x 26 in. (incl. Base frame) — Dimensions:

- Base frame height: 6 in.

Material: Galvanized steel (180g/m²) Powder paint NCS 2002-B Color:

Front access — Door: Pad lock / cylinder Locking type:

Environmental specification

VRLA/Sodium IP44 Ingress protection: Li-Ion IP55

 Relative humidity: 15-100%

Climate system

Air Conditioner

— Fan type: DC

 Cooling capacity: 500W @L35/L35

Convection cooling

Emergency fan

PA1 | 2019-02-03 | Ericsson Confidential | Page 2

SUPPLEMENTAL

SHEET NUMBER:

NOTE: THIS SHEET WAS CREATED BY OTHERS AND PROVIDED

R-604