

LOCATION MAP

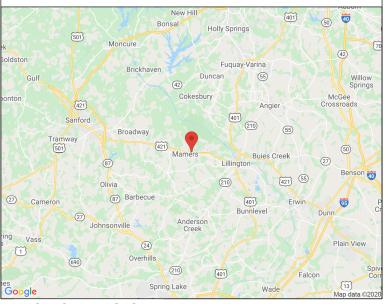

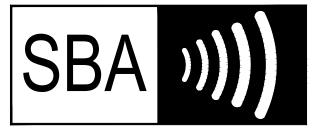

SITE NAME: MAMERS SITE NUMBER: NC40177-T

- Mobile SITE NUMBER: 5RA0821A DESCRIPTION: 67D5A97DB_B25

SITE NAME: L-SPRINT RA73XC047

SPRINT KEEP

190' RAD CENTER

-PROJECT DIRECTORY

APPLICATION/

PROPERTY OWNER: SBA COMMUNICATIONS CORPORATION

8051 CONGRESS AVE. BOCA RATON, FL 33487-2797 MACKENZIE CLIFFORD MCLIFFORD@SBASITE.COM 704.527.0003 x2106

ENGINEERING: P. MARSHALL & ASSOCIATES

3545 WHITEHALL PARK DRIVE SUITE 450 CHARLOTTE, NORTH CAROLINA 28273

TREVOR MCALLISTER TMCALLISTER@PMASS.COM

478-542-3291

CONSTRUCTION:

P. MARSHALL & ASSOCIATES 3545 WHITEHALL PARK DRIVE SUITE 450 CHARLOTTE, NORTH CAROLINA 28273

MARK MINTON

MMINTON@PMASS.COM

865-556-5283

-PROJECT SUMMARY -

SCOPE OF WORK

PROPOSED WORK WILL CONSIST OF PREPARATION AND INSTALLATION OF CELLULAR COMMUNICATION CARRIER EQUIPMENT, WHERE ALL WORK SHALL BE CONTAINED WITHIN COMPOUND & SHALL NOT ADVERSELY IMPACT THE SURROUNDING ADJACENT PARCELS. NO GRADING IS REQUIRED. NO NEW BUILDING BEING CONSTRUCTED, AND NO ELECTRICAL SERVICE UPGRADE IS REQUIRED. ALL PROPOSED CONSTRUCTION WILL BE CONTAINED WITHIN THE LIMITS OF THE EXISTING FENCED TELECOM COMPOUND OR WITHIN PROPOSED UTILITY EASEMENT. WORK WILL INCLUDE, BUT NOT LIMITED TO; ANTENNA SWAP & INSTALL, MOUNT WORK, CABLE REMOVAL/ INSTALLATION, AND CABINET INSTALLATION WITHIN EXISTING EQUIPMENT LEASE AREA.

CODES

ALL CONSTRUCTION SPECIFIED ON DOCUMENTS SUBMITTED FOR BUILDING PERMIT SHALL COMPLY WITH THE REQUIREMENTS OF THE FOLLOWING & ALL WORK SHALL BE PERFORMED IN ACCORDANCE WITH CURRENT EDITIONS OF THE FOLLOWING CODES AS ADOPTED BY THE LOCAL **GOVERNING AUTHORITIES:**

- 2018 NORTH CAROLINA BUILDING CODE (2015 IBC)
- 2018 NORTH CAROLINA FIRE CODE
- 2018 NORTH CAROLINA PLUMBING CODE
- 2018 NORTH CAROLINA MECHANICAL CODE
- 2018 NORTH CAROLINA ENERGY CONSERVATION CODE 2017 NORTH CAROLINA ELECTRICAL CODE - NFPA 70 ANSI/ TIA
- TIA-222-G, TIA-598-C, TIA-6087-B, TIA-569-B, TIA-568-C
- TIA-1019-A

SITE DESIGN SUMMARY:

WIND LOAD DESIGN: **EXPOSURE CATEGORY:** OCCUPANCY: CONSTRUCTION TYPE:

FACILITY IS UNMANNED AND NOT FOR HUMAN HABITATION. HANDICAP ACCESS IS NOT REQUIRED.

FACILITY HAS NO SANITARY OR POTABLE WATER

THERE IS "NO EMERGENCY RESPONSE EQUIPMENT ON THE TOWER AND EXISTING &/OR PROPOSED EQUIPMENT WILL NOT INTERFERE WITH COUNTY EMERGENCY COMMUNICATIONS AND THAT, IF SUCH, INTERFERENCE IS FOUND TO EXIST, THEN APPLICANT WILL TAKE WHATEVER STEPS NECESSARY TO CORRECT INTERFERENCE."

THIS SITE IS NOT IN ANY SPECIAL FLOOD HAZARD AREAS OR FUTURE CONDITIONS FLOOD HAZARD AREAS, AS SHOWN PER FIRM PANEL: 3720062000J. DATED: 10/03/2006.

- SITE SUMMARY -

SITE ADDRESS:

LILLINGTON, NC 27546

NC40177-T SBA NUMBER: **MAMERS** SBA NAME:

TOWER TYPE: COMPANY: SBA CARRIER: TENANT ID/NAME:

SITE LATITUDE(NAD83): 35.41925 (35° 25' 9.2994")

-78.919083 (-78° 55' 8.6988")

GND ELEVATION (NAVD88): 292' TOWER HEIGHT (AGL.)

40 RAVEN ROCK RD

MONOPOLE T-MOBILE 5RA0821A

> POWER COMPANY: SOUTH RIVER EMC TELCO COMPANY: CENTURY LINK

HARNETT COUNTY

3600 ± SQFT.

3600 ± SQFT.

0 SQFT.

130620009702

RA-30

JURISDICTION:

PARCEL #:

ACREAGE:

(E) IMPERVIOUS:

(P) IMPERVIOUS:

COMPOUND SIZE:

ZONING:

UTILITIES:

-SHEET INDEX

G-1

SITE LONGITUDE(NAD83):

T-1	TITLE SHEET
T-1A	APPENDIX B
T-1B	APPENDIX B
T-1C	APPENDIX B
C-1	SITE PLAN
C-2	EQUIPMENT PLAN
C-3	TOWER ELEVATION
C-4	ANTENNA ORIENTATION & CABLE SCHEDULE
C-5	PLUMBING DIAGRAM
C-6	EQUIPMENT SPECS
E-1	ELECTRICAL DETAILS
E-2	PANEL SCHEDULE & ONE-LINE DIAGRAM

GROUNDING DETAILS



T - Mobile-



SBA COMMUNICATIONS CORP 5900 BROKEN SOUND PKWY NW BOCA RATON, FL 33487



LOCATION:

40 RAVEN ROCK RD LILLINGTON, NC 27546

MAMERS NC40177-T

T-MOBILE

L-SPRINT RA73XC047 5RA0821A

SITE TYPE:

195' MONOPOLE T-MOBILE SPRINT KEEP

REV	DATE	DESCRIPTION
0	12/30/20	FOR CONSTRUCTION

SITE COORDINATES LAT: 35.41925 LONG: -78.919083

DRAWN: RSW CHECKED: PWM

20ASBTMMNC-0042 IOR#

> TITLE SHEET & **PROJECT INFORMATION**

> > T-1



CALL BEFORE YOU DIG

CALL NORTH CAROLINA ONE CALL (800) 632-4949 **CALL 3 WORKING DAYS BEFORE YOU DIG!**



2018 APPENDIX B BUILDING CODE SUMMARY FOR ALL COMMERCIAL PROJECTS

(EXCEPT 1 AND 2-FAMILY DWELLINGS AND TOWNHOUSES)

(Reproduce the following data on the building plans sheet 1 or 2)

Name of Project	. MT MODIAH -5PA	.0039A					
	T MORIAH ROAD DURHAM, NC			Zip Co	de		
	ed Agent: MACKENZIE CLIFFOR) 527 - 0003 x 21		MCLIFFORD@SBASITE.COM		
Owned By:	_	ty/County	Private CR				
Code Enforceme	_	ty	County Col	RNXMLE Sta			
cour zmoreeme		·J	<u></u>				
CONTACT:							
DESIGNER	FIRM	NAME	LICENSE #	TELEPHONE #	E-MAIL		
Architectural				()			
Civil Electrical	P. MARSHALL & ASSOCIATES	PATRICK MARSHALL	024136	(678) 280-2325			
Fire Alarm				()			
Plumbing							
Mechanical				()			
Sprinkler-Standp	pipe			()			
Structural Retaining Walls	>5' High			()			
Other	P. MARSHALL & ASSOCIATES	TREVOR MCALLISTER		(478) 542-3291	TMCALLISTER@PMASS.COM		
("Other" should	include firms and individu	als such as truss, p	recast, pre-engine	eered, interior desi	gners, etc.)		
2018 NC BUILDING CODE: New Building Shell/Core 1st Time Interior Completions							
		Chapter 14	☐ Alteratio	n Level III			
CONSTRU	CTED: (date)	CURREN	NT OCCUPANO	Y(S) (Ch. 3):			
RENOVAT	ED: (date)	_ PROPOS	ED OCCUPAN	CY(S) (Ch. 3):			
OCCUPANCY CATEGORY (Table 1604.5): Current: UTILITY Proposed: UTILITY							
BASIC BUILD	<u>-</u>	⊠ II-A	∏ III-A	□IV	□ V-A		
(check all that ap		□ II-B	☐ III-B	_	☐ V-B		
Sprinklers:	No Partial	☐ NFPA 13	☐ NFPA 13R	☐ NFPA 13D			
Standpipes:	⊠ No Class □ I		☐ Wet ☐ Dry	7			
Primary Fire D	istrict: 🛛 No 🔲 Ye	s Flood I	Hazard Area:	☐ No ☐ Yes			
Special Inspecti	ons Required: No	Yes Yes					
	GR	OSS BUILDING	AREA TABLE				
FLOOR	EXISTING (SQ FT)	New (s	SQ FT)	Sub-	TOTAL		
3 rd Floor							
2 nd Floor							
Mezzanine 1st Floor							
Basement							
Dasement							
TOTAL							

7-2 Low 1-2 Deflagrate	A-3 [] H-3 Combust [] I-3 [] 5] R-3 [☐ A-4 ☐ A-5 ☐ H-4 Health ☐ H-5 HPM ☐ I-4
7-2 Low 1-2 Deflagrate	H-3 Combust [I-3 [
I-2 Deflagrate] I-3 [
	_	_
	¬ р ₃	_
☐ S-2 Lo	ow	☐ R-4 ☐ High-piled ☐ Repair Garage
	_	
ı-Separate ¹	<u>'s).</u>	
(s): <	>	
~ `\O\ `		
70 1	(1)	
JILO Ared	of Occupancy B a of Occupancy B +	≤ 1 = ≤ 1.00
	(C) AREA FOR FRONT INCREASE ^{1,5}	
	n-Separate ^A ns): Arec (B) A PER TABLE 506.	n-Separate ¹ s). 10 11 12 13 15 16 17 17 18 18 18 19 19 19 19 19 19 19

T - Mobile-



SBA COMMUNICATIONS CORP. 5900 BROKEN SOUND PKWY NW BOCA RATON, FL 33487



LOCATION:

40 RAVEN ROCK RD LILLINGTON, NC 27546

SBA

MAMERS NC40177-T

T-MOBILE:

L-SPRINT RA73XC047 5RA0821A

SITE TYPE:

195' MONOPOLE T-MOBILE SPRINT KEEP

	וטטווו	LE OI KIIVI KEEL
REV	DATE	DESCRIPTION
0	12/30/20	FOR CONSTRUCTION

SITE COORDINATES LAT: 35.41925 LONG: -78.919083

DRAWN: RSW
CHECKED: PWM

JOB#: 20ASBTMMNC-0042

APPENDIX B

T-1A

ALLOWABLE HEIGHT

	ALLOWABLE	SHOWN ON PLANS	CODE REFERENCE
Building Height in Feet (Table 504.3)			
Building Height in Stories (Table 504.4)			

Provide code reference if the "Shown on Plans" quantity is not based on Table 504.3 or 504.4.

FIRE PROTECTION REQUIREMENTS

BUILDING ELEMENT	FIRE		RATING	DETAIL#	DESIGN#	SHEET # FOR	SHEET #
	SEPARATION DISTANCE (FEET)	REQ'D	PROVIDED (W/* REDUCTION)	AND SHEET #	FOR RATED ASSEMBLY	RATED PENETRATION	FOR RATED JOINTS
Structural Frame,							
including columns, girders, trusses							
Bearing Walls					J		
Exterior							
North							
East				,			
West							
South			_^	\			
Interior			' . ()	` _			
Nonbearing Walls and Partitions			MO	\mathcal{A})		
Exterior walls	l .	. ~	1 ,	\sim			
North		1 r	\sim	1			
East	\vdash \sim	١,	.、\)	• -			
West	1-	. ,	111/				
South	•	\sim	112				
Interior walls and partitions		Y)	-				
Floor Construction	-	~					
Including supporting beams			1				
and joists							
Floor Ceiling Assembly							
Columns Supporting Floors							
Roof Construction, including supporting beams and joists							
Roof Ceiling Assembly							
Columns Supporting Roof							
Shaft Enclosures - Exit							
Shaft Enclosures - Other							
Corridor Separation							
Occupancy/Fire Barrier Separat	tion	-					
Party/Fire Wall Separation		-	-	-			
Smoke Barrier Separation		-	-				
Smoke Partition		l	-	1			
Tenant/Dwelling Unit/ Sleeping Unit Separation							
Incidental Use Separation							

^{*} Indicate section number permitting reduction

ACCESSIBLE DWELLING UNITS

TOTAL UNITS	Accessible Units Required	ACCESSIBLE UNITS PROVIDED	TYPE A Units Required	TYPE A UNITS PROVIDED	TYPE B Units Required	TYPE B Units Provided	TOTAL ACCESSIBLE UNITS PROVIDED

ACCESSIBLE PARKING (SECTION 1106)

LOT OR PARKING AREA	TOTAL # OF PA	PROVIDED	REGULAR W ^P 5' ACCE ⁹	YD YCESS E	TOTAL # ACCESSIBLE PROVIDED
TOTAL			40,40		
		412	JII JIREMEN	NTS	

τ	JSE	W		\) .s		LAVATORIE	S	SHOWERS	DRINKING	FOUNTAINS
		MALE				MALE	FEMALE	UNISEX	/TUBS	REGULAR	ACCESSIBLE
SPACE	EXIST'G			1							
	NEW										
	REQ'D										

SPECIAL APPROVALS

Special approval: (Local Jurisdiction, Department of Insurance, OSC, DPI, DHHS, etc., describe below)

PERCENTAGE OF WALL OPENING CALCULATIONS

FIRE SEPARATION DISTANCE (FEET) FROM PROPERTY LINES	DEGREE OF OPENINGS PROTECTION (TABLE 705.8)	Allowable area (%)	ACTUAL SHOWN ON PLANS (%)

LIFE SAFETY SYSTEM REQUIREMENTS

Emergency Lighting:	☐ Yes ☐ No ☐ Yes ☐ No
Exit Signs: Fire Alarm:	☐ Yes ☐ No
Smoke Detection Systems: Carbon Monoxide Detection:	☐ Yes ☐ No ☐ Yes ☐ No

ife Safety Plan Sheet #:	_
Fire and/or smoke rated wall locations (Chapter 7)	1 Y
☐ Assumed and real property line locations (if no*	11 '
Exterior well opening area with respect to	, –

at door can accommodate based on egress width (1005.3)

above

are fire rated floor/ceiling and/or roof structure is provided for

LIFE SAFETY PLAN REQUIREM

Exterior wall opening area wi	th resp
Occupancy Use for each area	as it re
Occupant loads for each area	
Exit access travel distance	_
Common path of trav	1
Dead end lengths (.	1

\Box	Dead end lengths (•
	Clear exit widths for	
	Maximum calculated oc	
	Actual occupant load for c	
	Maximum calculated oc	

CIGHT CITTO LITERAL TOT (
Maximum calculated oc
Actual occupant load for c
A separate schematic plan in

Life Safety Plan Sheet #:

Actual occupant load for c
A separate schematic plan in
purposes of occupancy separa.

\Box	A separate senematic plan ii.	Te fire fated floor/centing and/or foor structure
	purposes of occupancy separa.	
	Location of doors with panic hardware	(1010.1.10)
	Location of doors with delayed egress le	ocks and the amount of delay (1010.1.9.7)

Location of doors with electromagnetic egress locks (1010.1.9.9)
Location of doors equipped with hold-open devices
T

Location of emergency escape windows (103
The square footage of each fire area (202)

The square footage of each fire area (2	02
The square footage of each smoke con	ıpa

The square footage of each smoke compartment for Occupancy Classification	i-2 (407.
Note any code exceptions or table notes that may have been utilized regarding	the	items

ENERGY SUMMARY

ENERGY REQUIREMENTS:

The following data shall be considered minimum and any special attribute required to meet the energy code shall also be provided. Each Designer shall furnish the required portions of the project information for the plan data sheet. If performance method, state the annual energy cost for the standard reference design vs annual energy cost for the

Existing building envelope complies with code: Select one

Exempt Building: Select one Provide code or statutory reference:

Climate Zone: Select one

Method	of Com	nliance:	Select	one

тенной от сотриансе.	Beleet one	
	(If "Other" specify source here)	

THERMAL ENVELOPE (Prescriptive method only)

Roof/ceiling Assembly (each assembly)

Description of assembly:
U-Value of total assembly:
R-Value of insulation:
Skylights in each assembly:
U-Value of skylight

U-Value of skylight: total square footage of skylights in each asser

Exterior Walls (each assembly) Description of assembly: U-Value of total assembly

R-Value of ins	ulation
Openings (win	do 1 📐 🐪
U-17	. \ \ \ \ \ \ \ \ \ \ \ \ \ \ \ \ \ \ \
,	111
	' ' ' ' ' ' ' ' ' ' ' ' ' ' ' ' ' ' ' '
	ao.
Walls balan and	O_{-}

Description o U-Value of tota R-Value of insula

Floors over unconditioned space (each assembly)

Description of assembly:	
U-Value of total assembly:	
R-Value of insulation:	

Floors slab on grade

Description of assembly U-Value of total assembly: R-Value of insulation: slab heated:

T - Mobile-



SBA COMMUNICATIONS CORP. 5900 BROKEN SOUND PKWY NW BOCA RATON, FL 33487



LOCATION:

40 RAVEN ROCK RD LILLINGTON, NC 27546

MAMERS NC40177-T

T-MOBILE:

L-SPRINT RA73XC047 5RA0821A

195' MONOPOLE T-MOBILE SPRINT KEEP

REV	DATE	DESCRIPTION
0	12/30/20	FOR CONSTRUCTION

SITE COORDINATES LAT: 35.41925 LONG: -78.919083

DRAWN: RSW CHECKED: PWM

JOB#: 20ASBTMMNC-0042

APPENDIX B

T-1B

2018 APPENDIX B BUILDING CODE SUMMARY FOR ALL COMMERCIAL PROJECTS STRUCTURAL DESIGN

(PROVIDE ON SHEET 1 OR 2 OF THE STRUCTURAL SHEETS)

DESIGN LOADS:	,
Importance Factors:	$\begin{array}{cccc} Wind & (I_W) & _ \\ Snow & (I_S) & _ \\ Seismic & (I_E) & _ \\ \end{array}$
Live Loads:	Roof psf Mezzanine psf Floor
Ground Snow Load:	psf
	ic Wind c C D
SEISMIC DESIGN CATE	
Provide the following Seisn. Occupancy Categor Spectral Response Ac Site Classification (ASC Data S Basic structural system (I II IV S %g S1 %g A B C D E F arce: Field Test Presumptive Historical Data
☐ Bearing Wall ☐ Building Fran ☐ Moment Fran Analysis Procedure:	☐ Dual w/Special Moment Frame ☐ Dual w/Intermediate R/C or Special Steel
LATERAL DESIGN CONTROL	: Earthquake Wind
	of test report) psf acity psf y

2018 APPENDIX B BUILDING CODE SUMMARY FOR ALL COMMERCIAL PROJECTS MECHANICAL DESIGN

(PROVIDE ON THE MECHANICAL SHEETS IF APPLICABLE)

MECHANICAL SUMMARY

MECHANICAL SYSTEMS, SERVICE SYSTEMS AND EQUIPMENT

	mal Zone
	winter dry bulb:
	summer dry bulb:
Inter	ior design conditions
	winter dry bulb:
	summer dry bulb:
	relative humidity:
Build	summer dry bulb:
Build	ling cooling load:
Mecl	nanical Spacing Condition).
	Unitary
	description of unit:
	heating efficiency:
	cooling efficiency:
	cooling efficiency:
	cooling efficiency:size category of unit:
	cooling efficiency: size category of unit: Boiler

2018 APPENDIX B BUILDING CODE SUMMARY FOR ALL COMMERCIAL PROJECTS ELECTRICAL DESIGN

(PROVIDE ON THE ELECTRICAL SHEETS IF APPLICABLE)

ELECTRICAL SUMMARY

ELECTRICAL SYSTEM AND EQUIPMENT

 $\begin{tabular}{ll} \textbf{Method of Compliance:} & \underline{Select\ one} \\ \end{tabular}$

 $\textbf{Lighting schedule} \ (\text{each fixture type})$

lamp type required in fixture number of lamps in fixture ballast type used in the fixty number of ballasts in fixtotal wattage per fixtotal interior wattage total exterior wattage

.e building or space by space)

Additional Prescriptive Complia.

506.2.1 More Efficient N. Johanical Equipment
506.2.2 Reduced Lighting Power Density
506.2.3 Energy Recovery Ventilation Systems
506.2.4 Higher Efficiency Service Water Heating
506.2.5 On-Site Supply of Renewable Energy
506.2.6 Automatic Daylighting Control Systems

T - Mobile-





LOCATION:

40 RAVEN ROCK RD LILLINGTON, NC 27546

SB

MAMERS NC40177-T

T-MOBILE:

L-SPRINT RA73XC047 5RA0821A

SITE TYPE:

195' MONOPOLE T-MOBILE SPRINT KEEP

1-WODILL OF KINT KLLI		
REV	DATE	DESCRIPTION
0	12/30/20	FOR CONSTRUCTION


SITE COORDINATES LAT: 35.41925 LONG: -78.919083

DRAWN: RSW CHECKED: PWM

JOB#: 20ASBTMMNC-0042

APPENDIX B

T-1C

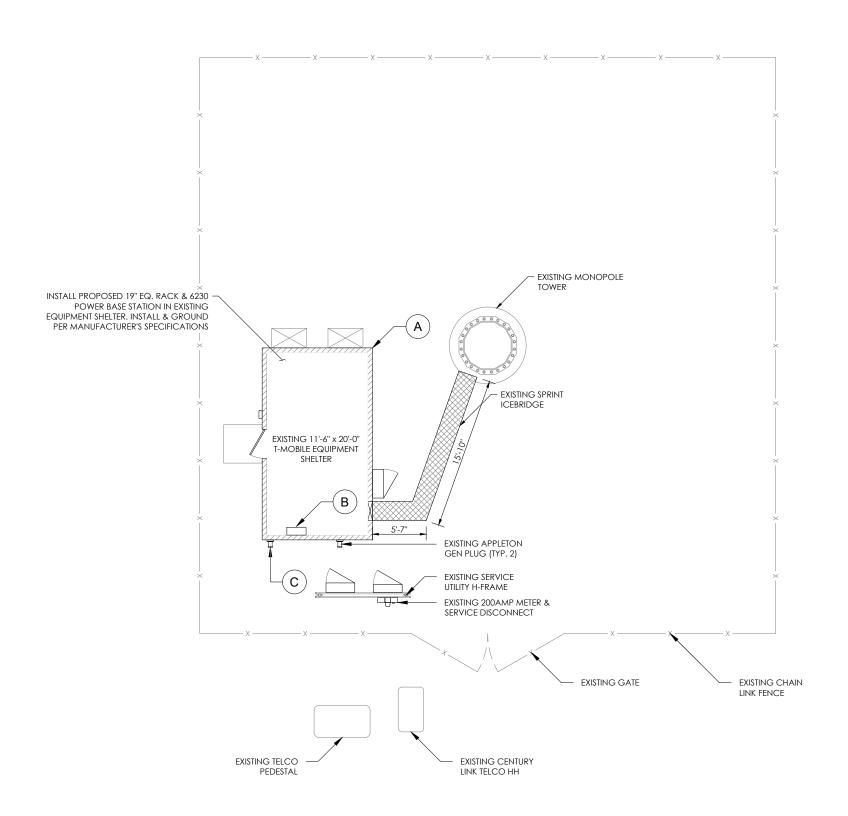

GENERAL NOTES -

- 1. ALL MATERIAL AND EQUIPMENT FURNISHED SHALL BE NEW AND OF GOOD QUALITY. FREE FROM FAULTS AND DEFECTS AND IN CONFORMANCE WITH THE CONTRACT DOCUMENTS. ANY SUBSTITUTIONS MUST BE PROPERLY APPROVED AND AUTHORIZED IN WRITING BY THE OWNER AND ENGINEER PRIOR TO INSTALLATION. CONTRACTOR SHALL FURNISH SATISFACTORY EVIDENCE AS TO THE KIND OF QUALITY OF MATERIAL AND EQUIPMENT BEING SUBSTITUTED.
- ACCESS TO PROPOSED WORK SITE MAY BE RESTRICTED. THE CONTRACTOR SHALL COORDINATE INTENDED CONSTRUCTION ACTIVITY, INCLUDING WORK SCHEDULE AND MATERIALS ACCESS WITH THE LEASING AGENT FOR APPROVAL.
- CONTRACTOR SHALL HAVE PRESENT ON SITE CURRENT CARRIER SUPPLIED INFORMATION PRIOR TO COMMENCE OF WORK; IE. RFDS, DESIGN DOCUMENTS SPECIFIC TO SITE AND CONFIGURATION. NOTIFY CONSTRUCTION MANAGER OF ANY DISCREPANCY PRIOR TO ARRIVAL AT SITE.
- 4. ALL HARDWARE ASSEMBLY MANUFACTURER'S INSTRUCTION SHALL BE FOLLOWED EXACTLY AND SHALL SUPERSEDE ANY CONFLICTING NOTES ENCLOSED HEREIN.
- 5. ALL DAMAGE TO EXISTING UNDERGROUND, OVERHEAD OBSTACLES AND/OR EXISTING EQUIPMENT, PAD OR SHELTERS SHALL BE REPLACED BACK TO FULL ORIGINAL OR BETTER CONDITION & SHALL MATCH EXISTING CONDITIONS BY REPAIRS AT GENERAL CONTRACTOR EXPENSE.
- 6. THE EXISTING TREES AND VEGETATION ARE SUFFICIENT TO PROVIDE THE REQUIRED SCREENING PER LOCAL ORDINANCE. IF THE VEGETATION IS REMOVED OR DAMAGED, NEW LANDSCAPING/ SCREENING WILL BE INSTALLED TO MEET LOCAL ORDINANCE REQUIREMENTS.

KEYED NOTES


- A. REMOVE ALL EXISTING NOT-IN-USE EQUIPMENT FROM EXISTING SHELTER. LEAVE EXISTING POWER PANEL, DISCONNECT, AND ALL EQUIPMENT REQUIRED TO CONTINUE SERVICING EXISTING B-25 TOWER TOP RADIO. RE-USE ALL EXISTING GROUND HALOS/BARS AND COAX PORTS. CABLE TRAYS TO REMAIN.
- B. APPROXIMATE LOCATION OF EXISTING POWER PANEL. REMOVE EXISTING BREAKERS NOT UTILIZED BY B25 RADIO EQUIPMENT AND INSTALL PROPOSED BREAKERS FOR PROPOSED EQUIPMENT.
- C. REPLACE EXISTING APPLETON GEN PLUGS AND INSTALL PROPOSED CAM-LOC PLUGS.


GRAPHIC SCALE

SITE PLAN

1"=5'-0" (FULL SIZE)
5' 2.5' 0 5' 1"=10'-0" (11x17)

-NORTH ARROW-

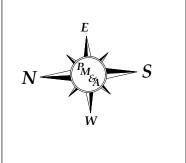

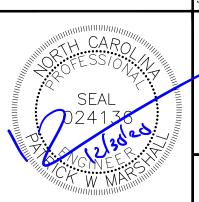

T - Mobile-



SBA COMMUNICATIONS CORP. 5900 BROKEN SOUND PKWY NW BOCA RATON, FL 33487



I OCATION:

40 RAVEN ROCK RD LILLINGTON, NC 27546

SBA:

MAMERS NC40177-T

T-MOBILE:

L-SPRINT RA73XC047 5RA0821A

ITE TYPE:

195' MONOPOLE T-MOBILE SPRINT KEEP


REV	DATE	DESCRIPTION
0	12/30/20	FOR CONSTRUCTION

SITE COORDINATES LAT: 35.41925 LONG: -78.919083

DRAWN: RSW CHECKED: PWM

JOB#: 20ASBTMMNC-0042

SITE PLAN

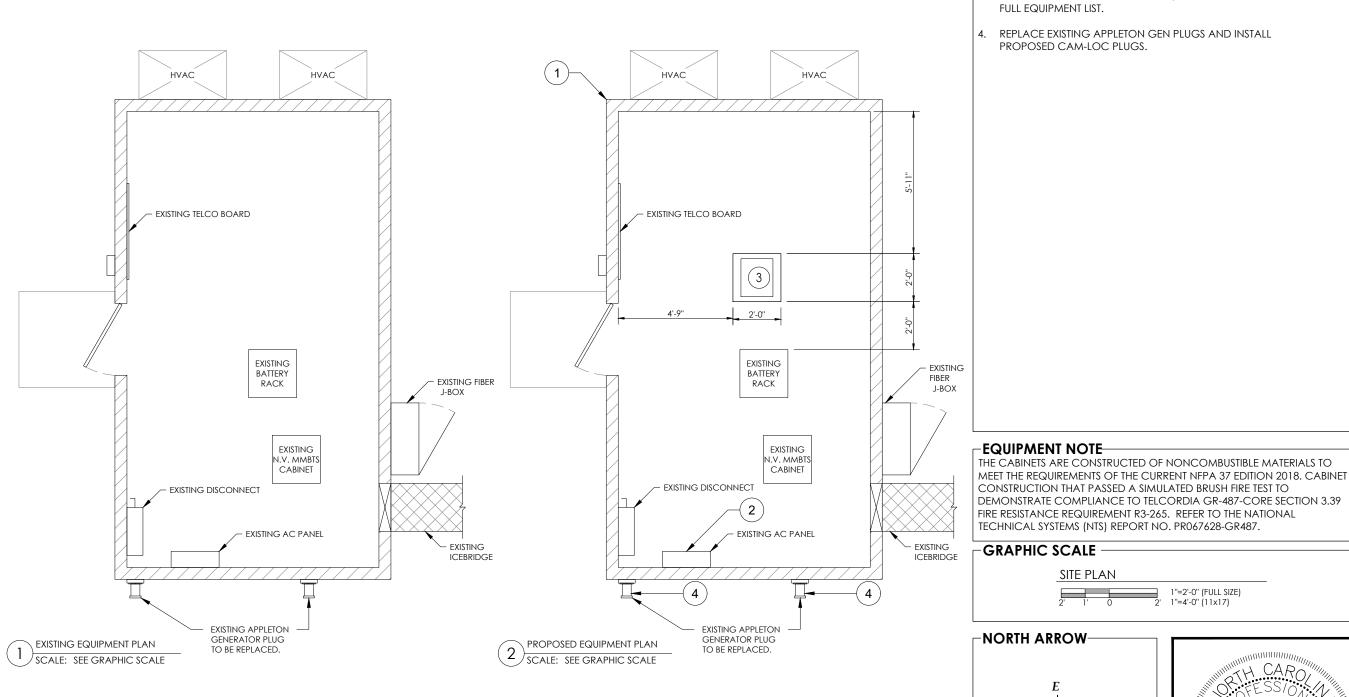

GENERAL NOTES

- REMOVE ALL EXISTING NOT-IN-USE EQUIPMENT FROM EXISTING SHELTER. LEAVE EXISTING POWER PANEL, DISCONNECT, AND ALL EQUIPMENT REQUIRED TO CONTINUE SERVICING EXISTING B-25 TOWER TOP RADIO. RE-USE ALL EXISTING GROUND HALOS/BARS AND COAX PORTS. CABLE TRAYS TO REMAIN.
- EXISTING POWER PANEL. REMOVE EXISTING BREAKERS NOT UTILIZED BY B25 RADIO EQUIPMENT AND INSTALL PROPOSED BREAKERS FOR PROPOSED EQUIPMENT.
- PROPOSED 19" RACK WITH 6230 PP, AND RBS 6601. SEE RFDS FOR FULL EQUIPMENT LIST.
- REPLACE EXISTING APPLETON GEN PLUGS AND INSTALL PROPOSED CAM-LOC PLUGS.

T - Mobile-



SBA COMMUNICATIONS CORP. 5900 BROKEN SOUND PKWY NW BOCA RATON, FL 33487



40 RAVEN ROCK RD LILLINGTON, NC 27546

MAMERS NC40177-T

T-MOBILE:

L-SPRINT RA73XC047 5RA0821A

195' MONOPOLE T-MOBILE SPRINT KEEP

RCONSTRUCTION

SITE COORDINATES LAT: 35.41925


LONG: -78.919083

DRAWN: RSW CHECKED: PWM

20ASBTMMNC-0042

-NORTH ARROW-


SITE PLAN

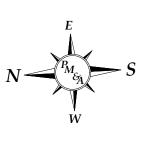



1"=2'-0" (FULL SIZE)

EXISTING EQUIPMENT PLAN

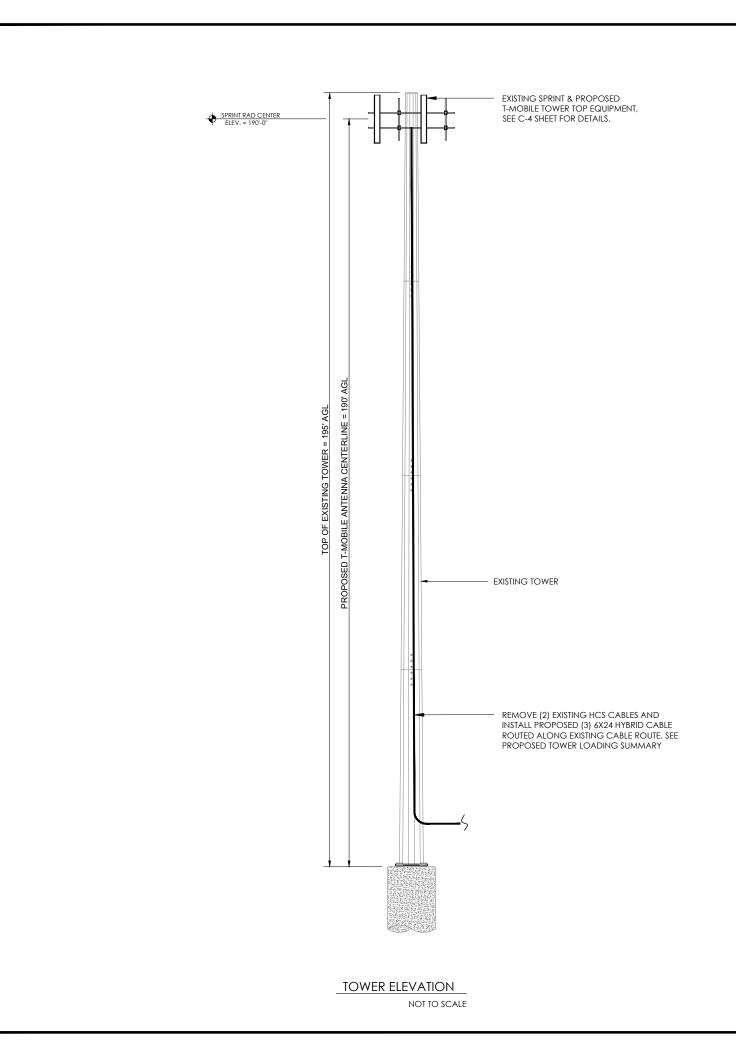

-GENERAL NOTES -

- PM&A HAS NOT PERFORMED A TOWER STRUCTURAL ANAYSIS FOR THIS PROJECT. REFER TO TOWER STRUCTURAL ANALYSIS BY OTHERS FOR PROPOSED ANTENNA CABLE LOADING DETAILS
- 2. TOWER ELEVATION SHOWN IS NOT DRAWN TO SCALE AND IS ONLY INTENDED FOR REFERENCE PURPOSES, REFER TO ORIGINAL TOWER DESIGN FOR ADDITIONAL INFORMATION.
- 3. ALL TOWER DIMENSIONS SHALL BE VERIFIED WITH THE PLANS PRIOR TO COMMENCING CONSTRCTION. NOTIFY TH EENGINEER IMMEDIATELY IF ANY DISCREPANCIES ARE DISCOVERED.
- 4. ALL HARDWARE ASSEMBLE MANUFACTURER'S INSTRUCTIONS SHALL BE FOLLOWED EXACTLY AND SHALL SUPERSEDE ANY CONFLICTING NOTES ENCLOSED HEREIN.
- 5. ALL MATERIALS AND EQUIPMENT FURNISHED SHALL BE NEW AND OF GOOD QUALITY, FREE FROM FAULTS AND DEFECTS AND IN CONFORMANCE WITH THE CONTRACT DOCUMENTS. ANY AND ALL SUBSTITUTIONS MUST BE PROPERLY APPROVED AND AUTHORIZED IN WRITING BY THE OWNER AND ENGINEER PRIOR TO INSTALLATION. CONTRACTOR SHALL FURNISH SATISFACTORY EVIDENCE AS TO THE KIND OF QUALITY OF THE MATERIALS AND EQUIPMENT BEING SUBSTITUTED.
- 6. CONTRACTOR TO REFER TO THE MOUNT ANALYSIS FOR THIS PROJECT.

FINISH NOTES:

TOWER- GALVANIZED TOWER MOUNTS- GALVANIZED

ANTENNA- NEUTRAL (MANUFACTURER FINISH)

FOUNDATIONS- UNPAINTED CONCRETE

ICE BRIDGE- GALVANIZED CABLES- BLACK

BASE CABINETS/EQUIPMENT- NEUTRAL (MANUFACTURER FINISH)

⊢TOWER	TOWER LOADING SUMMARY			
EXISTING	REMOVE	EQUIPMENT	ADD	TOTAL
6	6	ANTENNA	9	9
0	0	TMA	0	0
9	6	RADIOS	3	6
0	0	COAX	0	0
4	2	HYBRIDS	3	5





SBA COMMUNICATIONS CORP. 5900 BROKEN SOUND PKWY NW BOCA RATON, FL 33487



LOCATION:

40 RAVEN ROCK RD LILLINGTON, NC 27546

SBA:

MAMERS NC40177-T

T-MOBILE:

L-SPRINT RA73XC047 5RA0821A

SITE TYPE:

195' MONOPOLE T-MOBILE SPRINT KEEP


REV	DATE	DESCRIPTION
0	12/30/20	FOR CONSTRUCTION
SI	TE COORI	DINATES
LA	AT: 35.4	1925
LC	DNG: -78.	919083
DRAV	VN: RSV	V

CHECKED: PWM

JOB#: 20ASBTMMNC-0042



TOWER ELEVATION

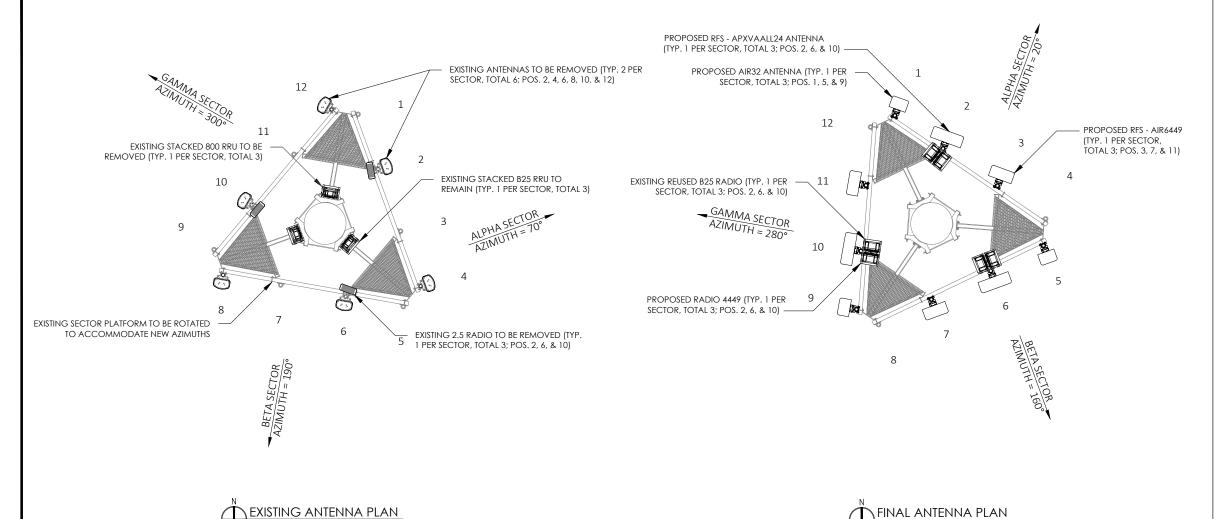

SECTOR	MARK	ENNA SCH azimuth	ANTENNA MODEL	RADIO MODEL	CABLE DESCRIPTION
ALPHA	1	20°	ERICSSON - AIR32 KRD901146-1_B66A_B2A (OCTO) (P)	-	(1) 1 1/2" 6x12 HCS (EXISTING TO REMAIN)
ALPHA	2	20°	RFS - APXVAALL24_43-U-NA20 (OCTO) (P)	(1) B25 4TRT RRU (E) (1) RADIO 4449 B71+B85 (P)	(1) ERICSSON 6x24 HCS 4AWG 80M (263') (P)
ALPHA	3	20°	ERICSSON - AIR6449 B41 (MASSIVE MIMO) (P)		-
-	4	-	-	-	
BETA	5	160°	ERICSSON - AIR32 KRD901146-1_B66A_B2A (OCTO) (P)	-	(1) 1 1/2" 6x12 HCS (EXISTING TO REMAIN)
BETA	6	160°	RFS - APXVAALL24_43-U-NA20 (OCTO) (P)	(1) B25 4TRT RRU (E) (1) RADIO 4449 B71+B85 (P)	(1) ERICSSON 6x24 HCS 4AWG 80M (263') (P)
BETA	7	160°	ERICSSON - AIR6449 B41 (MASSIVE MIMO) (P)	•	-
-	8	-	-	•	-
GAMMA	9	280°	ERICSSON - AIR32 KRD901146-1_B66A_B2A (OCTO) (P)	-	-
GAMMA	10	280°	RFS - APXVAALL24_43-U-NA20 (OCTO) (P)	(1) B25 4TRT RRU (E) (1) RADIO 4449 B71+B85 (P)	(1) ERICSSON 6x24 HCS 4AWG 80M (263') (P)
GAMMA	11	280°	ERICSSON - AIR6449 B41 (MASSIVE MIMO) (P)	-	
-	12	-	-		-

NOT TO SCALE

-ANTENNA NOTE

NOT TO SCALE

CONTRACTOR TO ROTATE THE ANTENNAS AND OR MOUNTS TO OBTAIN NEW AZIMUTHS. REFER TO FINAL RF DOCUMENTS TO CONFIRM NEW AZIMUTHS

(E)- EXISTING (P) - PROPOSED

GC TO PROVIDE POST CONSTRUCTION DOCUMENTATION ON ALL ANTENNA AZIMUTHS AND COLOR CODING FOR CABLES.

EQUIPMENT NOTES

- 1. THE HYBRID CABLE LENGTH
 SHOWN IS ONLY AN ESTIMATE
 AND SHOULD NOT BE USED FOR
 ORDERING MATERIALS.
 CONFIRM THE REQUIRED HYBRID
 CABLE LENGTH WITH T-MOBILE
 PRIOR TO ORDERING OR
 INSTALLATION.
- 2. THE CONTRACTOR SHALL TEST THE OPTICAL FIBER AFTER INSTALLATION IN ACCORDANCE WITH T-MOBILE STANDARDS AND SUPPLY THE RESULTS TO T-MOBILE.
- 3. THE CONTRACTOR SHALL CONFIRM THE TOWER TOP EQUIPMENT LIST ABOVE WITH THE FINAL T-MOBILE RFDS PRIOR TO INSTALLATION.
- 4. ALL PROPOSED ANTENNA
 CABLES SHALL BE COLOR
 CODED PER T-MOBILE MARKET
 STANDARDS.
- 5. REFER TO ERICSSON EQUIPMENT INSTALLATION STANDARDS FOR ADDITIONAL INFORMATION.
- 6. REFER TO EQUIPMENT
 MANUFACTURER'S
 SPECIFICATION SHEETS FOR
 ADDITIONAL INFORMATION NOT
 LISTED ABOVE.
- 7. CONTRACTOR TO FIELD COORDINATE EXACT LOCATION OF PROPOSED EQUIPMENT WITH EXISTING CONDITIONS ON SITE.
- 8. PROPOSED EQUIPMENT SHALL BE INSTALLED PER MANUFACTURER'S SPECIFICATIONS. ALL HARDWARE FASTENERS SHALL BE HIGH STRENGTH (A325, A36)
- DRILLING OF EXISTING STEEL
 MEMBERS IS NOT PERMITTED.
- 10.BOND PROPOSED EQUIPMENT
 TO EXISTING SECTOR GROUND
 BAR PER MANUFACTURER'S
 SPECIFICATIONS, PROVIDE
 ADDITIONAL SECTOR GROUND
 BARS AS REQUIRED.
- 11. ALL ANTENNAS, CABLES, AND MOUNTS SHALL BE INSTALLED IN ACCORDANCE WITH THE ENGINEER'S RECOMMENDATIONS IN A MANNER CONSISTENT WITH THE STRUCTURAL ANALYSIS REPORT.
- 12. CONTRACTOR TO CONTACT T-MOBILE FOR UP-TO-DATE RF DESIGN DATA. NOTIFY ENGINEER IF CONFLICT EXISTS.

T - Mobile-



SBA COMMUNICATIONS CORP. 5900 BROKEN SOUND PKWY NW BOCA RATON, FL 33487



LOCATION:

40 RAVEN ROCK RD LILLINGTON, NC 27546

SBA:

MAMERS NC40177-T

T-MOBILE:

L-SPRINT RA73XC047 5RA0821A

SITE TYPE:

195' MONOPOLE T-MOBILE SPRINT KEEP

REV	DATE	DESCRIPTION
0	12/30/20	FOR CONSTRUCTION

SITE COORDINATES LAT: 35.41925 LONG: -78.919083

DRAWN: RSW

CHECKED: PWM

JOB#: 20ASBTMMNC-0042


SEAL

O24138

WMARINING
WM

ANTENNA
ORIENTATION &
CABLE SCHEDULE

PROPOSED RF CONFIGURATION: 67D5A97DB_B25

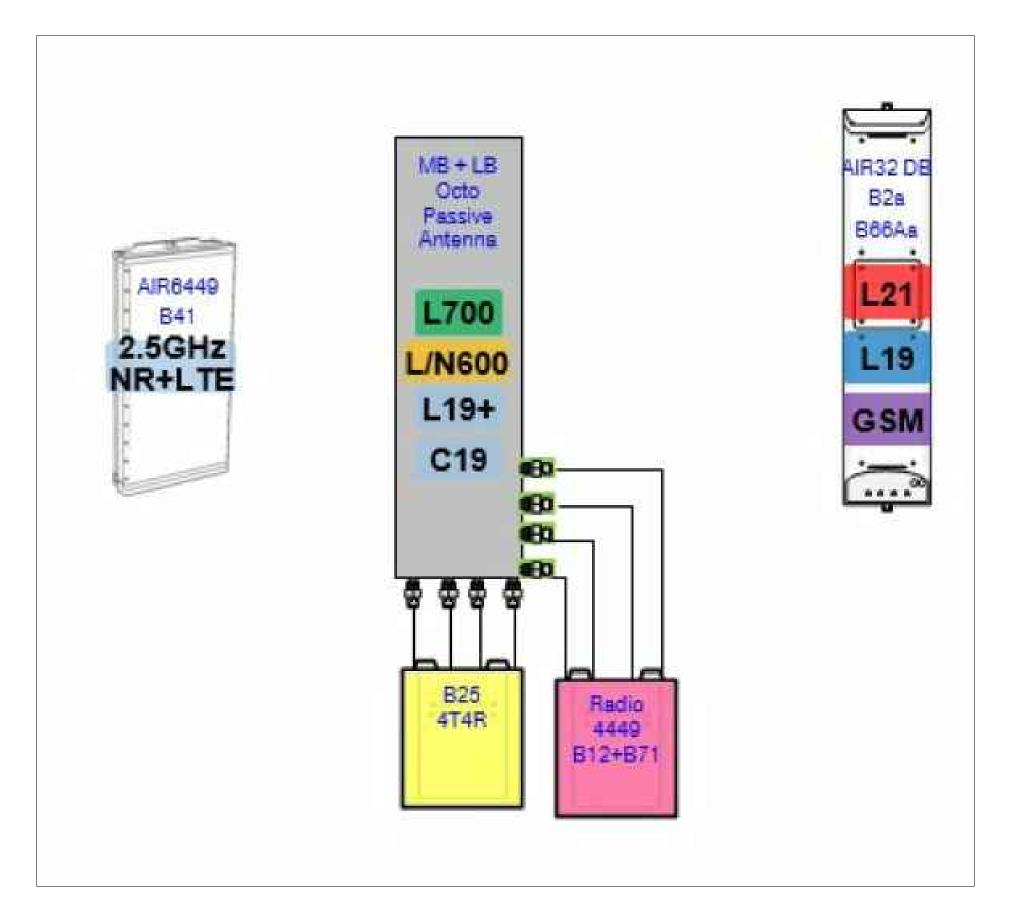

T - Mobile-





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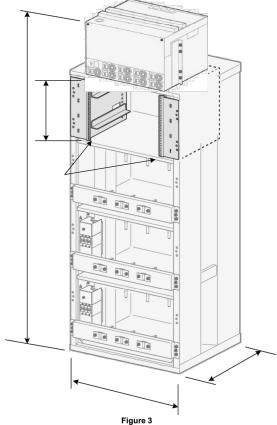
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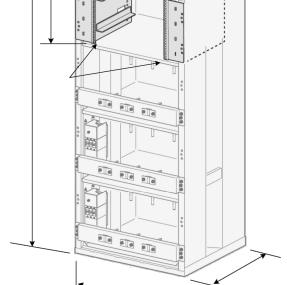
JOB#: 20ASBTMMNC-0042

PLUMBING DIAGRAM

6230 Placement

The 6230 arrives mounted on top of the prescribed Ericsson battery rack (Figure 3), which is to be bolted down onto the floor. Clearance at the top shall be provided to enable cabling for AC feed, DC loads, SPD, and battery cables. Front clearance shall allow work space for loading/unloading of 190 Ahr batteries (22"x5"x12" each). If desired, any of the battery shelves can be converted for user equipment by installing optional rack kit to provide up to 8U each.





T-Mobile USA, INC. Confidential 6 of 17





SBA COMMUNICATIONS CORP. 5900 BROKEN SOUND PKWY NW BOCA RATON, FL 33487



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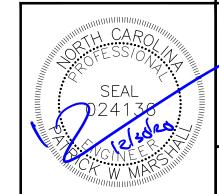
195' MONOPOLE T-MOBILE SPRINT KEEP

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20ASBTMMNC-0042



EQUIPMENT SPECS

C-6

DC distribution circuit breaker Extended interface board (EIB) Interface board (IB2) Rectifier Power controller unit (PCU) AC grounding

Cable routing AC cable interface Battery cable inlet

RTN alarm

T-Mobile USA, INC. Confidential

Feature

-48 VDC distribution

Figure 2

Adaptor bracket for wall mounting kit

0 V bus bar DC connection AC input

0 V/RTN for battery cables

Alarm circuit breaker cable, temperature sensor, SCU power cable

5 of 17

EQUIPMENT NOTES-

DEMO NOTES:


- 1. REWORK ALL TERMINATION, ELECTRICAL CONNECTORS, CONDUCTORS, CONDUITS, ETC., TO FACILITATE NEW WORK.
- 2. VERIFY LOCATION IN THE FIELD OF ALL UNDERGROUND UTILITIES PRIOR TO EXCAVATING. COORDINATE WITH PUBLIC UTILITIES AS NECESSARY TO COMPLETE REQUIRED WORK AS INDICATED IN THE CONTRACT DOCUMENTS. THE CONTRACTOR SHALL BE RESPONSIBLE FOR THE REPAIR / REPLACEMENT OF ALL DAMAGED UTILITIES AT THE EXPENSE OF THE CONTRACTOR.
- 3. DEMOLITION IS INCLUDED TO GIVE A COMMON BASIS FOR QUOTATIONS AND MAY NOT SHOW EVERY ITEM TO BE DEMOLISHED. IT IS THE CONTRACTOR'S RESPONSIBILITY TO VISIT THE SITE TO DETERMINE THE EXACT EXTENT OF WORK, COORDINATION, DEMOLITION, TEMPORARY FACILITIES, UTILITIES, ETC. NECESSARY TO COMPLETE THE PROJECT AS INDICATED ON THE CONTRACT DOCUMENTS.
- 4. PROTECT NETWORK EQUIPMENT, RECTIFIERS, FIBER CABLE, RACEWAYS, UTILITIES, BUILDING SYSTEMS, ETC. FROM DAMAGE.
- EQUIPMENT DESIGNATED TO BE RELOCATED SHALL BE CLEANED, STORED AND PROTECTED FROM DAMAGE UNTIL REINSTALLED. REPLACE ALL EQUIPMENT DAMAGED DURING RELOCATING.
- 6. PROVIDE TEMPORARY POWER TO ALL ESSENTIAL SYSTEMS AS REQUIRED TO FACILITATE DEMOLITION. PROVIDE TEMPORARY COOLING UNITS AS REQUIRED.
- 7. MAINTAIN CIRCUIT CONTINUITY TO EXISTING CIRCUITS AND EQUIPMENT TO REMAIN OR TO BE RELOCATED.
- 8. WHERE ALLOWED BY CODE IT IS PERMISSIBLE TO REUSE EXISTING CONDUIT. PROVIDE NEW CONDUIT AND CONDUCTORS FOR NEW CIRCUITS AND THE EXTENSION OF EXISTING CIRCUITS.
- 9. PROVIDE EQUIPMENT PROTECTION ABOVE ALL NETWORK EQUIPMENT (INCLUDING BUT NOT LIMITED TO CABLING, BUS, CABLE TRAY, EQUIPMENT BAYS, RECTIFIERS, BATTERIES, INVERTERS, DISTRIBUTION PANELS, ETC.) WHEN WORKING ABOVE ALL EQUIPMENT. ALL PROTECTION SHALL BE COORDINATED WITH THE SWITCH MANAGER TO ENSURE THAT THE PROTECTION WILL NOT BLOCK ACCESS TO EQUIPMENT OR CAUSE OVERHEATING. PROVIDE TEMPORARY COOLING AS REQUIRED.
- 10. PROVIDE APPROPRIATE SEALING AND PATCHING OF ANY BUILDING PENETRATIONS AFTER REMOVAL OF ELECTRICAL DEVICES, EQUIPMENT, ETC. MATCH EXISTING WALLS. SEE ARCHITECTURE.

GENERAL NOTES:

- 1. IT IS CONTRACTOR'S RESPONSIBILITY TO VISIT THE SITE & DETERMINE THE EXACT EXTENT OF WORK, COORDINATION, DEMOLITION, TEMPORARY FACILITIES, UTILITIES, ETC. NECESSARY TO COMPLETE THE PROJECT AS INDICATED ON THE CONTRACT DOCUMENTS.
- VERIFY LOCATION IN THE FIELD OF ALL UNDERGROUND UTILITIES PRIOR TO EXCAVATING. COORDINATE WITH PUBLIC
 UTILITIES AS NECESSARY TO COMPLETE REQUIRED WORK AS INDICATED IN THE CONTRACT DOCUMENTS. THE
 CONTRACTOR SHALL BE RESPONSIBLE FOR THE REPAIR/REPLACEMENT OF ALL DAMAGED UTILITIES AT THE EXPENSE OF
 THE CONTRACTOR.
- 3. PROVIDE SEPARATE INSULATED GROUNDING CONDUCTOR IN ALL FEEDER & BC.
- 4. PROVIDE 2-HOLE LUGS CAPABLE OF ACCEPTING MULTIPLE CRIMPS FOR ALL POWER & GROUNDING CONNECTIONS TO A BUS OR WHERE FEASIBLE. USE MANUFACTURER'S COMPRESSION TOOL WITH PROPER DIE FOR EACH CONNECTOR. MANUFACTURER'S EMBOSSED CODING SYSTEM IS REQUIRED. A UNIVERSAL OR DIE-LESS TYPE CRIMPING TOOL SHALL NOT BE USED. PROVIDE LUGS WITH INSPECTOR HOLE FOR ALL INTERIOR INSTALLATIONS. PROVIDE CLOSED LUGS (NO INSPECTION HOLE) FOR EXTERIOR OR UNDERGROUND CONNECTIONS.
- 5. FEEDER CIRCUITS, GROUND LEADS, & DEDICATED EQUIPMENT CIRCUITS SHALL NOT BE SPLICED.
- 6. VERIFY LASHING REQUIREMENTS FOR SERVICE ENTRANCE & MAIN DISTRIBUTION EQUIPMENT WITH MANUFACTURER. INSTALL LASHING PER MANUFACTURER'S REQUIREMENTS.


COMPRESSION LUG NOTES:

REFER TO SPECIFICATION SECTION 260519 & NSTD516 REGARDING REQUIREMENTS FOR A SAMPLE COMPRESSION LUG SUBMITTAL ON ALL PROJECTS. FAILURE TO PROVIDE CORRECT LUGS & SUBMIT A SAMPLE COMPRESSION LUG TO VZW PRIOR TO INSTALLATION OF ANY LUGS MAY RESULT IN REJECTION OF THE INSTALLATION & REPLACEMENT OF ALL LUGS & ASSOCIATED CABLE, WHERE REQUIRED, AT NO COST TO T-MOBILE.

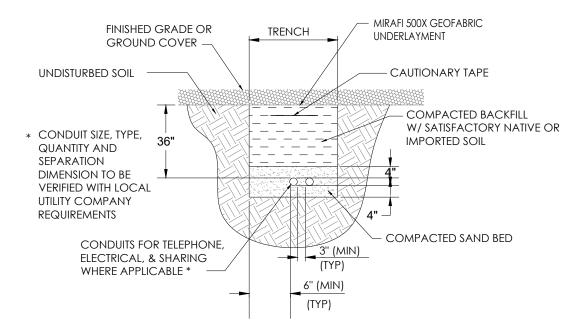

TRENCH DETAIL

SCALE: NTS

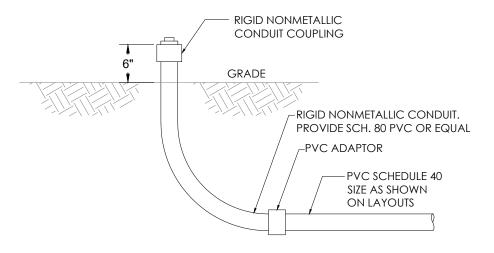

UNDERGROUND CONDUIT STUB-UP

SCALE: NTS

T - Mobile



SBA COMMUNICATIONS CORP 5900 BROKEN SOUND PKWY NV BOCA BATON FL 33487



LOCATION:

40 RAVEN ROCK RD LILLINGTON, NC 27546

SBA

MAMERS NC40177-T

T-MOBILE:

L-SPRINT RA73XC047 5RA0821A

SITE TYPE:

195' MONOPOLE T-MOBILE SPRINT KEEF

L T	T-MOBILE SPRINT KEEP	
REV	DATE	DESCRIPTION
0	12/30/20	FOR CONSTRUCTION
SI	SITE COORDINATES	

SITE COORDINATES LAT: 35.41925 LONG: -78.919083


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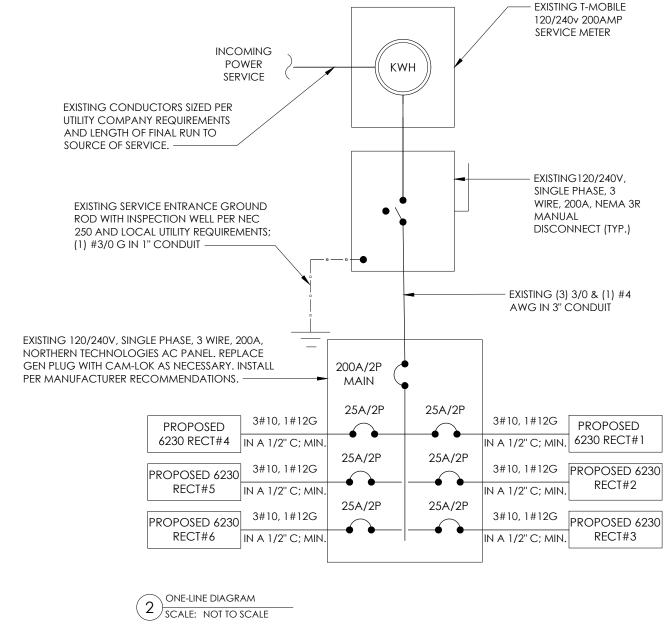
JOB#: 20ASBTMMNC-0042

ELECTRICAL DETAILS

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E-1



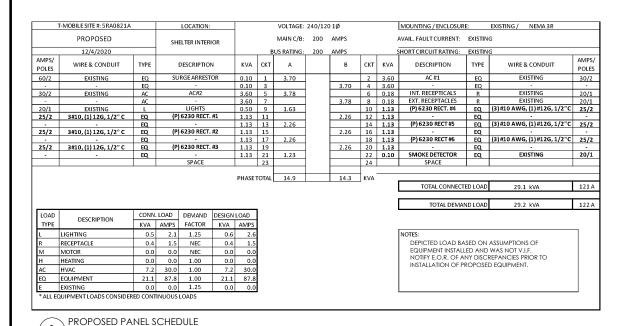

GENERAL ELECTRICAL NOTES

SCALE: NOT TO SCALE

- 1. NO SITE SPECIFIC LOAD STUDY WAS ACQUIRED. DEMAND LOADING KVA SHOWN AS ASSUMPTIONS PER MANUFACTURER SPECIFICATION DOCUMENTS & INDUSTRY STANDARD. WHEN OVERAGES ARE VERIFIED ON SITE, ALL DISCREPANCY SHALL BE BROUGHT TO THE ENGINEER OF RECORD PRIOR TO COMMENCING WORK.
- 2. ELECTRICAL SERVICE SHALL BE 200A, 240/120v, 1 P, 3W
- 3. FOR COMPLETE INTERNAL WIRING AND ARRANGEMENT, REFER TO VENDER PRINTS PROVIDED BY EQUIPMENT MANUFACTURER.
- 4. CONTRACTOR SHALL VERIFY AVAILABLE FAULT CURRENT WITH POWER COMPANY AND ENSURE ALL ELECTRICAL EQUIPMENT IS SUITABLE FOR AVAILABLE FAULT CURRENT.CONTRACTOR SHALL COORDINATE WITH UTILITY COMPANY AND CALCULATE SHORT CIRCUIT FAULT CURRENT AND ARC FLASH AND PROVIDE LABELS ON ELECTRICAL EQUIPMENT PER THE N.E.C. AND LOCAL JURISDICTION. CONTRACTOR SHALL PROVIDE EQUIPMENT RATED FOR FAULT CURRENT.
- 5. CONTRACTOR SHALL COORDINATE UTILITY SERVICES WITH LOCAL UTILITY COMPANIES. VERIFY ALL REQUIREMENTS WITH UTILITY COMPANY STANDARDS. THE MAXIMUM 12-MONTH DEMAND LOAD WAS NOT AVAILABLE AT TIME OF PRINTING. CONTRACTOR SHALL COORDINATE WITH POWER CO., OBTAIN MAXIMUM DEMAND LOAD, MULTIPLY VALUE BY 1.25, ADD ALL NEW LOADS & VERIFY NEW MAXIMUM DEMAND LOAD DOES NOT OVERLOAD ANY PORTION OF THE EXISTING ELECTRICAL SYSTEM. CONTACT EOR IF OVERLOAD IS POSSIBLE BEFORE START OF WORK.
- 6. ONE-LINE DIAGRAM IS SCHEMATIC ONLY AND NOT INDICATIVE OF ACTUAL EQUIPMENT LAYOUT. CONTRACTOR IS RESPONSIBLE FOR LOADING ON ALL PANELS AND FEEDERS PER THE N.E.C. CONTRACTOR SHALL ENSURE CONTINUITY OF EXISTING CIRCUITS TO REMAIN. ELECTRICAL CONTRACTOR SHALL VERIFY THAT ALL EXISTING AND PROPOSED LOADS PLACED ON EXISTING PANELS DO NOT EXCEED THE MAXIMUM LOADING REQUIRED PER THE LATEST EDITION OF THE N.E.C. NOTIFY EOR IF OVERLOAD IS POSSIBLE
- 7. 6230 ENCLOSURE CONFIGURATION INCLUDES (6) 3500W RECTIFIERS. LOAD PROVIDED IN PANEL SCHEDULE IS BASED ON THIS CONFIGURATION. IF ADDITIONAL RECTIFIERS ARE REQUIRED, ENGINEER OF RECORD SHALL BE CONTACTED TO DETERMINE ADEQUACY OF EXISTING PANEL FOR ADDITIONAL LOAD
- 8. CONTRACTOR SHALL FIELD VERIFY EXISTING AC PANEL MODEL AND ENSURE SUFFICIENT BREAKER SPACE IS AVAILABLE. CONTACT EOR IF DISCREPANCIES ARE FOUND.
- 9. CONTRACTOR TO FIELD VERIFY ALL EQUIPMENT RATINGS AND WIRE SIZES. IF ANY DISCREPANCIES EXIST, CONTACT ENGINEER PRIOR TO ROUGH IN.

T - Mobile-



SBA COMMUNICATIONS CORP. 5900 BROKEN SOUND PKWY NW BOCA RATON, FL 33487



LOCATION:

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T-MOBILE:

L-SPRINT RA73XC047 5RA0821A

SITE TY

195' MONOPOLE T-MOBILE SPRINT KEEP

DATE	DESCRIPTION
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SITE COORDINATES LAT: 35.41925 LONG: -78.919083


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JOB#: 20ASBTMMNC-0042




PANEL SCHEDULE & ONE-LINE DIAGRAM

E-2

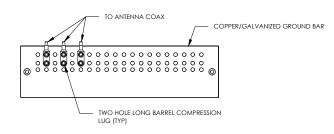


- DOUBLING UP "OR STACKING" OF CONNECTIONS IS NOT PERMITTED.
 EXTERIOR ANTIOXIDANT JOINT COMPOUND TO BE USED ON ALL EXTERIOR CONNECTIONS.
 GROUND BAR SHALL NOT BE ISOLATED FROM TOWER, MOUNT DIRECTLY TO TOWER STEEL.


ANTENNA GROUND BAR DETAIL SCALE: NOT TO SCALE

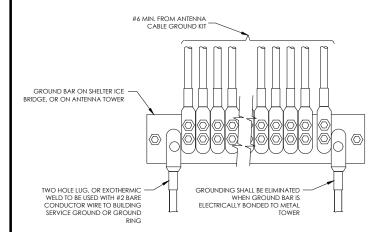

GROUNDWIRE INSTALLATION SCALE: NOT TO SCALE

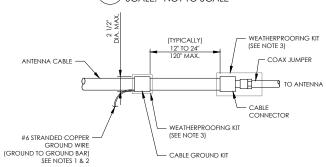


- DO NOT INSTALL CABLE GROUND KIT AT A BEND AND ALWAYS DIRECT GROUND WIRE DOWN TO GROUND BAR.
 GROUNDING KIT SHALL BE TYPE AND PART NUMBER AS SUPPLIED OR RECOMMENDED BY CABLE
- WEATHER PROOFING SHALL BE TWO-PART TAPE KIT, COLD SHRINK SHALL NOT BE USED.
 - CABLE GROUND KIT CONNECTION 6) SCALE: NOT TO SCALE

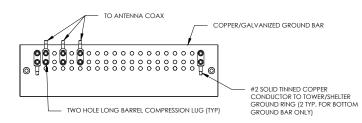

NOTES:


- EXTERIOR ANTIOXIDANT JOINT COMPOUND TO BE USED ON ALL EXTERIOR CONNECTIONS.
 GROUND BAR SHALL NOT BE ISOLATED FROM TOWER. MOUNT DIRECTLY TO TOWER STEEL (TOWER ONLY).
 GROUND BAR SHALL BE ISOLATED FROM BUILDING OR SHELTER.

TOWER/SHELTER GROUND BAR DETAIL SCALE: NOT TO SCALE

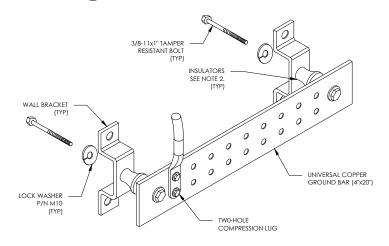


- 1. DOWN LEAD (HOME RUN) CONDUCTORS ARE <u>NOT</u> TO BE INSTALLED ON CROWN CASTLE USA INC. TOWER, PER THE GROUNDING DOWN CONDUCTOR POLICY GAS-STD-10091. NO MODIFICATION OR DRILLING TO TOWER STELL IS ALLOWED IN ANY FORM OR FASHION, CAD-WELDING ON THE TOWER AND/OR IN THE AIR ARE NOT PERMITTED.
- 2. OMIT INSULATOR WHEN MOUNTING TO TOWER STEEL OR PLATFORM STEEL USE INSULATORS WHEN ATTACHING TO BUILDING OR SHELTERS.

GROUND BAR DETAIL SCALE: NOT TO SCALE

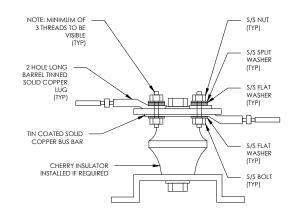


LUG DETAIL SCALE: NOT TO SCALE


WIRE SIZE	BURNDY LUG	BOLT SIZE
#6 GREEN INSULATED	YA6C-2TC38	3/8" - 16 NC SS 2 BOLT
#2 SOLID TINNED	YA3C-2TC38	3/8" - 16 NC SS 2 BOLT
#2 STRANDED	YA2C-2TC38	3/8" - 16 NC SS 2 BOLT
#2/0 STRANDED	YA26-2TC38	3/8" - 16 NC SS 2 BOLT
#4/0 STRANDED	YA28-2N	1/2" - 16 NC SS 2 BOLT

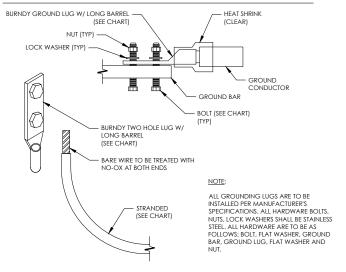


MECHANICAL LUG CONNECTION 3) SCALE: NOT TO SCALE

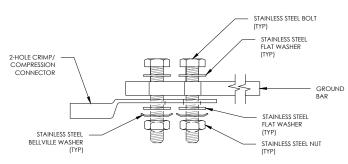

SINGLE CONNECTOR AT GROUND BARS

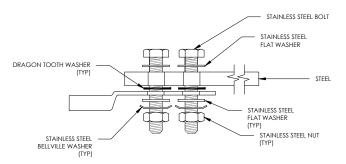

SINGLE CONNECTOR AT STEEL OBJECTS

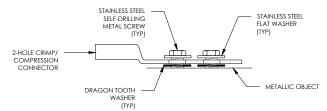

SINGLE CONNECTOR AT METALLIC/STEEL OBJECTS

HARDWARE DETAIL FOR EXTERIOR CONNECTIONS (8) SCALE: NOT TO SCALE

T - Mobile-



SBA COMMUNICATIONS CORP. 5900 BROKEN SOUND PKWY NW BOCA RATON, FL 33487



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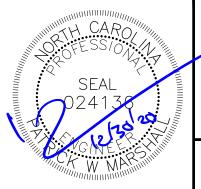
195' MONOPOLE T-MOBILE SPRINT KEEP

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GROUNDING DETAILS

G-1