




REAR ELEVATION

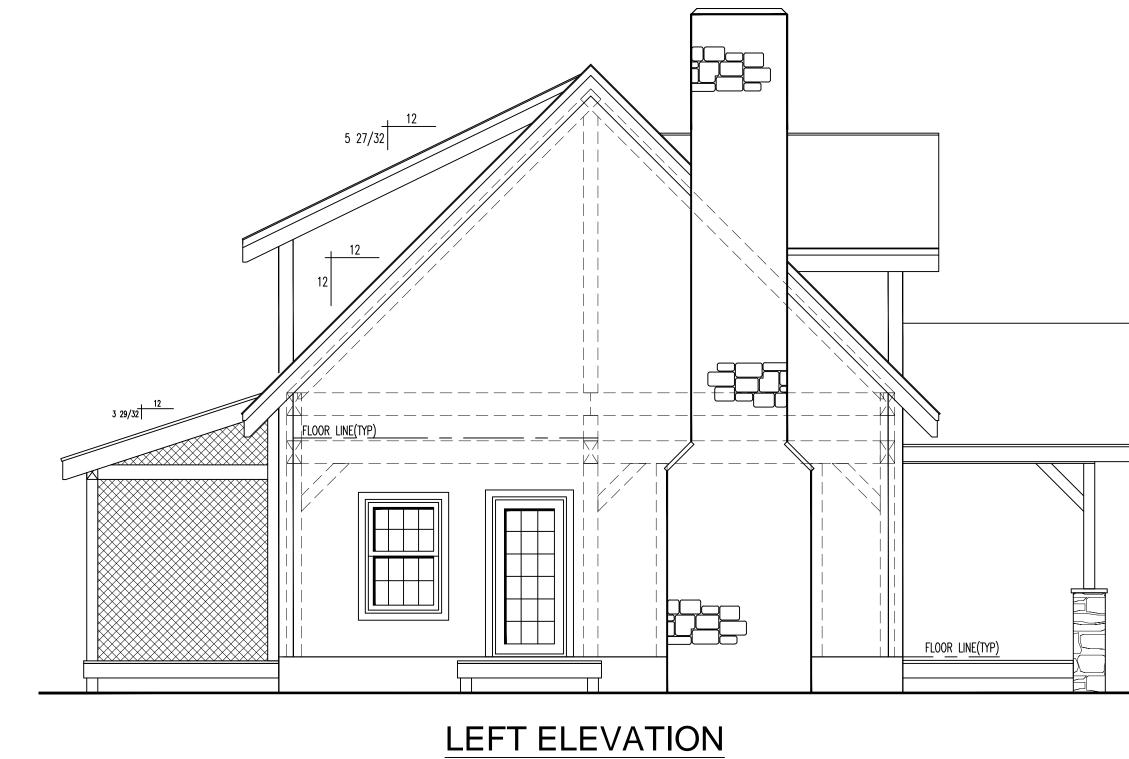


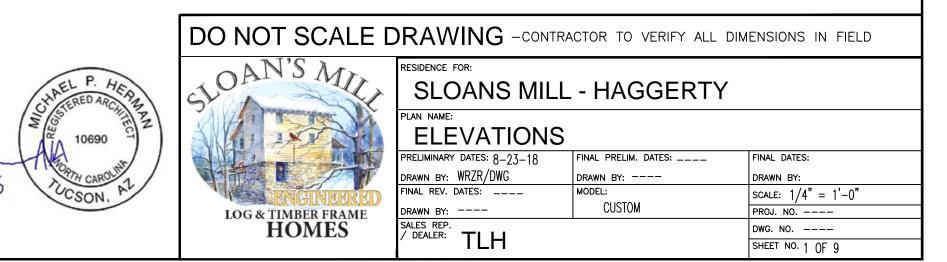

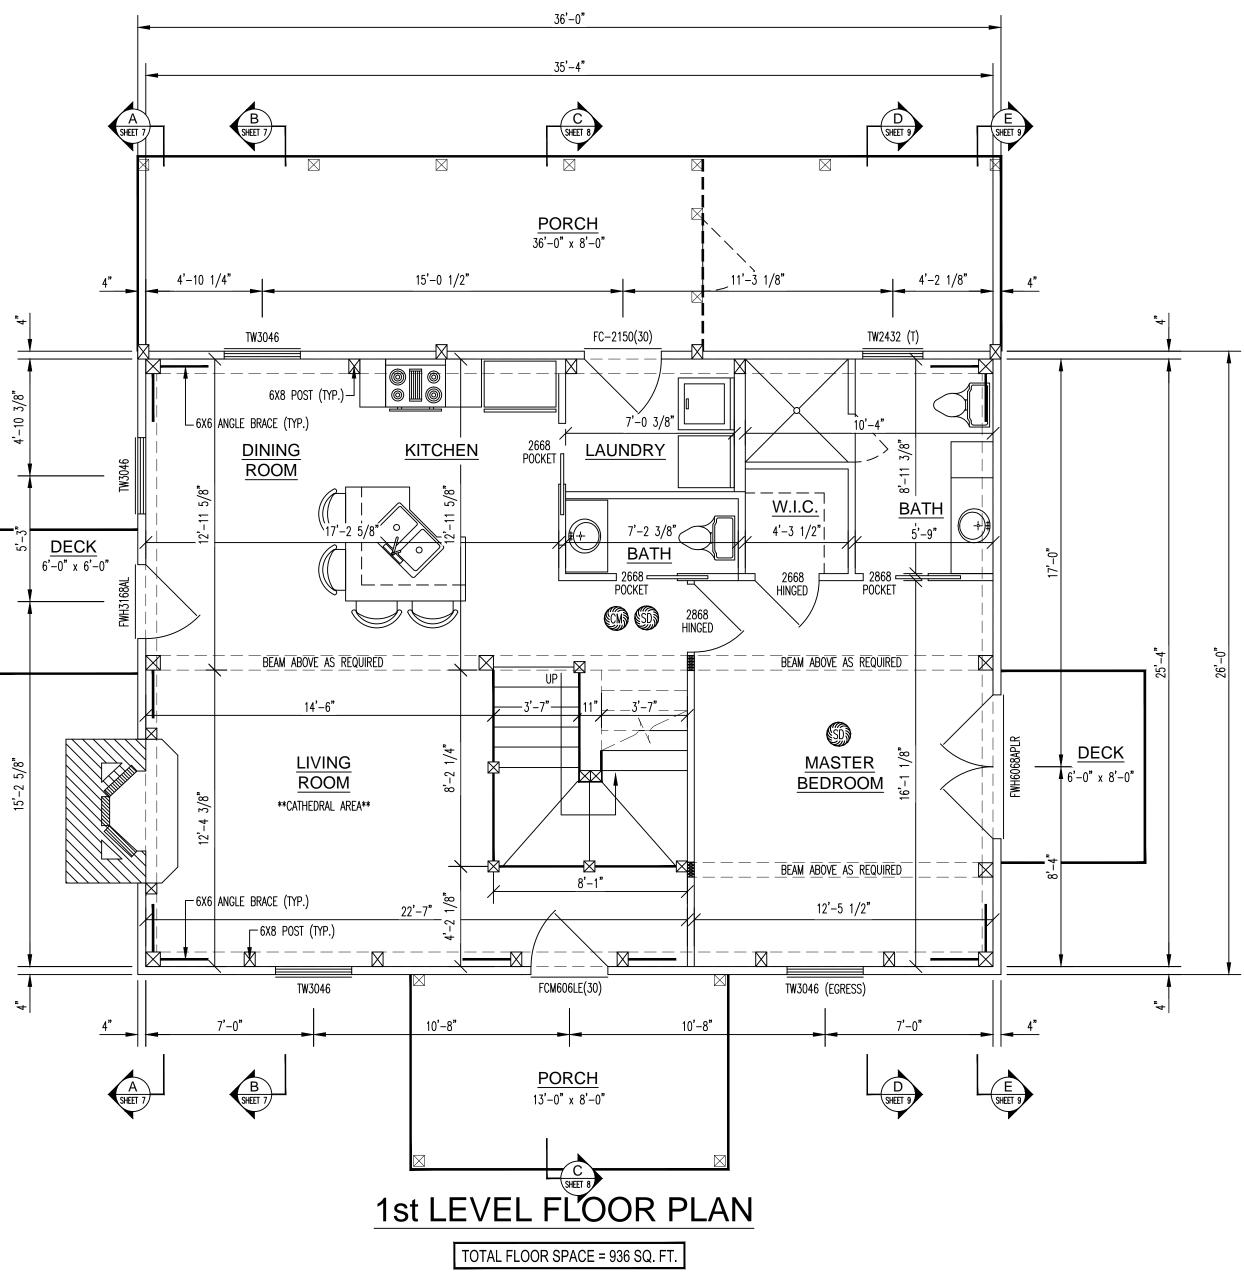

WINDOW & DOOR SCHEDULE					
MODEL #	QTY	ROUGH OPENING	DESCRIPTION	COMMENTS	
FWH3168AL	1	3'-1" x 6'-8"	ANDERSEN FRENCHWOOD HINGED PATIO DOOR	BY OTHERS	
FWH6068APLR	1	6'-0" x 6'-8"	ANDERSEN FRENCHWOOD HINGED PATIO DOOR	BY OTHERS	
FC-2150(30)	1	3'-2 1/2" x 6'-10 1/2"	THERMA-TRU FIBER-CLASSIC ENTRY DOOR	BY OTHERS	
FCM606LE(30)	1	3'-2 1/2" x 6'-10 1/2"	THERMA-TRU FIBER-CLASSIC MAHOGANY ENTRY DOOR	BY OTHERS	
TW2432 (T)	1	2'-6 1/8" x 3'-4 7/8"	ANDERSEN DOUBLE-HUNG WINDOW (TEMPERED)	BY OTHERS	
TW3046	4	3'-2 1/8" x 4'-8 7/8"	ANDERSEN DOUBLE-HUNG WINDOW	BY OTHERS	
CXW135	3	3'-0 1/2" x 3'-5 3/8"	ANDERSEN CASEMENT WINDOW (EGRESS HARDWARE REQ'D)	BY OTHERS	
2668	1	2'-8" x 6'-10"	RAISED PANEL WHITE PINE IHINGED DOOR	BY OTHERS	
2868	4	2'-10" x 6'-10"	RAISED PANEL WHITE PINE HINGED DOOR	BY OTHERS	
2668	2	SEE POCKET DOOR FRAME R.O.	RAISED PANEL WHITE PINE POCKET DOOR	BY OTHERS	
2668	2	5'-1" X 7'-0 1/2"	POCKET DOOR FRAME AND HARDWARE	BY OTHERS	
2868	1	SEE POCKET DOOR FRAME R.O.	RAISED PANEL WHITE PINE POCKET DOOR	BY OTHERS	
2868	1	5'-5" X 7'-0 1/2"	POCKET DOOR FRAME AND HARDWARE	BY OTHERS	
3068	2	3'-2" x 6'-10"	RAISED PANEL WHITE PINE BI-FOLD DOOR	BY OTHERS	

LOCATE THE FOLLOWING NUME
FRAMED WALLS
- (3) THREE AT DOUBLE DOOR
- (2) TWO AT SINGLE DOORS AN

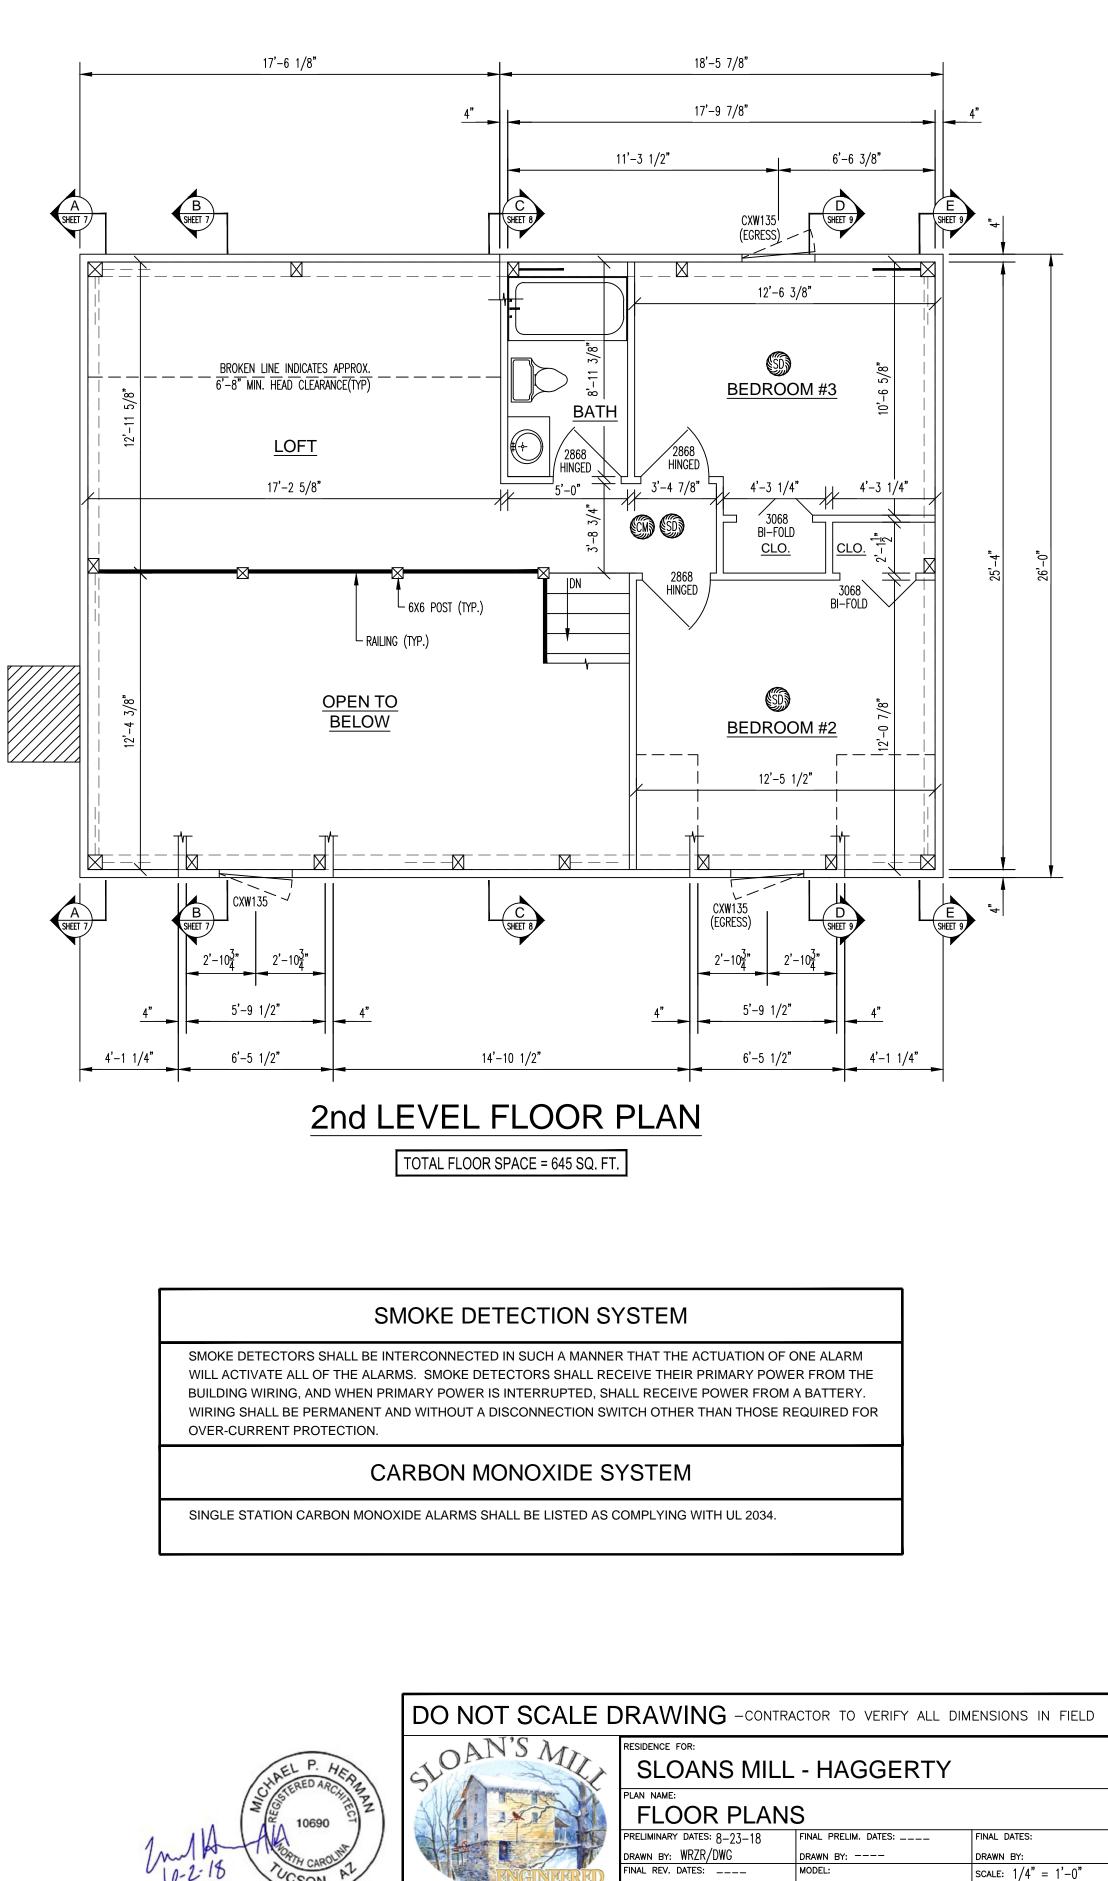

CUSTOM

PROJ. NO. ----

DWG. NO. ----SHEET NO. 2 OF 9


drawn by: ----sales rep. / dealer: TLH


LOG & TIMBER FRAME HOMES


WINDOW/DOOR FRAMING

UMBER OF FULL HEIGHT STUDS BESIDE JACK STUDS @ EACH END OF OPENINGS IN

S AND WINDOWS

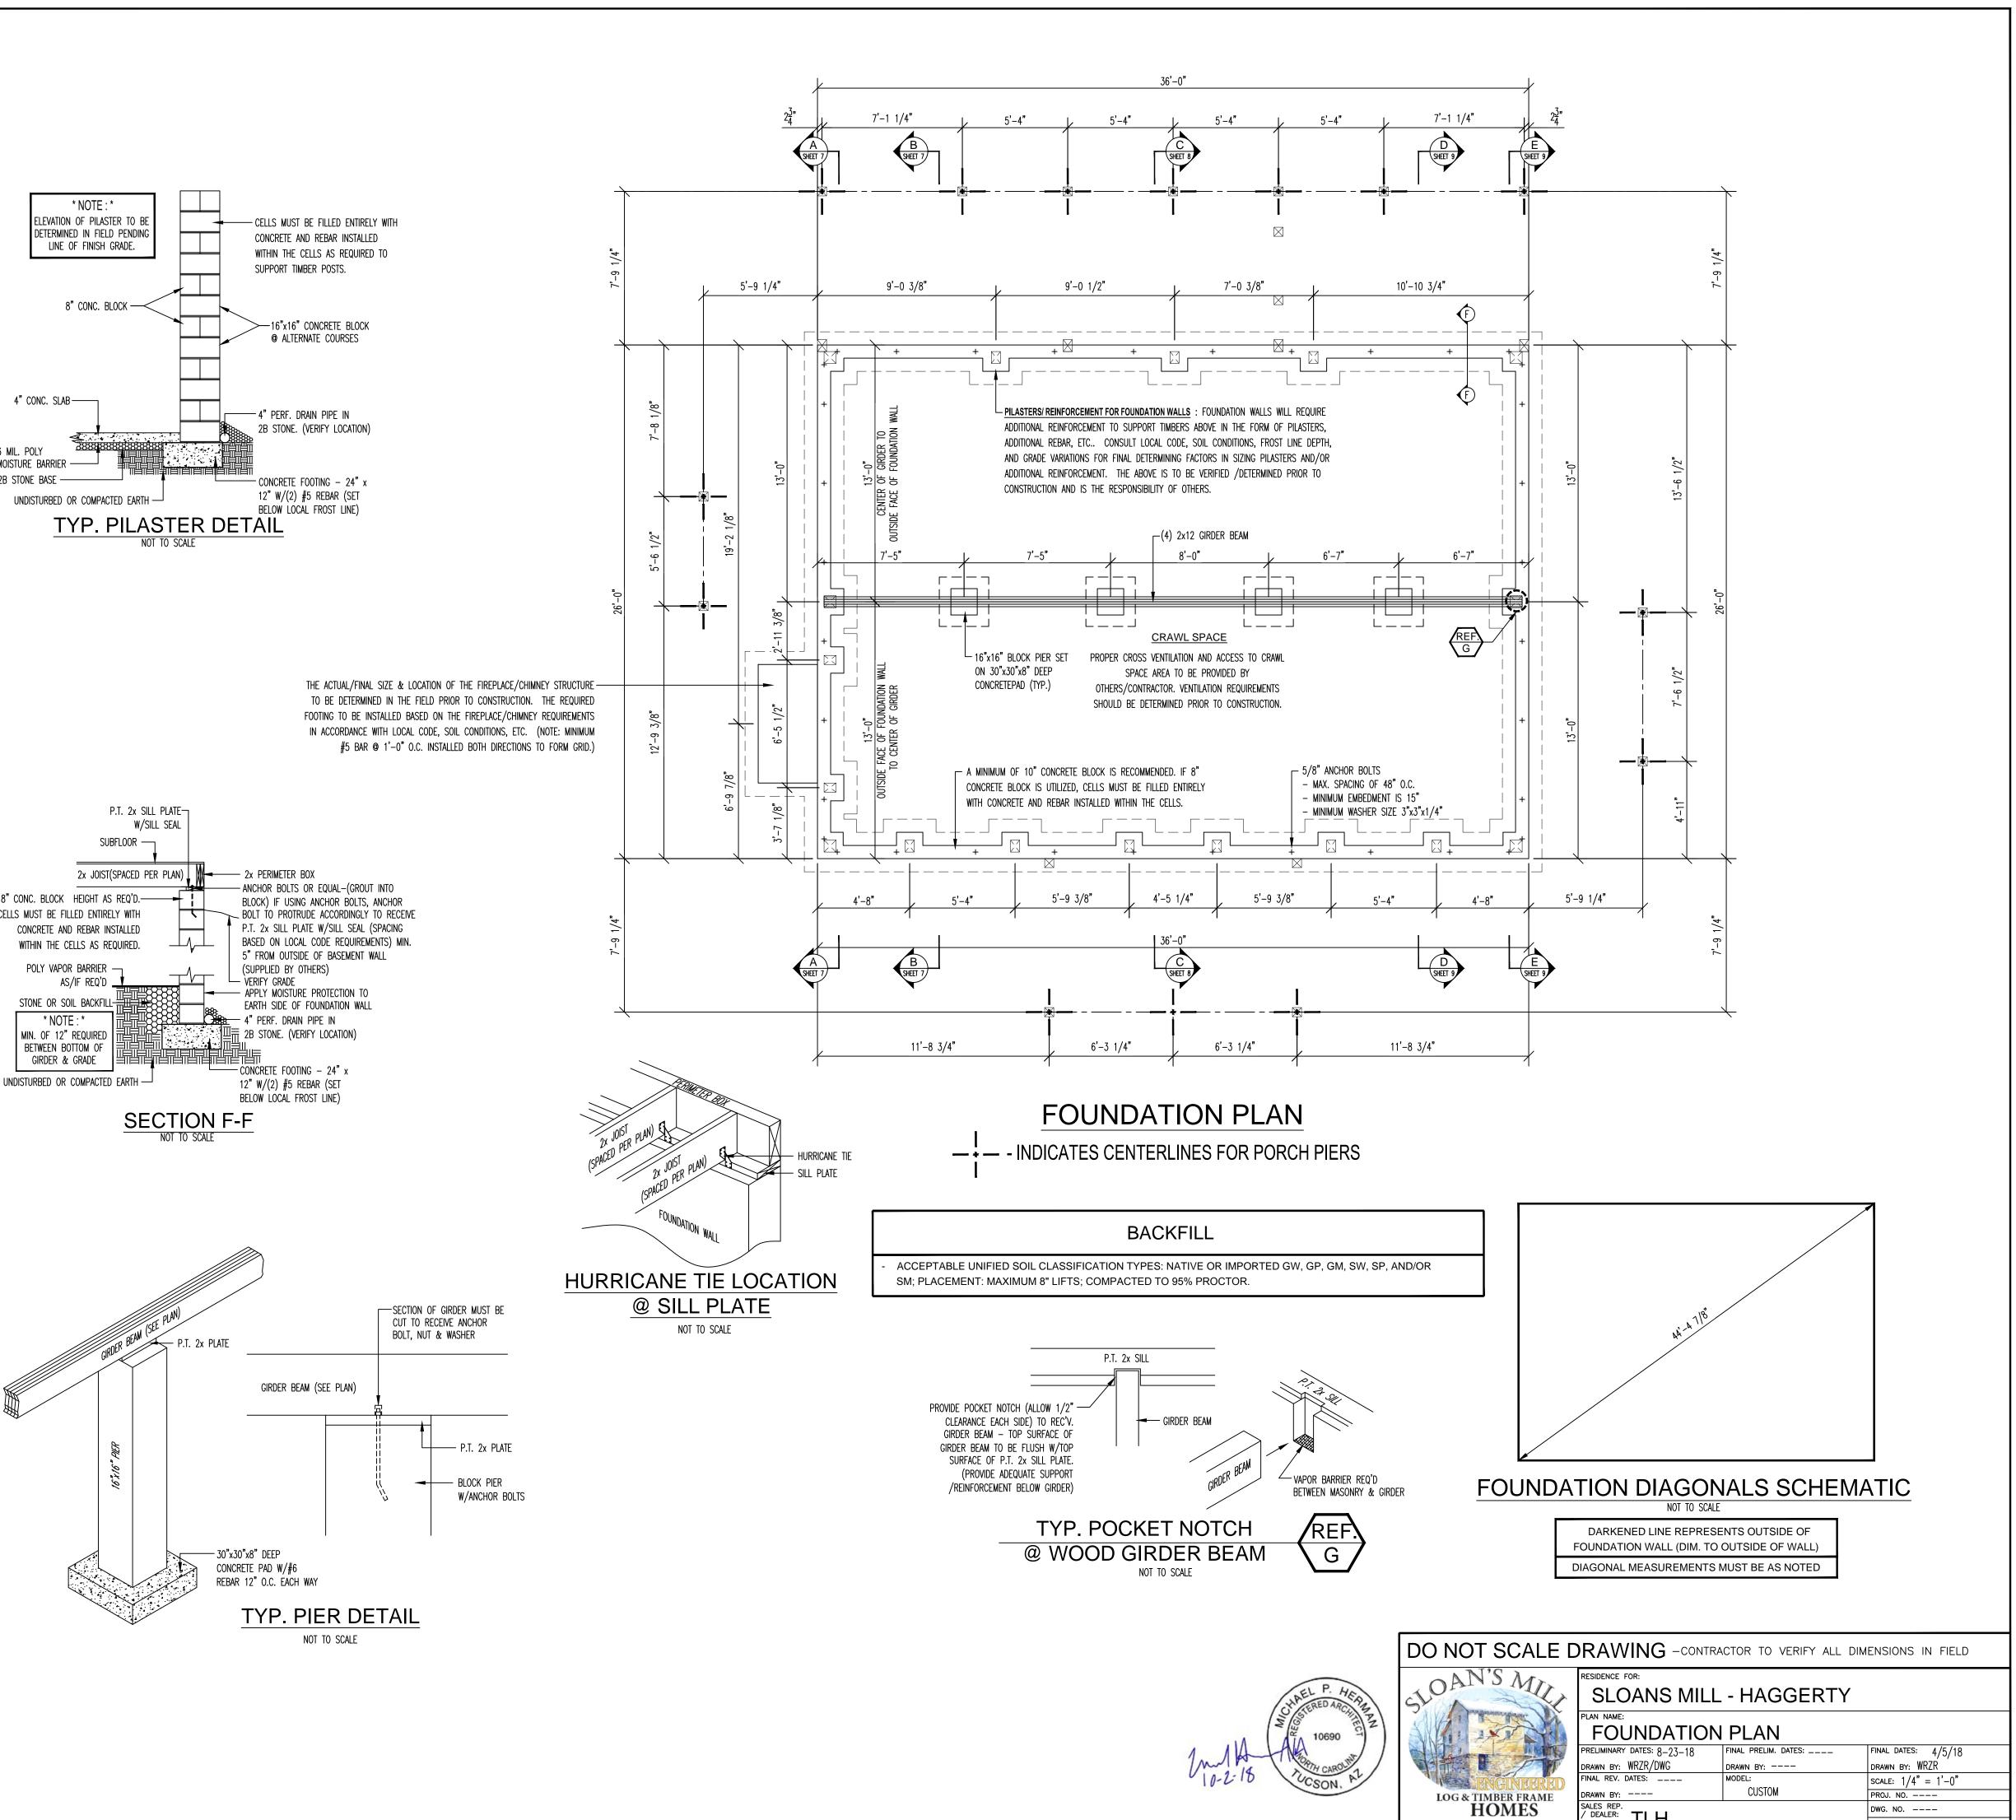


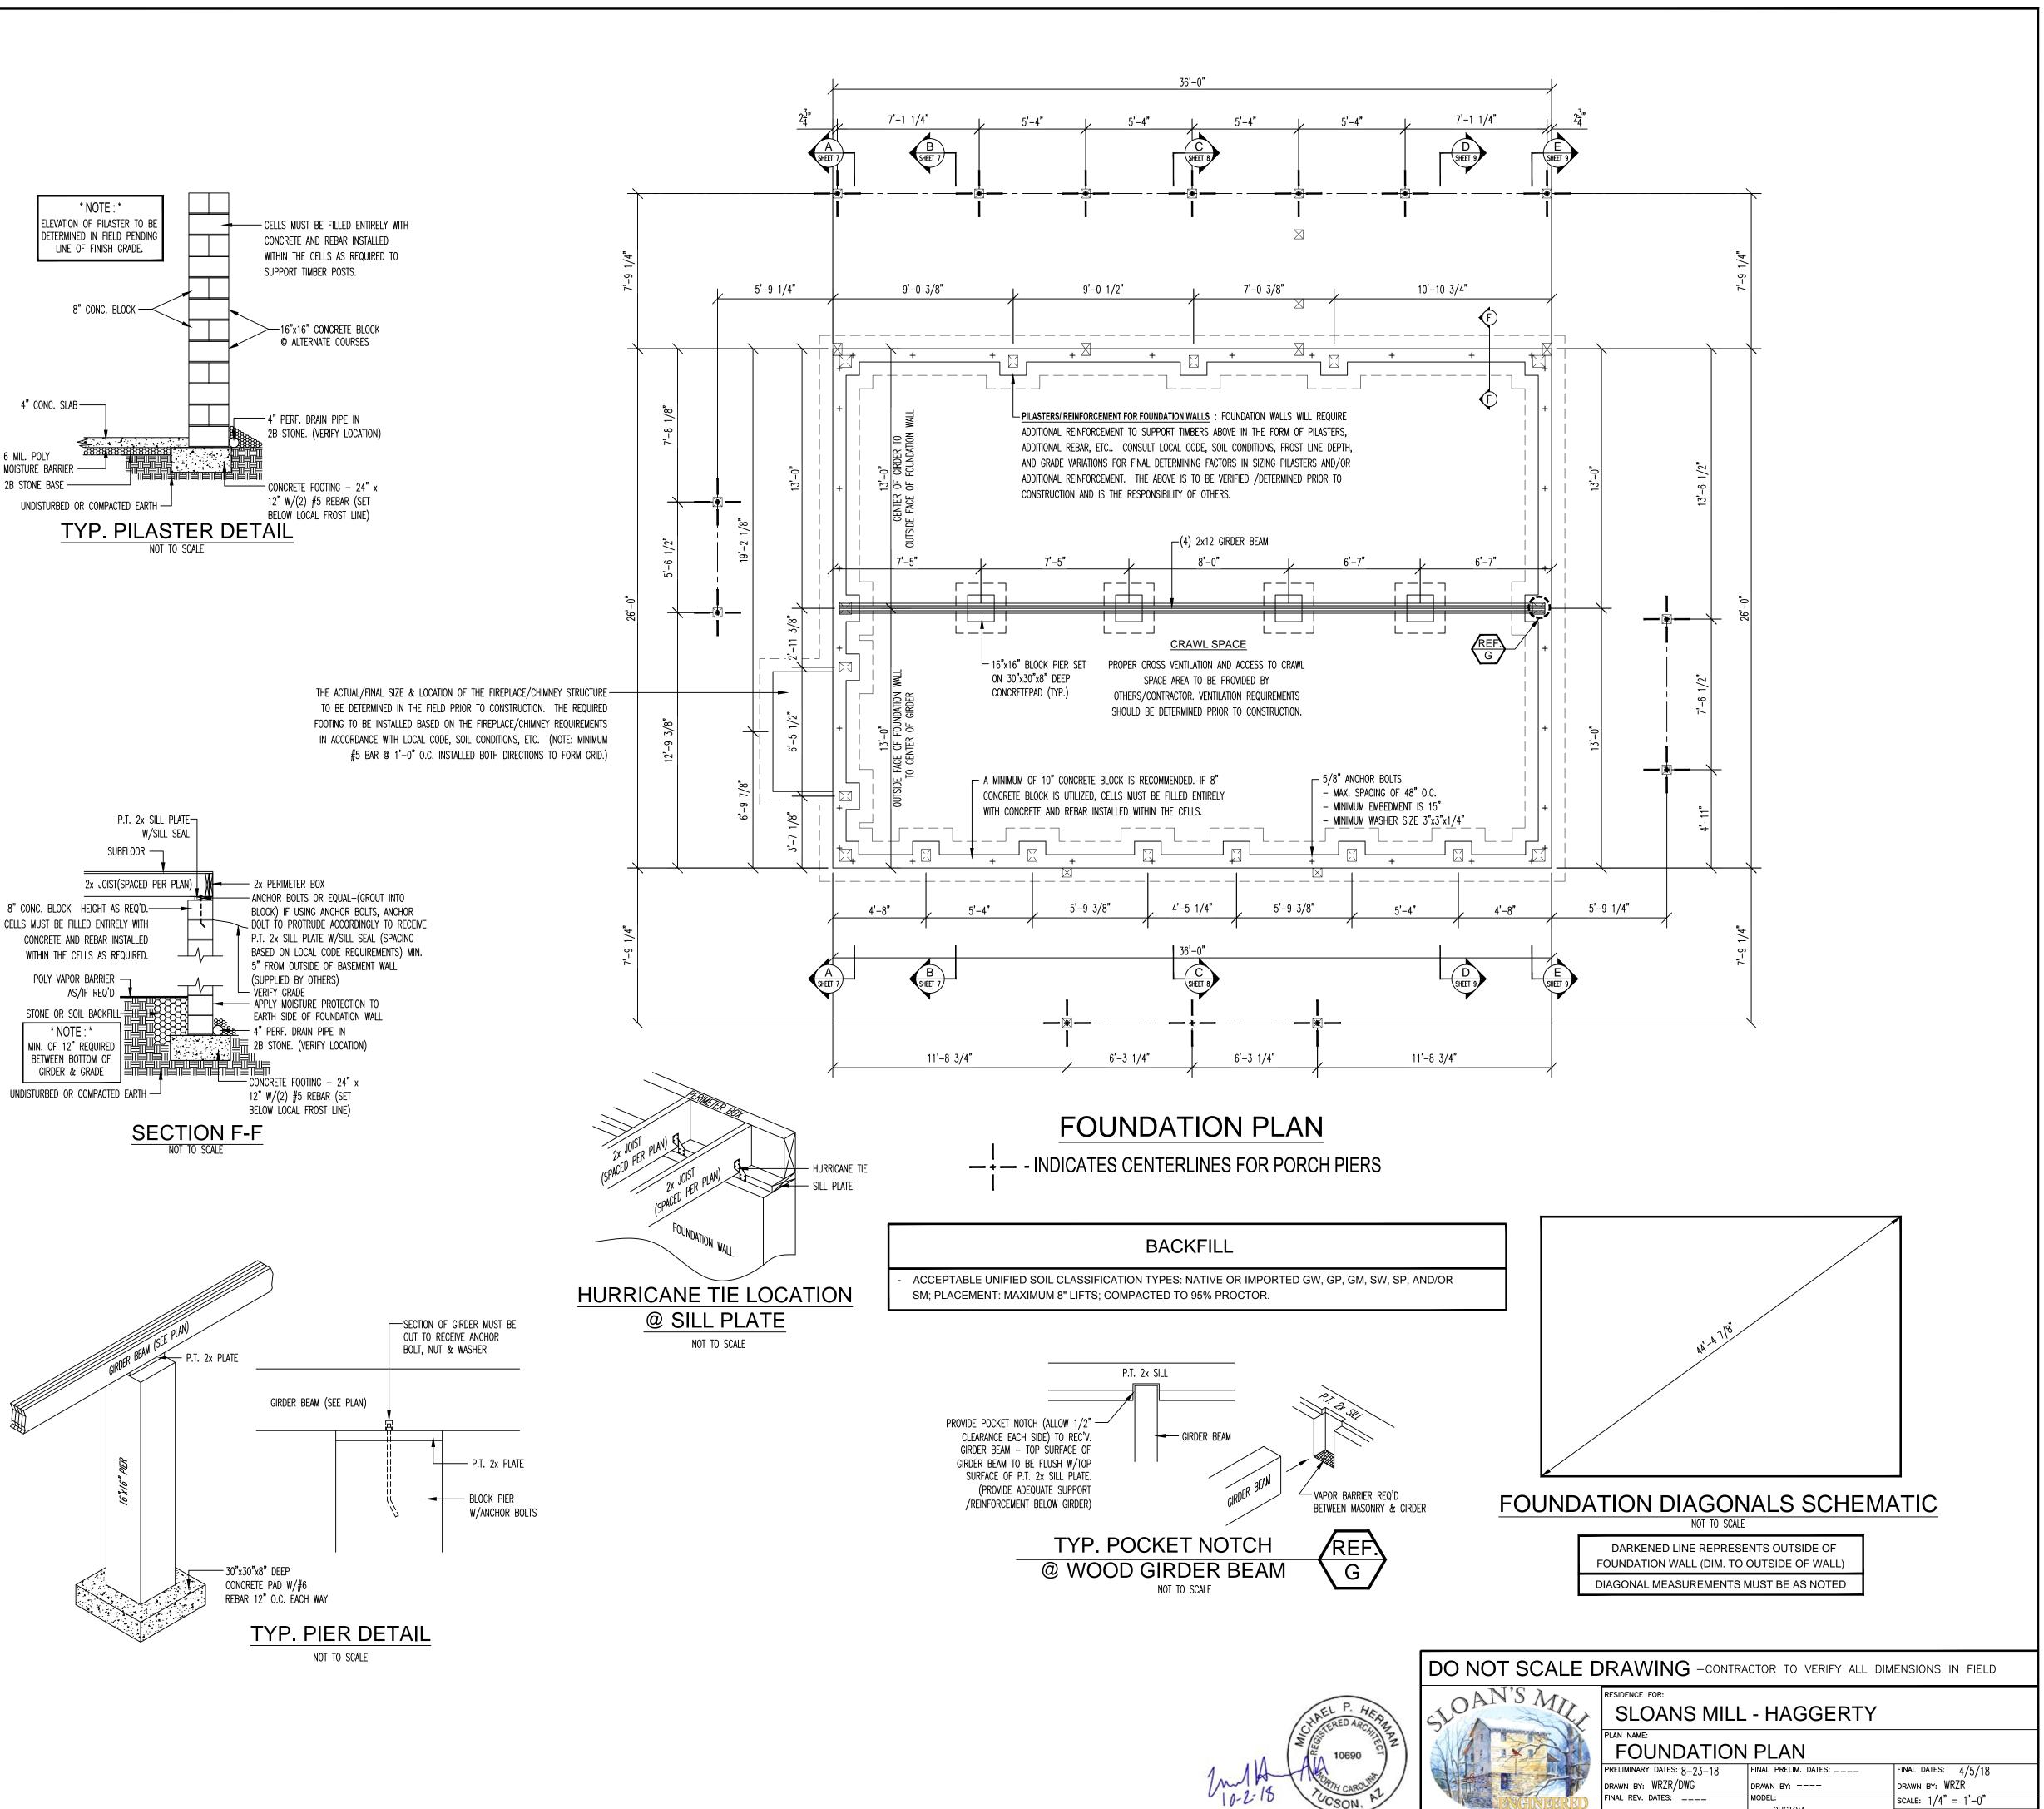


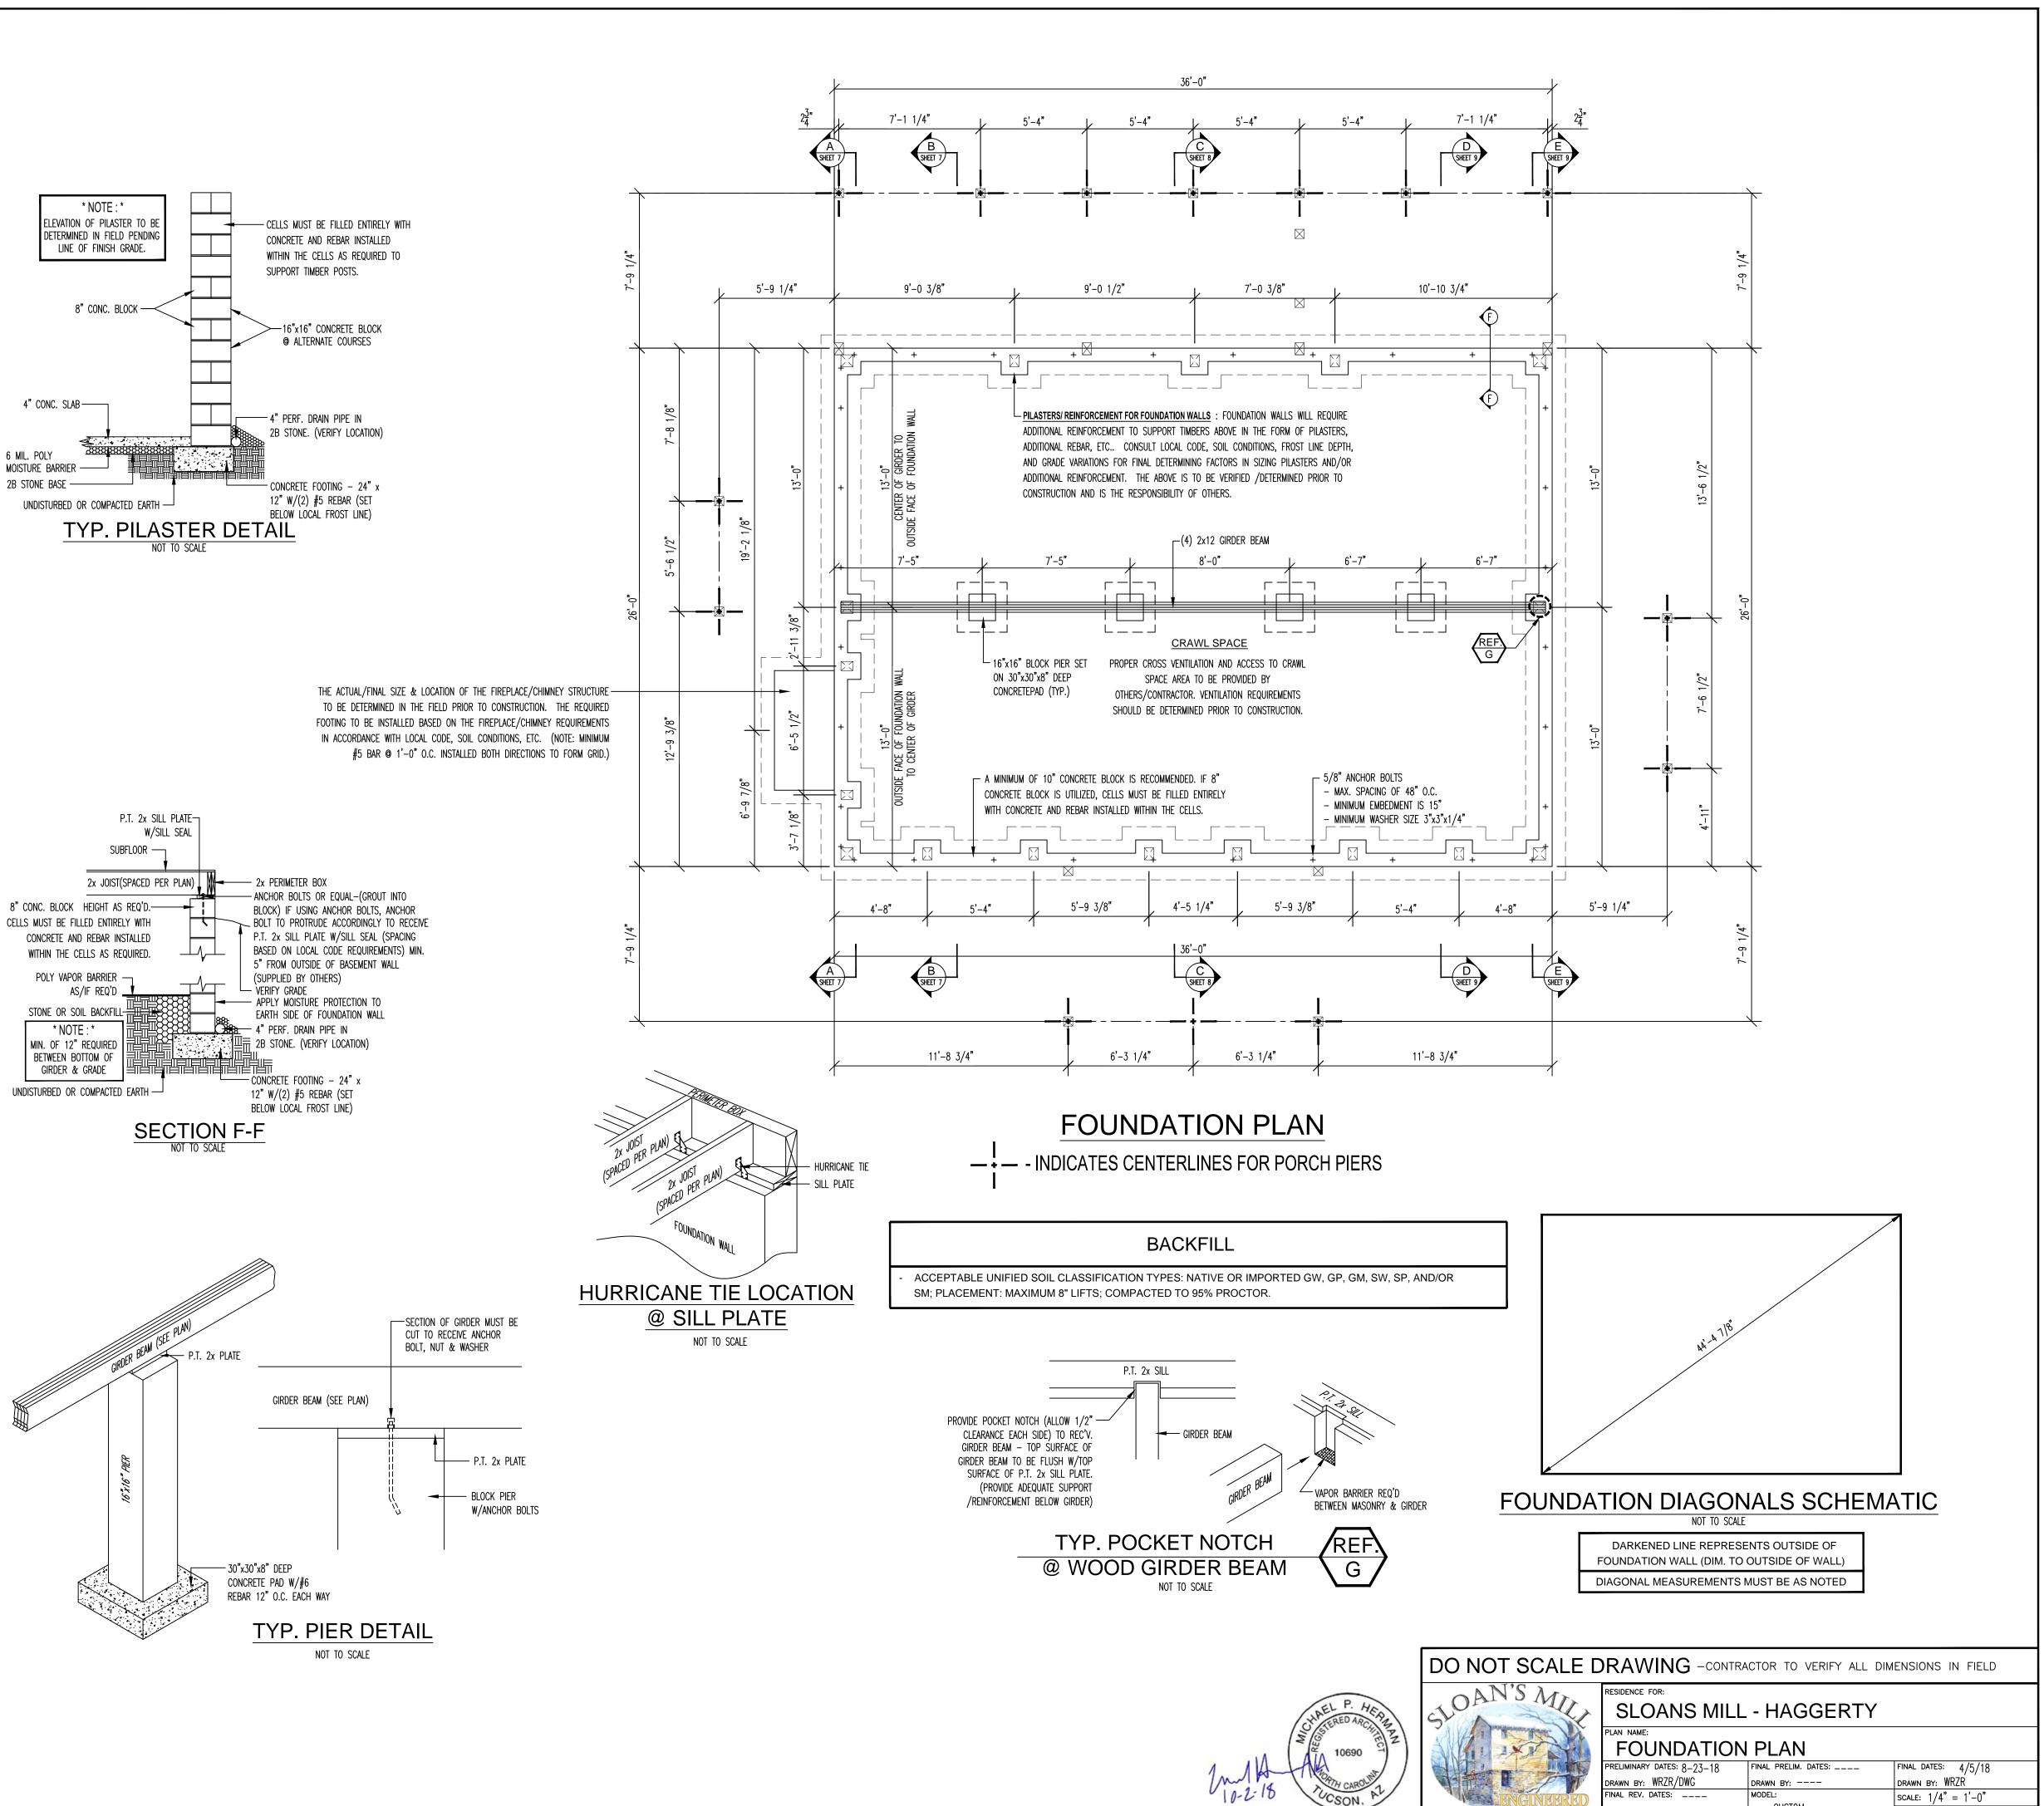



SALES REP. / DEALER: TLH

DWG. NO. ----SHEET NO. 3 OF 9

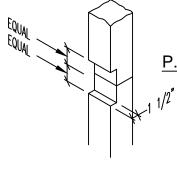


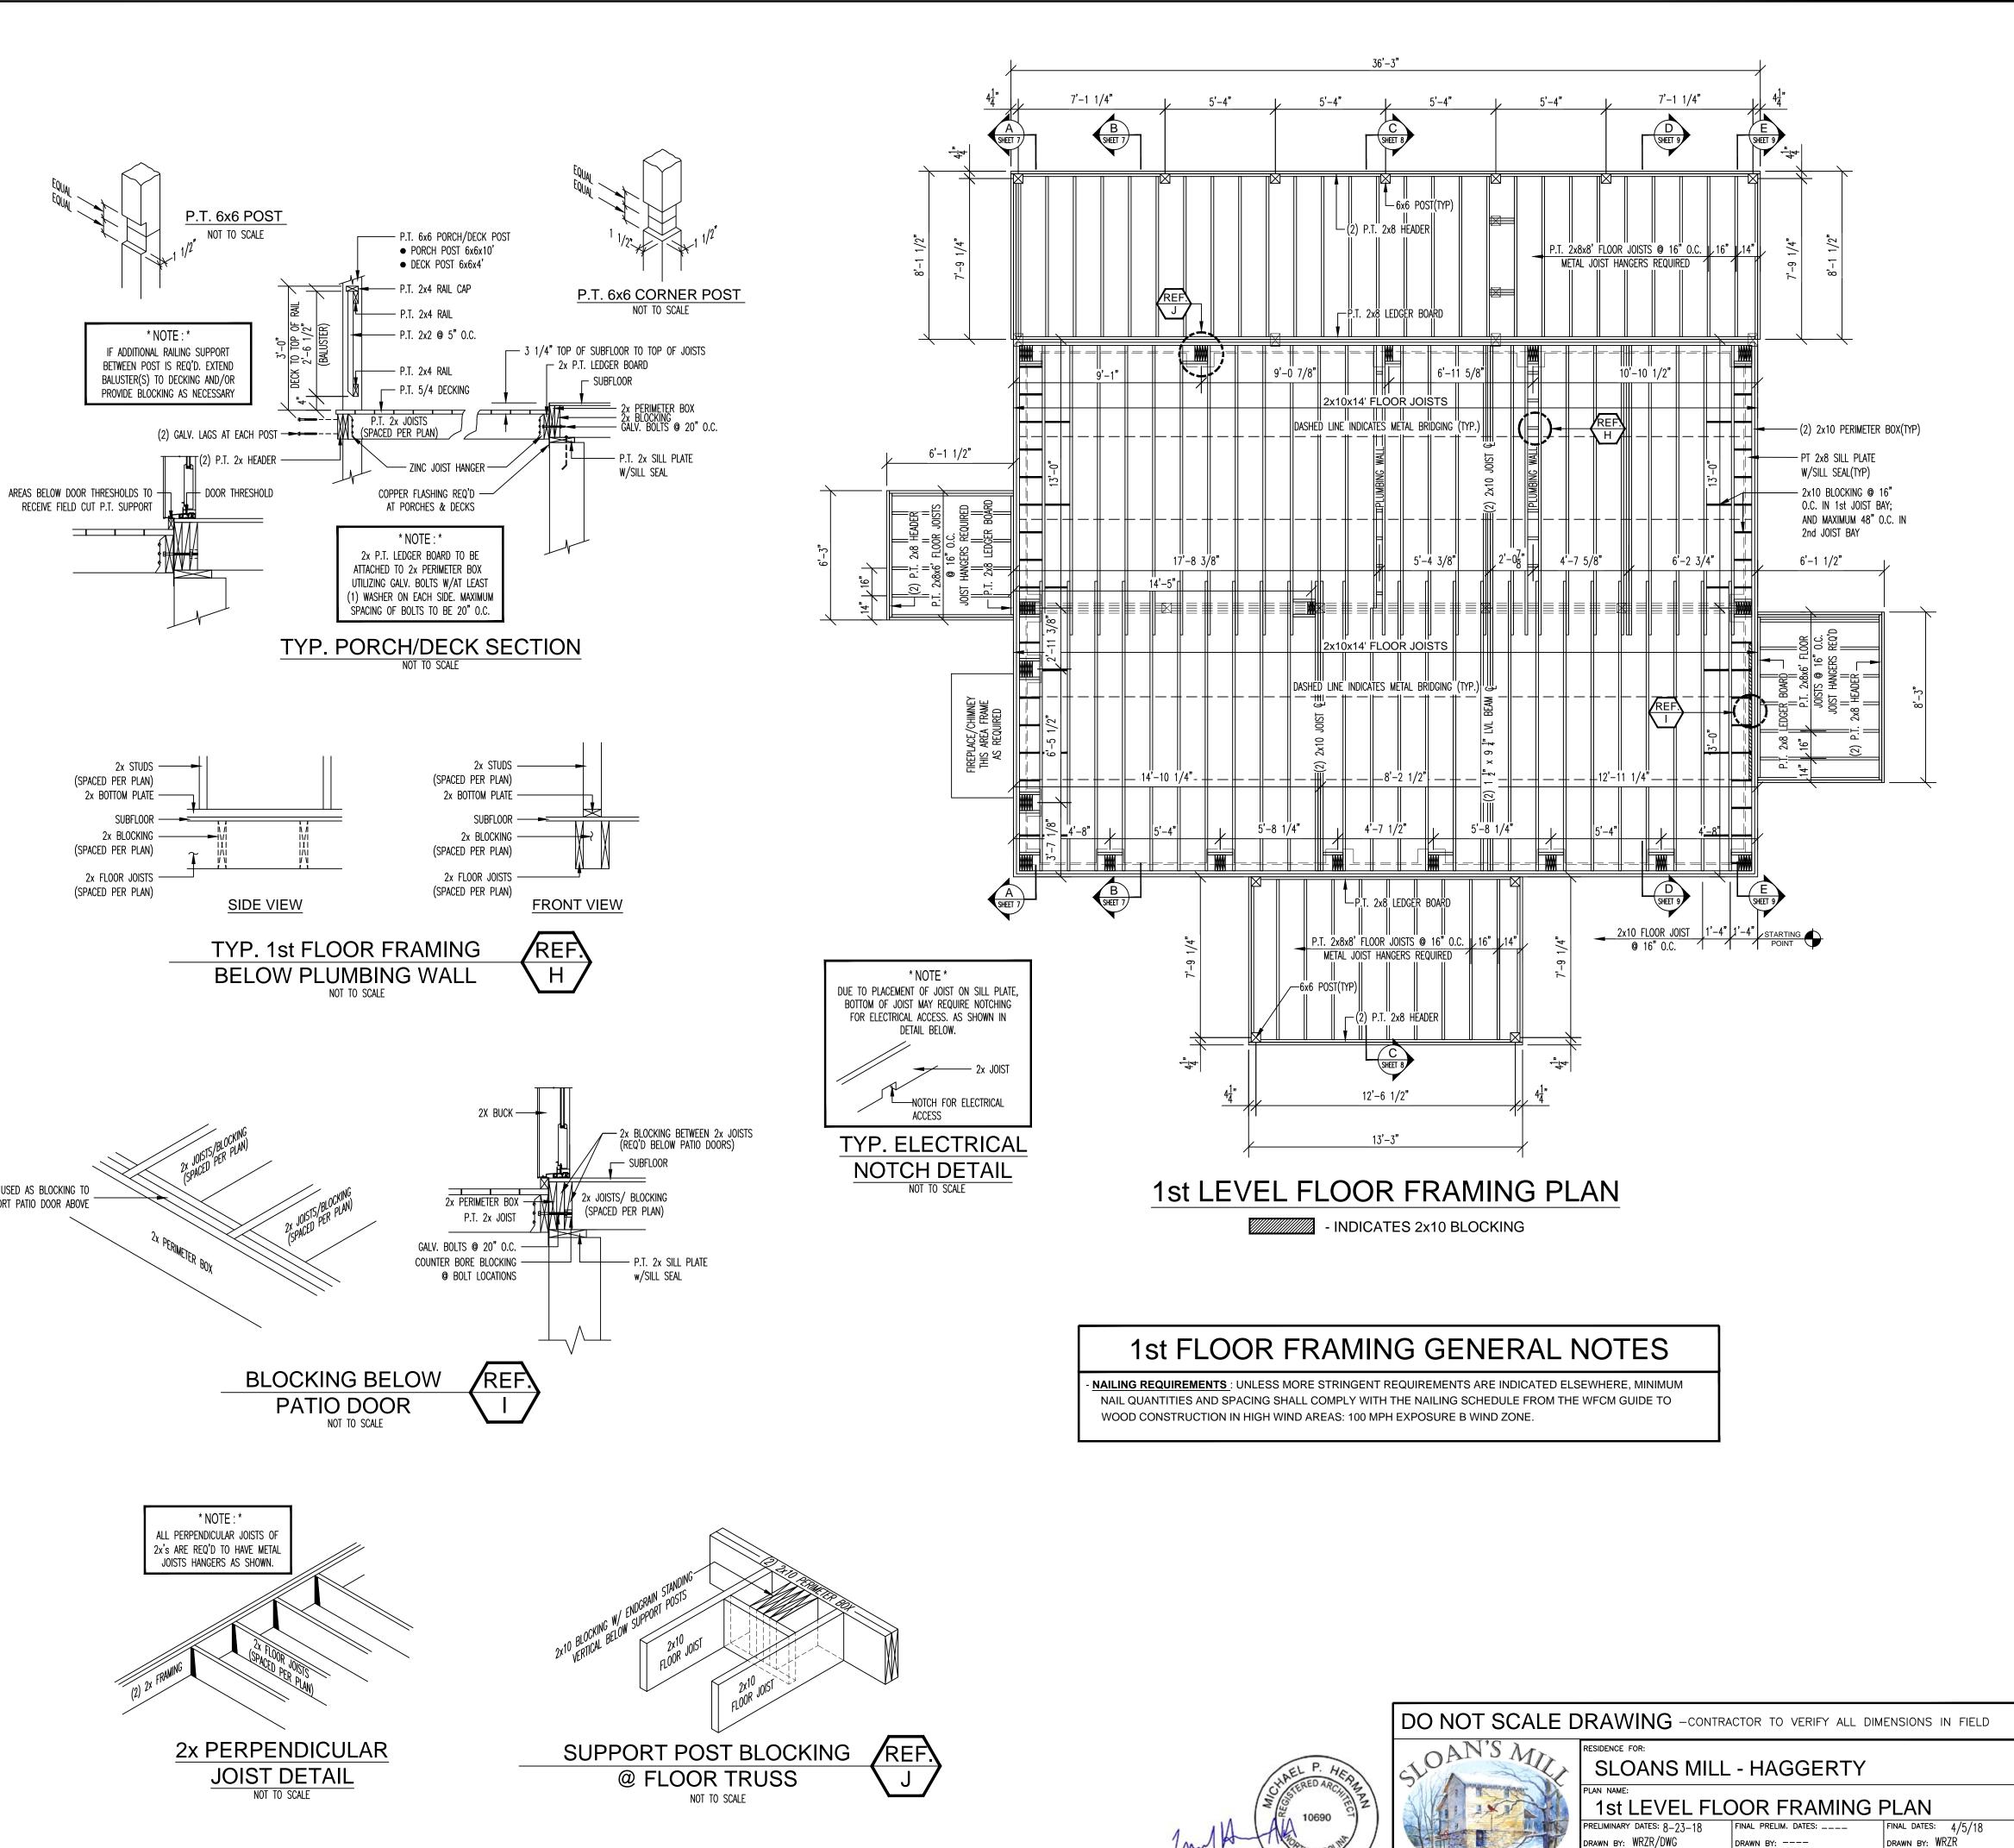

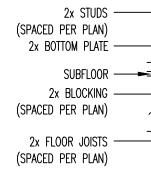

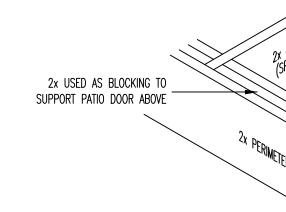



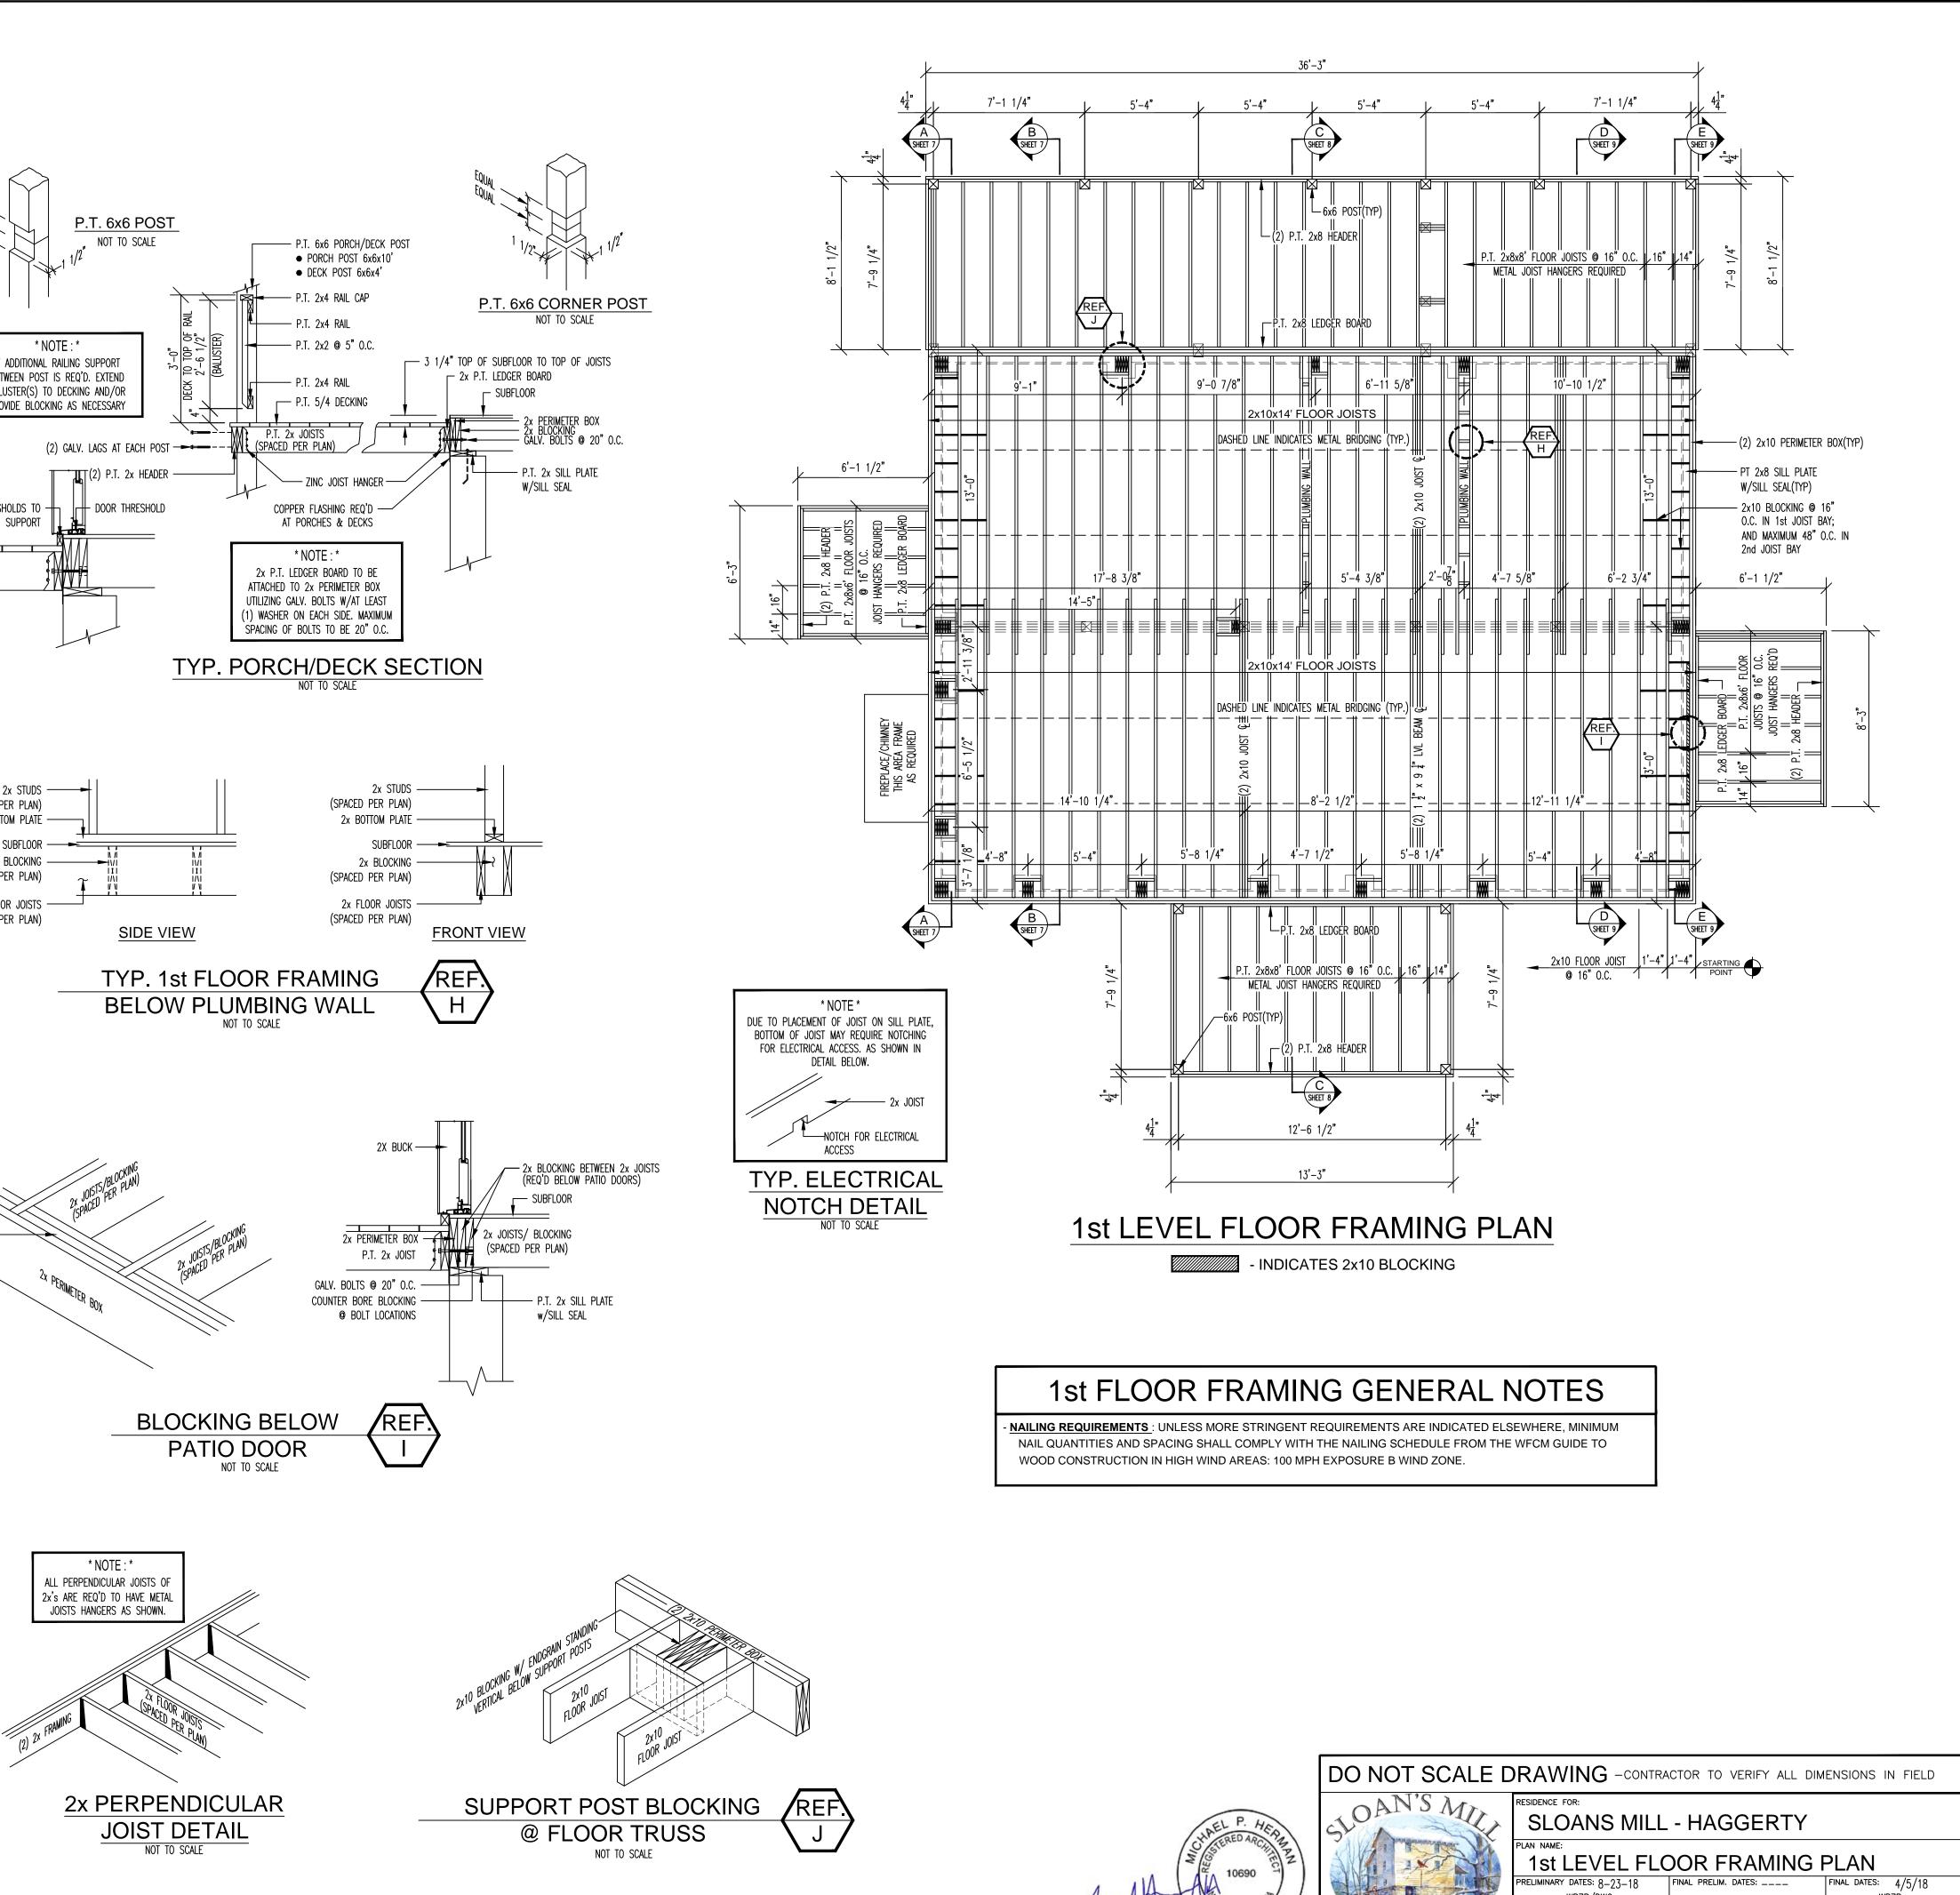

INAL REV. DATES: ____

drawn by: ----sales rep. / dealer: TLH


LOG & TIMBER FRAME HOMES


CUSTOM

SCALE: 1/4" = 1'-0"


PROJ. NO. ----


DWG. NO. ----SHEET NO. 4 OF 9

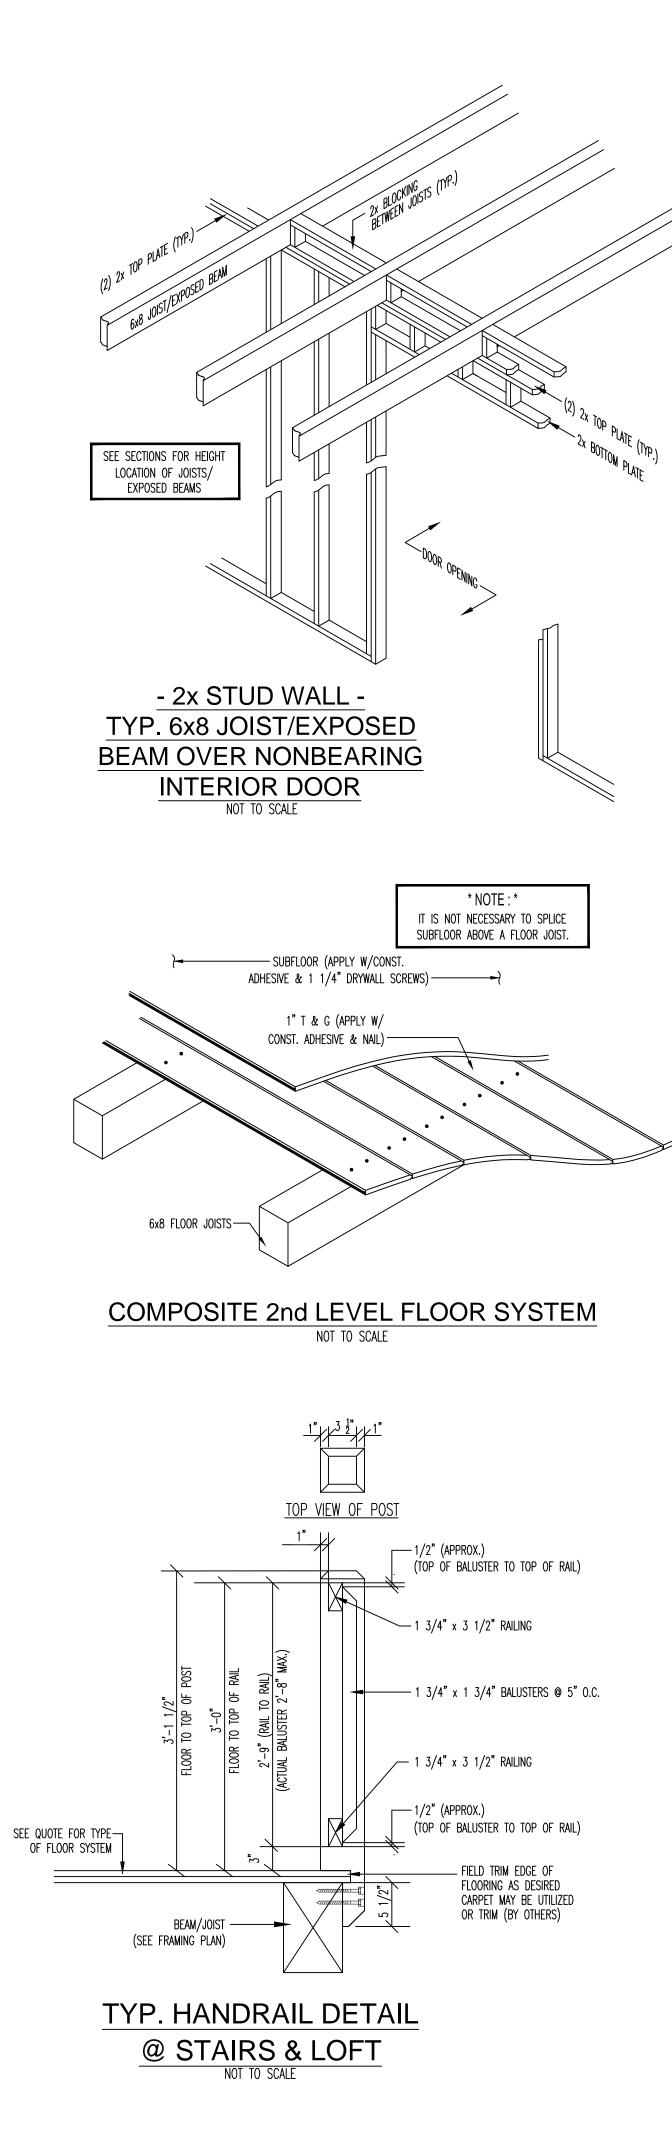

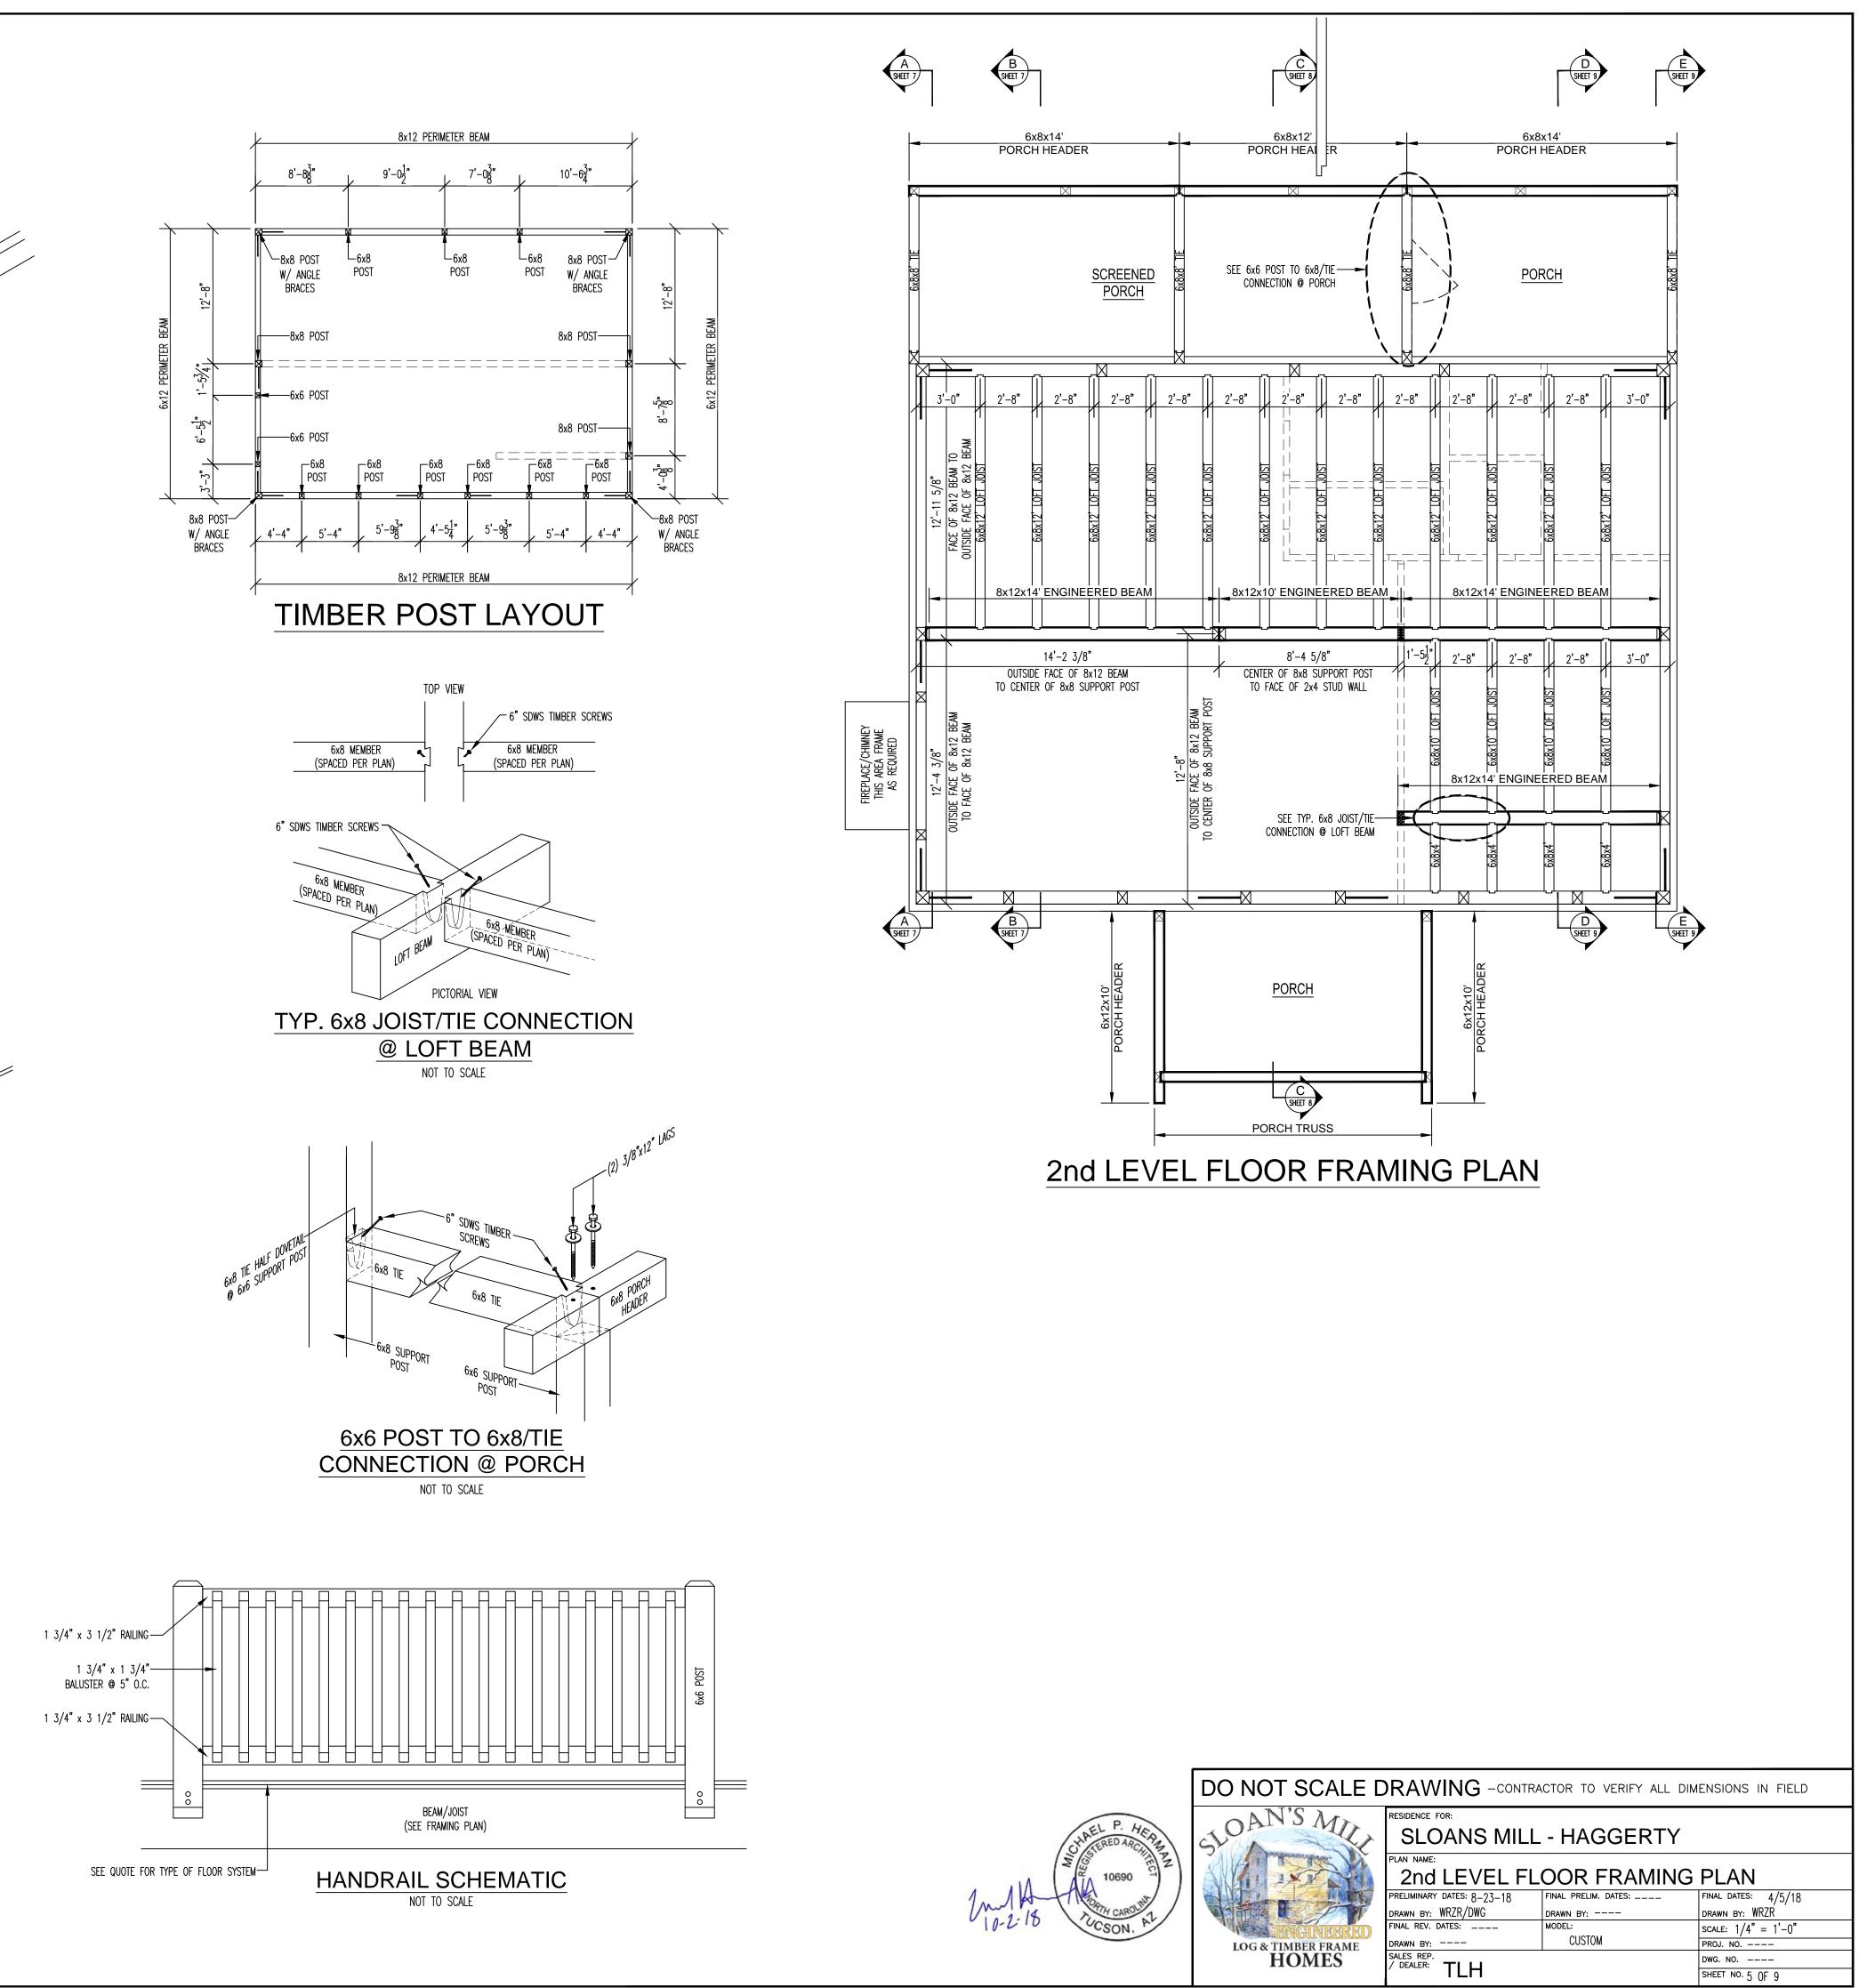



1" T&G SOFFIT — 6x8x2'-0" BRACE · **@** 4'-0" 0.C.

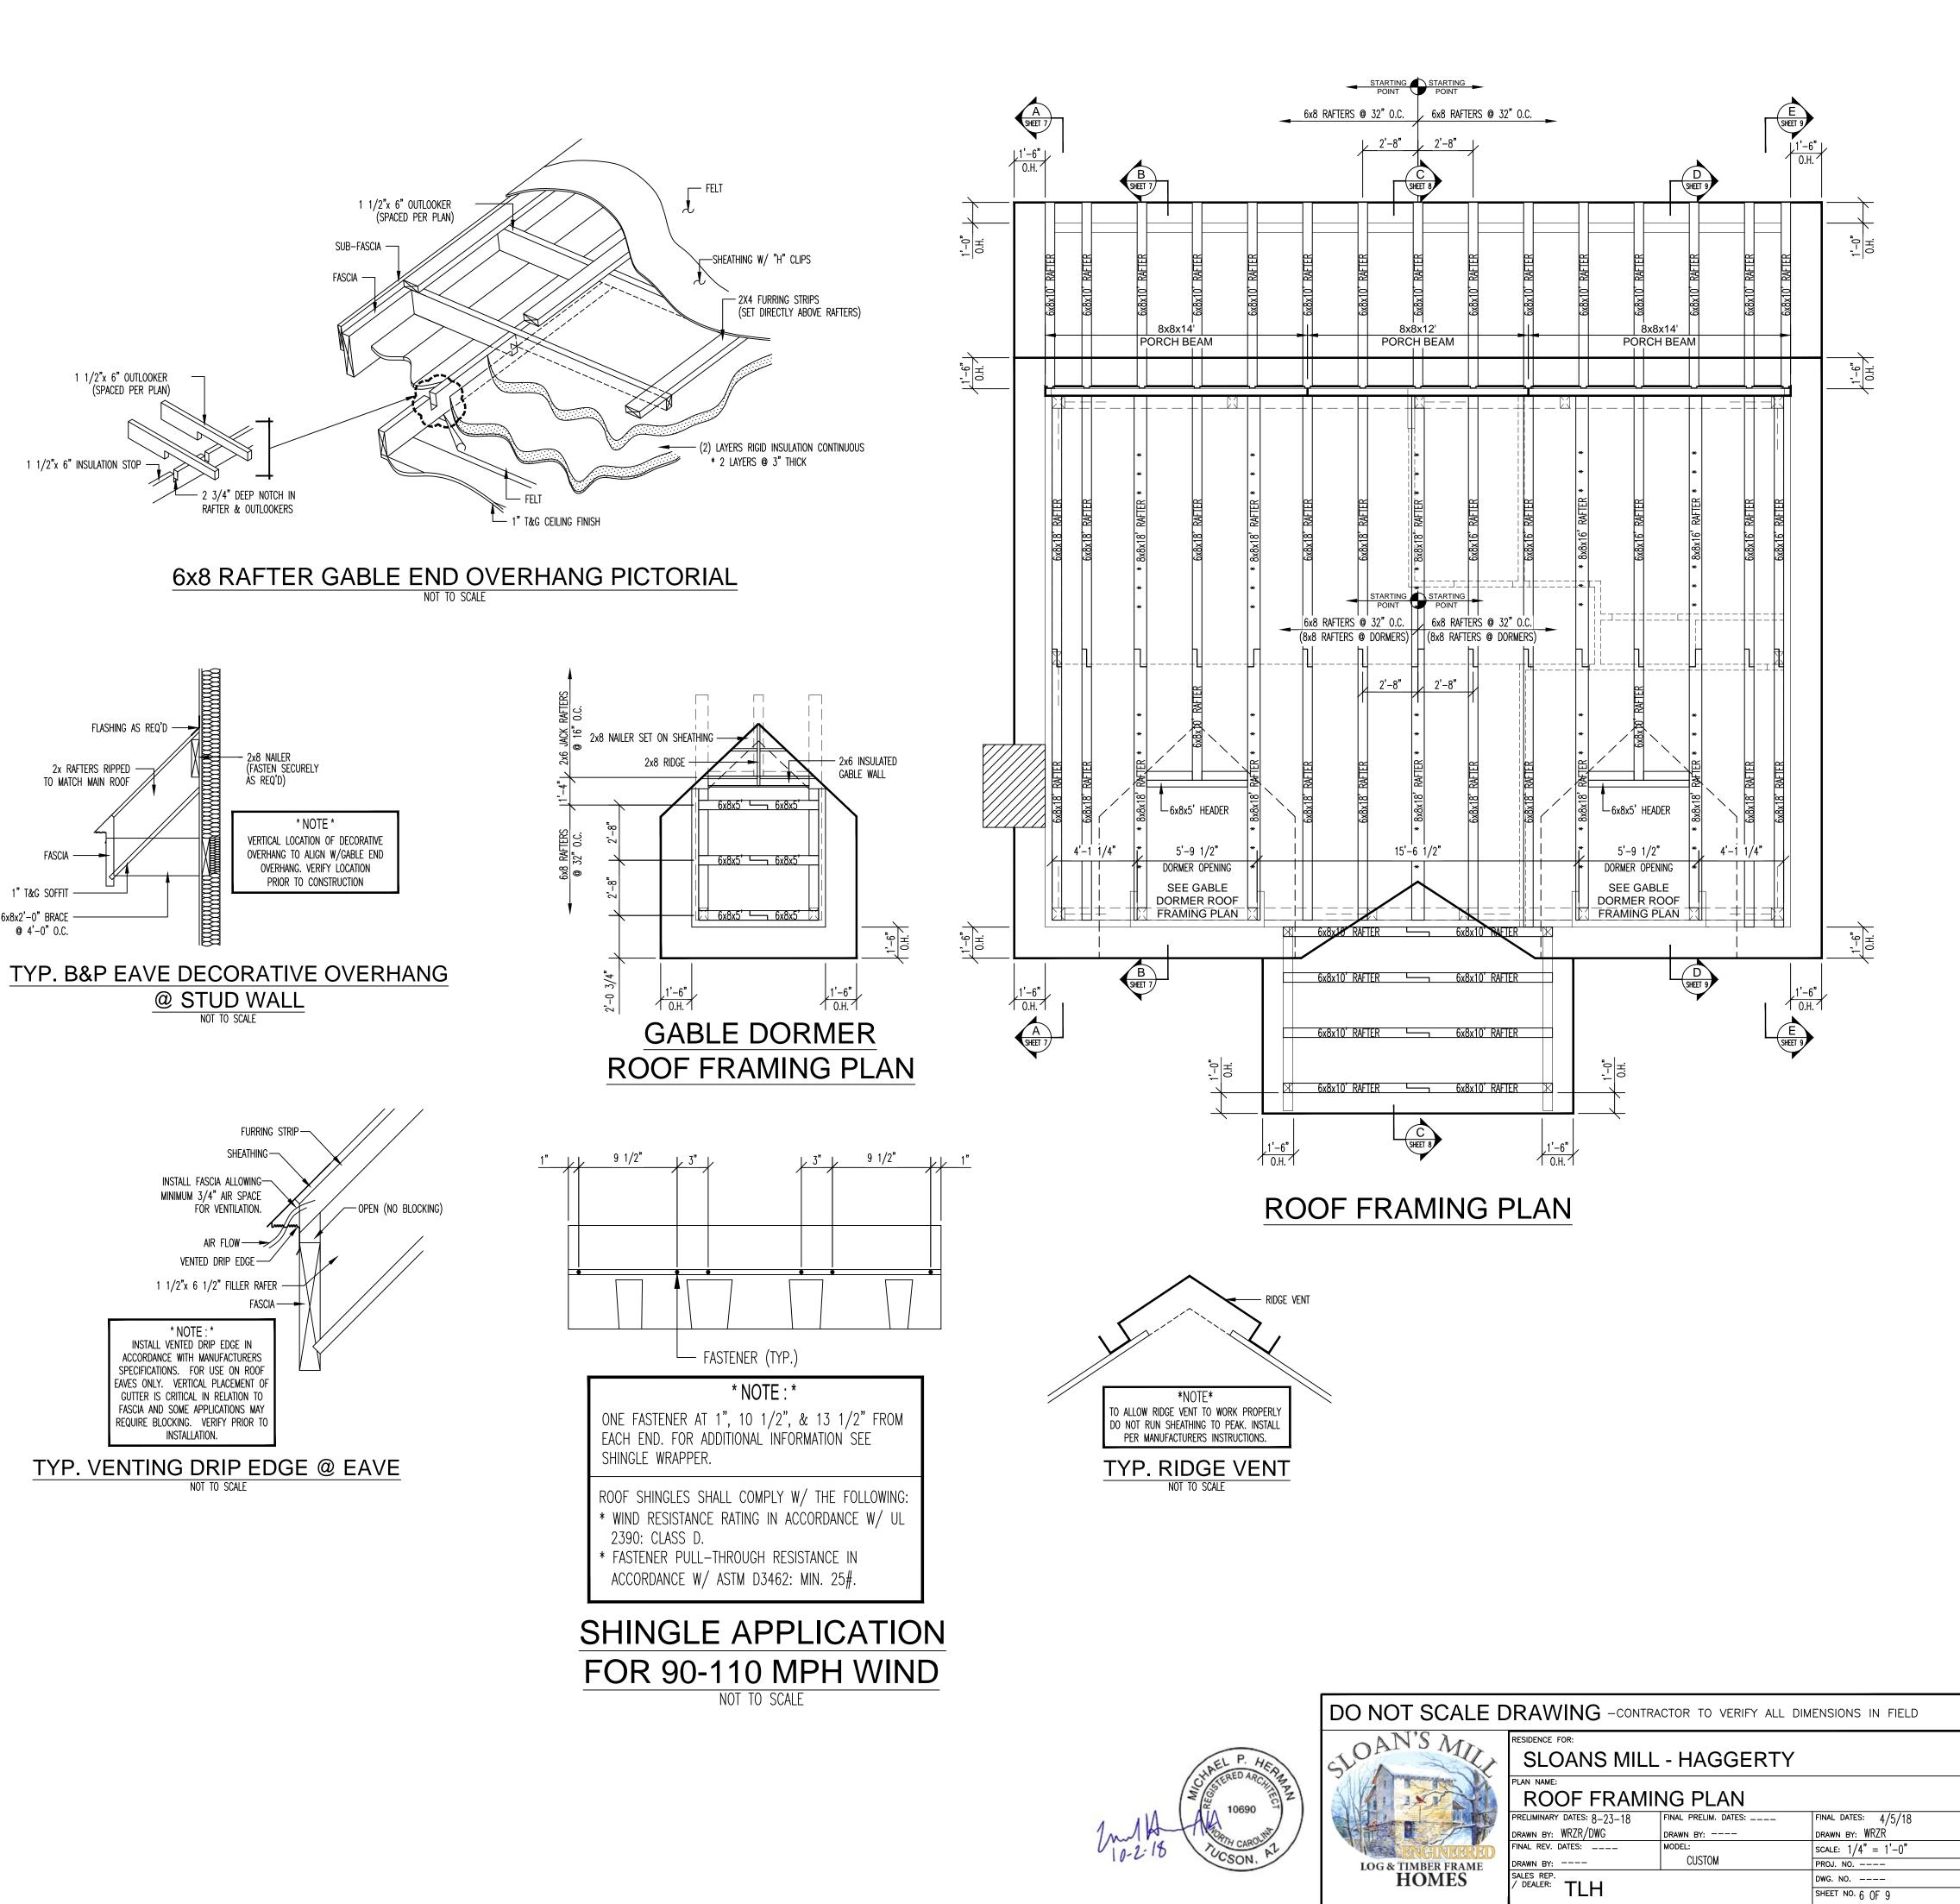


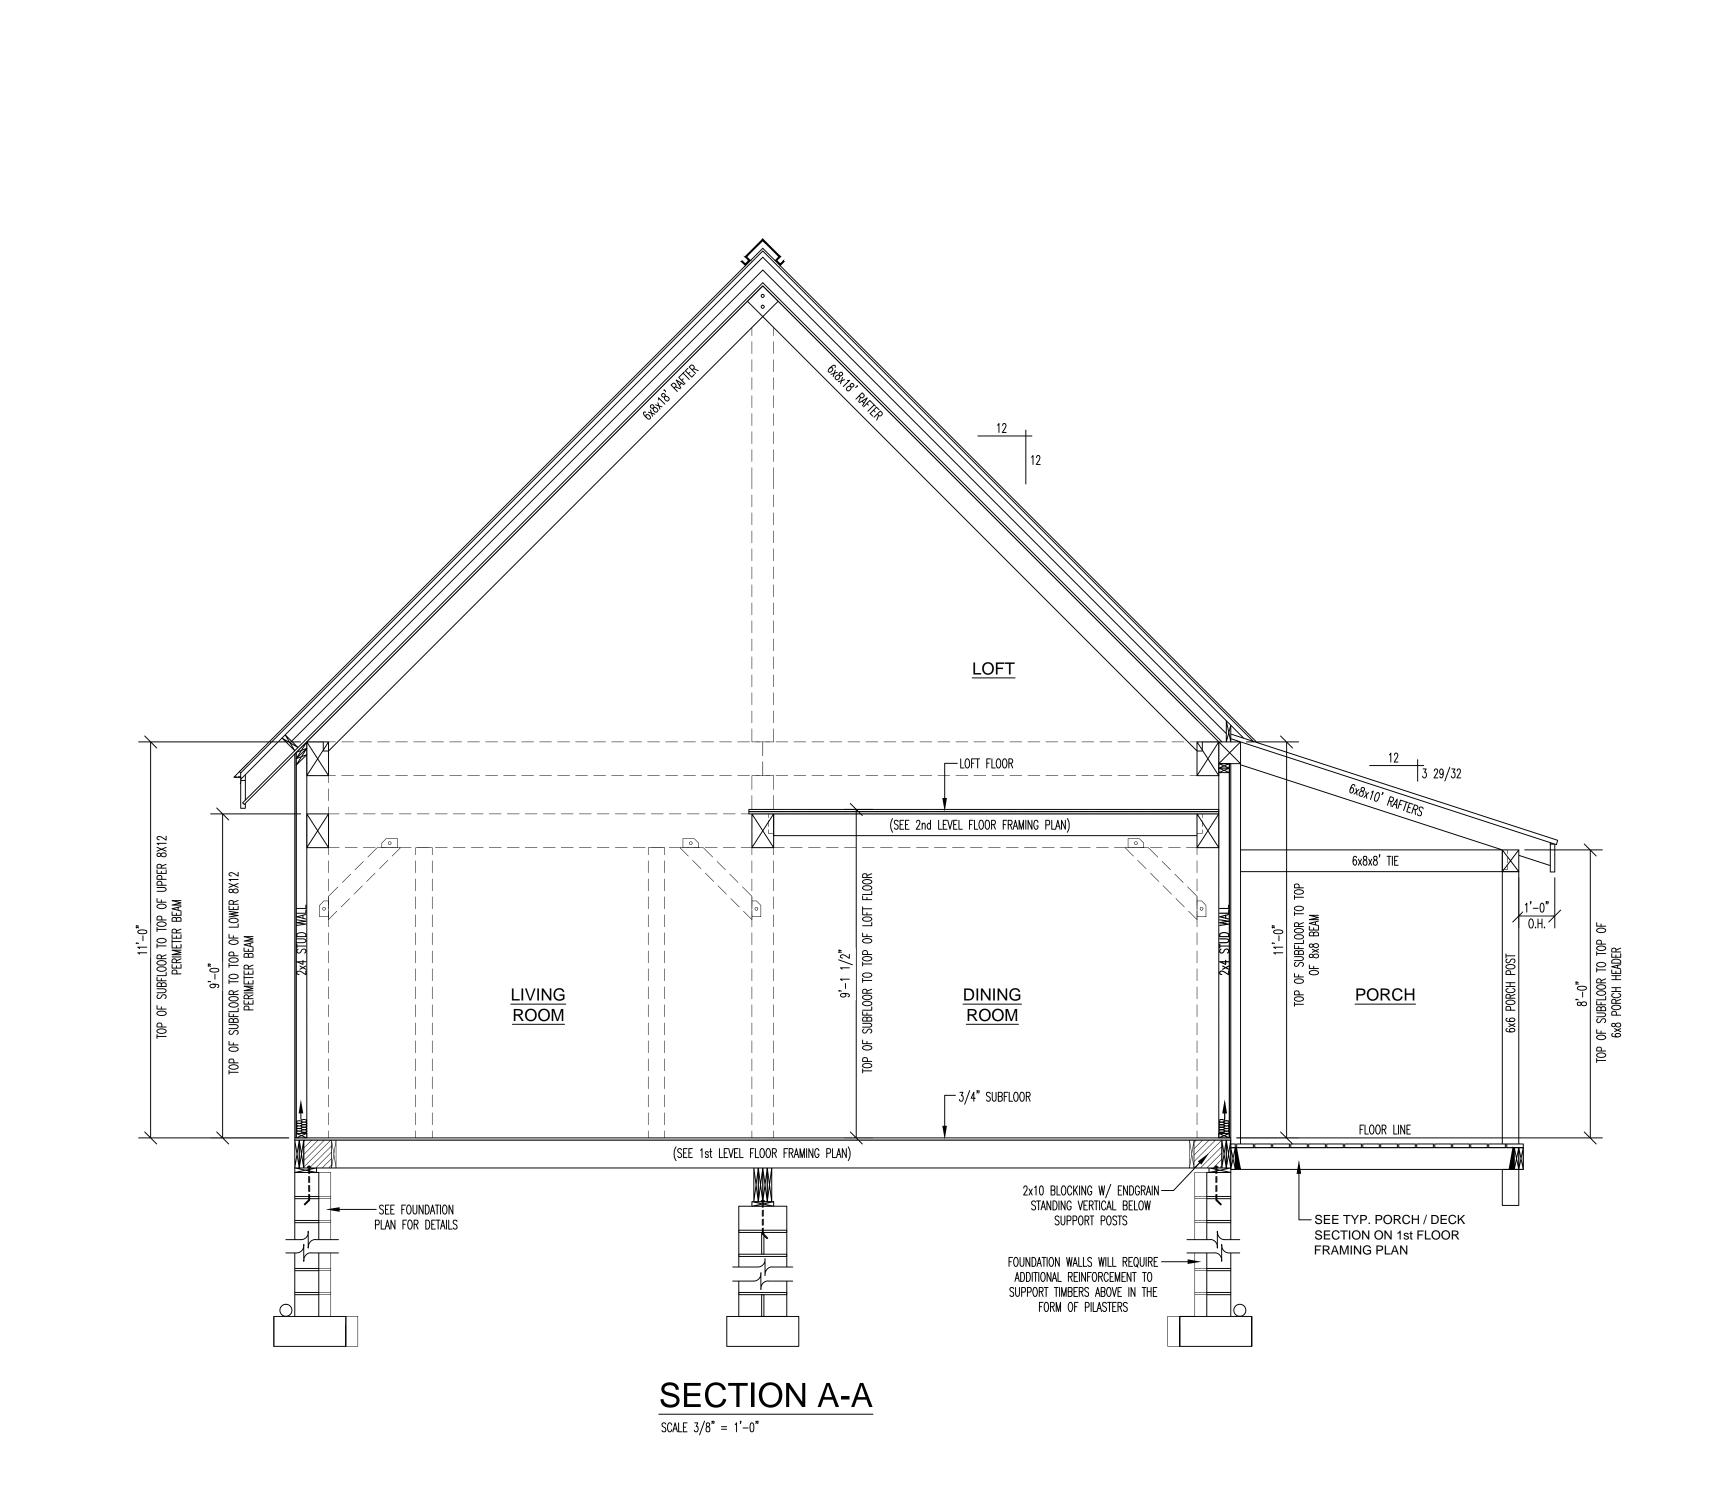



HURRICANE TIE PLATES & FASTENERS (100 MPH)					
PLATE	PLATE NO.	FASTENERS	LOCATION		
Lov co	H3Z (ZINC COATED)	(8) 8d GALVANIZED NAIL	• JOIST TO SILL PLATE CONNECTION: (1) EVERY JO		
<u>⁺</u> ,	LSTA24	(18) 10d NAIL	• DOOR AND WINDOW HEADER STRAPS IN FRAMED		
€	LSTA30	(22) 10d NAIL	• FLOOR-TO-FLOOR STRAP TIES SPACED @ 48" 00		
₹ Z	HDU2	(6) SDS 1/4 x 2 1/2"	• HOLD DOWNS @ STUD WALL CORNERS		
•		12" TIMBERSCREW	• SPACED @ 12" OC AT ROOF INSULATION STOP.		
¢>		3/8 X 10" LAG	• (2) LAGS AND WASHERS AT RAFTER TO BEAM CONNECTION		

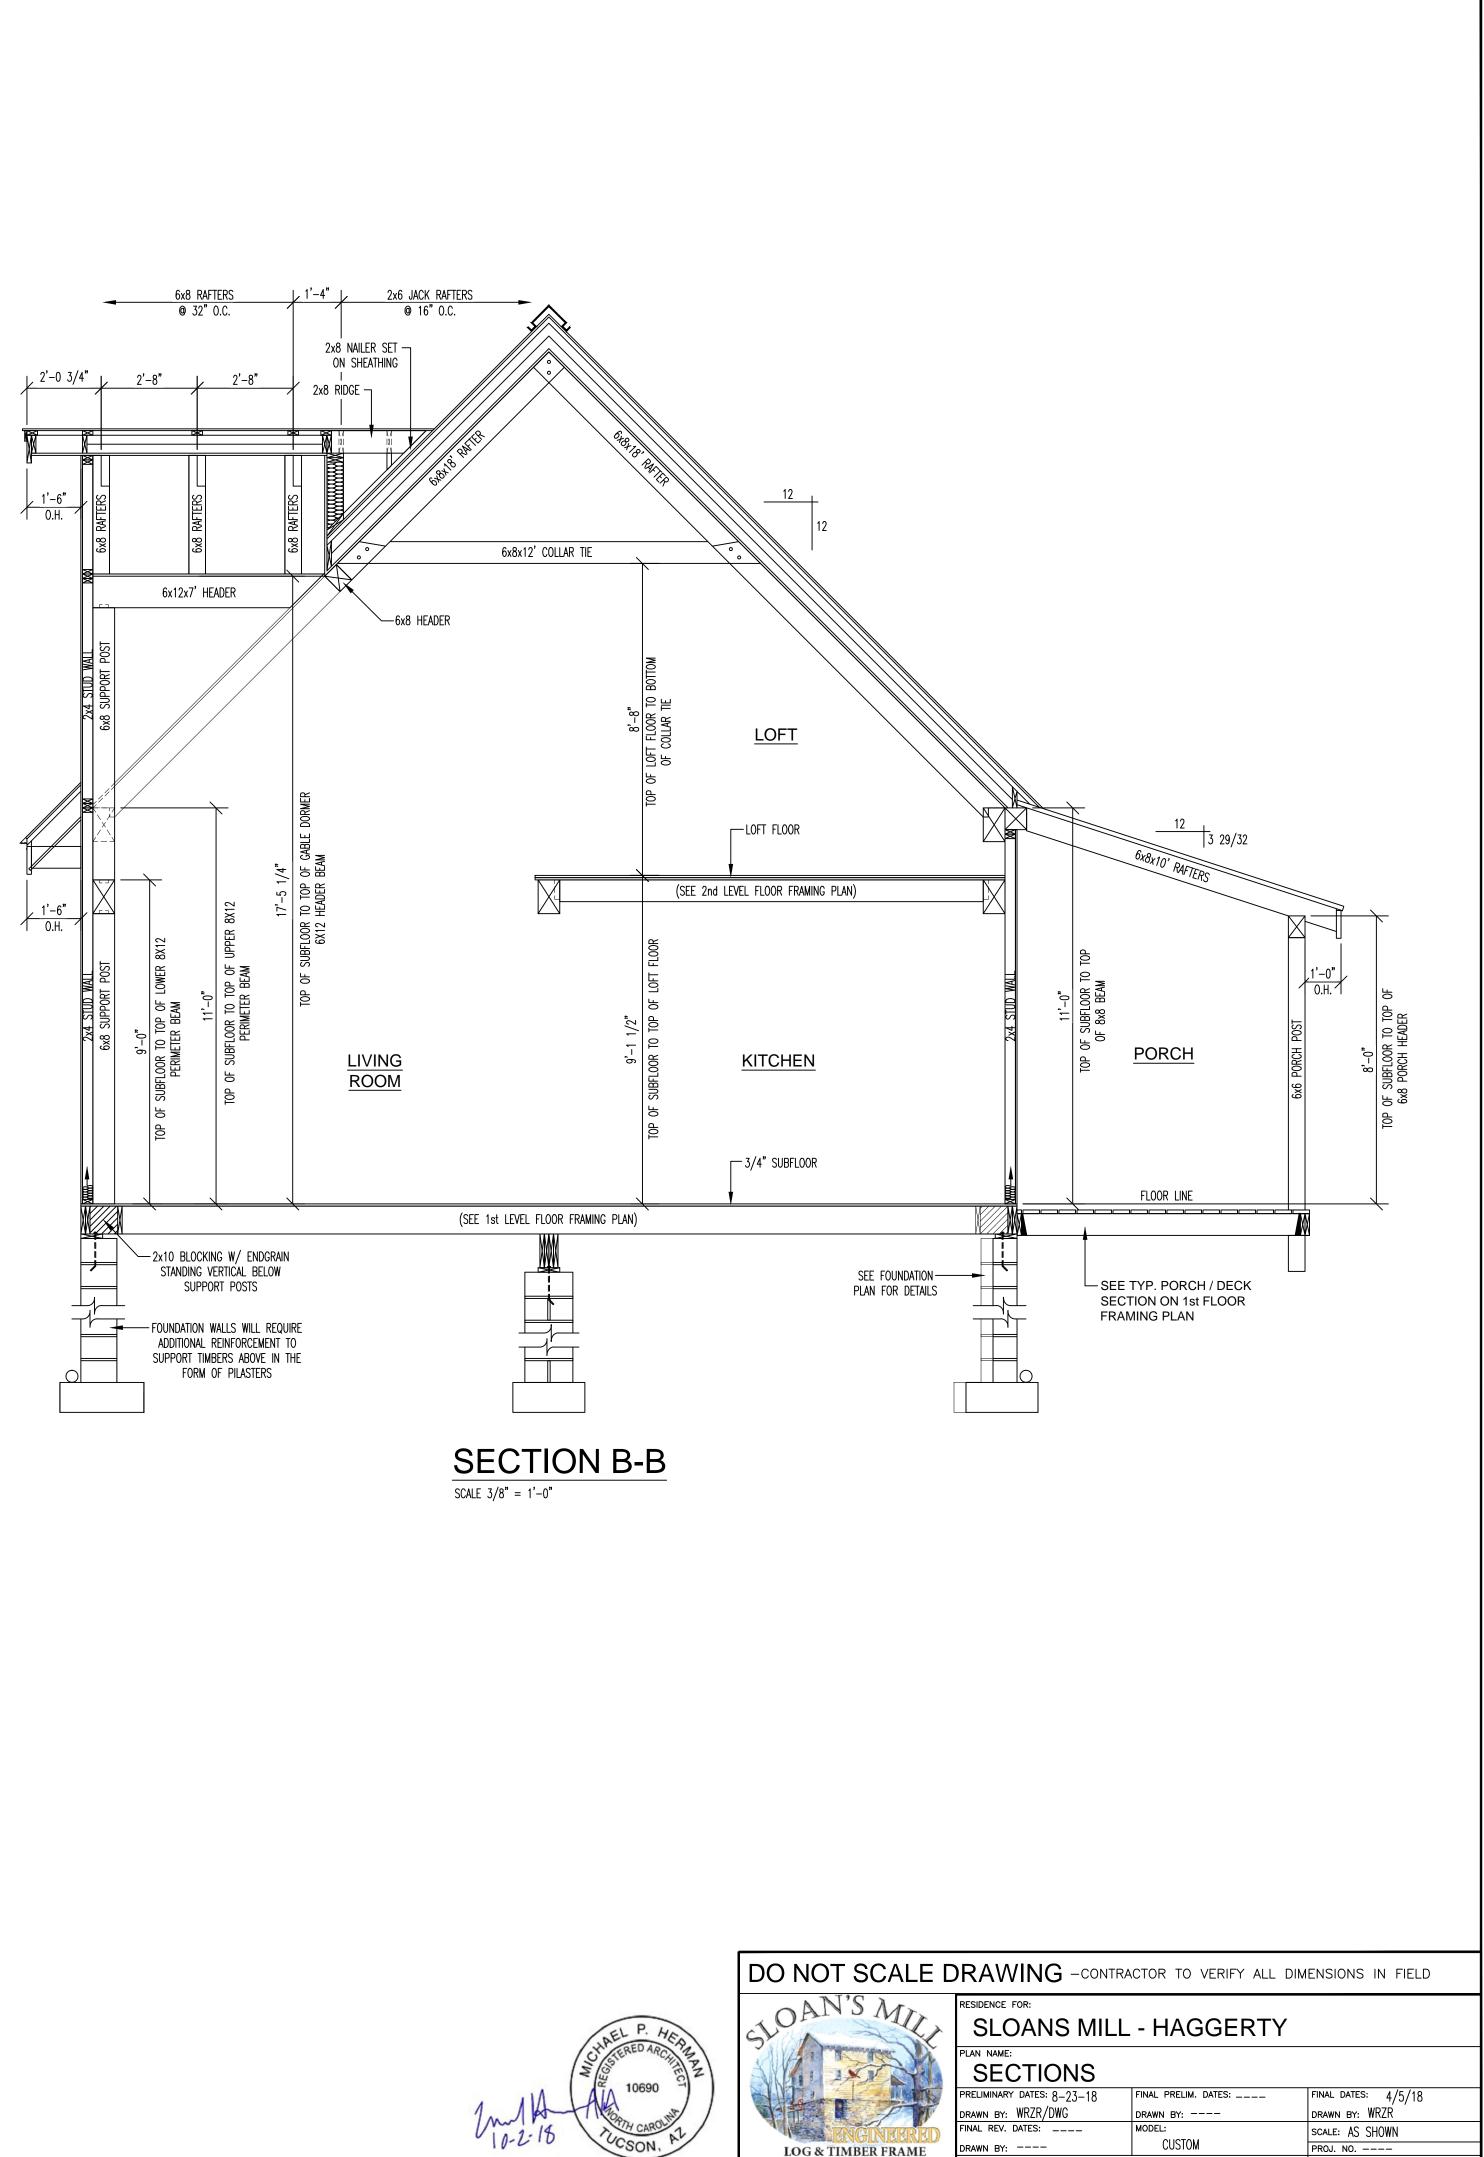


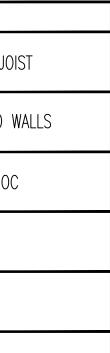


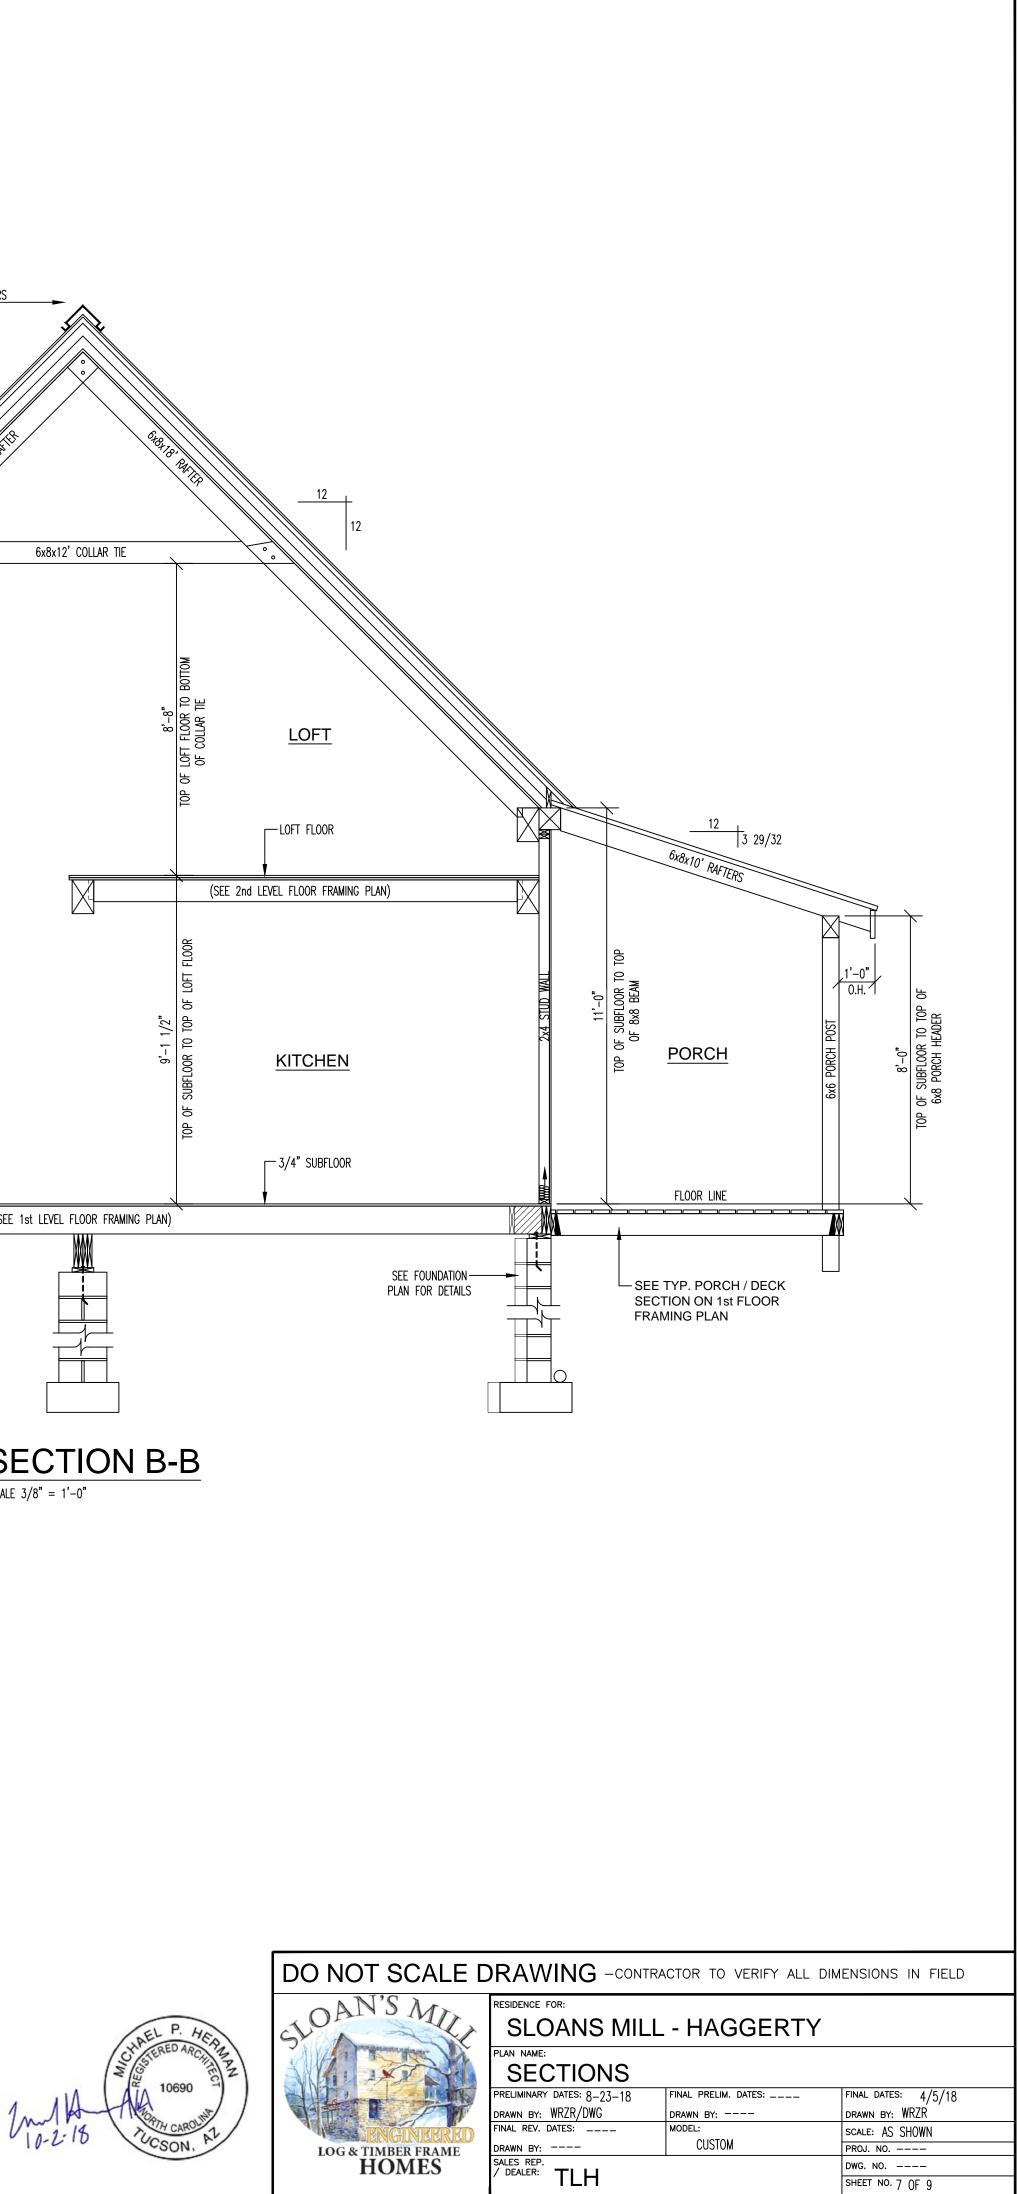


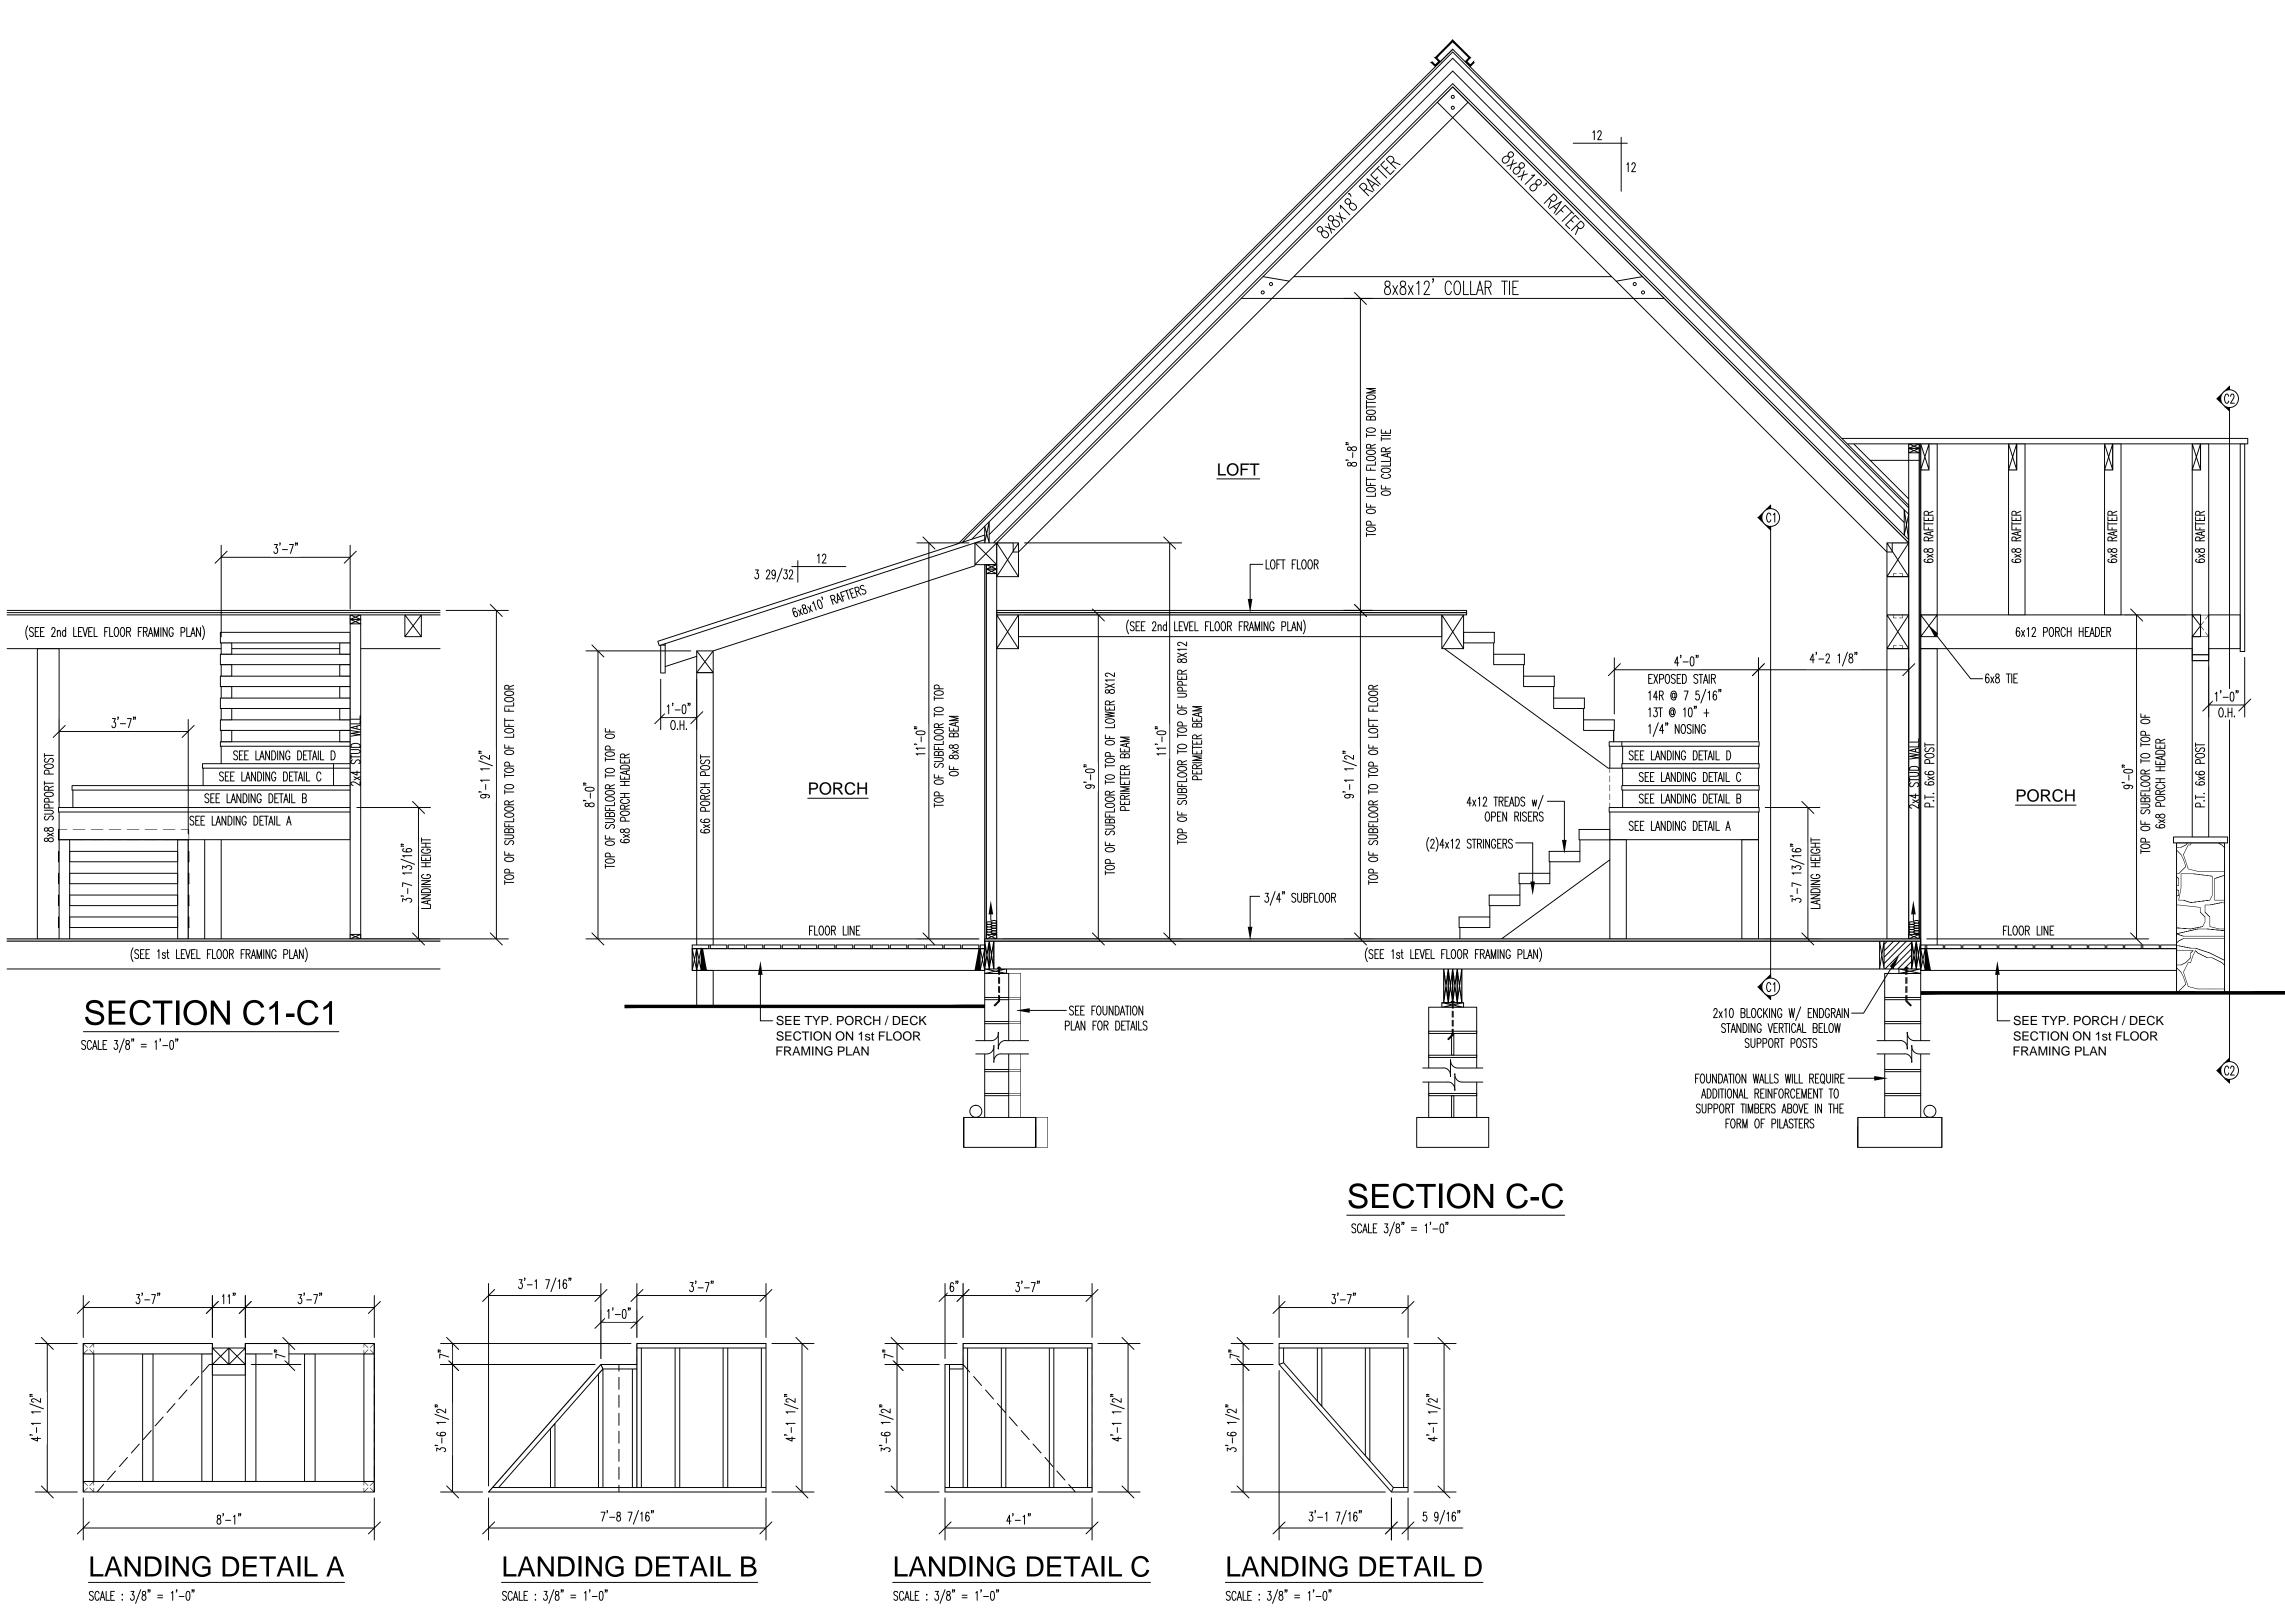

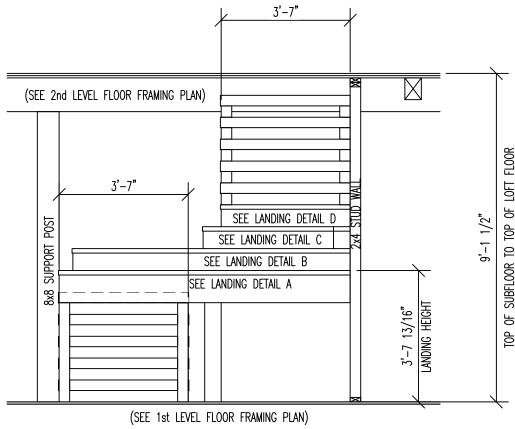

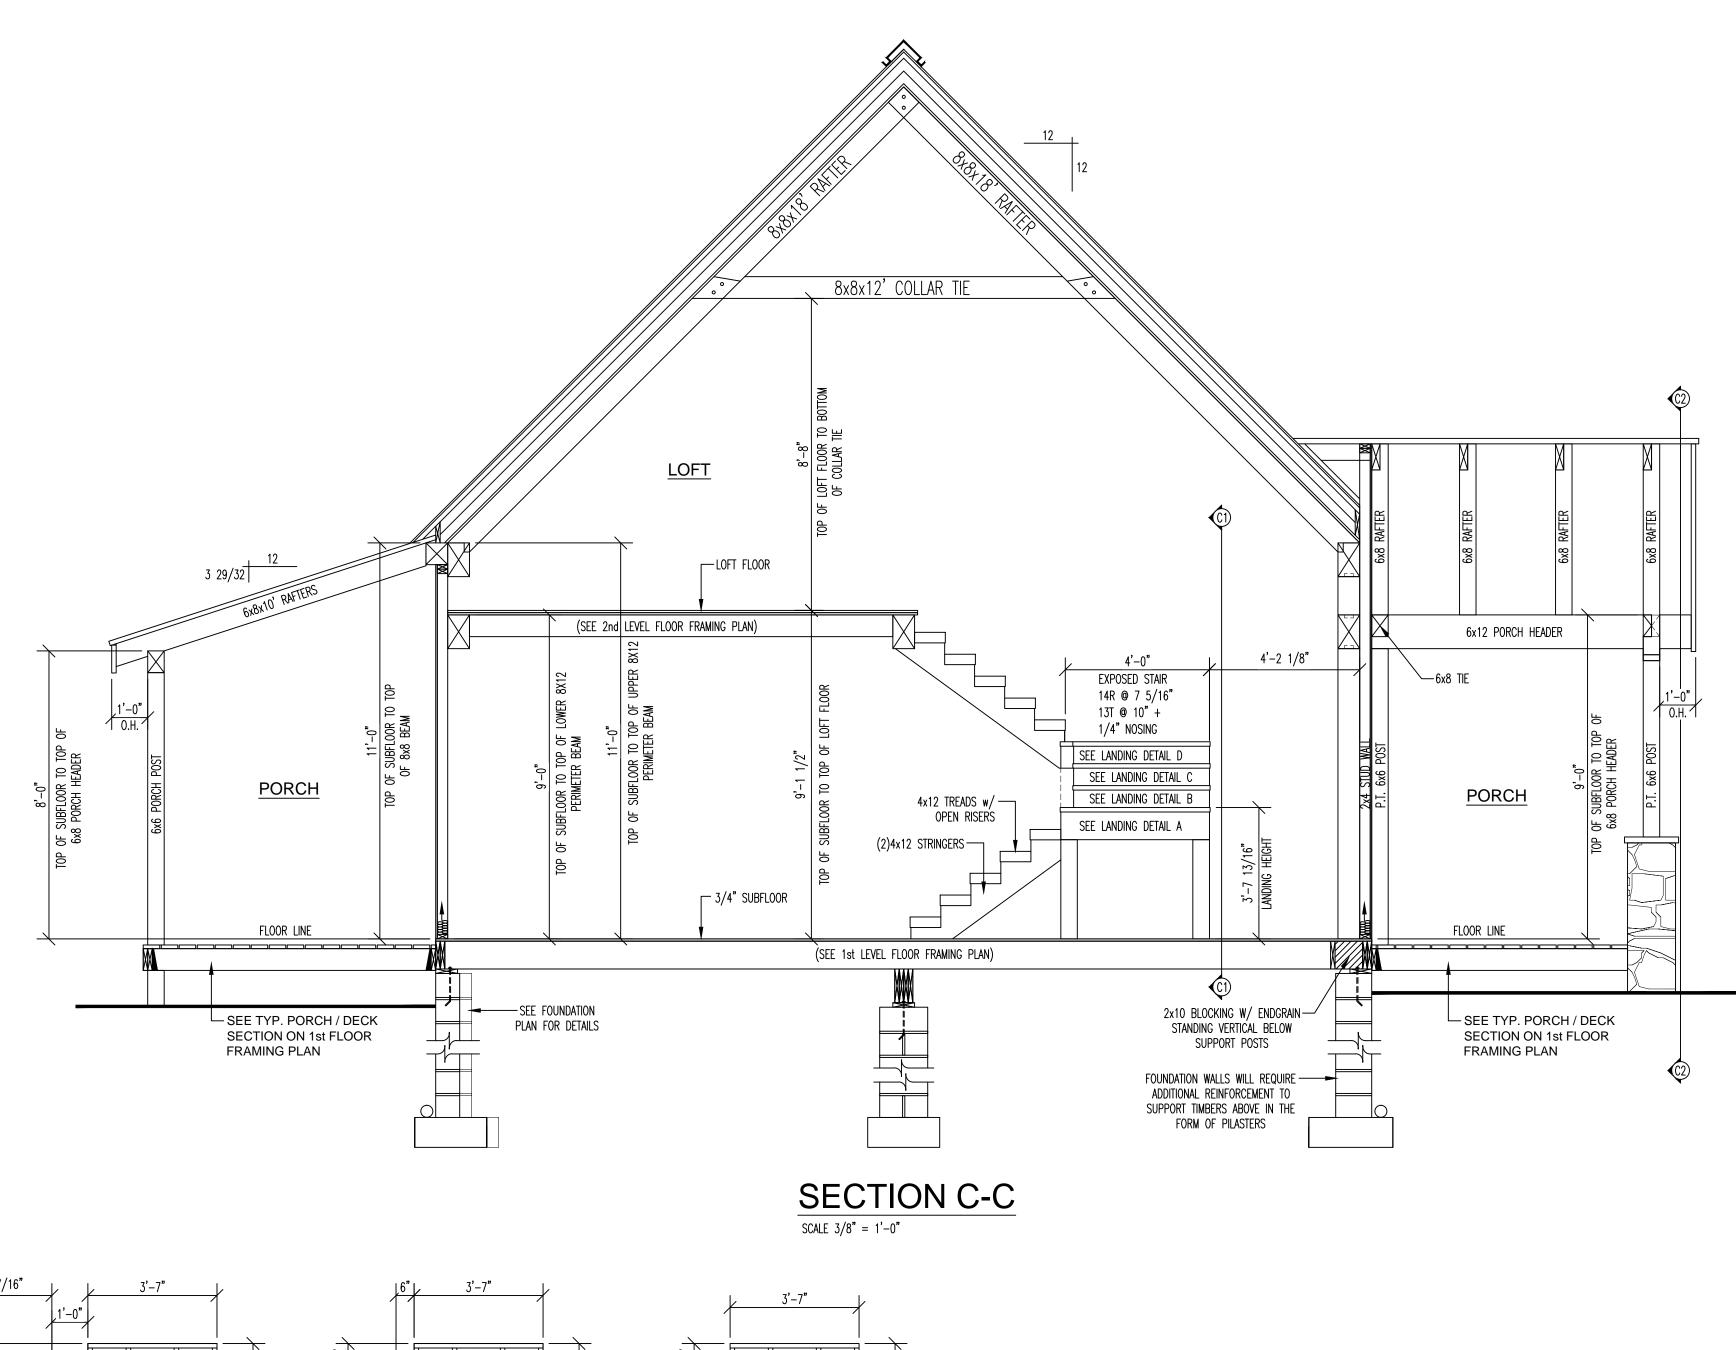

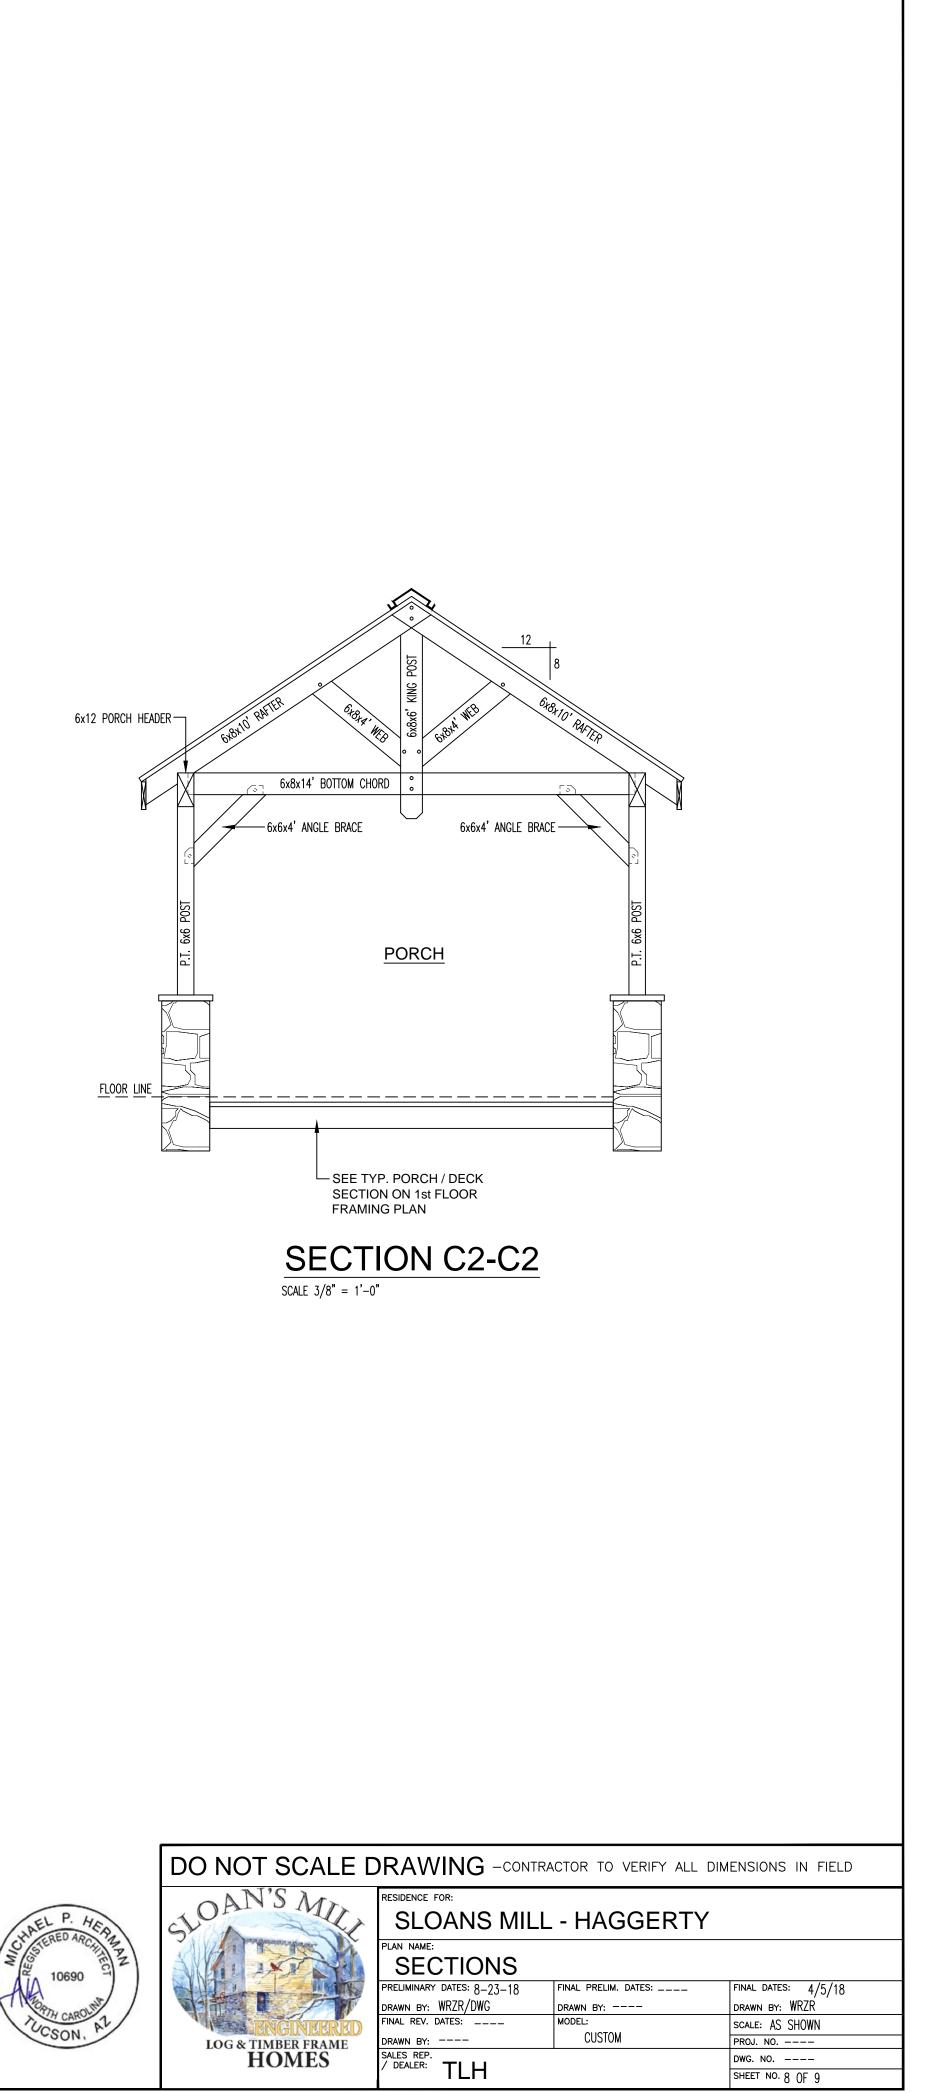

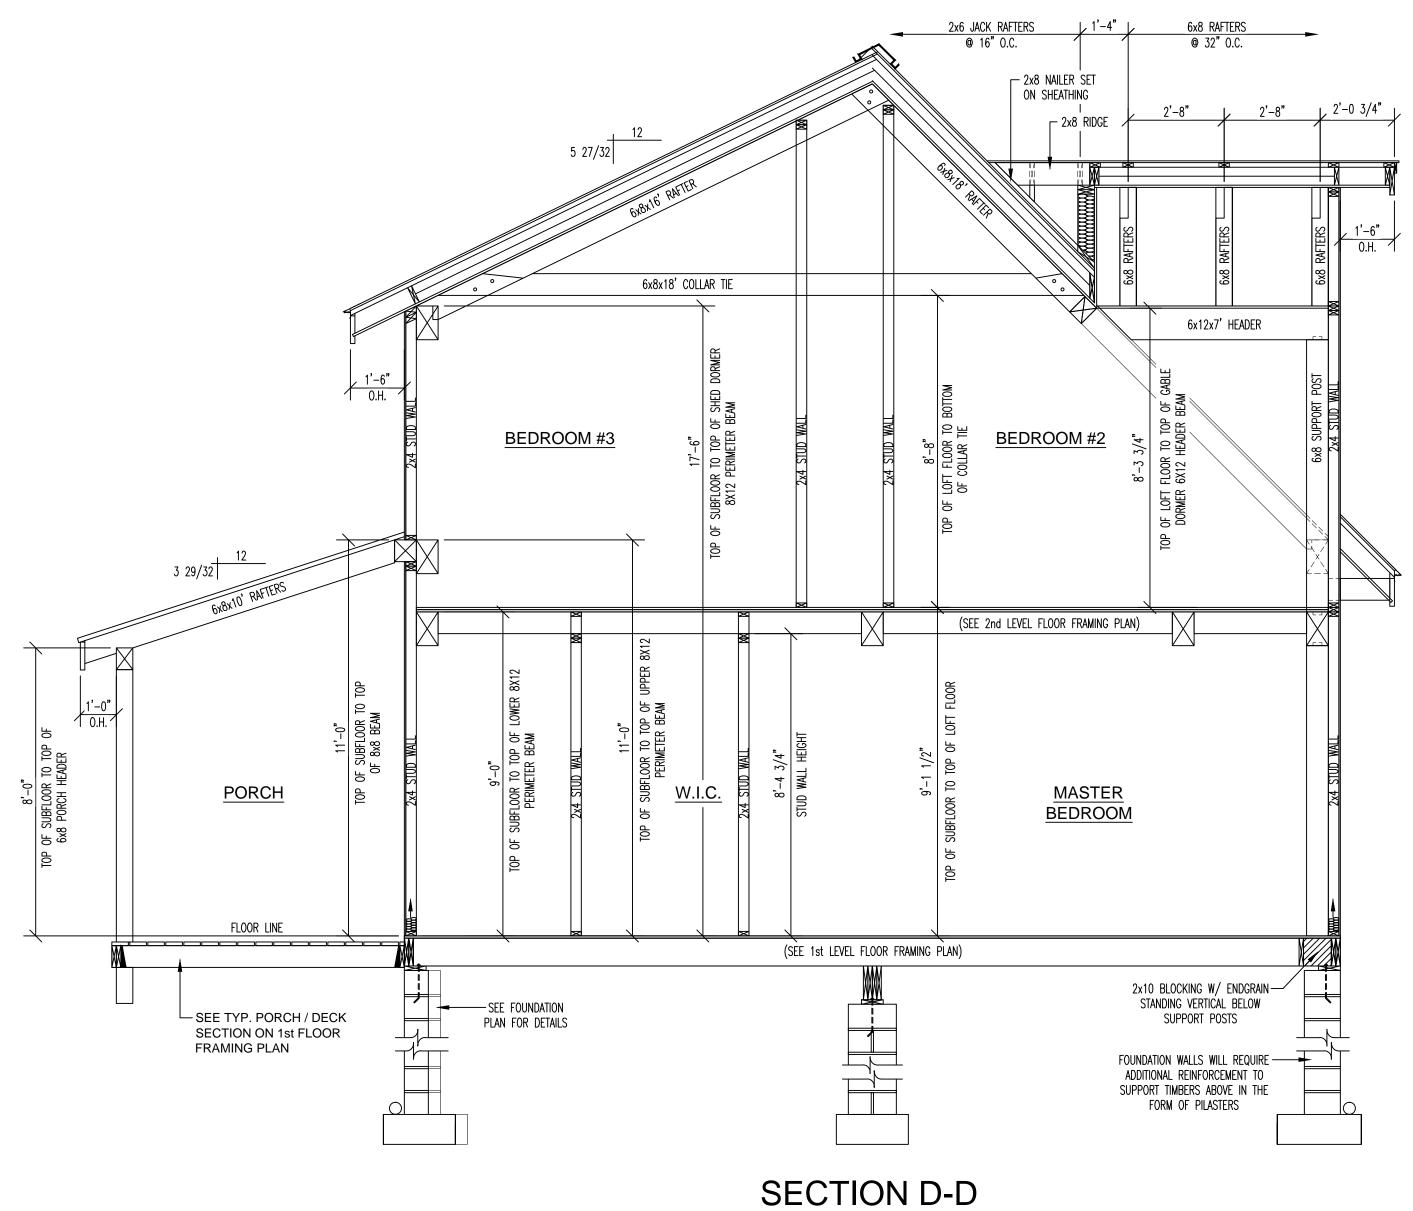

SCALE 3/8" = 1'-0"

