

LEFT ELEVATION

SCALE 1/4" = 1'-0"



El = 18'-8" ~ Upper Front Ridge Height

EI = 7'-0" Window Height

EI = 0'-0" Ground Height

10/12 ROOF PITCH


Apex, North Carolina

EI = 7'-0" Window Height


Area 2547.3413 square ft. Perimeter 235'-2 1/2"

Porch area (240.4063 sq. ft.) Garage area (416.4097 sq. ft.)



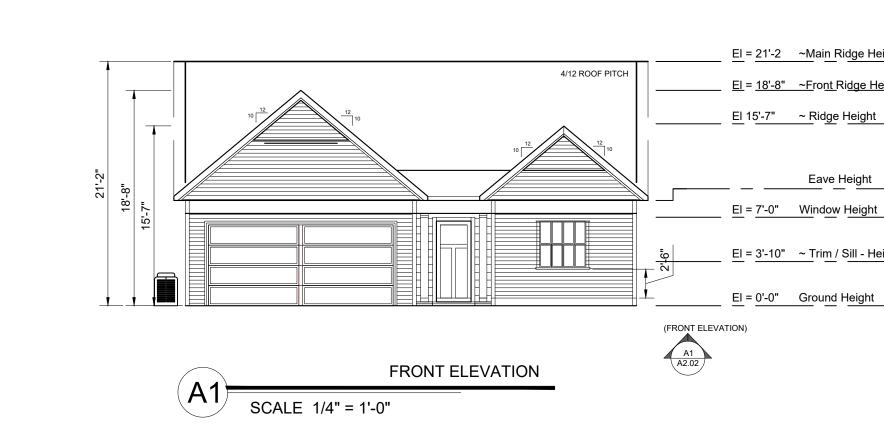

Vicinity Map

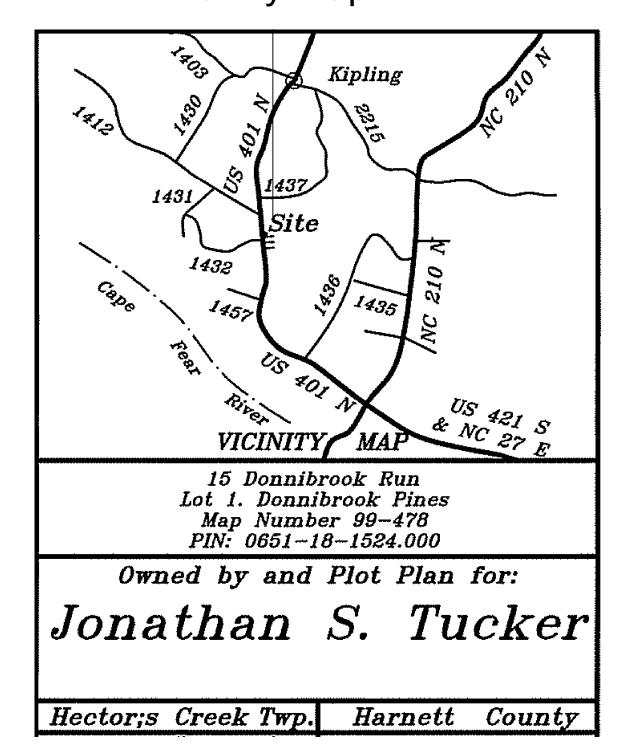


Drawing Index


Architectural	Structural	
		C2 01
GENERAL	Framing/Lintels	S2.01
COVER SHEET A0.01	Framing Details	S4.01
SITE PLAN AS.01		
ARCHITECTURAL		
FLOOR PLAN A1.01		
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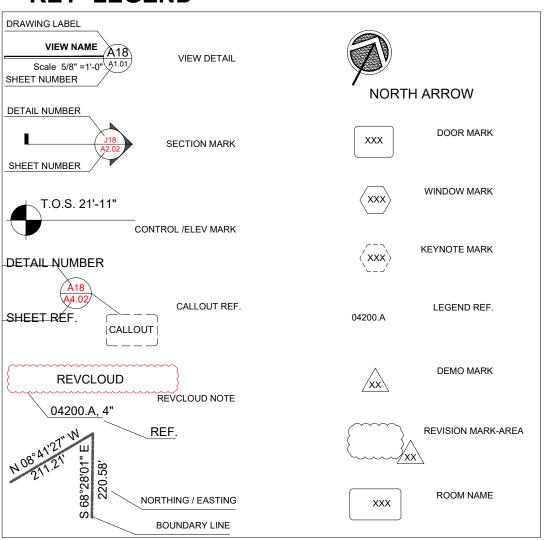
Residence



A0.01

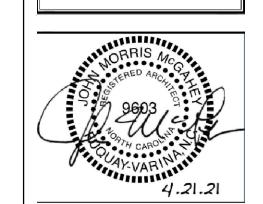KEY LEGEND

ITEM

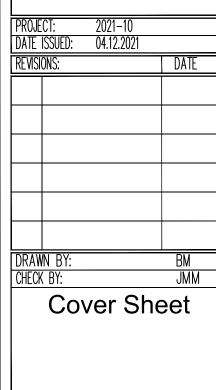

PLAN NOTES

ALL INSTALLATIONS TO MEET REQUIREMENTS OF

LOCAL MUNICALITIES ADOPTED CODES.

INC. IS STRICTLY PROHIBITED.

BY LOCAL CODE - SEE DETAIL.

REFERENCE

THE ATTACHED PLANS & SPECIFICATIONSARE ARE THE SOLE PROPERTY OF PULTE HOMES, INC. ANY UNAUTHORIZED USE OF THE PLANS WITHOUT WRITTEN CONSENT OF PULTE HOMES

ALL FRAMED WALLS TO BE 2x4 UNLESS NOTED OTHERWISE

THERE SHALL BE NO STEP AT GARAGE ENTRANCE AS ALLOWED BY GRADE CONDITION. OPENINGS BETWEEN

THICK. OR 20 MINUTE FIRE-RATED DOORS PER IRC.

SLOPE 1/8" PER LINEAL FOOT TOWARD EXTERIOR

SPECIFIED BY HVAC CONTRACTOR.

FIRE BLOCK CEILING

NO BASEBOARD TRIM

SILL HEIGHT

CALCULATIONS..

13. | SPACING OF 4" PER IRC.

PER IRC.

GARAGE CONCRETE SLAB TO SLOPE 1/8" PER LINEAL FOOT FROM GARAGE ENTRY DOOR TOWARDS GARAGE OVERHEAD

DOOR, PROVIDE 12" x 16'-3 X 3/4 " GARAGE SLAB LEAVOUT.

A/C PAD IS APPROXIMATE LOCATION IN FIELD - MOVE AS REQUIRED BY LOCAL CODE OR DRAINAGE RESTRICTIONS

DRWALL & WALLS (TAPED/MUD ONLY, NO PAINT)

DRYWALL & CEILING (TAPED/MUD ONLY, NO PAINT)

NO FLOORING, EXPOSED CONCRETE OR SUB-FLOOR CONDENSATE DRAIN REQ'D TO TIE INTO PLUMBING PER

2ND FLOOR WINDOWS: ANY OPERABLE WINDOW THAT IS MORE

THAN 72" ABOVE GRADE MUST COMPLY PER IRC CODE - MIN.

THE GARAGE SHALL BE SEPARATED FROM THE RESIDENCE

AND ITS ATTIC AREA BY NOT LESS THAN 1/2" GYP. BOARD

GARAGE W/ NOT LESS THAN 5/8" TYPE 'X' GYP. BOARD OR EQUIVALENT. ALL WALLS WHICH ARE ADJACENT TO AIR

CONDITIONED SPACE SHALL BE INSULATED PER ENERGY

SHOWER DOORS TO BE 24" TEMPERED U.N.O. SHOWER ENCLOSURES ARE REQUIRED TO BE TEMPERED PER IRC.

ALL GUARDRAILS TO BE MIN. 36" A.F.F. W/MAXIMUM SPINDLE

PROVIDE MIN. 1/2" GYP. BOARD ON BOTTOM SIDE OF STAIRS

DRYER TO BE LOCATED TO THE RIGHT OF WASHING MACHINE

OPT. TANKLESS WATER HEATER TO BE INSTALLED ON

OPT. WATER SOFTENER TO BE INSTALLED AT REAR OF

GARAGE ADJACENT TO WATER HEATER.

EXTERIOR WALL IN GARAGE IN PLACE OF WATER HEATER

APPLIED TO THE GARAGE SIDE. THE GARAGE SHALL BE SEPARATED FROM ALL HABITABLE ROOMS ABOVE THE

(ADD ADDITIONAL PADS PER HVAC REQUIREMENTS AS

ALL HVAC'S LOCATED IN CLOSET TO BE FINISHED:

ALL PORCH AND PATIO CONCRETE SLABS TO DROP 3-1/2" AND

28" x 28" HOT WATER HEATER PLATFORM TO BE 18" ABOVE FFL

(FINIISHED FLOOR LEVEL. (PROVIDE ENCLOSURE AS REQUIRE

ATTIC VENTILATION CALCS

ATTIC VENTILATION - (300 SQ. FT. ATTIC SPACE / 1 SQ FT VENTILATION) w/ 40% - 50% REQ. VENTS GREATER THAN OR EQUAL TO 3'-0 ABOVE EAVE CORNICE VENTS PER IRC R806.2

ELEVATIONS "LC 102" 2276 SQ FT UNDER ROOF ATTIC / 300 SQ FT / 1 SQ FT = 7.59 SQ FT VENTILATION

RIDGE VENT 18 SQ IN = (.125 SQ FT)BOX VENT 50 SQ IN = (.3472 SQ FT)SOFFIT VENT 9 SQ IN = (.0625 SQ FT)

0.0625 SQ FT

7.59 SQ FT x 50% = 3.7935 SQ FT RIDGE.7.59 SQ FT x 50% = 3.7935 SQ FT SOFFIT

RIDGE VENT	OR w/ HIP, BOX VENT
3.793 SQ FT x 50% = 30.3 SQ FT OF RIDGE VENT	3.793 SQ FT = 10.9 BOX VENT(S)
0.125 SQ FT	0.3472 SQ FT
SOFFIT VENT	
3.793 SQ FT = 60.7 FEET OF SOFFIT VENT	

JONATHON TUCKER RESIDENCE

Apex, North Carolina

Area 2547.3413 square ft. Perimeter 235'-2 1/2"

Porch area (240.4063 sq. ft.) Garage area (416.4097 sq. ft.)

Vicinity Map

15 Donnibrook Run

Lot 1. Donnibrook Pines

Map Number 99-478 PIN: 0651-18-1524.000

Owned by and Plot Plan for:


Jonathan S. Tucker

Harnett County

Date: 6-24-16

Hector;s Creek Twp.

Scale: 1" = 40'

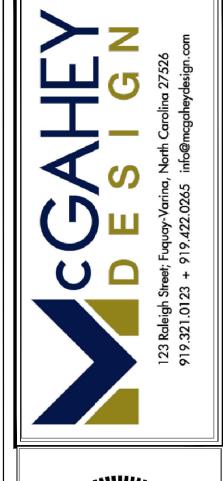





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PROJECT: 2021–10							
DATE ISSUED: 04.12.2021							
REVISION	REVISIONS: DATE						
	N BY:	BM					
CHECK	BY:	JMM					
Cover Sheet							
	COVCI ONC	,01					

A0.02

FRAMING NOTES


- ALL EXTERIOR WALLS ARE SHOWN AT 3-1/2 " UNLESS OTHERWISE SPECIFIED
- 2 ALL INTERIOR WALLS ARE SHOWN AT 3-1/2 " UNLESS OTHERWISE SPECIFIED.
- 3 SOLID BLOCK ALL GIRDERS & BEAMS TO THE FOUNDATION.
- 4 ALL INTERIOR NON-LOAD BEARING WALLS TO BE 16" O.C.
- 5 ALL LOAD BEARING WALLS TO 16" O.C.
- ALL HEADERS TO BE (2) PLY U.N.O. 2x4 AND 2x8 TO BE SPF OR SP No. 2 OR BETTER. HEADERS GREATER THAN 2x6 TO BE SP No. 2 OR BETTER.
- PROVIDE SOLID BLOCKING OR BLOCKING PER JOIST MANUFACTURER BETWEEN ALL JOISTS AT ALL COLUMN POINT LOADS, BEAMS, GIRDERS, AND LOAD BEARING WALLS.
- 8 FLOOR SYSTEM ENGINEERED BY OTHERS. INSTALL PER MANUFACTURERS RECOMMENDATION, NOTES & DETAILS, CHANGES OR MODIFICATIONS TO THESE DOCUMENTS ARE NOT PERMITTED WITHOUT A LETTER FROM THE ENGINEER OF RECORD.


TRUSS NOTES

- **UNLESS OTHERWISE NOTED**
- 2 TRUSS STRAPS TO BE SIMPSON H2.5A w/10d NAILS MIN. (2) M2.5A TO BE USED TO MULTI-PLY TRUSS (1) EACH SIDE w/8d NAILS MIN.
- K2.5T TRUSS STRAPS ARE TO BE USED U.O. H2.5A WHEN EXTERIOR SHEATHING IS NOT NAILED TO THE TOP PLATE OF THE WALL.
- THESE PLANS ARE ENGINEERED BASED ON TRUSS LAYOUTS AND ENGINEERING PROVIDED BT TRUSS MANUFACTURER, CHANGES OR MODIFICATIONS ARE NOT PERMITTED WITHOUT A LETTER FROM THE ENGINEER OF RECORD.
- FOR GABLE END BRACING, START AT ROOF SIDELINE ANDS BRACE PER DETAIL REFER TO STRUCTURAL DETAILS FOR ADDITIONAL INFORMATION.
- HIP JACKS TO BE TOE NAILED w/ (3) 10d NAILS MIN. TO HIP ORDER TRUSS
- BLOCK ALL SEAMS.

WALL SHEATHING TO BE CONTINUOUS THROUGH FLOOR SYSTEM.


Plat Plan

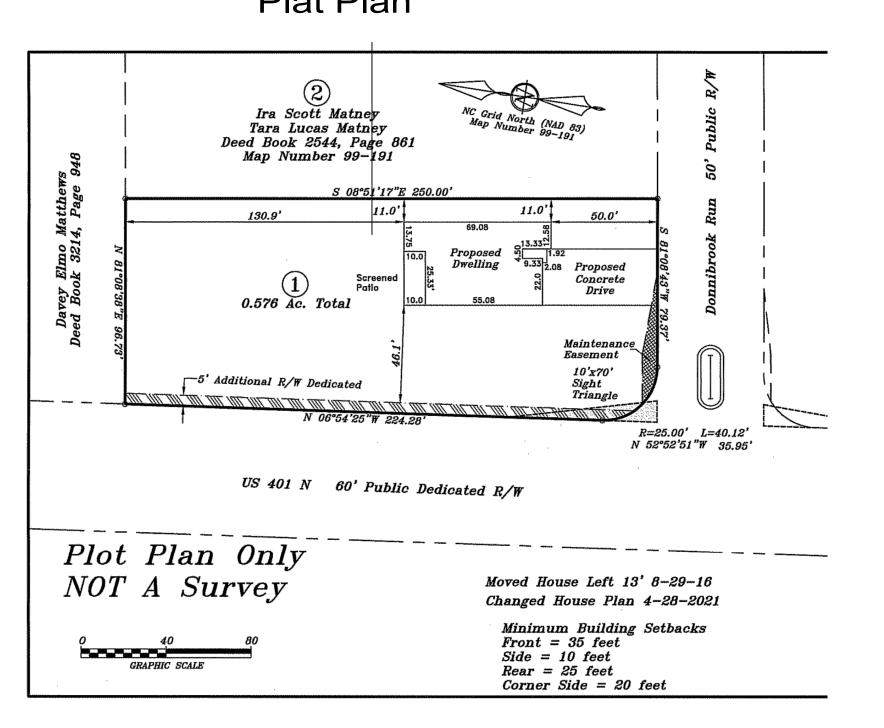


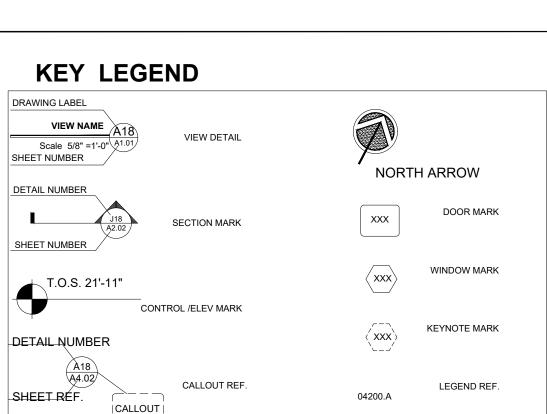

FRAMING NOTES ALL EXTERIOR WALLS ARE SHOWN AT 3-1/2 " UNLESS OTHERWISE SPECIFIED ALL INTERIOR WALLS ARE SHOWN AT 3-1/2 " UNLESS OTHERWISE SPECIFIED SOLID BLOCK ALL GIRDERS & BEAMS TO THE FOUNDATION. ALL INTERIOR NON-LOAD BEARING WALLS TO BE 16" O.C. ALL LOAD BEARING WALLS TO 16" O.C. ALL HEADERS TO BE (2) PLY U.N.O. 2x4 AND 2x8 TO BE SPF OR SP No. 2 OR PROVIDE SOLID BLOCKING OR BLOCKING PER JOIST MANUFACTURER BETWEEN ALL JOISTS AT ALL COLUMN POINT LOADS, BEAMS, GIRDERS, AND THESE DOCUMENTS ARE NOT PERMITTED WITHOUT A LETTER FROM THE

TUCKER RESIDENCE - APEX, NC Area 2547.3413 square ft. Perimeter 235'-2 1/2" Porch area (240.4063 sq. ft.) Garage area (416.4097 sq. ft.)

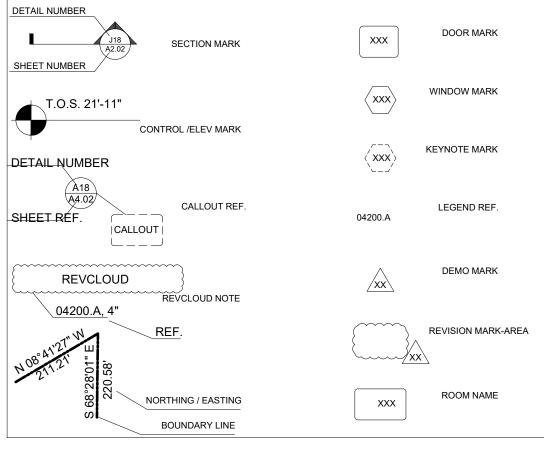

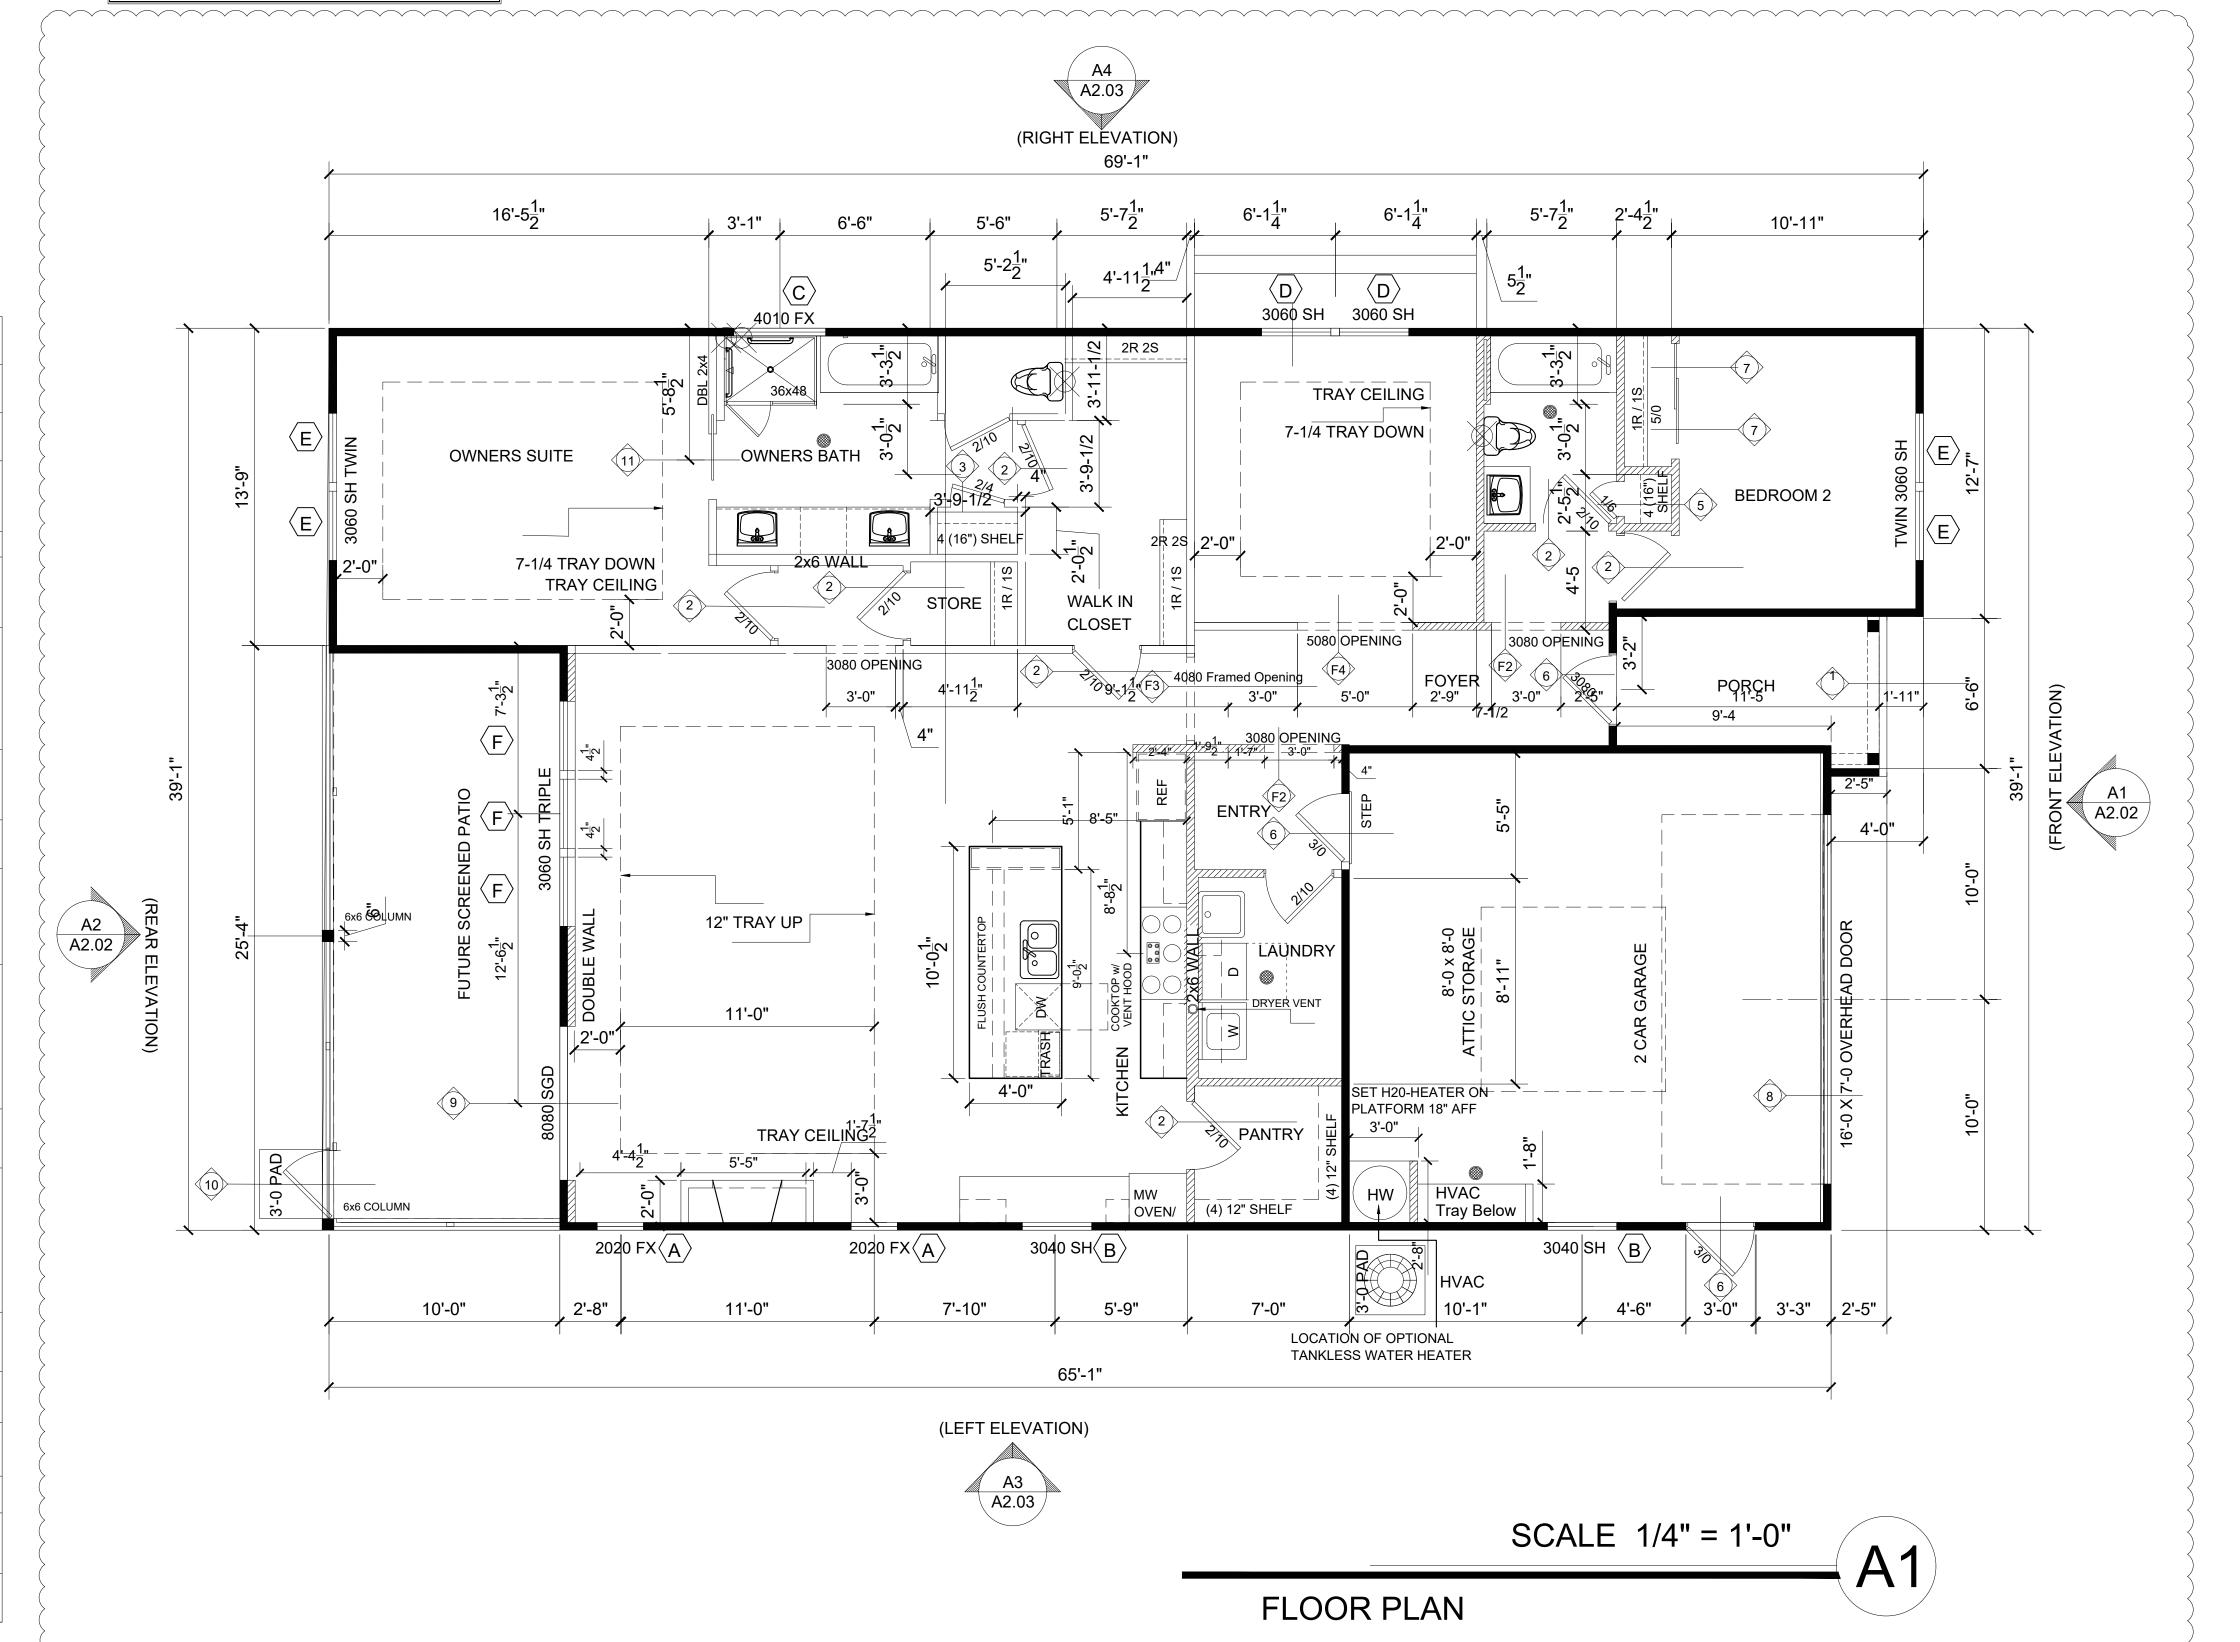



REFERENCE ALL INSTALLATIONS TO MEET REQUIREMENTS OF LOCAL MUNICALITIES ADOPTED CODES. THE ATTACHED PLANS & SPECIFICATIONSARE ARE THE SOLE

PROPERTY OF PULTE HOMES, INC. ANY UNAUTHORIZED USE OF THE PLANS WITHOUT WRITTEN CONSENT OF PULTE HOMES, INC. IS STRICTLY PROHIBITED. ALL FRAMED WALLS TO BE 2x4 UNLESS NOTED OTHERWISE

28" x 28" HOT WATER HEATER PLATFORM TO BE 18" ABOVE FFL (FINIISHED FLOOR LEVEL. (PROVIDE ENCLOSURE AS REQUIRED BY LOCAL CODE - SEE DETAIL.

THERE SHALL BE NO STEP AT GARAGE ENTRANCE AS ALLOWED BY GRADE CONDITION. OPENINGS BETWEEN GARAGE & RESIDENCE SHALL BE EQUIPPED WITH SOLID WOOD DOORS NOT LESS THAN 1-3/8" IN THICKNESS, SOLID OR HONEYCOMB-CORE STEEL DOORS NOT LESS THAN 1-3/8" THICK. OR 20 MINUTE FIRE-RATED DOORS PER IRC.

GARAGE CONCRETE SLAB TO SLOPE 1/8" PER LINEAL FOOT FROM GARAGE ENTRY DOOR TOWARDS GARAGE OVERHEAD DOOR. PROVIDE 12" x 16'-3 X 3/4 " GARAGE SLAB LEAVOUT.

ALL PORCH AND PATIO CONCRETE SLABS TO DROP 3-1/2" AND SLOPE 1/8" PER LINEAL FOOT TOWARD EXTERIOR .

A/C PAD IS APPROXIMATE LOCATION IN FIELD - MOVE AS REQUIRED BY LOCAL CODE OR DRAINAGE RESTRICTIONS (ADD ADDITIONAL PADS PER HVAC REQUIREMENTS AS SPECIFIED BY HVAC CONTRACTOR.

ALL HVAC'S LOCATED IN CLOSET TO BE FINISHED: DRWALL & WALLS (TAPED/MUD ONLY, NO PAINT)

DRYWALL & CEILING (TAPED/MUD ONLY, NO PAINT) FIRE BLOCK CEILING

NO FLOORING, EXPOSED CONCRETE OR SUB-FLOOR CONDENSATE DRAIN REQ'D TO TIE INTO PLUMBING PER

2ND FLOOR WINDOWS: ANY OPERABLE WINDOW THAT IS MORE THAN 72" ABOVE GRADE MUST COMPLY PER IRC CODE - MIN. SILL HEIGHT.

THE GARAGE SHALL BE SEPARATED FROM THE RESIDENCE 11. AND ITS ATTIC AREA BY NOT LESS THAN 1/2" GYP. BOARD APPLIED TO THE GARAGE SIDE. THE GARAGE SHALL BE SEPARATED FROM ALL HABITABLE ROOMS ABOVE THE GARAGE W/ NOT LESS THAN 5/8" TYPE 'X' GYP. BOARD OR EQUIVALENT. ALL WALLS WHICH ARE ADJACENT TO AIR CONDITIONED SPACE SHALL BE INSULATED PER ENERGY CALCULATIONS.

SHOWER DOORS TO BE 24" TEMPERED U.N.O. SHOWER 12. ENCLOSURES ARE REQUIRED TO BE TEMPERED PER IRC.

ALL GUARDRAILS TO BE MIN. 36" A.F.F. W/MAXIMUM SPINDLE SPACING OF 4" PER IRC.

PROVIDE MIN. 1/2" GYP. BOARD ON BOTTOM SIDE OF STAIRS 14. PER IRC.

DRYER TO BE LOCATED TO THE RIGHT OF WASHING MACHINE

OPT. TANKLESS WATER HEATER TO BE INSTALLED ON EXTERIOR WALL IN GARAGE IN PLACE OF WATER HEATER


OPT. WATER SOFTENER TO BE INSTALLED AT REAR OF 17. GARAGE ADJACENT TO WATER HEATER.


Scale: 1/4" = 1'-0"







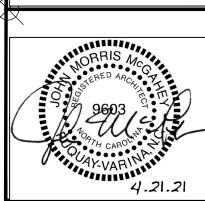


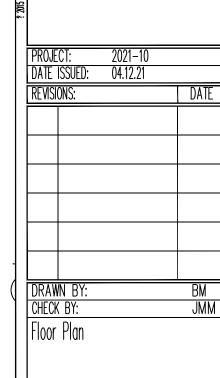







TUCKER RESIDENCE LEFT SIDE GARAGE

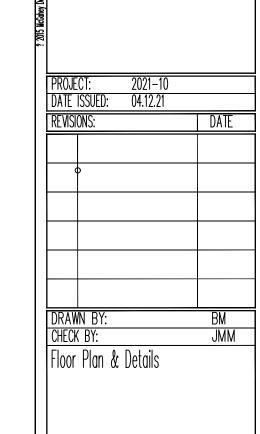


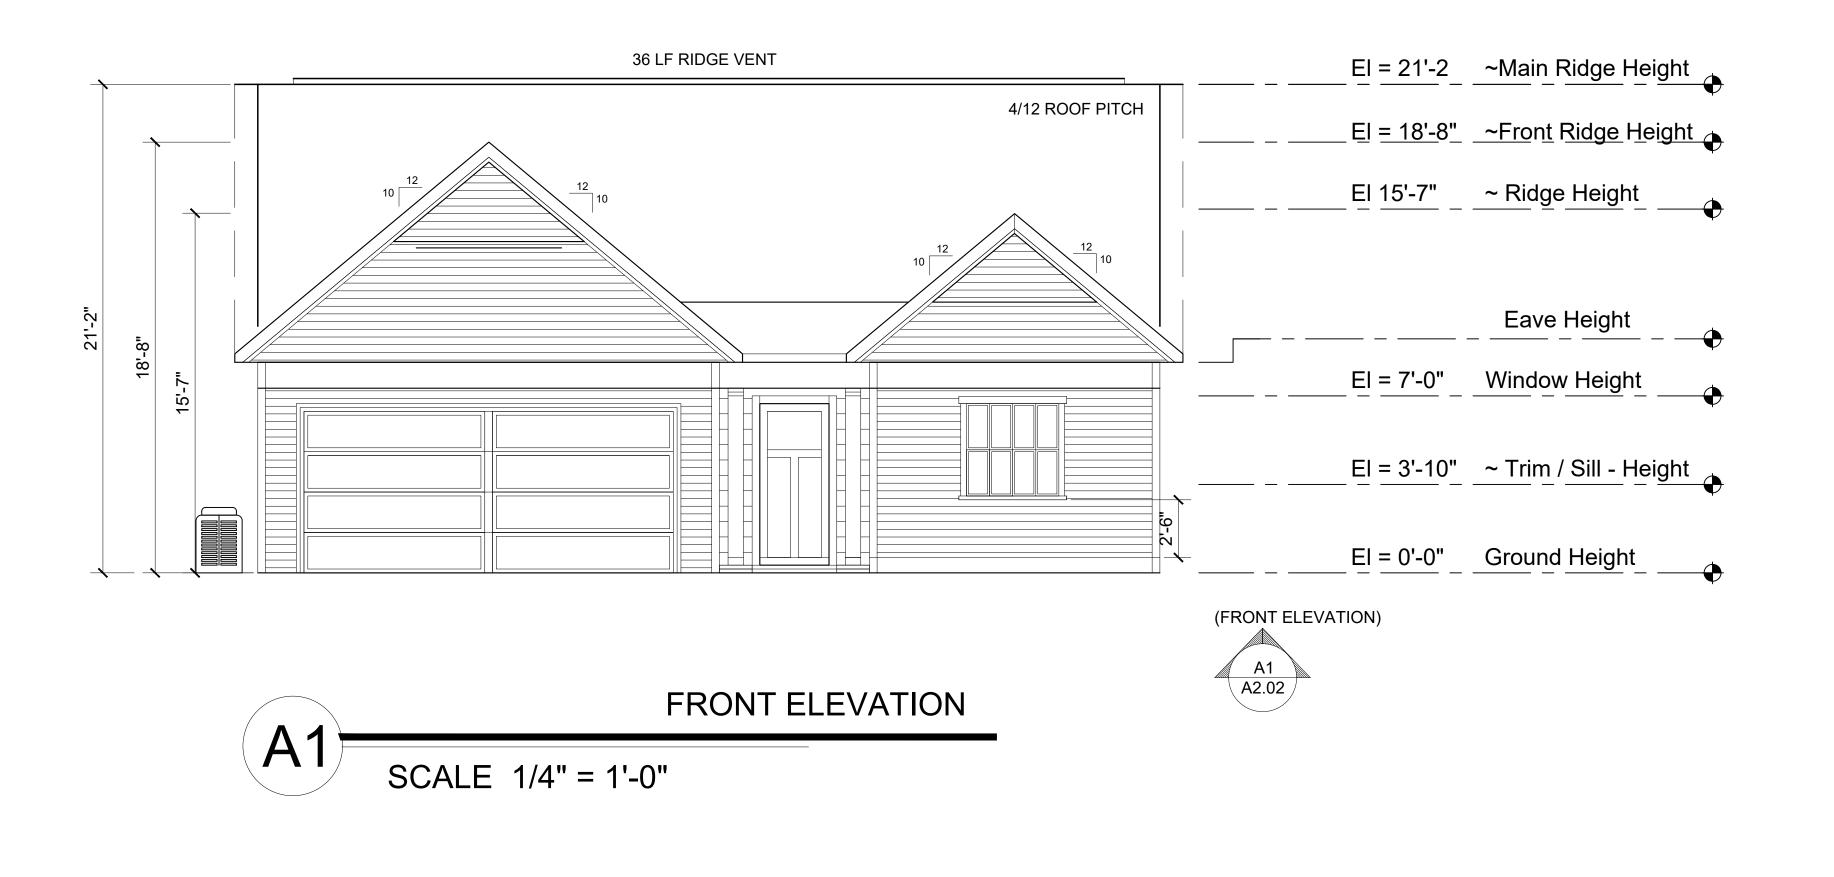


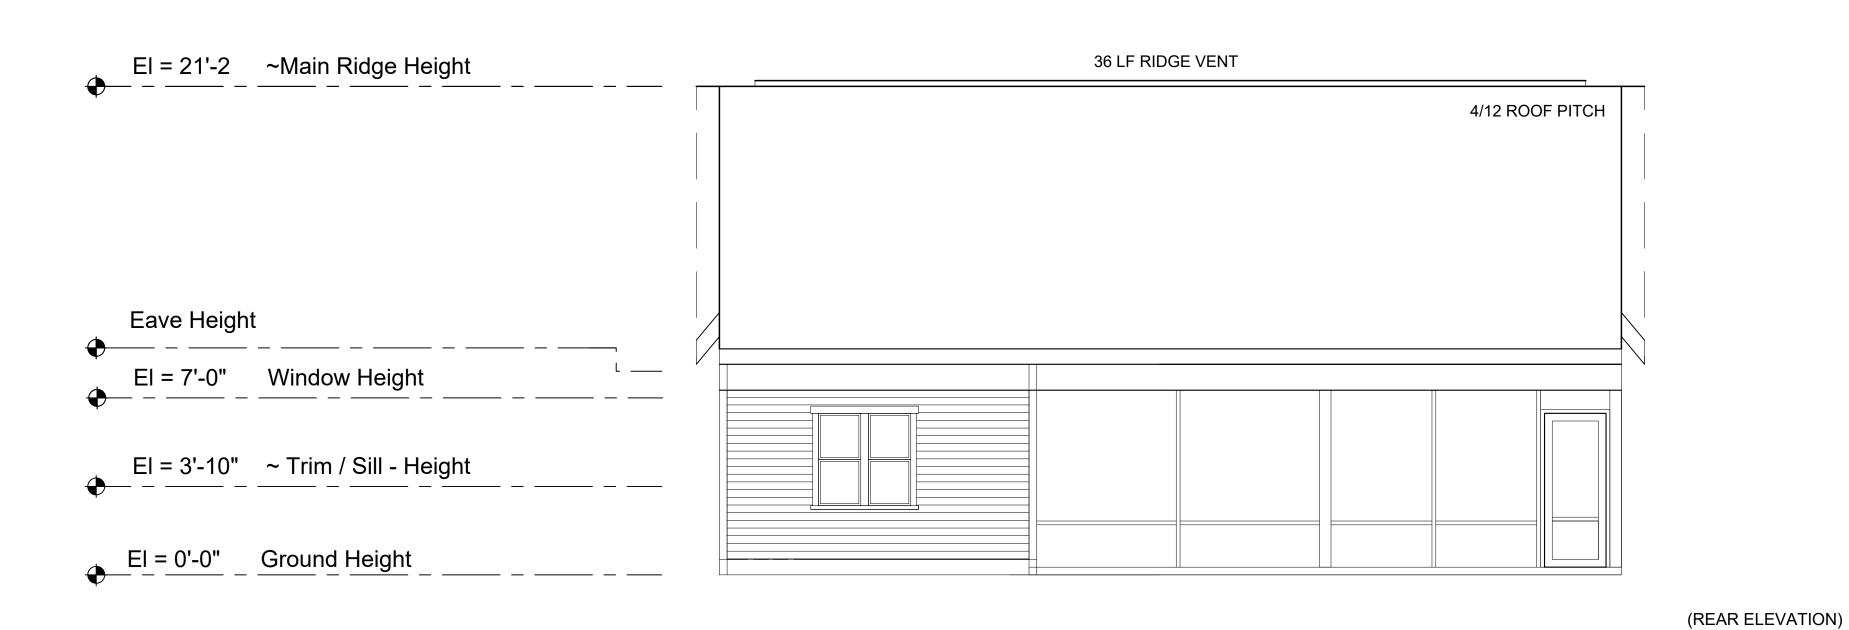

REAR ELEVATION

SCALE 1/4" = 1'-0"

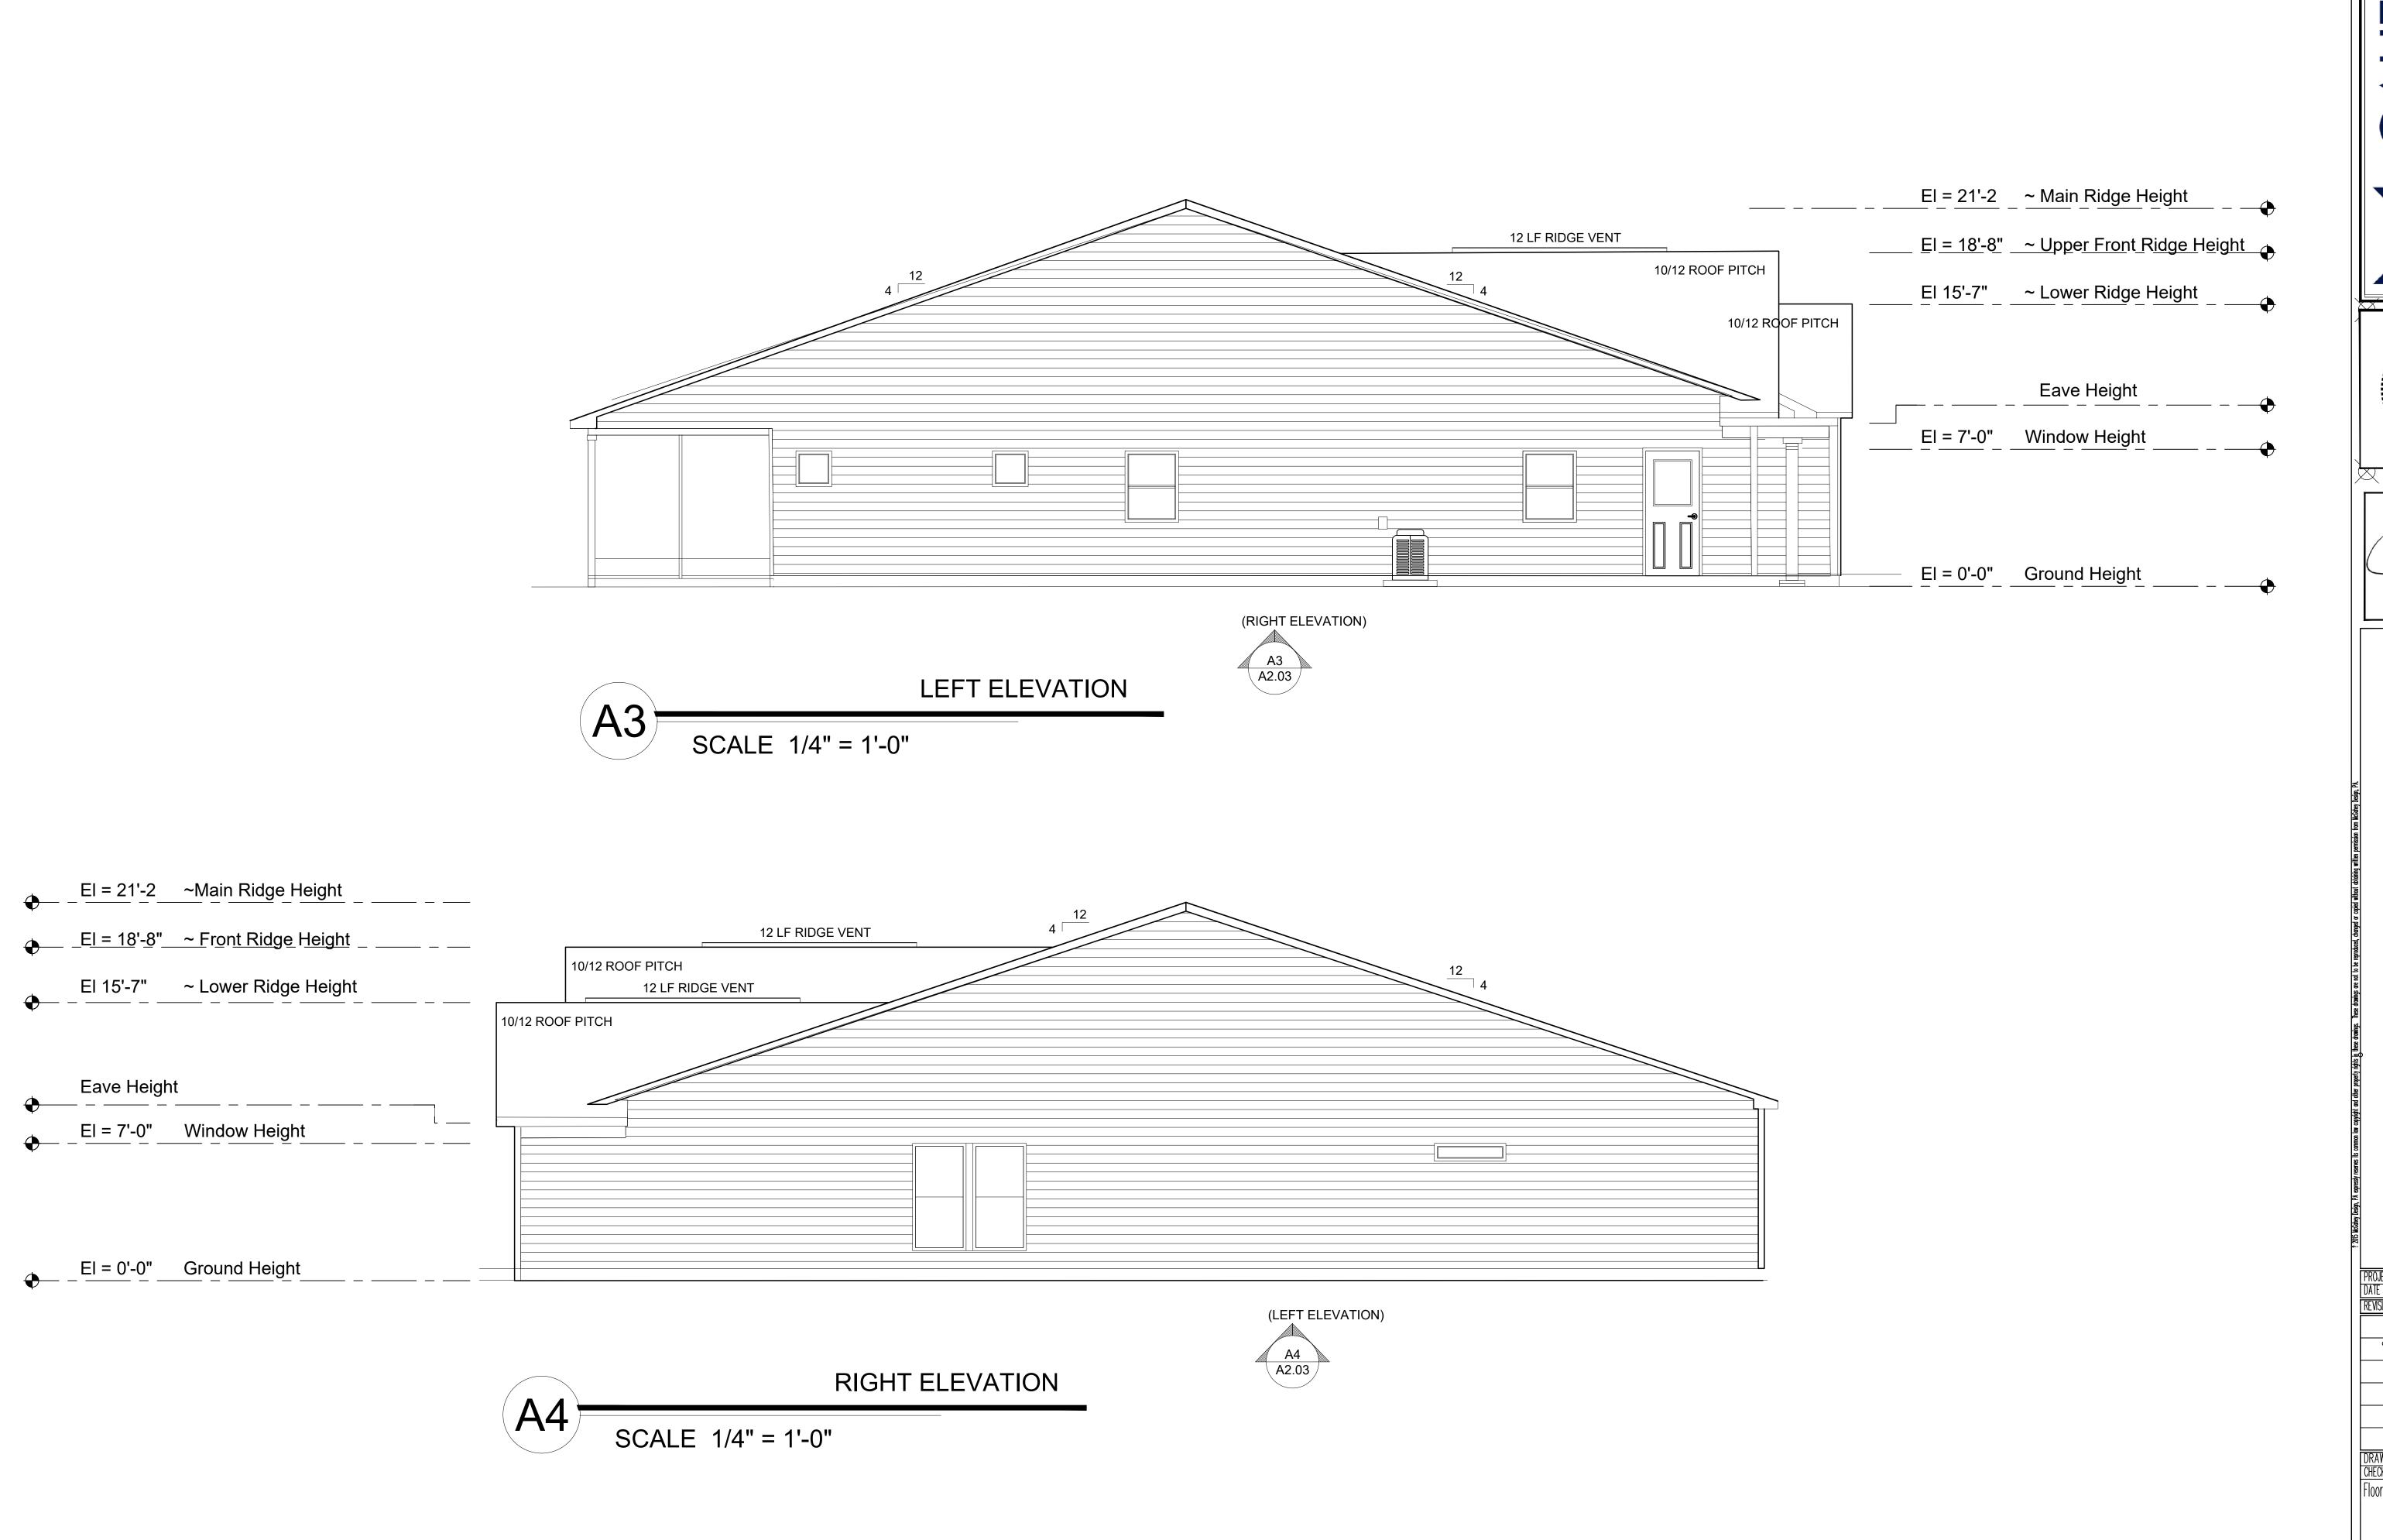

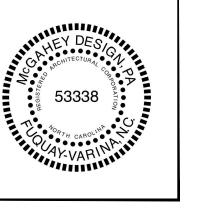




TUCKER RESIDENCE LEFT SIDE GARAGE

DRAWN BY: CHECK BY: Floor Plan & Details

A1.03

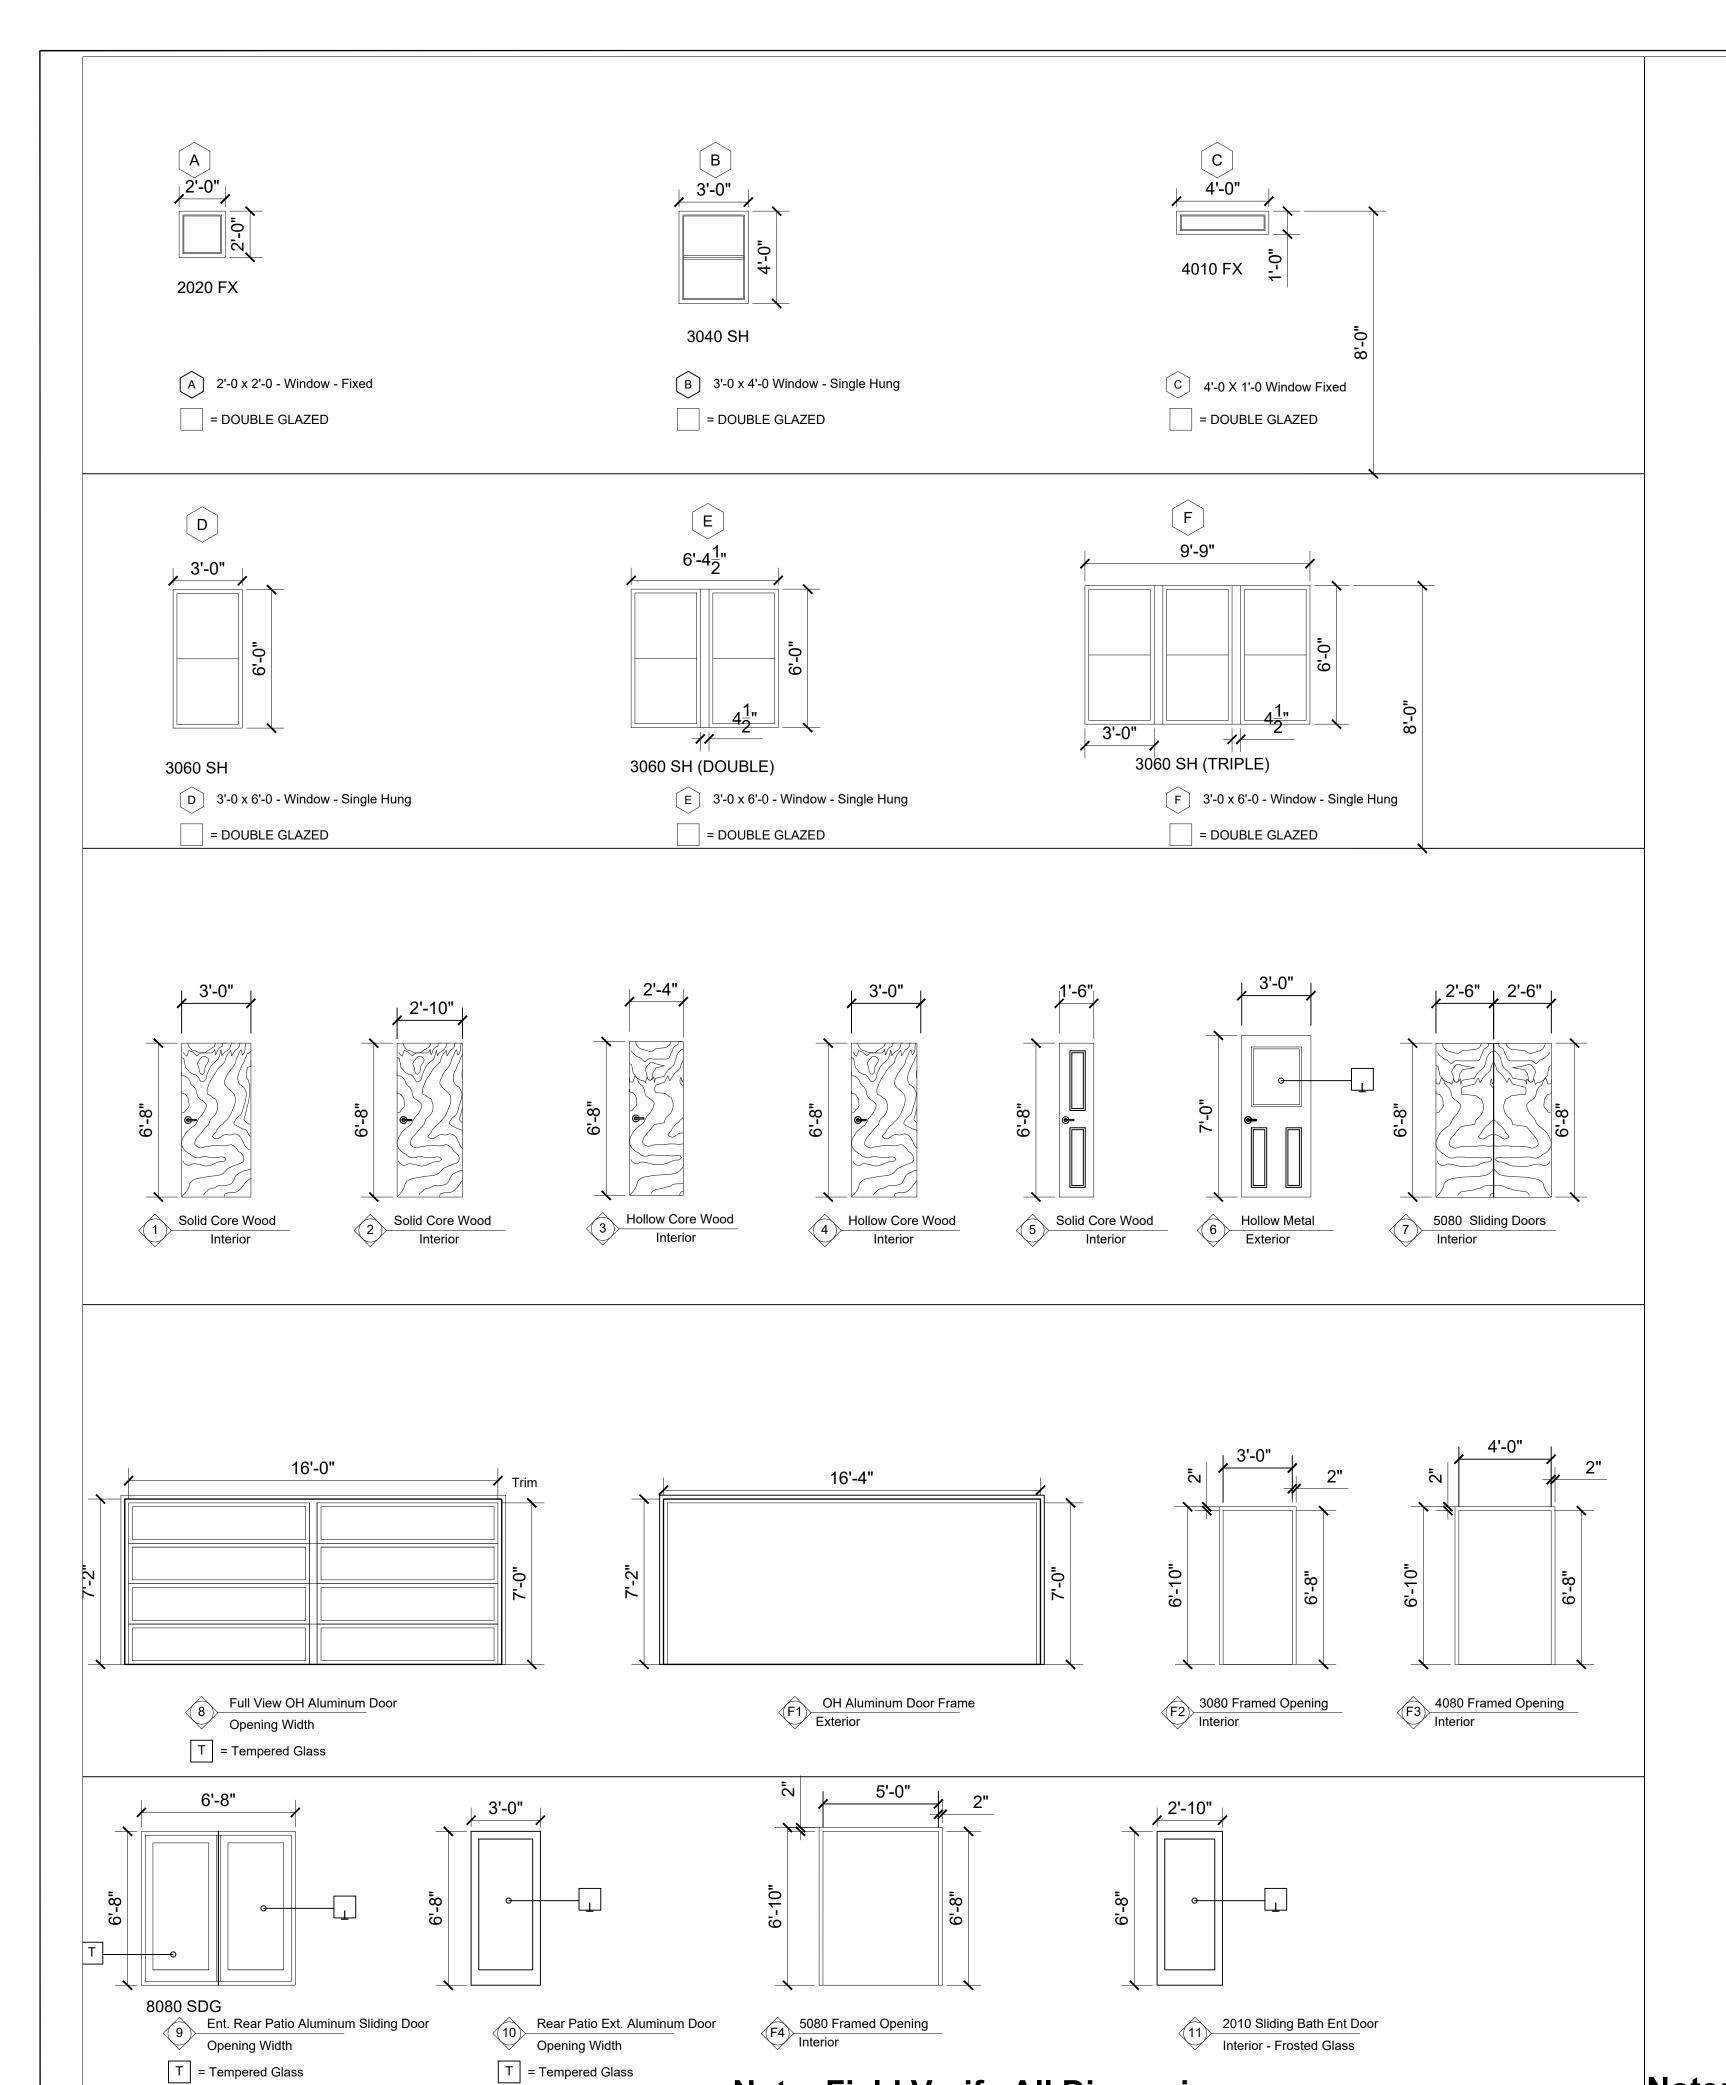

Note: Field Verify All Dimensions.

Room Finish Schedule							
Mark	Room Name	Floor	Base	Wall	Ceiling	Clg. Hgt.	Remarks
100	2 Car Garage	Sealed Concrete	NA	Painted Drywall	5/8 Gypsum	9'-0"	Fireproof
101	Pantry	Ceramic	Baseboard	Painted Drywall	Sheetrock	9'-0"	Waterproof
102	Laundry Room	Ceramic	Ceramic	Painted Drywall	Sheetrock	9'-0"	Waterproof
103	Entry Area	Oak Floor	Baseboard	Painted Drywall	Sheetrock	9'-0"	
104	Foyer Area	Oak Floor	Baseboard	Painted Drywall	Sheetrock	9'-0"	
105	Porch	Ceramic	Ceramic	Painted Drywall	Sheetrock	9'-0"	
106	Kitchen	Ceramic	Ceramic	Painted Drywall	Sheetrock	9'-0"	Waterproof
107	Main Room	Oak Floor	Baseboard	Painted Drywall	Sheetrock	9'-0"	Tray Ceiling
108	Screened Patio	Ceramic	Ceramic	Painted Drywall	Sheetrock	9'-0"	Waterproof
109	Owners Suite	Oak Floor	Baseboard	Painted Drywall	Sheetrock	9'-0"	Tray Ceiling
110	Owners Bath	Ceramic	Ceramic	Painted Drywall	Sheetrock	9'-0"	Wet Room
111	Walk-in-Closet	Oak Floor	Baseboard	Painted Drywall	Sheetrock	9'-0"	
112	Flex Space	Oak Floor	Baseboard	Painted Drywall	Sheetrock	9'-0"	Tray Ceiling
113	Second Bath	Ceramic	Ceramic	Painted Drywall	Sheetrock	9'-0"	Wet Room
114	Second Bedroom	Oak Floor	Baseboard	Painted Drywall	Sheetrock	9'-0"	
115	HVAC Closet	Ceramic	Ceramic	Painted Drywall	Sheetrock	9'-0"	Fireproof
116	Store Room	Oak Floor	Baseboard	Painted Drywall	Sheetrock	9'-0"	Fireproof

Door Schedule						
	Door		Frame			
Mark	Size	Mat'l	Туре	Mat'l	Interior/ Exterior	Remarks
1	3'-0" X 7'-0"	Wood	Interior	Wood	Interior	Interior Door
2	2'-10" X 6'-8"	Wood	Interior	Wood	Interior	Interior Door
3	2'-4" X 6'-8"	Wood	Interior	Wood	Interior	Interior Door
4	3'-0" X 6'-8"	Wood	Interior	Wood	Interior	Interior Door
5	1'-6" X 6'-8"	Wood	Interior	Wood	Interior	Interior Door
6	3'-0" X 7'-0"	Alum	Interior	Wood	Interior	Interior Door
7	2'-6" X 6'-8" Pair	Wood	Interior	Wood	Interior	Interior Door
8	16'-0" X 7'-0"	Alum	Exterior	Wood	Exterior	Full OH Door - Grey Tint Glass
9	6'-8" X 6'-8"	Alum	Exterior	Alum	Exterior	8080-Sliding Door-Grey Tint Glass
10	3'-0" X 6'-8"	Alum	Exterior	Alum	Exterior	Alum. Door-Grey Tint Glass
11)	2'-10" X 6'-8"	Wood	Interior	Wood	Interior	Sliding Door-Frosted Glass
F2	3'-0" X 6'-8"			Wood	Interior	3080 Framed Opening
(F3)	4'-0" X 6'-8"			Wood	Interior	4080 Framed Opening
F4	4'-0" X 6'-8"			Wood	Interior	5080 Framed Opening

Window Schedule							
Mark	W Size H	Туре	Material	Glass	Remarks		
A	2'-0 x 2'-0	FIXED	Alum	3/4" Insul. Glass	SINGLE		
В	3'-0 x 4'-0	SINGLE HUNG	Alum	3/4" Insul. Glass	SINGLE		
C	4'-0 x 1'-0	FIXED	Alum	3/4" Insul. Glass	SINGLE		
D	3'-0 x 6'-0	SINGLE HUNG	Alum	3/4" Insul. Glass	SINGLE		
E	3'-0 x 6'-0	SINGLE HUNG	Alum	3/4" Insul. Glass	TWIN		
F	3'-0 x 6'-0	SINGLE HUNG	Alum	3/4" Insul. Glass	TRIPLE		

Note: Field Verify All Dimensions.

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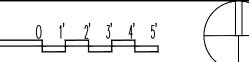
SIDE GARAGE

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SIDE GA

Floor Plan, Elevations, Details
Scale: As Shown






PROJECT: 2021–10


DATE ISSUED: 04.12.21

DRAWN BY: CHECK BY: Floor Plan & Details


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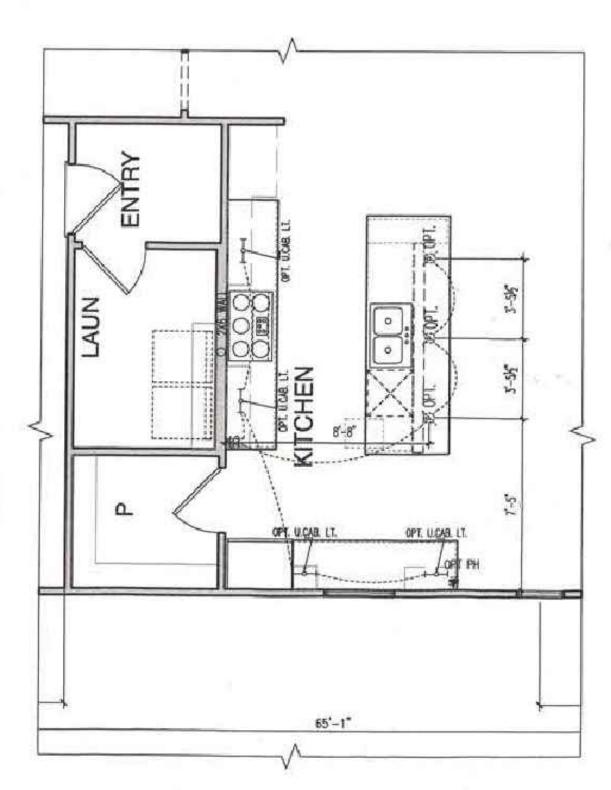
SCALE 1/4" = 1"-0" (NOTE: SCALE 1/8"=1"-0" ON 11X17 PAPER)

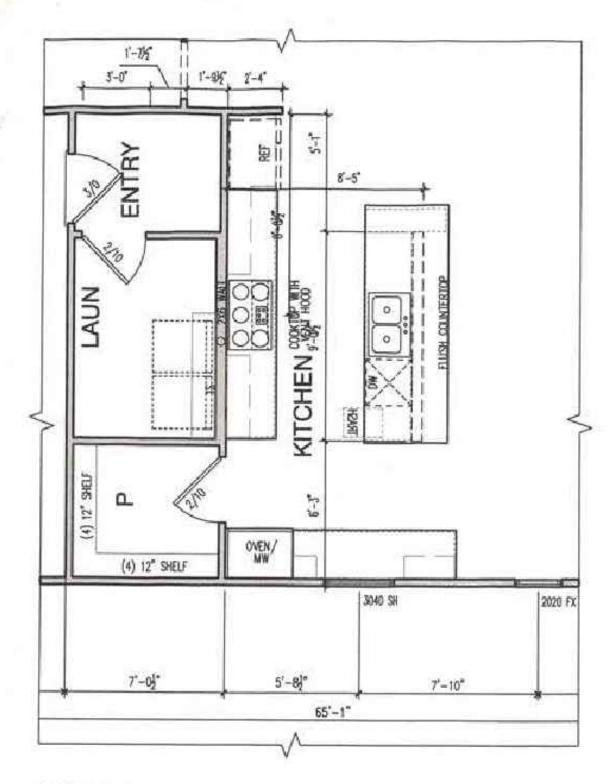

SCALE 1/4" = 1'-0" (NOTE: SCALE 1/8"=1'-0" ON 11X17 PAPER)

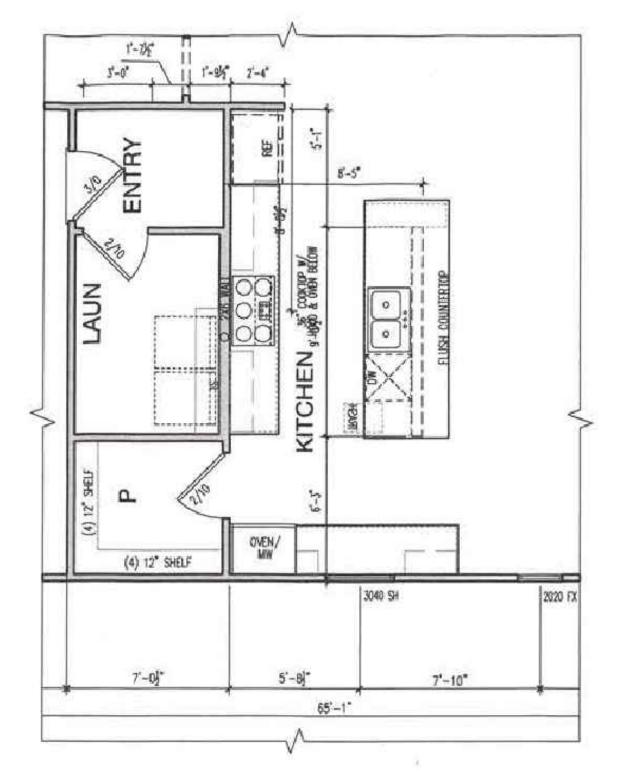


SCALE 1/4" = 1'-0" (NOTE: SCALE 1/8"=1'-0" ON 11X17 PAPER)

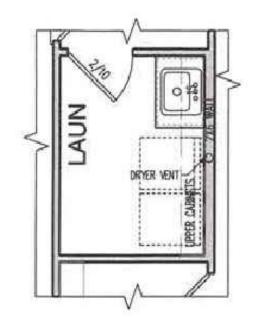


KITCHEN LAYOUT 4
OPTIONAL UTILITY PLAN


SCALE 1/4" = 1'-0" (NOTE: SCALE 1/8"=1'-0" ON 11X17 PAPER)

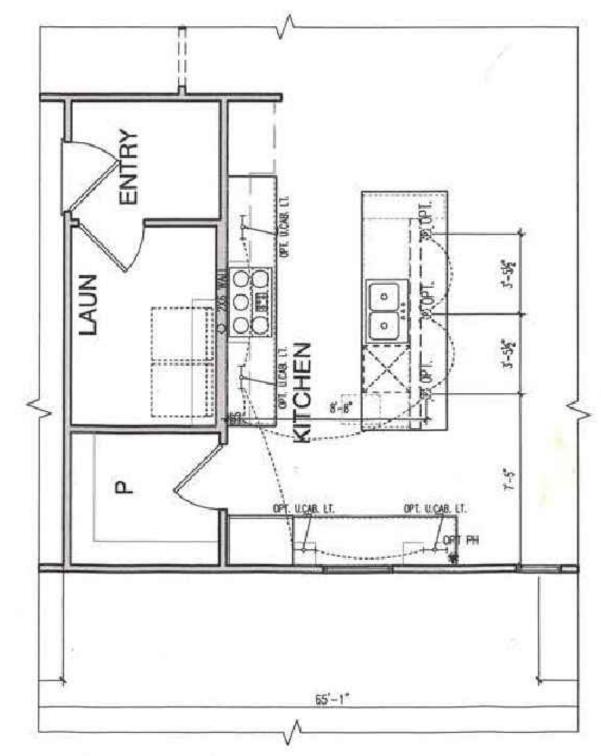


KITCHEN LAYOUT 5
OPTIONAL UTILITY PLAN

SCALE 1/4" = 1"-0" (NOTE: SCALE 1/8"=1"-0" ON 11X17 PAPER)

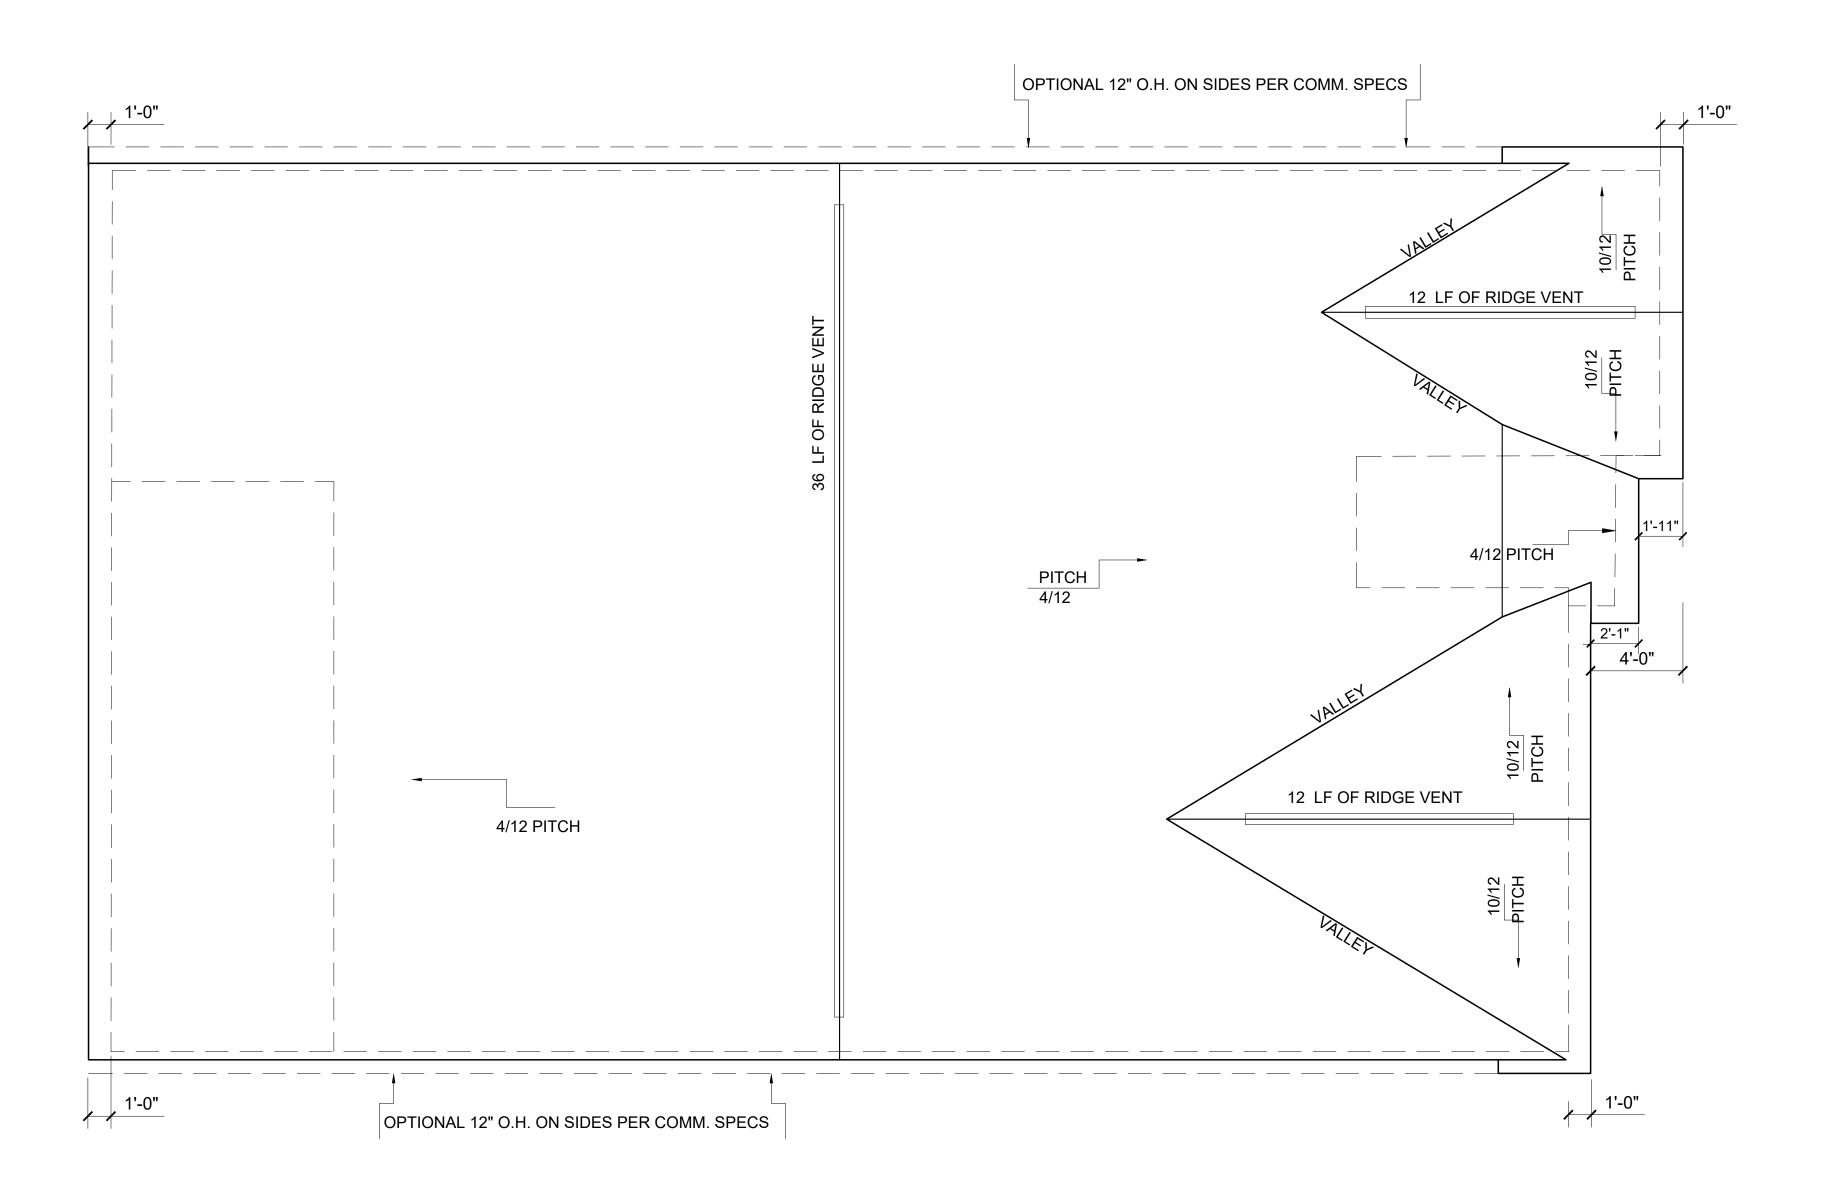

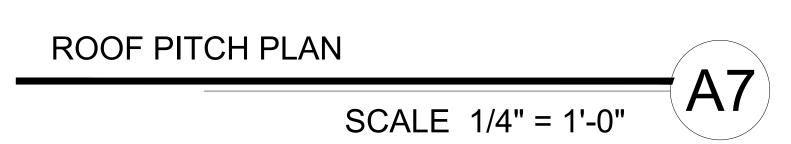

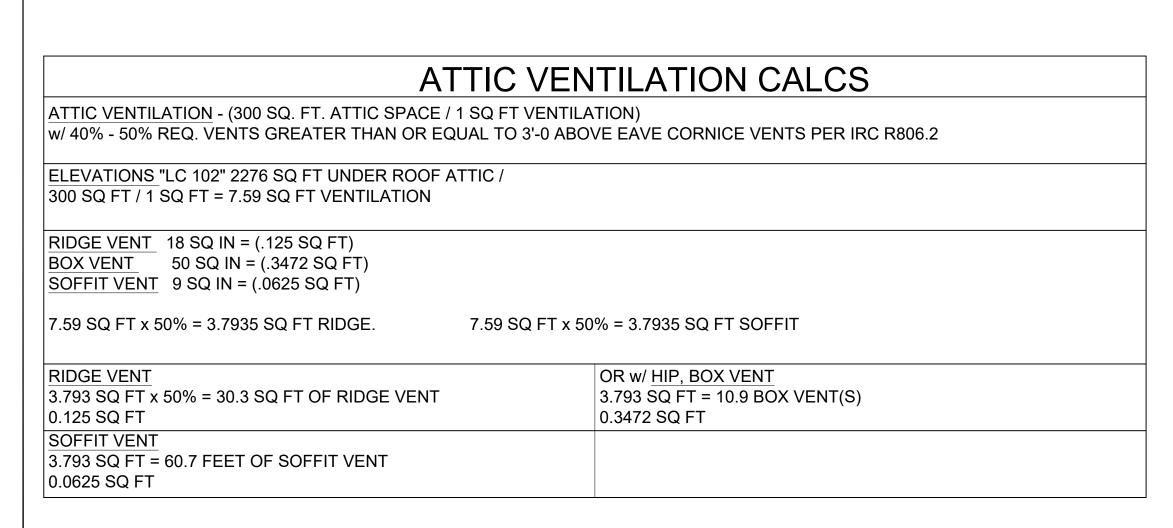











TUCKER RESIDENCI LEFT SIDE GARAGE

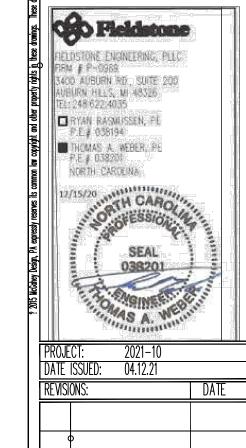

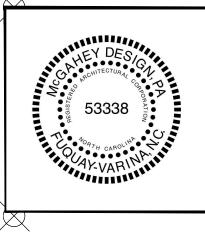


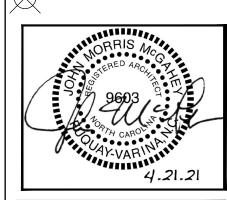



(ER RE SIDE (

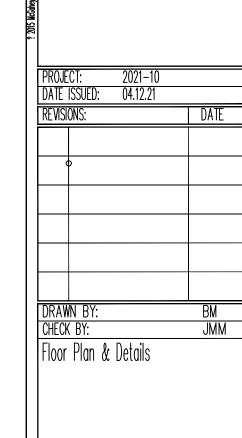


A6.01

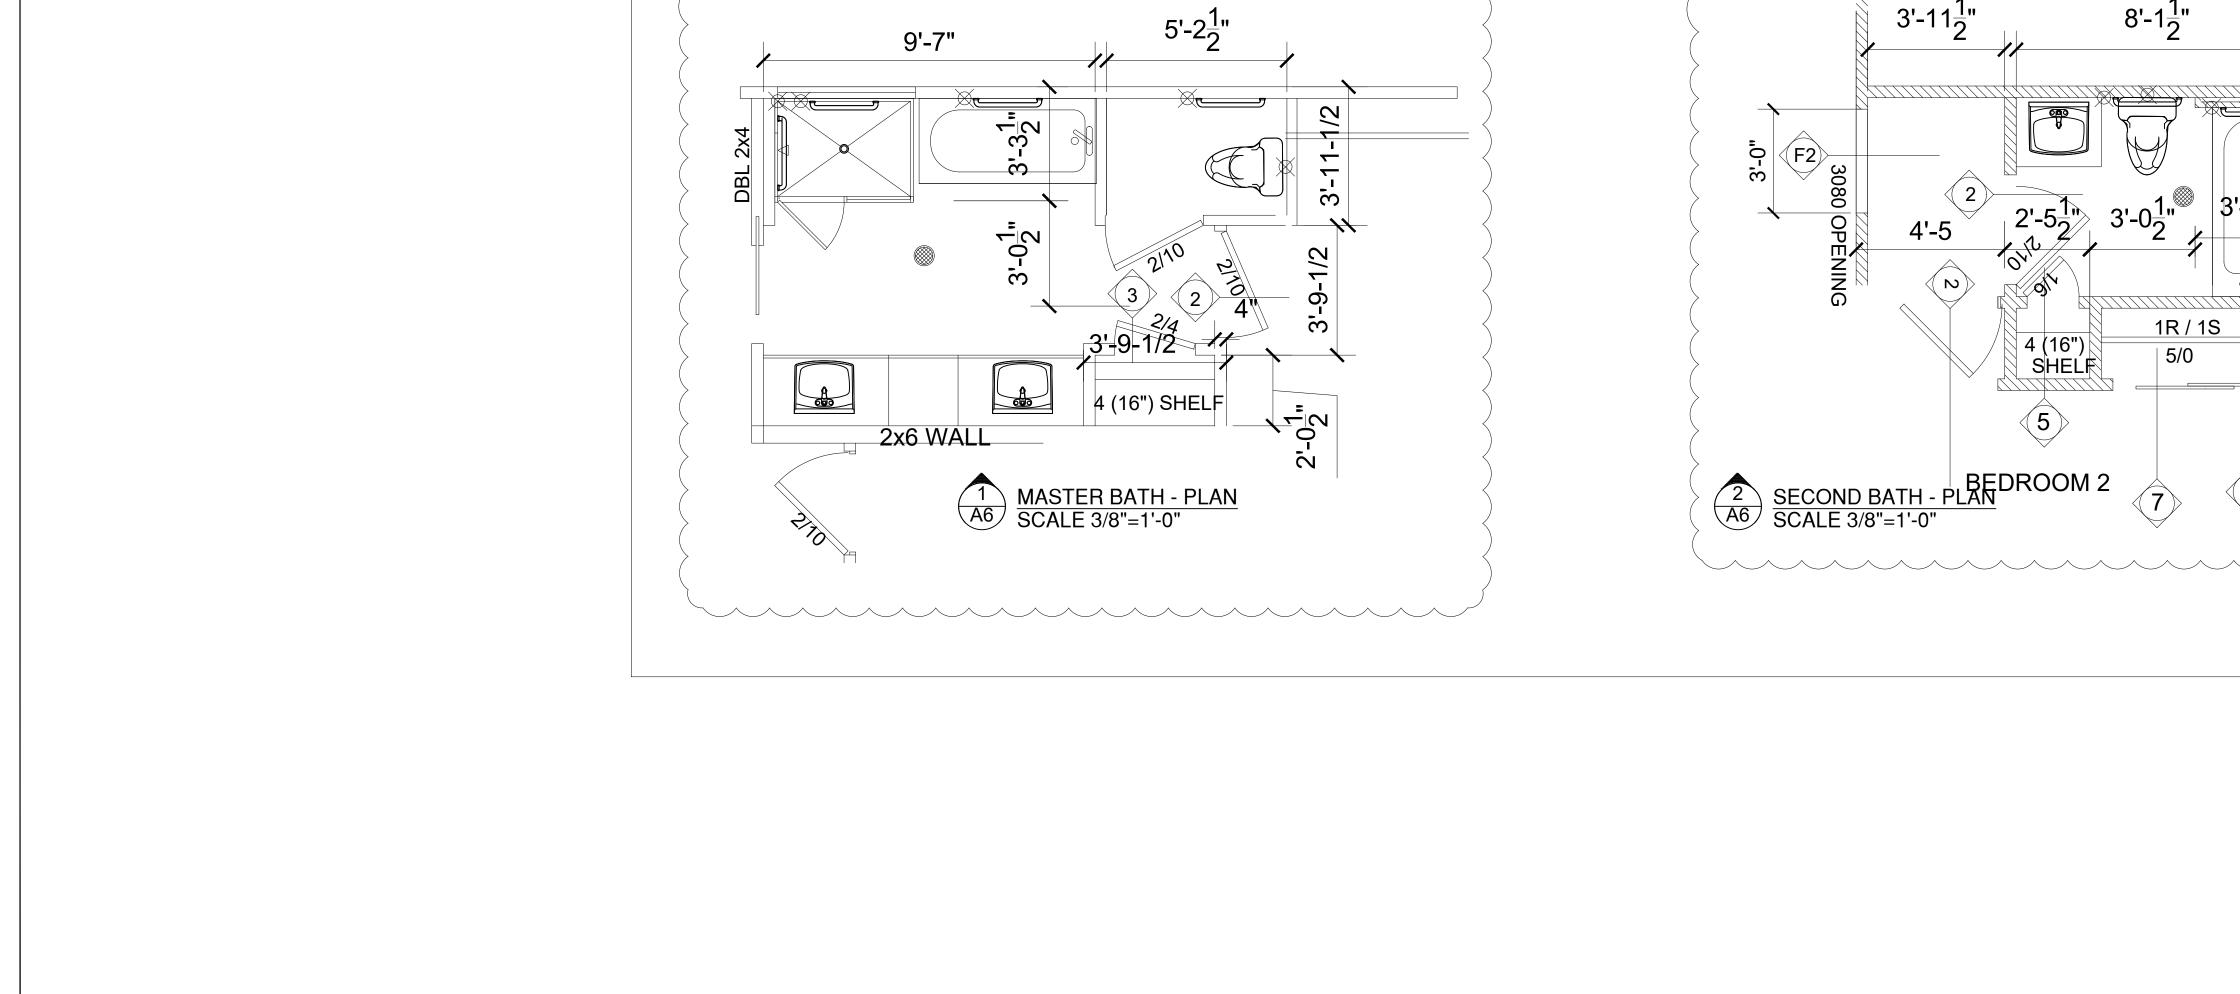

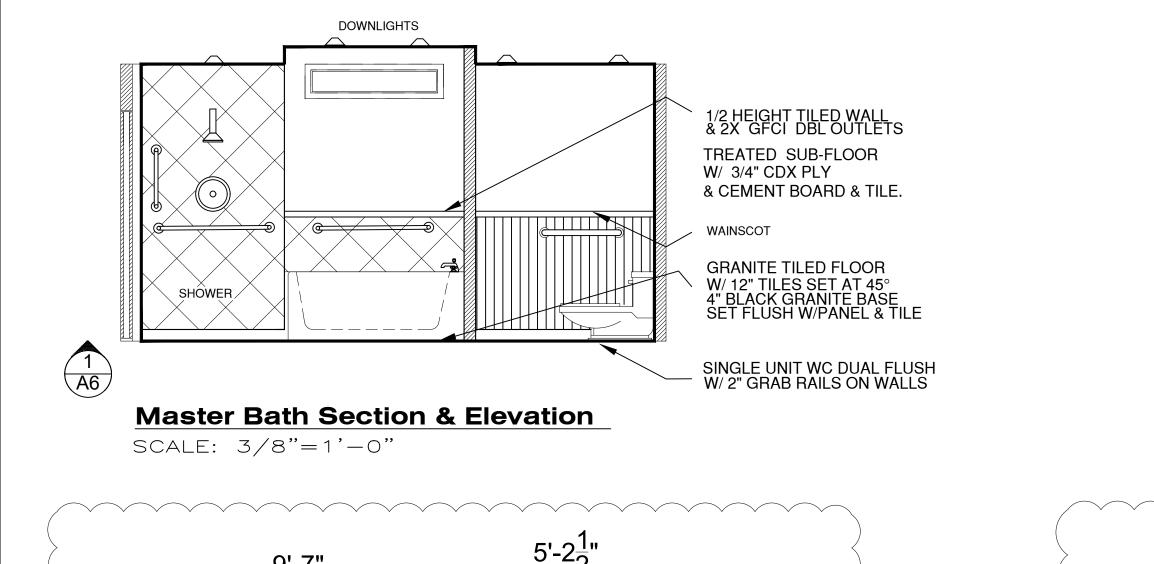

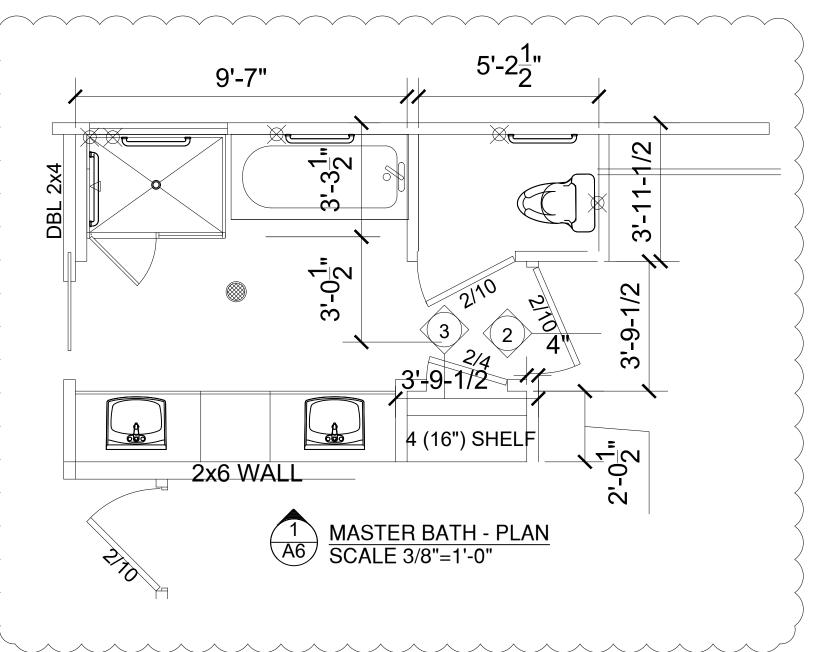

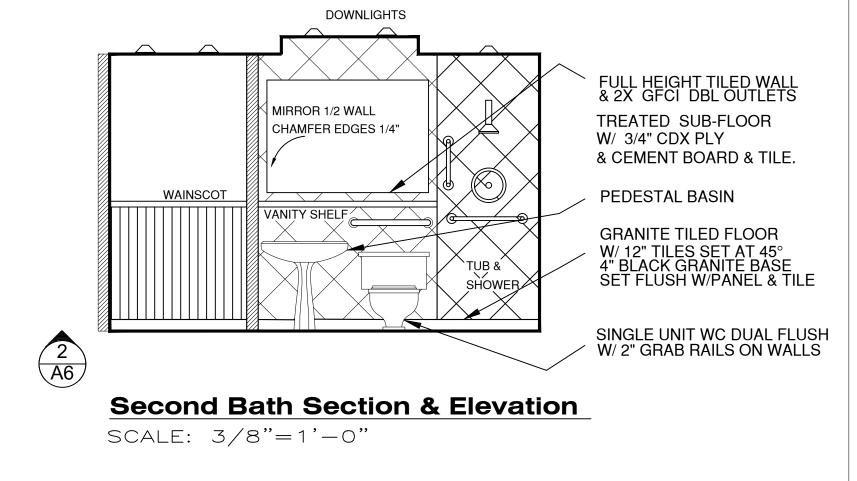

KEY LEGEND

Scale 5/8" =1'-0" A1.01

SHEET NUMBER

DETAIL NUMBER

SHEET REF.

VIEW DETAIL

CONTROL /ELEV MARK

NORTHING / EASTING

BOUNDARY LINE

CALLOUT

REVCLOUD

\04200.A, 4"

NORTH ARROW

DOOR MARK

KEYNOTE MARK

DEMO MARK


REVISION MARK-AREA


ROOM NAME


xxx

04200.A

XXX

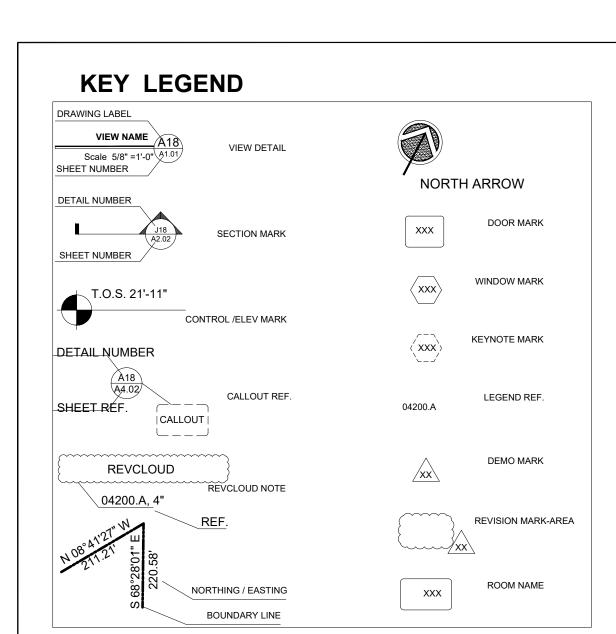

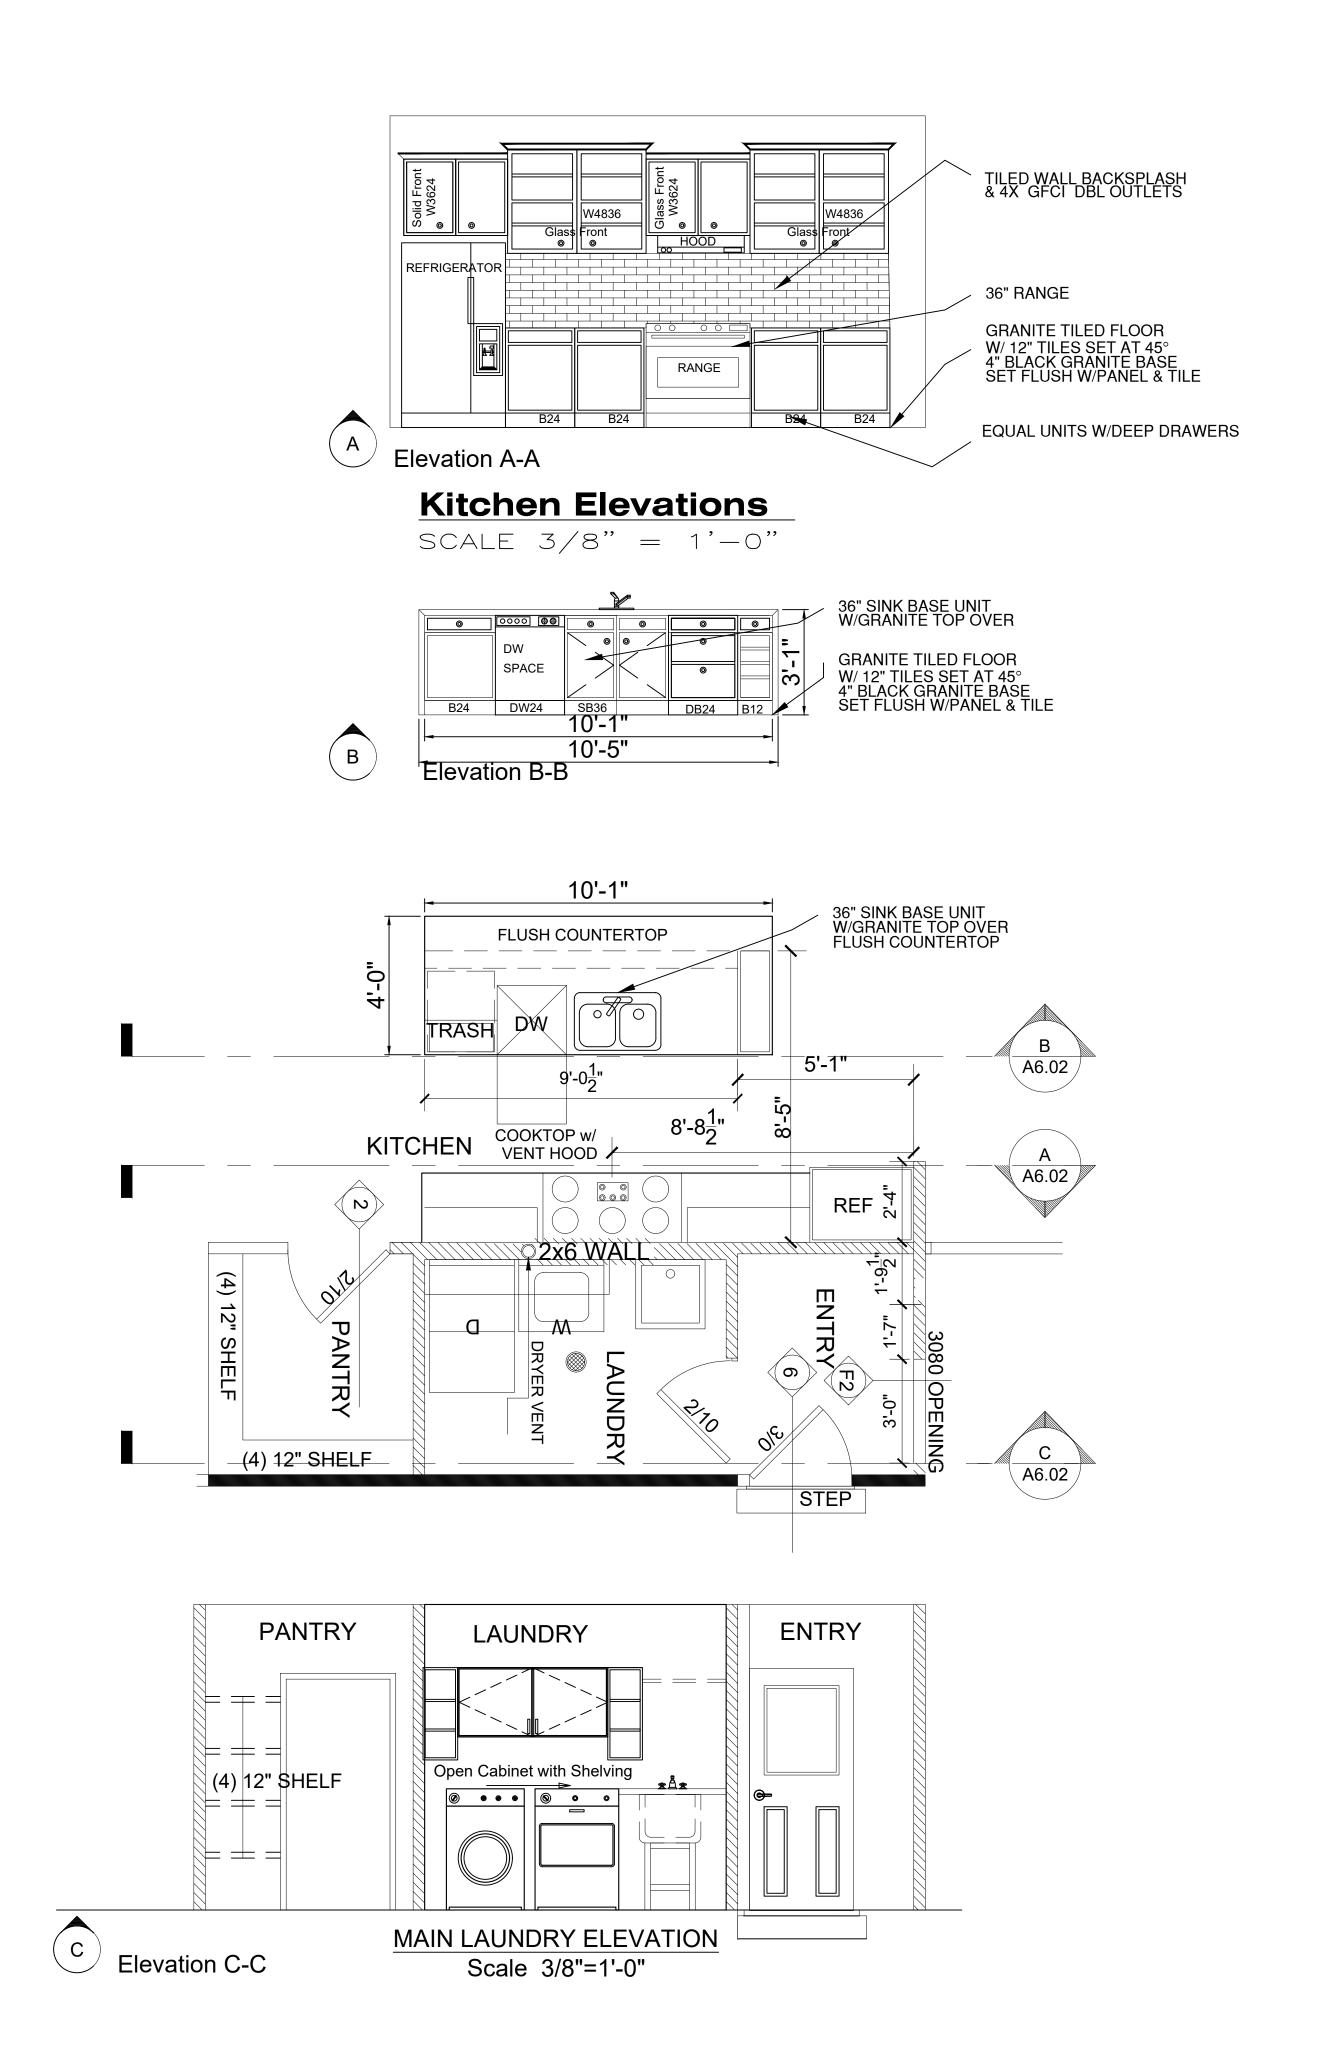


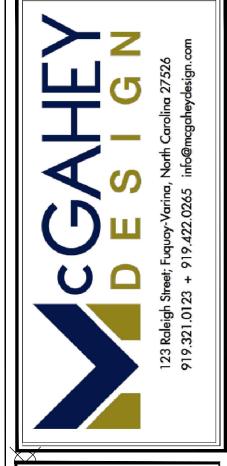






TUCKER RESIDENCE LEFT SIDE GARAGE

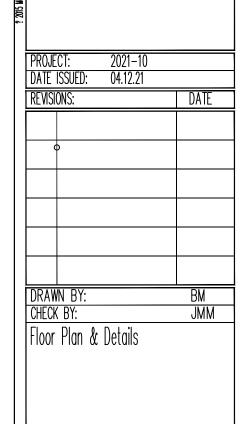

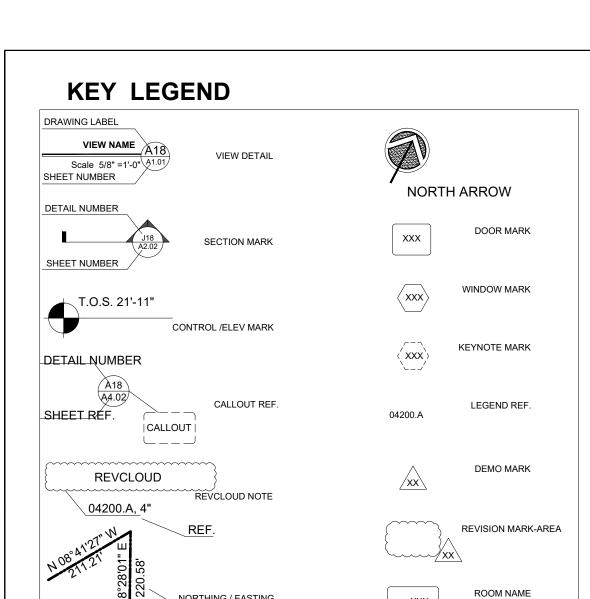

FRAMING NOTES

- ALL EXTERIOR WALLS ARE SHOWN AT 3-1/2 " UNLESS OTHERWISE SPECIFIED.
- ALL INTERIOR WALLS ARE SHOWN AT 3-1/2 " UNLESS OTHERWISE SPECIFIED.
- 3 SOLID BLOCK ALL GIRDERS & BEAMS TO THE FOUNDATION.
- 4 ALL INTERIOR NON-LOAD BEARING WALLS TO BE 16" O.C.
- 5 ALL LOAD BEARING WALLS TO 16" O.C.
- ALL HEADERS TO BE (2) PLY U.N.O. 2x4 AND 2x8 TO BE SPF OR SP No. 2 OR BETTER. HEADERS GREATER THAN 2x6 TO BE SP No. 2 OR BETTER.
- PROVIDE SOLID BLOCKING OR BLOCKING PER JOIST MANUFACTURER BETWEEN ALL JOISTS AT ALL COLUMN POINT LOADS, BEAMS, GIRDERS, AND LOAD BEARING WALLS.
- FLOOR SYSTEM ENGINEERED BY OTHERS. INSTALL PER MANUFACTURERS RECOMMENDATION, NOTES & DETAILS, CHANGES OR MODIFICATIONS TO THESE DOCUMENTS ARE NOT PERMITTED WITHOUT A LETTER FROM THE ENGINEER OF RECORD.

TRUSS NOTES

- 1 UNLESS OTHERWISE NOTED
- TRUSS STRAPS TO BE SIMPSON H2.5A w/10d NAILS MIN. (2) M2.5A TO BE USED TO MULTI-PLY TRUSS (1) EACH SIDE w/8d NAILS MIN.
- K2.5T TRUSS STRAPS ARE TO BE USED U.O. H2.5A WHEN EXTERIOR SHEATHING IS NOT NAILED TO THE TOP PLATE OF THE WALL.
- ENGINEERING PROVIDED BT TRUSS MANUFACTURER, CHANGES OR MODIFICATIONS ARE NOT PERMITTED WITHOUT A LETTER FROM THE ENGINEER OF RECORD.
 - FOR GABLE END BRACING, START AT ROOF SIDELINE ANDS BRACE PER DETAIL REFER TO STRUCTURAL DETAILS FOR ADDITIONAL INFORMATION.

THESE PLANS ARE ENGINEERED BASED ON TRUSS LAYOUTS AND

- HIP JACKS TO BE TOE NAILED w/ (3) 10d NAILS MIN. TO HIP ORDER TRUSS
- WALL SHEATHING TO BE CONTINUOUS THROUGH FLOOR SYSTEM. BLOCK ALL SEAMS.

ATTIC VENTILATION CALCS

ATTIC VENTILATION - (300 SQ. FT. ATTIC SPACE / 1 SQ FT VENTILATION)

w/ 40% - 50% REQ. VENTS GREATER THAN OR EQUAL TO 3'-0 ABOVE EAVE CORNICE VENTS PER IRC R806.2

ELEVATIONS "LC 102" 2276 SQ FT UNDER ROOF ATTIC / 300 SQ FT / 1 SQ FT = 7.59 SQ FT VENTILATION

RIDGE VENT 18 SQ IN = (.125 SQ FT) BOX VENT 50 SQ IN = (.3472 SQ FT) SOFFIT VENT 9 SQ IN = (.0625 SQ FT)

|7.59 SQ FT x 50% = 3.7935 SQ FT RIDGE.

7.59 SQ FT x 50% = 3.7935 SQ FT SOFFIT

RIDGE VENT 3.793 SQ FT x 50% = 30.3 SQ FT OF RIDGE VENT 0.125 SQ FT

3.793 SQ FT = 10.9 BOX VENT(S)


OR w/ HIP, BOX VENT

0.3472 SQ FT

SOFFIT VENT


3.793 SQ FT = 60.7 FEET OF SOFFIT VENT

0.0625 SQ FT

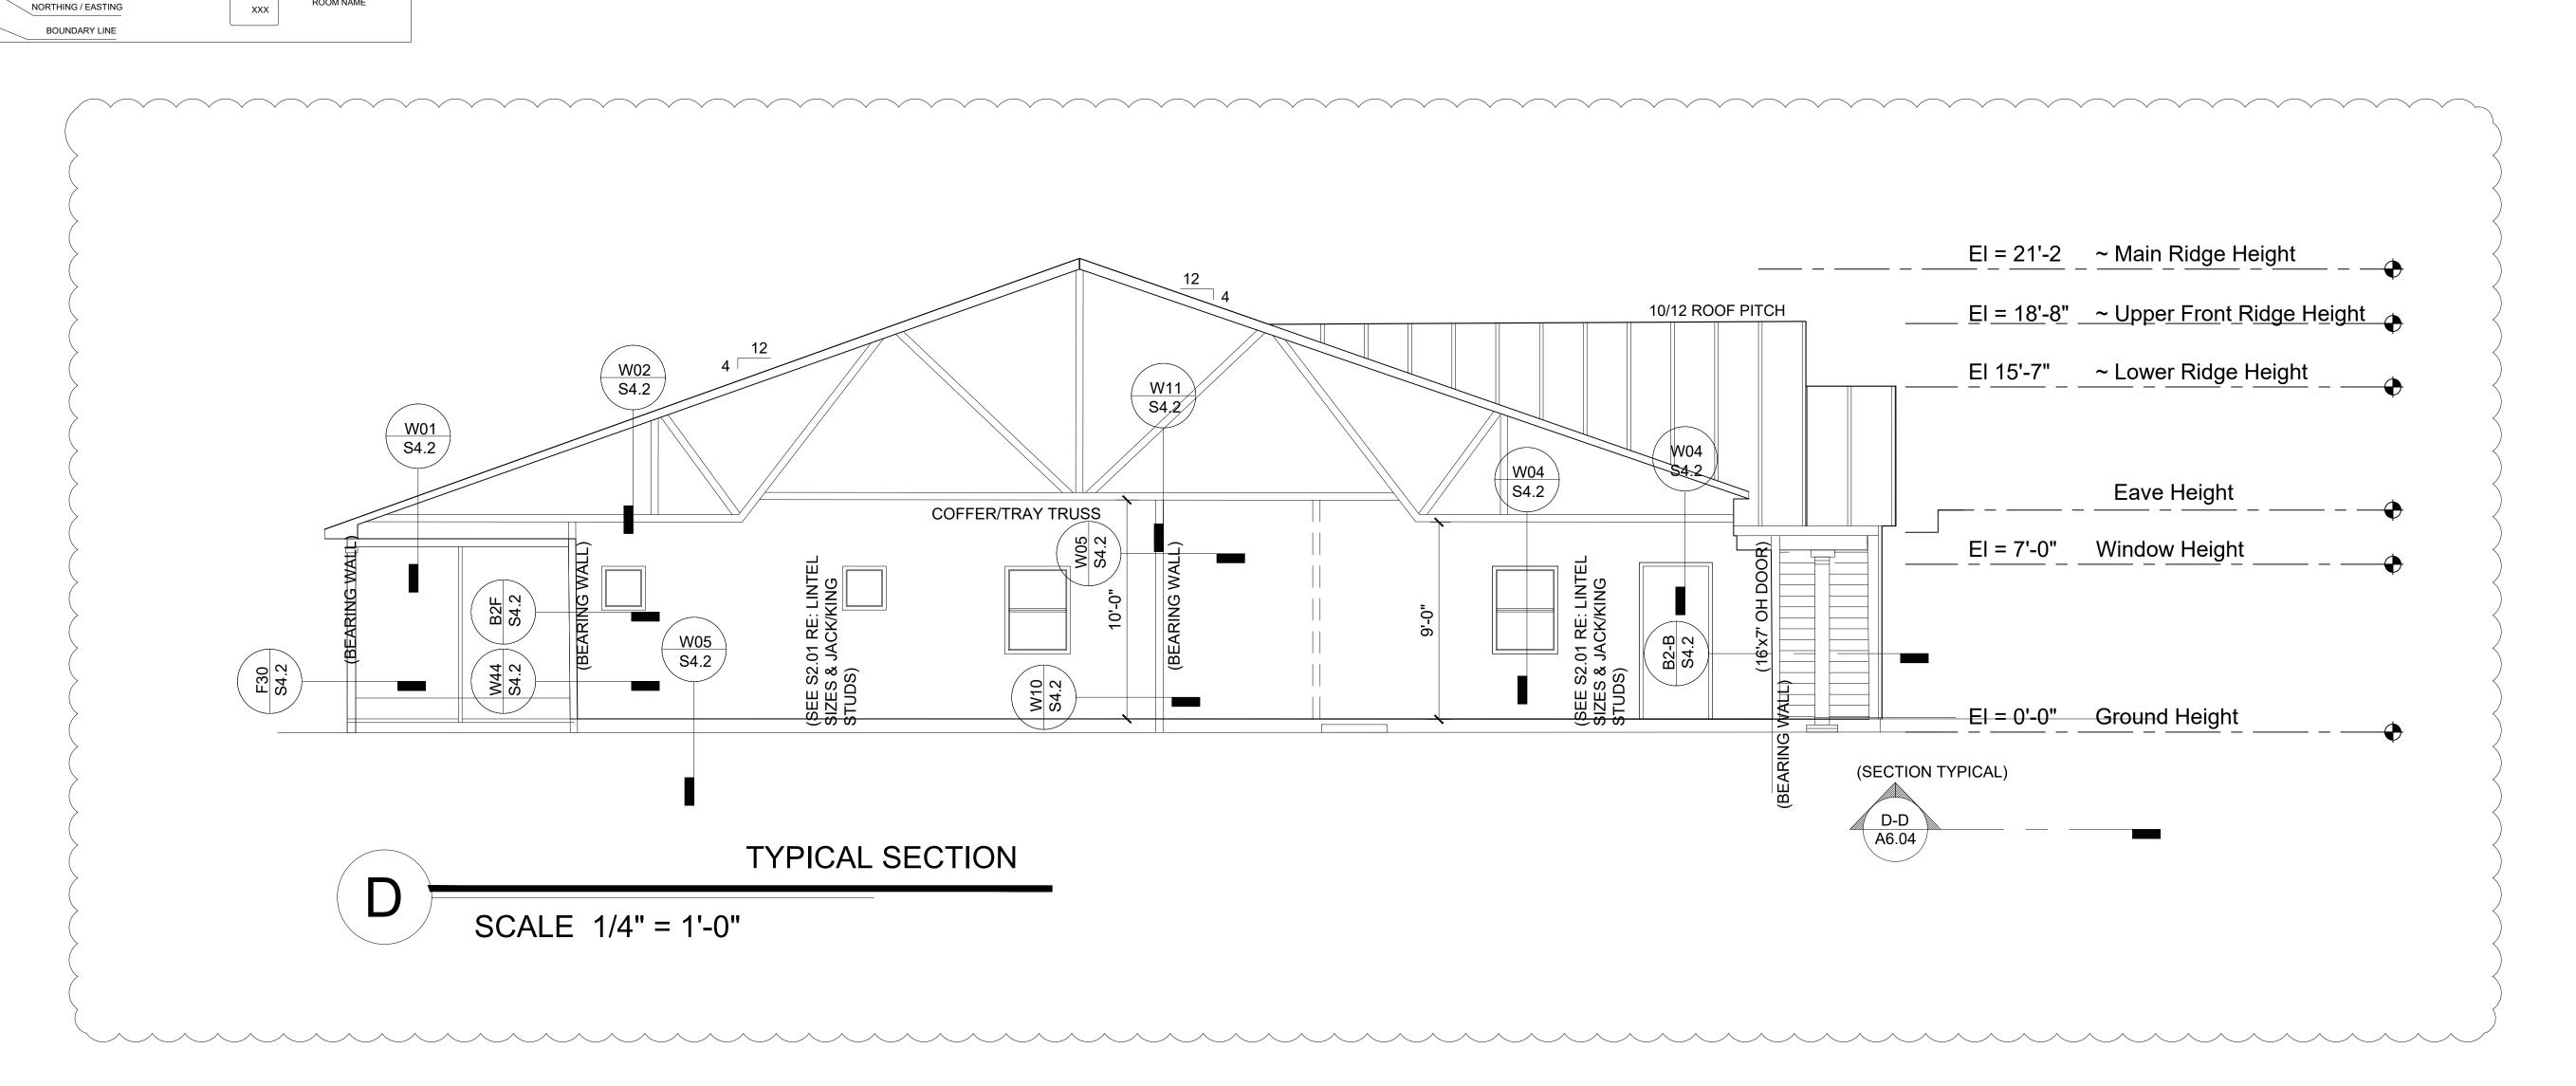






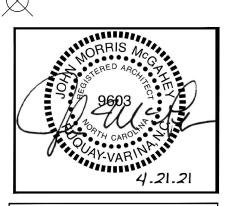


GE AR ER RE SIDE

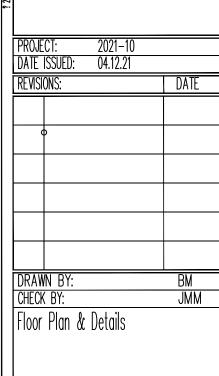

A6.03

Key Plan

Not to Scale

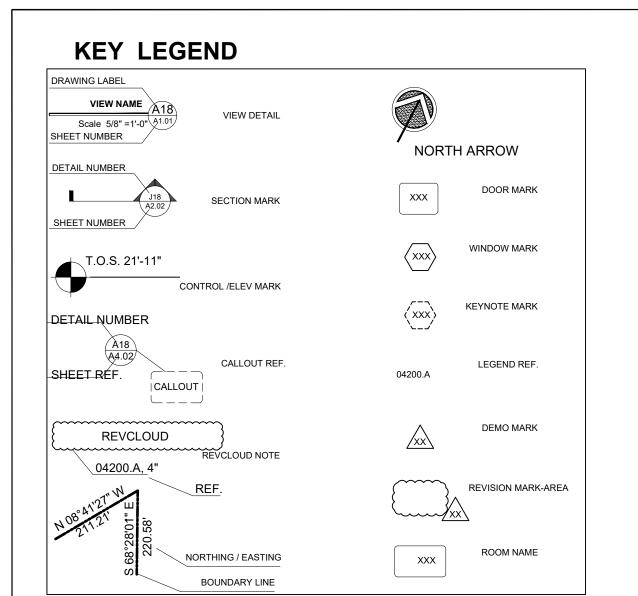

FRAMING NOTES ALL EXTERIOR WALLS ARE SHOWN AT 3-1/2 " UNLESS OTHERWISE SPECIFIED. ALL INTERIOR WALLS ARE SHOWN AT 3-1/2 " UNLESS OTHERWISE SPECIFIED. SOLID BLOCK ALL GIRDERS & BEAMS TO THE FOUNDATION. 4 ALL INTERIOR NON-LOAD BEARING WALLS TO BE 16" O.C. 5 ALL LOAD BEARING WALLS TO 16" O.C. ALL HEADERS TO BE (2) PLY U.N.O. 2x4 AND 2x8 TO BE SPF OR SP No. 2 OR PROVIDE SOLID BLOCKING OR BLOCKING PER JOIST MANUFACTURER BETWEEN ALL JOISTS AT ALL COLUMN POINT LOADS, BEAMS, GIRDERS, AND LOAD BEARING WALLS. RECOMMENDATION, NOTES & DETAILS, CHANGES OR MODIFICATIONS TO THESE DOCUMENTS ARE NOT PERMITTED WITHOUT A LETTER FROM THE ENGINEER OF RECORD.

