

**SOIL/SITE EVALUATION
 for ON-SITE WASTEWATER SYSTEM**

Owner: Applicant:
 Address: Date Evaluated:
 Proposed Facility: 3800ms Design Flow (.1949): 360gpd Property Size:
 Location of Site: Property Recorded:
 Water Supply: Public Individual Well Spring Other
 Evaluation Method: Auger Boring Pit Cut
 Type of Wastewater: Sewage Industrial Process Mixed

P R O F I L E #	.1940 Landscape Position/ Slope %	Horizon Depth (In.)	SOIL MORPHOLOGY .1941		OTHER PROFILE FACTORS				Profile Class & LTAR
			.1941 Structure/ Texture	.1941 Consistence Mineralogy	.1942 Soil Wetness/ Color	.1943 Soil Depth (IN.)	.1956 Sapro Class	.1944 Restr Horiz	
1	L9 0-2	0-29	G S	vf n us/mg					
		29-48	G S w/ pebbles	vf n us/mg					5.8
		48-60	SBK SCL	fn ss/mg					PS.4
2		0-28	G S	vf n us/mg					
		28-40	CSL w/ P60	fn ss/mg					13.5
		40- ⁺	SBK SCL	fn ss/mg					

Description	Initial System	Repair System	Other Factors (.1946):
Available Space (.1945)	✓	✓	Site Classification (.1948): <u>PS</u>
System Type(s)	<u>25% P60</u>		Evaluated By: <u>CX</u>
Site LTAR	<u>.5</u>	<u>.4</u>	Others Present: <u>-</u>

1x200" @ 18-24"

MAP NO. 2006-1122

MAP REFERENCE: MAP NO. 2006-1122

SITE PLAN APPROVAL


DISTRICT RA-30 USE SFD

#BEDROOMS 3

8-1-13
Zoning Administrator


"PINTAIL DRIVE"
50' R/W

NCSR # 1291 "OLD US 421" 60' R/W

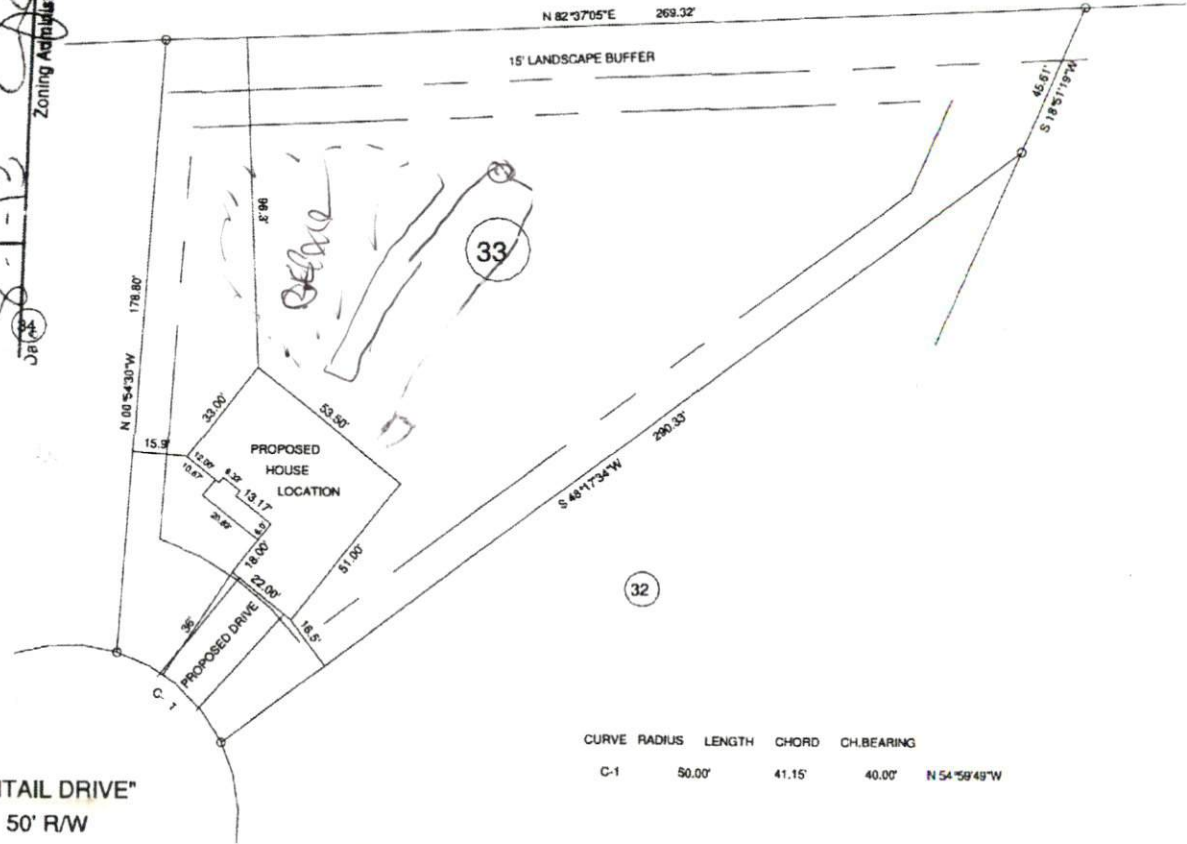

CURVE	RADIUS	LENGTH	CHORD	CH. BEARING
C-1	50.00'	41.15'	40.00'	N 54°59'49"W

- MINIMUM BUILDING SET BACKS**
- FRONT YARD — 30'
 - REAR YARD — 25'
 - SIDE YARD — 10'
 - CORNER LOT SIDE YARD — 20'
 - MAXIMUM HEIGHT — 35'

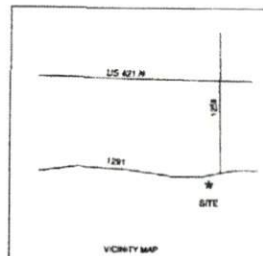

SURVEY FOR:				BENNETT SURVEYS	
PROPOSED PLOT PLAN - LOT - 33				1662 CLARK RD., LILLINGTON, N.C. 27546	
SHAYLAH'S KNOLL SUBDIVISION				(910) 893-5252	
TOWNSHIP	UPPER LITTLE RIVER	COUNTY	HARNETT	25' 0 50'	SURVEYED BY:
STATE:	NORTH CAROLINA	DATE:		SCALE: 1" = 50'	DRAWN BY: RVB
ZONE	RA-30	WATERSHED DISTRICT	TAX PARCEL ID#	CHECKED & CLOSURE BY:	FIELD BOOK
					DRAWING NO.
					13291