

**SOIL/SITE EVALUATION
 for ON-SITE WASTEWATER SYSTEM**

Owner: _____ Applicant: _____
 Address: _____ Date Evaluated: 1/19/2012
 Proposed Facility: _____ Design Flow (.1949): _____ Property Size: _____
 Location of Site: _____ Property Recorded: _____
 Water Supply: _____ Public Individual Well Spring Other
 Evaluation Method: Auger Boring Pit Cut
 Type of Wastewater: Sewage Industrial Process Mixed

P R O F I L E #	.1940 Landscape Position/ Slope %	Horizon Depth (In.)	SOIL MORPHOLOGY .1941		OTHER PROFILE FACTORS				Profile Class & LTAR
			.1941 Structure/ Texture	.1941 Consistence Mineralogy	.1942 Soil Wetness/ Color	.1943 Soil Depth (IN.)	.1956 Sapro Class	.1944 Restr Horiz	
	LS 5%	0-48	G/LS	Vf r NSNP					5.8
		0-48	G/LS	Vf r NSNP					5.8
		0-48	G/LS	Vf r NSNP					5.8

Description	Initial System	Repair System	Other Factors (.1946): Site Classification (.1948): 5 Evaluated By: [Signature] Others Present:
Available Space (.1945)			
System Type(s)	25%	25%	
Site LTAR	5	5	

COMMENTS: _____

<u>LANDSCAPE POSITIONS</u>	<u>GROUP</u>	<u>TEXTURES</u>	<u>.1955 LTAR</u>	<u>CONSISTENCE MOIST</u>	<u>WET</u>
R-RIDGE	I	S-SAND	1.2 - 0.8	VFR-VERY FRIABLE	NS-NON-STICKY
S-SHOULDER SLOPE		LS-LOAMY SAND		FR-FRIABLE	SS-SLIGHTLY STICKY
L-LINEAR SLOPE	II	SL-SANDY LOAM	0.8 - 0.6	FI-FIRM	S-STICKY
FS-FOOT SLOPE		L-LOAM		VFI-VERY FIRM	VS-VERY STICKY
N-NOSE SLOPE				EFI-EXTREMELY FIRM	NP-NON-PLASTIC
H-HEAD SLOPE	III	SI-SILT	0.6 - 0.3		SP-SLIGHTLY STICKY
CC-CONCLAVE SLOPE		SIL-SILT LOAM			P-PLASTIC
CV-CONVEX SLOPE		CL-CLAY LOAM			VP-VERY PLASTIC
T-TERRACE		SCL-SANDY CLAY LOAM			
FP-FLOOD PLAN	IV	SIC-SILTY CLAY	0.4 - 0.1		
		C-CLAY			
		SC-SANDY CLAY			

STRUCTURE
 SG-SINGLE GRAIN
 M- MASSIVE
 CR-CRUMB
 GR-GRANULAR
 SBK-SUBANGULAR BLOCKY
 ABK-ANGULAR BLOCKY
 PL-PLATY
 PR-PRISMATIC

MINERALOGY
 SLIGHTLY EXPANSIVE
 EXPANSIVE

Show profile locations and other site features (dimensions, references or benchmark, and North)

A large grid for site profile locations and other site features. The grid is approximately 20 columns wide and 20 rows high, providing a space for drawing and recording data.

MAP NO. 2011-411


"HORSE WHISPERER LN." 50' R/W

CURVE RADIUS	LENGTH	CHORD	CH.BEARING
C-1	50.00'	76.45'	71.35° N 78°34'15"E

MAP REFERENCE: MAP NO. 2011-411


SITE PLAN APPROVAL

DISTRICT RA-20R USE SFD
 #BEDROOMS 4
 Date 1-10-12 Zoning Administrator [Signature]

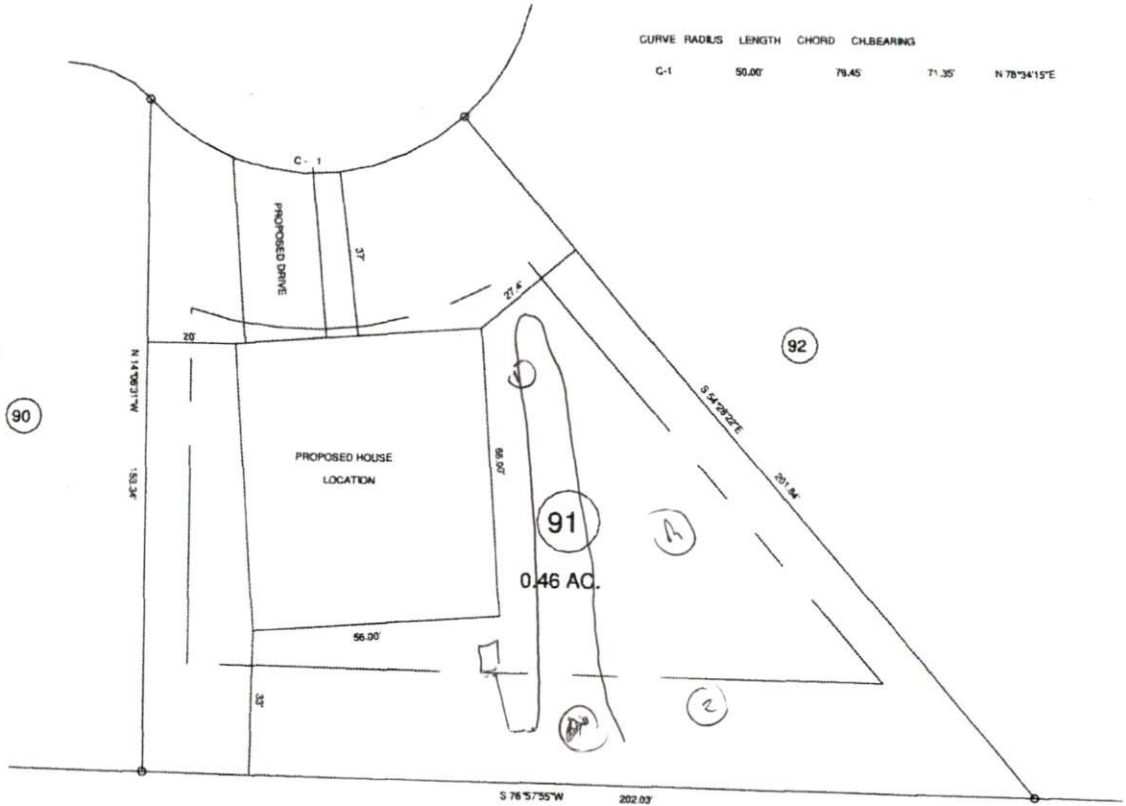

1 X 200
 250
 10-30

MINIMUM BUILDING SET BACKS
 FRONT YARD — 35'
 REAR YARD — 25'
 SIDE YARD — 10'
 CORNER LOT SIDE YARD — 20'
 MAXIMUM HEIGHT — 35'

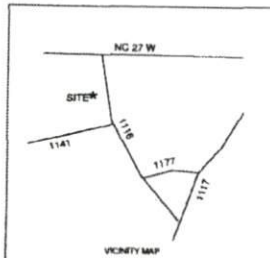

SURVEY FOR: PROPOSED PLOT PLAN - LOT - 91 TROTTER'S RIDGE S/D, PHASE - 1 - C				BENNETT SURVEYS, INC. 1862 CLARK RD., LILLINGTON, N.C. 27546 (910) 893-5252		JOB NO. 11403 C-1080		
TOWNSHIP	BARBEQUE	COUNTY	HARNETT	20	0	40	SURVEYED BY:	FIELD BOOK
STATE: NORTH CAROLINA		DATE: DECEMBER 27, 2011		SCALE: 1" = 40'		DRAWN BY: RVB		DRAWING NO.
ZONE	RA-20R	WATERSHED DISTRICT	TAX PARCEL ID#	CHECKED & CLOSURE BY:				11403