

COMMENTS: _____

<u>LANDSCAPE POSITIONS</u>	<u>GROUP</u>	<u>TEXTURES</u>	<u>.1955 LTAR</u>	<u>CONSISTENCE MOIST</u>	<u>WET</u>
R-RIDGE	I	S-SAND	1.2 - 0.8	VFR-VERY FRIABLE FR-FRIABLE FI-FIRM VFI-VERY FIRM EFI-EXTREMELY FIRM	NS-NON-STICKY SS-SLIGHTLY STICKY S-STICKY VS-VERY STICKY NP-NON-PLASTIC SP-SLIGHTLY STICKY P-PLASTIC VP-VERY PLASTIC
S-SHOULDER SLOPE		LS-LOAMY SAND			
L-LINEAR SLOPE	II	SL-SANDY LOAM	0.8 - 0.6		
FS-FOOT SLOPE		L-LOAM			
N-NOSE SLOPE	III	SI-SILT	0.6 - 0.3		
H-HEAD SLOPE		SIL-SILT LOAM			
CC-CONCLAVE SLOPE		CL-CLAY LOAM			
CV-CONVEX SLOPE		SCL-SANDY CLAY LOAM			
T-TERRACE					
FP-FLOOD PLAN	IV	SIC-SILTY CLAY	0.4 - 0.1		
		C-CLAY			
		SC-SANDY CLAY			

STRUCTURE

- SG-SINGLE GRAIN
- M- MASSIVE
- CR-CRUMB
- GR-GRANULAR
- SBK-SUBANGULAR BLOCKY
- ABK-ANGULAR BLOCKY
- PL-PLATY
- PR-PRISMATIC

MINERALOGY

- SLIGHTLY EXPANSIVE
- EXPANSIVE


Show profile locations and other site features (dimensions, references or benchmark, and North)

A large grid for drawing site profiles and features. The grid is approximately 20 units wide and 25 units high, providing a scale for plotting data.

I, MICHAEL P. GRIFFIN, certify that under my direction and supervision this map was drawn from an actual field survey; that the error of closure of the survey as calculated by coordinates is 1:10,000+; that the area shown hereon was calculated by coordinates.
 Witness my hand and seal this day of MONTH 2011.



DAVID KOLAR #
 ROBERT KOLAR
 DB 2577 PG 445

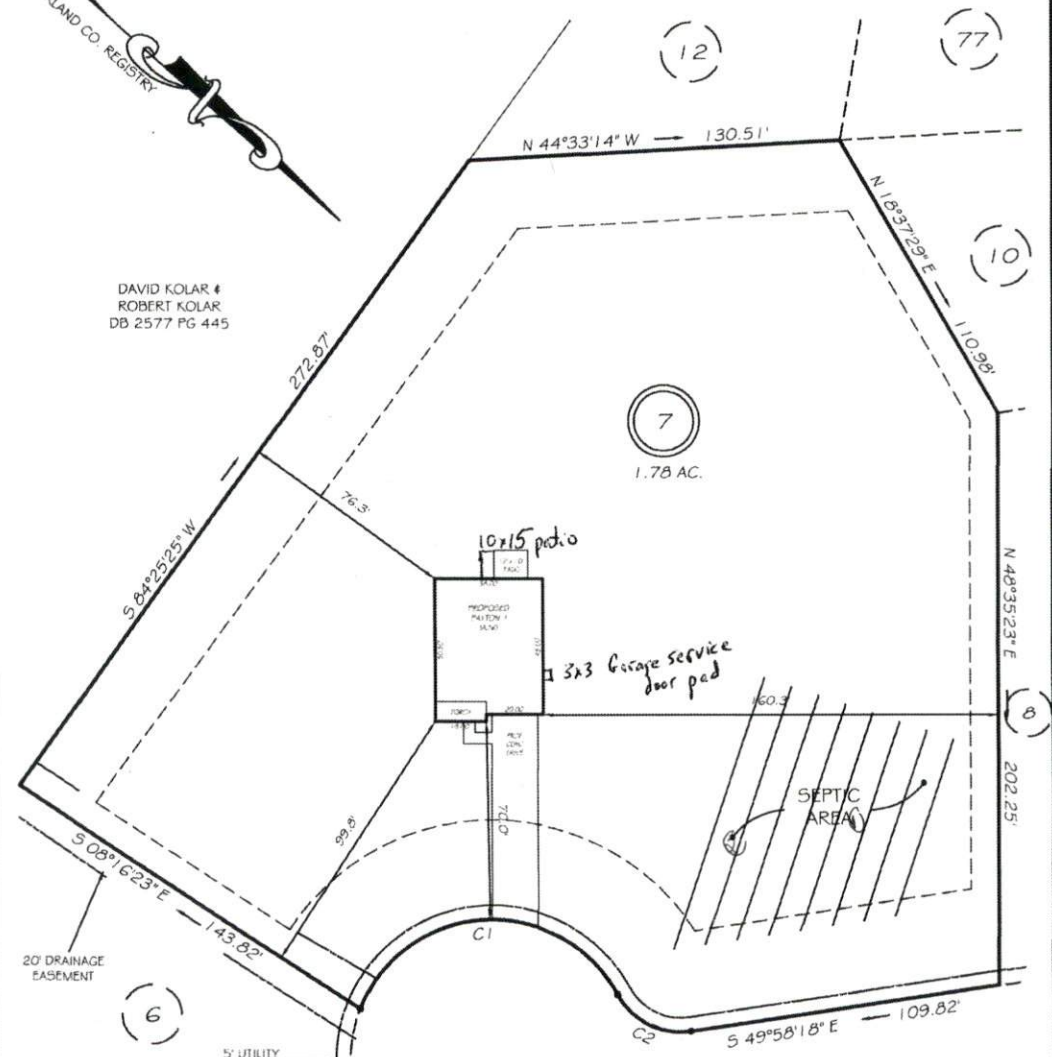

SITE PLAN APPROVAL
 DISTRICT RAJOM USE SEC
 #BEDROOMS 4
10-20-11 9/28


HIGHGREEN POINT
 50' PUBLIC RW

SETBACKS
 FRONT 35'
 REAR 25'
 SIDE 10'
 CORNER SIDE 20'

Curves:
 C1 R=50.00' L=113.91' S44°42'26"E 90.82'
 C2 R=25.00' L=30.77' S14°42'26"E 28.87'

LEGEND

EIP	EXISTING IRON PIPE	FES	FLARED END SECTION
IPS	IRON PIPE SET	WM	WATER METER
RAW	RIGHT OF WAY	CO	CLEAN OUT
N/F	NOW OR FORMERLY	FH	FIRE HYDRANT
EIS	EXISTING IRON STAKE	CB	CATCH BASIN

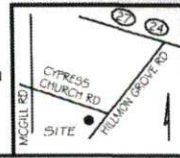

PRELIMINARY
 NOT FOR RECORDATION,
 SALES OR CONVEYANCE

GRiffin LAND SURVEYING, INC.
 P.O. BOX 148
 FUGUAY-VARINA, NC 27526
 (919) - 587-1983

PLOT PLAN
 FOR
D.R. HORTON
 CYPRESS POINTE
 LOT 7
 90 HIGHGREEN POINT
 CAMERON, N.C.
 CUMBERLAND CO. JOHNSONVILLE TOWNSHIP

DRAWN BY <u>NMF</u>	DATE <u>10/14/11</u>
CHECKED BY <u>MPG</u>	SCALE <u>1" = 50'</u>

SOUTHEASTEN SOIL & ENVIRONMENTAL ASSOC, INC.

PROPOSED SUBSURFACE WASTE DISPOSAL SYSTEM DETAIL SHEET

SUBDIVISION Cypress Pointe

LOT 7

INITIAL SYSTEM pump to APPROVED 25% REDUCTION

REPAIR pump to approved 25% reduction

DISTRIBUTION D-Box

DISTRIBUTION D-Box

BENCHMARK 100.0

LOCATION Front corner 7/8

NO. BEDROOMS 4

proposed LTAR = 0.5 gal/ft²

LINE FLAG COLOR ELEVATION ACTUAL LENGTH

Entered

<u>LINE</u>	<u>FLAG COLOR</u>	<u>ELEVATION</u>	<u>ACTUAL LENGTH</u>
1	B	98.0	60'
2	P	97.67	60'
3	B	97.25	60'
4	P	96.75	60'
			240'
5	B	96.25	60'
6	P	95.75	60'
7	B	95.25	60'
8	P	94.75	60'
			240'

BY M. FAHER

DATE 01/11