

Property ID:
 Lot #:
 File #:
 Code:

**SOIL/SITE EVALUATION
 for ON-SITE WASTEWATER SYSTEM**

Owner:
 Address:
 Proposed Facility: Design Flow (.1949):
 Location of Site:
 Water Supply: Public Individual Well
 Evaluation Method: Auger Boring Pit
 Type of Wastewater: Sewage Industrial Process

Applicant:
 Date Evaluated:
 Property Size:
 Property Recorded:
 Spring Other
 Cut
 Mixed

P R O F I L E #	1940 Landscape Position/ Slope%	Horizon Depth (IN.)	SOIL MORPHOLOGY .1941		OTHER PROFILE FACTORS				Profile Class & LTAR
			.1941 Structure/ Texture	.1941 Consistence Mineralogy	.1942 Soil Wetness/ Color	.1943 Soil Depth (IN.)	.1956 Sapro Class	.1944 Restr Horiz	
	53%	0-72	CLL	VLR 50					5
		0-30	CLL	VLR 50					5
		0-30	CLL	VLR 15					5
		0-30	CL SL	VLR 50					5
		0-30	CL SL	VLR 50					5

Description	Initial System	Repair System
Available Space (.1945)		
System Type(s)	25%	25%
Site LTAR	5	5

1230

Other Factors (.1946):
 Site Classification (.1948):
 Evaluated By:
 Others Present:


COMMENTS: _____

<u>LANDSCAPE POSITIONS</u>	<u>GROUP</u>	<u>TEXTURES</u>	<u>.1955 LTAR</u>	<u>CONSISTENCE MOIST</u>	<u>WET</u>
R-RIDGE	I	S-SAND	1.2 - 0.8	VFR-VERY FRIABLE	NS-NON-STICKY
S-SHOULDER SLOPE		LS-LOAMY SAND			
L-LINEAR SLOPE	II	SL-SANDY LOAM	0.8 - 0.6	FR-FRIABLE	SS-SLIGHTLY STICKY
FS-FOOT SLOPE		L-LOAM			
N-NOSE SLOPE	III	SI-SILT-	0.6 - 0.3	FI-FIRM	S-STICKY
H-HEAD SLOPE		SIL-SILT LOAM			
CC-CONCLAVE SLOPE		CL-CLAY LOAM			
CV-CONVEX SLOPE		SCL-SANDY CLAY LOAM			
T-TERRACE	IV	SIC-SILTY CLAY	0.4 - 0.1	VFI-VERY FIRM	VS-VERY STICKY
FP-FLOOD PLAN		C-CLAY			
		SC-SANDY CLAY			
				EFI-EXTREMELY FIRM	NP-NON-PLASTIC
					SP-SLIGHTLY STICKY
					P-PLASTIC
					VP-VERY PLASTIC


STRUCTURE
 SG-SINGLE GRAIN
 M-MASSIVE
 CR-CRUMB
 GR-GRANULAR
 SBK-SUBANGULAR BLOCKY
 ABK-ANGULAR BLOCKY
 PL-PLATY
 PR-PRISMATIC

MINERALOGY
 SLIGHTLY EXPANSIVE
 EXPANSIVE


Show profile locations and other site features (dimensions, reference or benchmark, and North).

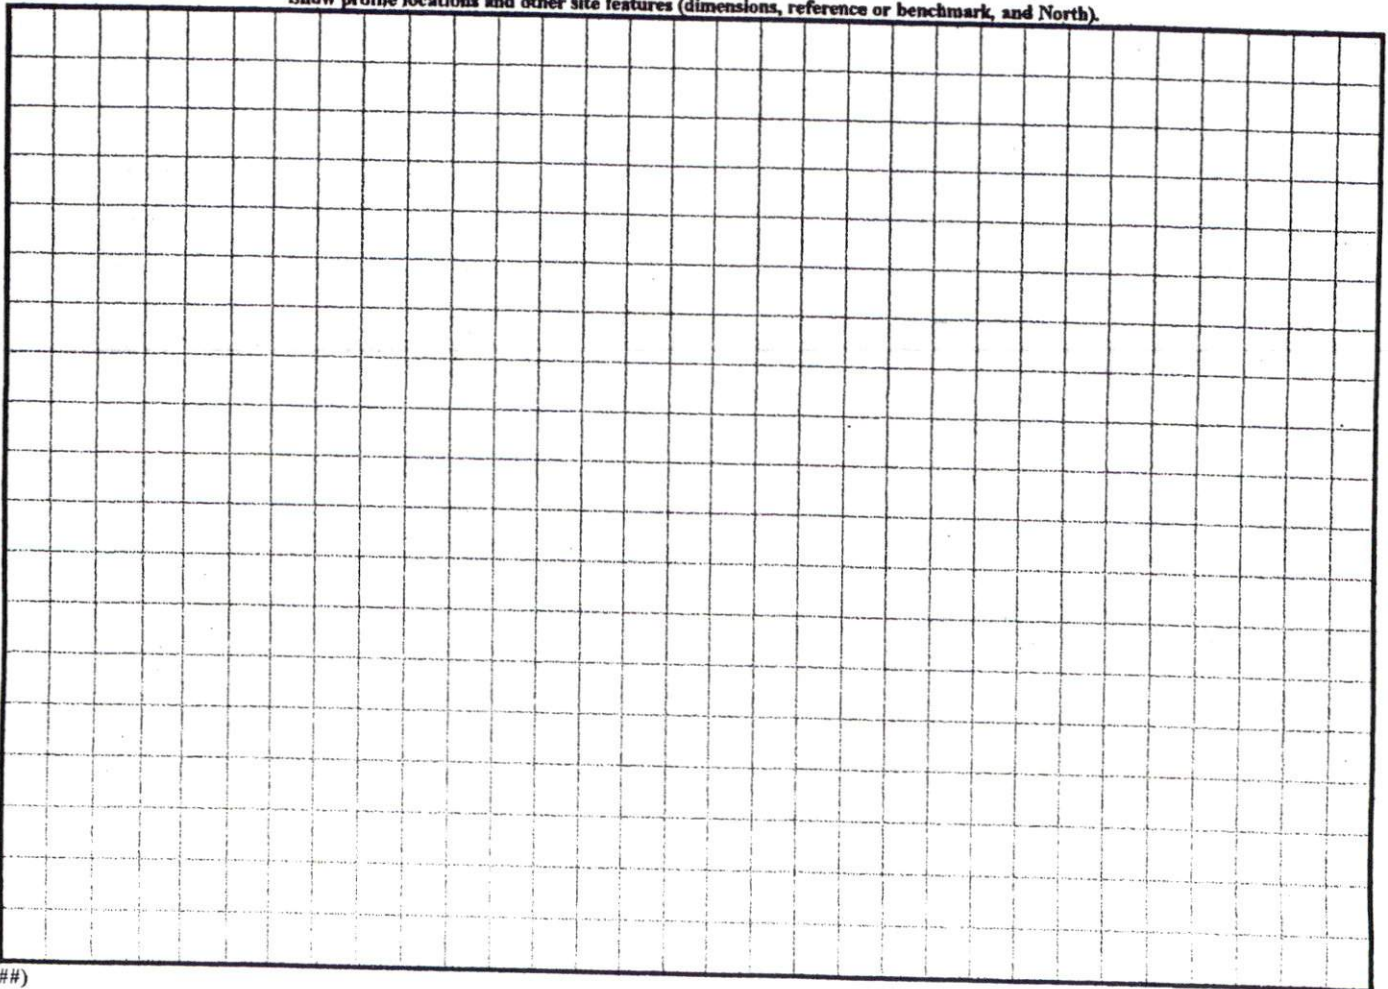

FRONT YARD 20'
 REAR YARD 20'
 SIDE YARD 10'
 CORNER LOT SIDE YARD 20'
 MAXIMUM HEIGHT 30'

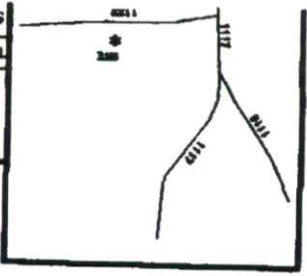

JOB NO. 06308
BENNETT SURVEYS, INC.
 1662 CLARK RD., LILLINGTON, N.C. 27346
 (910) 893-9292
 SURVEYED BY:
 DRAWN BY: RWB
 SCALE: 1" = 40'
 DATE: JUNE 24, 2008
 COUNTY: HARNETT
 TOWNSHIP: ANDERSON CREEK
 STATE: NORTH CAROLINA
PROPOSED LOT PLAN - LOT - 221
WOODSHIRE S/D, PHASE - 5
 SURVEY FOR:

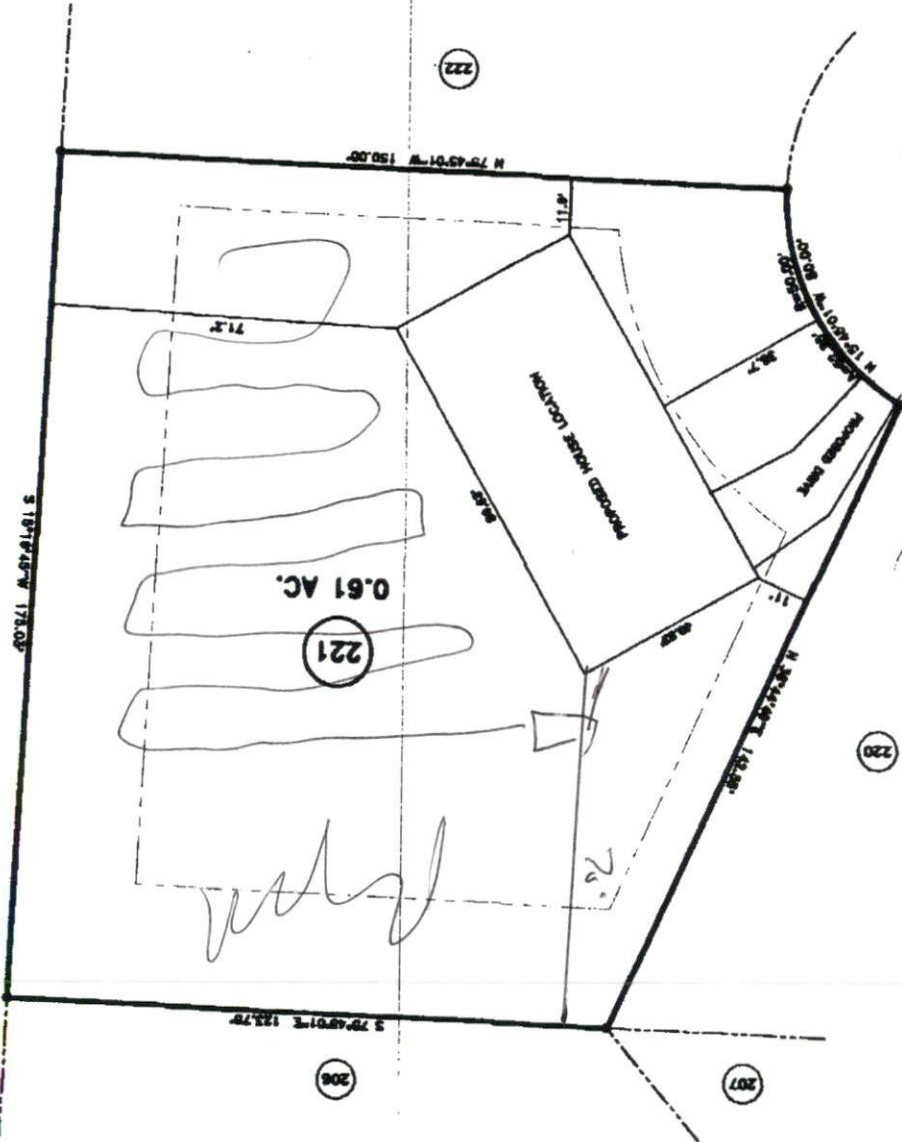

50' R/W
"SONORA DRIVE"

MAP REFERENCE: MAP NO. 2007-948

ZONING ADMINISTRATOR
 6.24.08 duration
 #BEDROOMS
 DISTRICT USE: SFD
 SITE PLAN APPROVAL

N.C. GRID NORTH (NAD 27)

206

207

220

222

221