

**SOIL/SITE EVALUATION
 for ON-SITE WASTEWATER SYSTEM**

Owner: 06-500 14637

Applicant:

Date Evaluated: 5-15-02

Address:

Property Size: .35 ac

Proposed Facility: Home

Design Flow (.1949): 400

Property Recorded: unk

Location of Site: 1115

- Water Supply: Public Individual Well Spring Other
 Evaluation Method: Auger Boring Pit Cut
 Type of Wastewater: Sewage Industrial Process Mixed

P R O F I L E #	.1940 Landscape Position/ Slope%	Horizon Depth (IN.)	SOIL MORPHOLOGY .1941		OTHER PROFILE FACTORS				Profile Class & LTAR	
			.1941 Structure/ Texture	.1941 Consistence Mineralogy	.1942 Soil Wetness/ Color	.1943 Soil Depth (IN.)	.1956 Sapro Class	.1944 Restr Horiz		
		<u>044</u>	<u>GRll</u>	<u>VFR</u>	<u>sc</u>		<u>42</u>			<u>6</u>
		<u>048</u>	<u>GRll</u>	<u>Vfr</u>	<u>sc</u>		<u>48</u>			<u>6</u>
		<u>048</u>	<u>GRll</u>	<u>VFR</u>	<u>sc</u>		<u>48</u>			<u>6</u>
		<u>048</u>	<u>GRll</u>	<u>VFR</u>	<u>sc</u>		<u>48</u>			<u>6</u>
		<u>048</u>	<u>GRll</u>	<u>VFR</u>	<u>sc</u>		<u>48</u>			<u>6</u>

Description	Initial System	Repair System
Available Space (.1945)		
System Type(s)	<u>CRS</u>	<u>60</u>
Site LTAR	<u>16</u>	<u>2</u>

Other Factors (.1946): _____
 Site Classification (.1948): 1
 Evaluated By: gwf
 Others Present:


COMMENTS: _____

<u>LANDSCAPE POSITIONS</u>	<u>GROUP</u>	<u>TEXTURES</u>	<u>.1955 LTAR</u>	<u>CONSISTENCE MOIST</u>	<u>WET</u>
R-RIDGE	I	S-SAND	1.2 - 0.8	VFR-VERY FRIABLE FR-FRIABLE FI-FIRM VFI-VERY FIRM EFI-EXTREMELY FIRM	NS-NON-STICKY SS-SLIGHTLY STICKY S-STICKY VS-VERY STICKY NP-NON-PLASTIC SP-SLIGHTLY STICKY P-PLASTIC VP-VERY PLASTIC
S-SHOULDER SLOPE		LS-LOAMY SAND			
L-LINEAR SLOPE	II	SL-SANDY LOAM	0.8 - 0.6		
FS-FOOT SLOPE		L-LOAM			
N-NOSE SLOPE	III	SI-SILT-	0.6 - 0.3		
H-HEAD SLOPE		SIL-SILT LOAM			
CC-CONCLAVE SLOPE		CL-CLAY LOAM			
CV-CONVEX SLOPE		SCL-SANDY CLAY LOAM			
T-TERRACE	IV	SIC-SILTY CLAY	0.4 - 0.1		
FP-FLOOD PLAN		C-CLAY			
		SC-SANDY CLAY			

- STRUCTURE
 SG-SINGLE GRAIN
 M-MASSIVE
 CR-CRUMB
 GR-GRANULAR
 SBK-SUBANGULAR BLOCKY
 ABK-ANGULAR BLOCKY
 PL-PLATY
 PR-PRISMATIC

- MINERALOGY
 SLIGHTLY EXPANSIVE
 EXPANSIVE

Show profile locations and other site features (dimensions, reference or benchmark, and North).

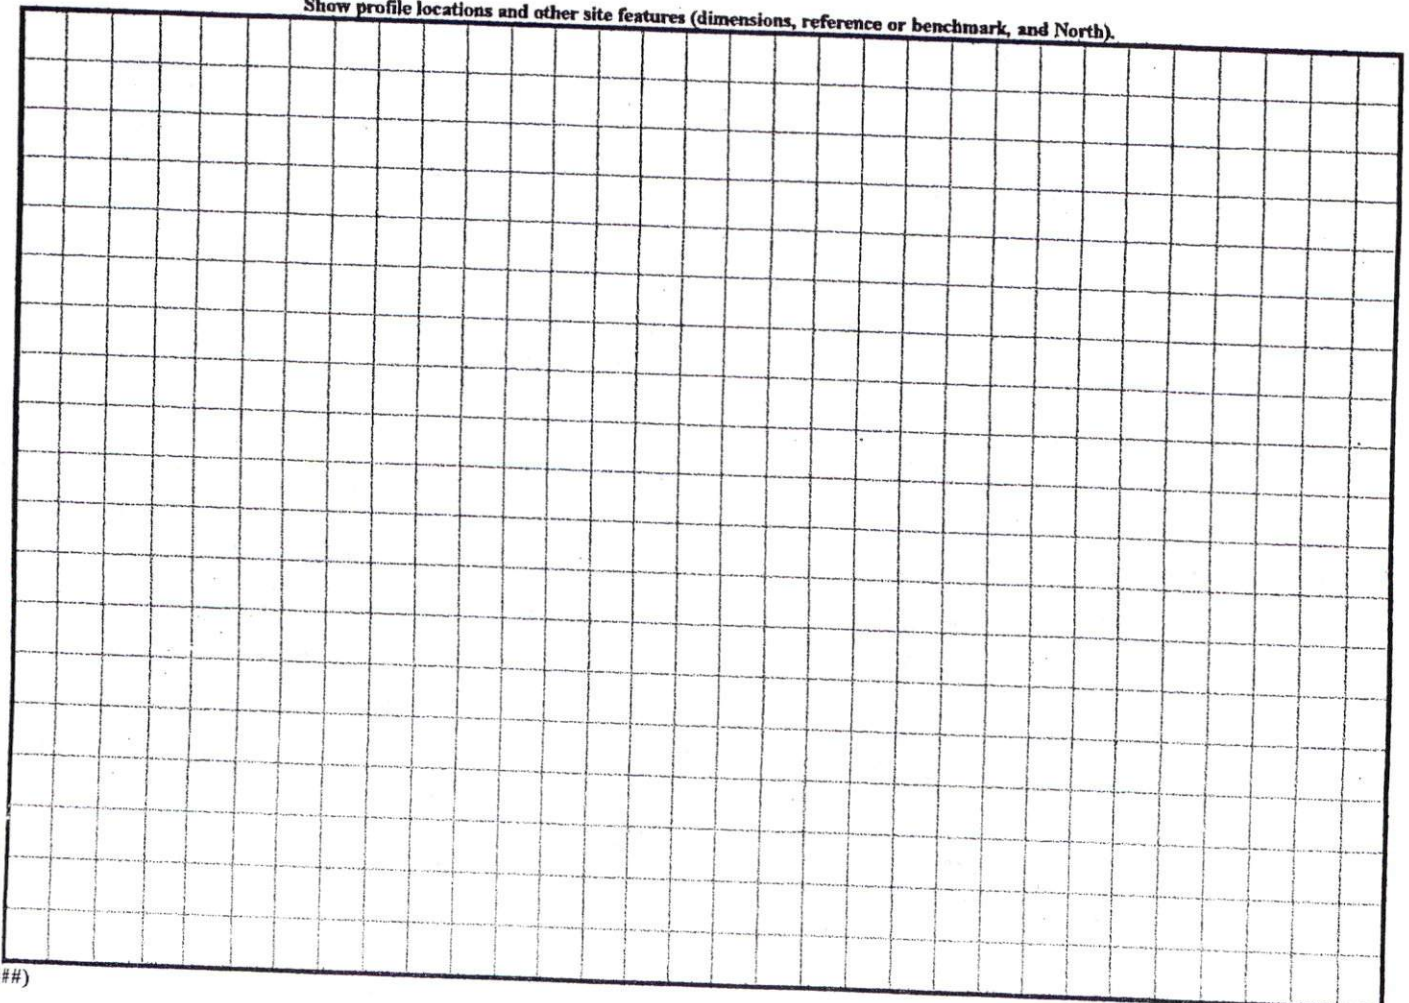


SITE PLAN APPROVAL

DISTRICT RAPID USE SFD

4 ROOMS H


Harold A. Duggan
Zoning Administrator

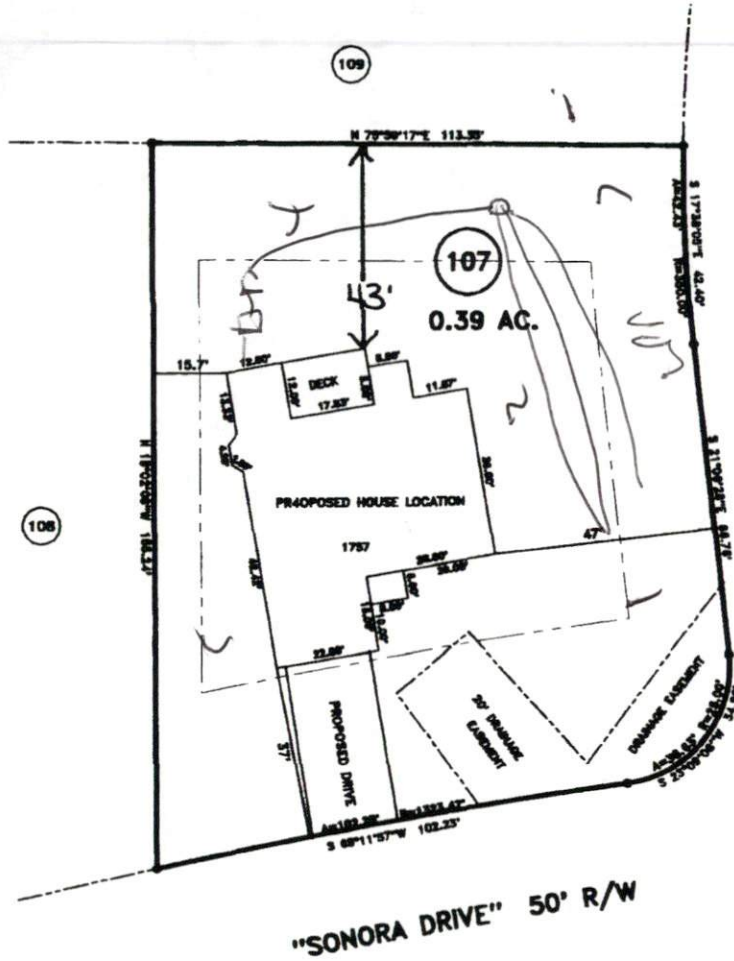

Handwritten notes:
 "SONORA DRIVE" 50' R/W
 "BREEZEWOOD DRIVE" 50' R/W
 5' SETBACK
 10' SETBACK
 15' SETBACK
 20' SETBACK
 25' SETBACK
 30' SETBACK
 35' SETBACK
 40' SETBACK
 45' SETBACK
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 145' SETBACK
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 155' SETBACK
 160' SETBACK
 165' SETBACK
 170' SETBACK
 175' SETBACK
 180' SETBACK
 185' SETBACK
 190' SETBACK
 195' SETBACK
 200' SETBACK

MINIMUM BUILDING SET BACKS

- FRONT YARD — 30'
- REAR YARD — 25'
- SIDE YARD — 10'
- CORNER LOT SIDE YARD — 20'
- MAXIMUM HEIGHT — 30'

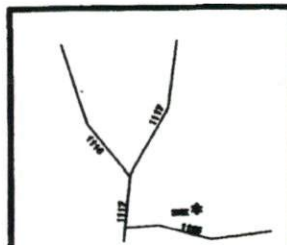

SURVEY FOR:
PROPOSED PLOT PLAN - LOT - 107
WOODSHIRE S/D, PHASE FOUR

TOWNSHIP ANDERSON CREEK COUNTY HARNETT
 STATE: NORTH CAROLINA DATE: APRIL 10, 2006

10 0 20
 SCALE: 1" = 20'

BENNETT SURVEYS, INC.
 1662 CLARK RD., LILLINGTON, N.C. 27546
 (910) 893-5252

SURVEYED BY:
 DRAWN BY: RVB

FIELD BOOK
 DRAWING 1

JOB NO. 06237