# verizon

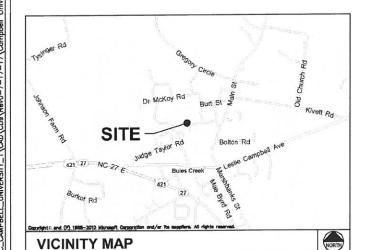
8921 RESEARCH DRIVE CHARLOTTE, NC 28262

### **CAMPBELL UNIVERSITY**

### SITE ADDRESS

179 DAY DORM ROAD LILLINGTON, NC 27546 HARNETT COUNTY

LATITUDE: 35° 24' 38.66" N LONGITUDE: 78° 44' 26.82" W



FROM CHARLOTTE OFFICE: START OUT GOING SOUTHWEST ON RESEARCH DRIVE TOWARDS HARRIS BLVD 0.4 MILE; TURN LEFT ONTO W WT HARRIS BLVD 0.4 MILE; TURN LEFT ONTO THE I-85N RAMP 0.3 MILE; MERGE ONTO I-85N 42.1 MILES; KEEP LEFT AT THE FORK TO STAY ON I-85N 32.8 MILES; KEEP LEFT AT THE FORK TO STAY ON I-85N 5.6 MILES; TAKE EXIT 126A-126B TO MERGE ONTO US-421S TOWARD SANFORD 44.9 MILES; KEEP LEFT TO STAY ON US-421S TOWARD SANFORD 44.9 ON US-421S 7.3 MILES; TAKE EXIT 143A TO STAY ON US-421S TOWARD LILLINGTON 0.2 MILE; MERGE ONTO US-421S 17.7 MILES; TURN LEFT ONTO S MAIN ST 1.5 MILES TURN RIGHT ONTO US-421S 3 MILES; TURN LEFT ONTO LESLIE CAMPBELL AVE 315FT; TURN LEFT ONTO JUDGE TAYLER RD 0.3 MILE; TURN LEFT ONTO T T LANIER EXD 0.3 MILE; TURN RIGHT ONTO DR MCKOY RD 0.2 MILE; TURN RIGHT ONTO DAY DORM RD 374FT; ARRIVE AT DESTINATION ON THE RIGHT.

**DRIVING DIRECTIONS** 

MUNICIPALITY:
TOWN OF BUIES CREEK

STATE: NORTH CAROLINA

TOWER TYPE: EXISTING BUILDING ROOFTOP

NUMBER OF CARRIERS: 0 EXISTING, 1 PROPOSED

JSE:

EXISTING STORAGE ROOM W/ EQUIPMENT RACKS AND ROOFTOP MOUNTED ANTENNAS

CONSULTANT

KIMLEY-HORN AND ASSOCIATES, INC. 2 SUN COURT, SUITE 450 PEACHTREE CORNERS, GEORGIA 30092 PHONE: (404) 201-6156 ATTN.: COLE EDMONSON

**PROJECT SUMMARY** 

DEVELOPER
VERIZON WIRELESS
8921 RESEARCH DRIVE
CHARLOTTE, NC 28262
PHONE: (704) 510-8717
ATTN: ROCKY CANADY

PROPERTY OWNER CAMPBELL UNIVERSITY P.O. BOX 97 BUIES CREEK, NC 27506

CONTACTS

SHEET	DESCRIPTION	REV.
T1	COVER SHEET	0
T2	APPENDIX B: BUILDING CODE SUMMARY	0
C1	OVERALL SITE LAYOUT	0
C2	OVERALL THIRD FLOOR PLAN	0
C3	THIRD FLOOR STORAGE ROOM LAYOUT	0
C4	ROOFTOP LAYOUT	0
C5	BUILDING ELEVATIONS	0
C6	ANTENNA & COAX MOUNT DETAILS	0
C7	WALL PENETRATION DETAILS	0
E1	ELECTRICAL NOTES	0
E2	THIRD FLOOR STORAGE ROOM ROUTING PLAN	0
E3	SINGLE-LINE DIAGRAM	0
E4	PANEL SCHEDULE	0

SHEET INDEX

HARNETT COUNTY DEVELOPMENT SERVICES

108 E. FRONT ST. LILLINGTON, NC 27546 PHONE: (910) 893-7525 ATTN.: CUSTOMER SERVICE

PERMIT INFORMATION

verizon/

8921 RESEARCH DRIVE CHARLOTTE, NORTH CAROLINA 2826

VERIZON NAME: CAMPBELL UNIVERSITY

VERIZON No.: TBD 179 DAY DORM ROAD LILLINGTON, NC 27546 HARNETT COUNTY

CURRENT ISSUE DATE:

PROJECT INFORMATION:

07/17/17

ISSUED FOR:

CONSTRUCTION

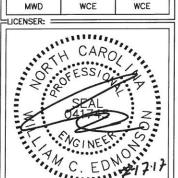
CONSULTANT:

**Kimley Horn** 

2 SUN COURT, SUITE 450
PEACHTREE CORNERS, GA 30092
PHONE: 770-825-0744
WWW.KIMLEY-HORN.COM
NC License F-0102

CONSULTANT:

DRAWN BY:-CHK.: APV.:



SHEET TITLE:

COVER SHEET

SHEET NUMBER:

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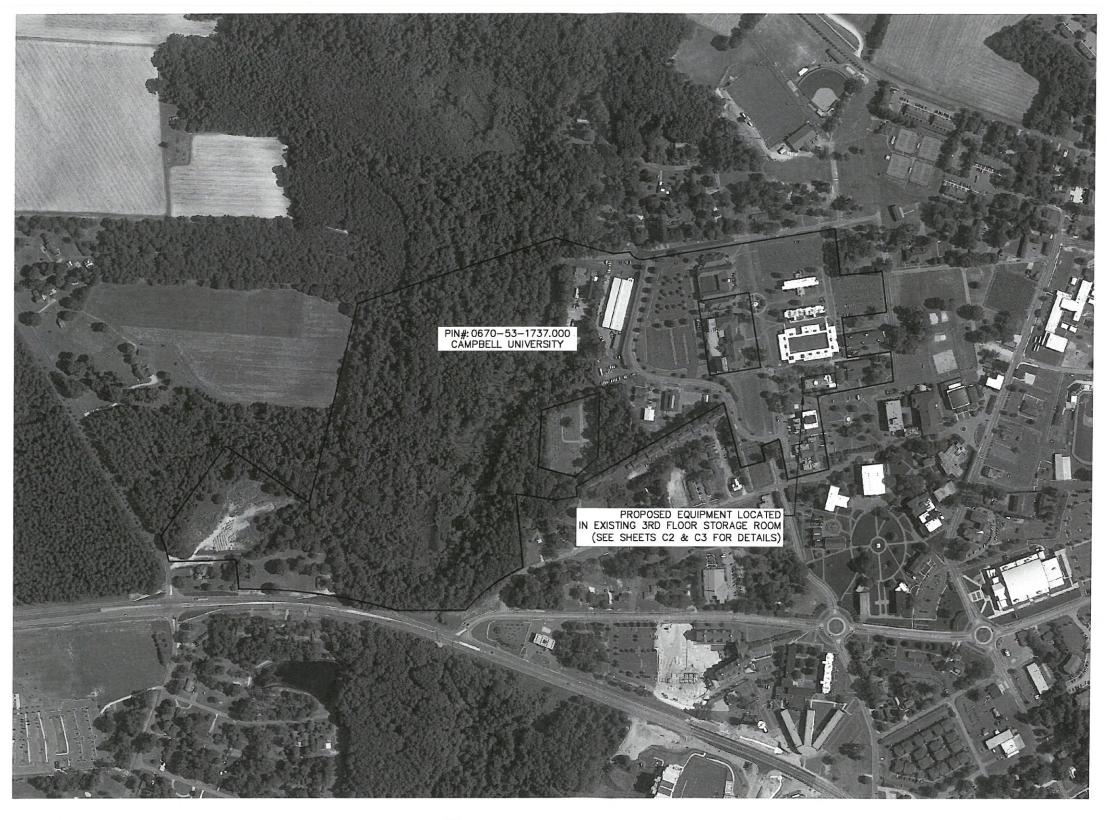
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cument, together with the concepts and designs presented herein, on an instrument of service, is intended only for the specific purpose and client for which it was prepared. Reuse of and improper resignace on this document without written authorization and adaptation by Kimley-Horn and Associates, inc. shall be without liability to Kimley-Horn and Associates, in

				7	
County HARNET   County Harne	Mixed Occupancy:	LIFE SAFETY PLAN REQUIREMENTS  Life Safety Plan Sheet #:    Fire and/or smoke rated wall locations (Chapter 7)	ENERGY SUMMARY  ENERGY REQUIREMENTS: The following data shall be considered minimum and any special attribute required to meet the energy code shall also be provided. Each Designer shall furnish the required portions of the project information for the plan data sheet. If performance method state the annual energy cost for the standard reference design vs annual energy cost for the proposed design.  Climate Zone:   3   4   5    Method of Compliance:   Performance (Energy Code)   Prescriptive (Energy Code)   Performance (Energy Code)   Persoriptive (ASIIRAE 90.1)   Performance (ASHRAE 90.1)   Performance (ASHRAE 90.1)    THERMAL ENVELOPE  Roof/ceiling Assembly (cach assembly) Description of assembly:   U-Value of total assembly:   U-Value of skylights in cach assembly:   U-Value of skylights in cach assembly:   U-Value of cotal assembly:   U-Value of cotal assembly:   U-Value of total assembly:   U-Value of insulation:   Openings (windows fr doors with glazing)   U-Value of insulation:   Openings (windows fr doors with glazing)   U-Value of total assembly:   U-Value of total	CHARLOTTE, N PROJECT INFORM VERIZ 179 DV LILLING HARN CURRENT ISSUE  O7/ ISSUED FOR:  REV::-DATE:  A 06/05/17 D 07/17/17  CONSULTANT::  Kimle  2 SUN C PEACHTREE PHONE: WWW.IS	ZON NAME: LL UNIVERSITY (ON No.: TBD AY DORM ROAD TON, NC 27546 WETT COUNTY  DATE:  / 17/17  TRUCTION  ISSUED FOR:  PRELIMINARY WCI CONSTRUCTION WCI  COURT, SUITE 450 CORNERS, GA 30092 770-825-0744 MEEY-HORN,COM JENSEE F-0102
Assembly   A-1   A-2   A-3   A-4   A-5	Structural Frame; iscluding columns, girders, transes: Bearing Walth Exterior North Fad Weet South Interior North Exa Weet South Interior walls North Exa Weat South Interior walls and partitions Floor Construction Including supporting bearns and girds South Interior Separation Including supporting bearns and girds South South Interior Separation Including supporting bearns and girds South South Interior Separation Including supporting bearns and girds South South Interior Separation Including supporting bearns and girds South South Interior Separation Including supporting bearns and girds South Interior Separation Includent Lies S	Snow (16) Schmic (16)  Live Loads: Roof Mczzanine psf Floor psf Mczzanine psf Proxide the following Scismic Design Parameters: Occupancy Caregory (Table 1604.5)  SeisMic Design Category (Table 1604.5) Spectral Response Acceleration Sp Site Classification (Table 1613.2) Spectral Response Acceleration Sp Site Sp	MECHANICAL SUSTEMS, SERVICE SYSTEMS AND EQUIPMENT  Thermal Zone  winter dry bulb: summer dr	MWD  LICENSER:  OFF  SHEET TITLE:  APPE BUILDI	INDIX B: NG CODE





1 OVERALL SITE LAYOUT
C1 SCALE: 1" = 500'

0 250 500 1000 GRAPHIC SCALE: 1" = 500' verizon/

8921 RESEARCH DRIVE CHARLOTTE, NORTH CAROLINA 28262

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179 DAY DORM ROAD LILLINGTON, NC 27546 HARNETT COUNTY

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0	07/17/17	CONSTRUCTION	WCI

CONSULTANT

### **Kimley** » Horn

2 SUN COURT, SUITE 450
PEACHTREE CORNERS, GA 30092
PHONE: 770-825-0744
WWW.KIMLEY-HORN.COM
NC License F-0102

CONSULTANT:

DRAWN BY:=CHK.: APV.:

C. EDWARD

SHEET TITLE:

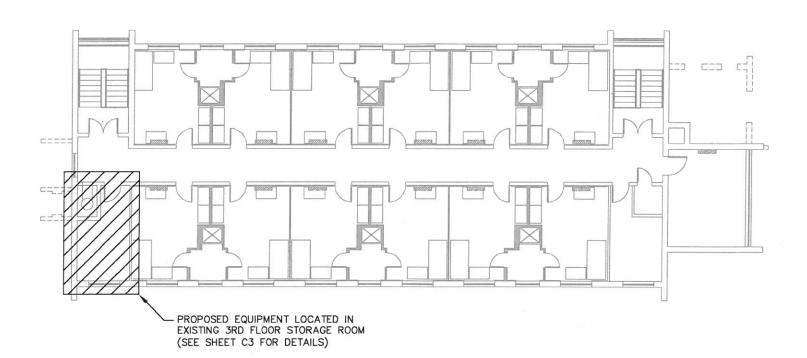
OVERALL SITE LAYOUT

SHEET NUMBER: REVISION:

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OVERALL THIRD FLOOR PLAN

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8921 RESEARCH DRIVE CHARLOTTE, NORTH CAROLINA 28282

PROJECT INFORMATION:

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CAMPBELL UNIVERSITY
VERIZON No.: TBD
179 DAY DORM ROAD
LILLINGTON, NC 27546
HARNETT COUNTY

CURRENT ISSUE DATE:

07/17/17

ISSUED FOR:

CONSTRUCTION

RE	V.:=DATE:===	ASSUED FOR:	BY:
A	06/05/17	PRELIMINARY	WCE
0	07/17/17	CONSTRUCTION	WCE
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\_CONSULTANT:=

## Kimley»Horn

2 SUN COURT, SUITE 450
PEACHTREE CORNERS, GA 30092
PHONE: 770-825-0744
WWW.KINLEY-HORN.COM
NC License F-0102

CONSULTANT:

DRAWN BY:—CHK.:——APV.:——MWD WCE WCE

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SHEET TITLE:

OVERALL THIRD FLOOR PLAN

SHEET NUMBER:—REVISION:—

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EXISTING ELECTRICAL -PANEL PROPOSED 3' X 7' LEASE -AREA (21± SQ. FT.) PROPOSED 23" POWER PLANT RACK TWO(2) PROPOSED 19" EQUIPMENT RACKS NEW THROUGH WALL -PENETRATION FOR CONDUIT ROUTING TO ROOFTOP (SEE SHEET 1/C7 FOR DETAILS) EXISTING 2"Ø FLOOR PENETRATION THIRD FLOOR STORAGE ROOM SCALE: 1" = 3'

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8921 RESEARCH DRIVE CHARLOTTE, NORTH CAROLINA 28262

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2 SUN COURT, SUITE 450
PEACHTREE CORNERS, GA 30092
PHONE: 770-825-0744
WWW.KIMLEY-HORN.COM
NC License F-0102

CONSULTANT:

DRAWN BY:-CHK.:-APV.:-MWD WCE WCE

LICENSER:

THIRD FLOOR STORAGE ROOM LAYOUT

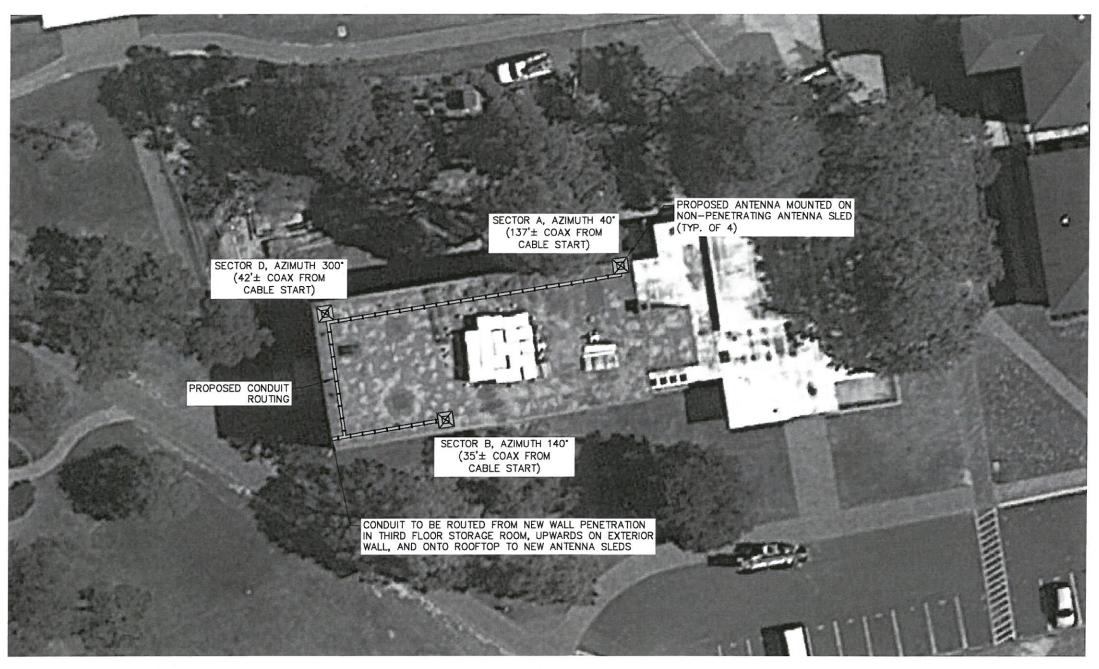
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GRAPHIC SCALE: 1" = 3'







ANTENNA	AZIMUTH IN	MECHANICAL	ANTENNA*	COMPO	SITION CAE	BLES
SECTOR	DEGREES	DOWN TILT	(QTY.) MAKE/MODEL	LENGTH	SIZE	QTY.
SECTOR A	40*	0.	(1) ANDREW/ NH65S-DG-FOM	137'±	1-5/8"ø	1
SECTOR B	140"	0.	(1) ANDREW/ NH65S-DG-FOM	35'±	1-5/8"ø	1
SECTOR G	300°	0,	(1) ANDREW/ NH65S-DG-FOM	42'±	1-5/8"ø	1

\* CONTRACTOR TO INSTALL ANY ADDITIONAL EQUIPMENT AS NECESSARY, VERIFY WITH VERIZON WIRELESS PROJECT MANAGER PRIOR TO CONSTRUCTION.



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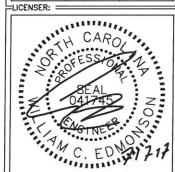
CONSULTANT:=

### **Kimley** » Horn

2 SUN COURT, SUITE 450
PEACHTREE CORNERS, GA 30092
PHONE: 770-825-0744
WWW.KIMLEY-HORN.COM
NC License F-0102

CONSULTANT:

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MWD WCE WCE



SHEET TITLE:

GRAPHIC SCALE: 1" = 30'

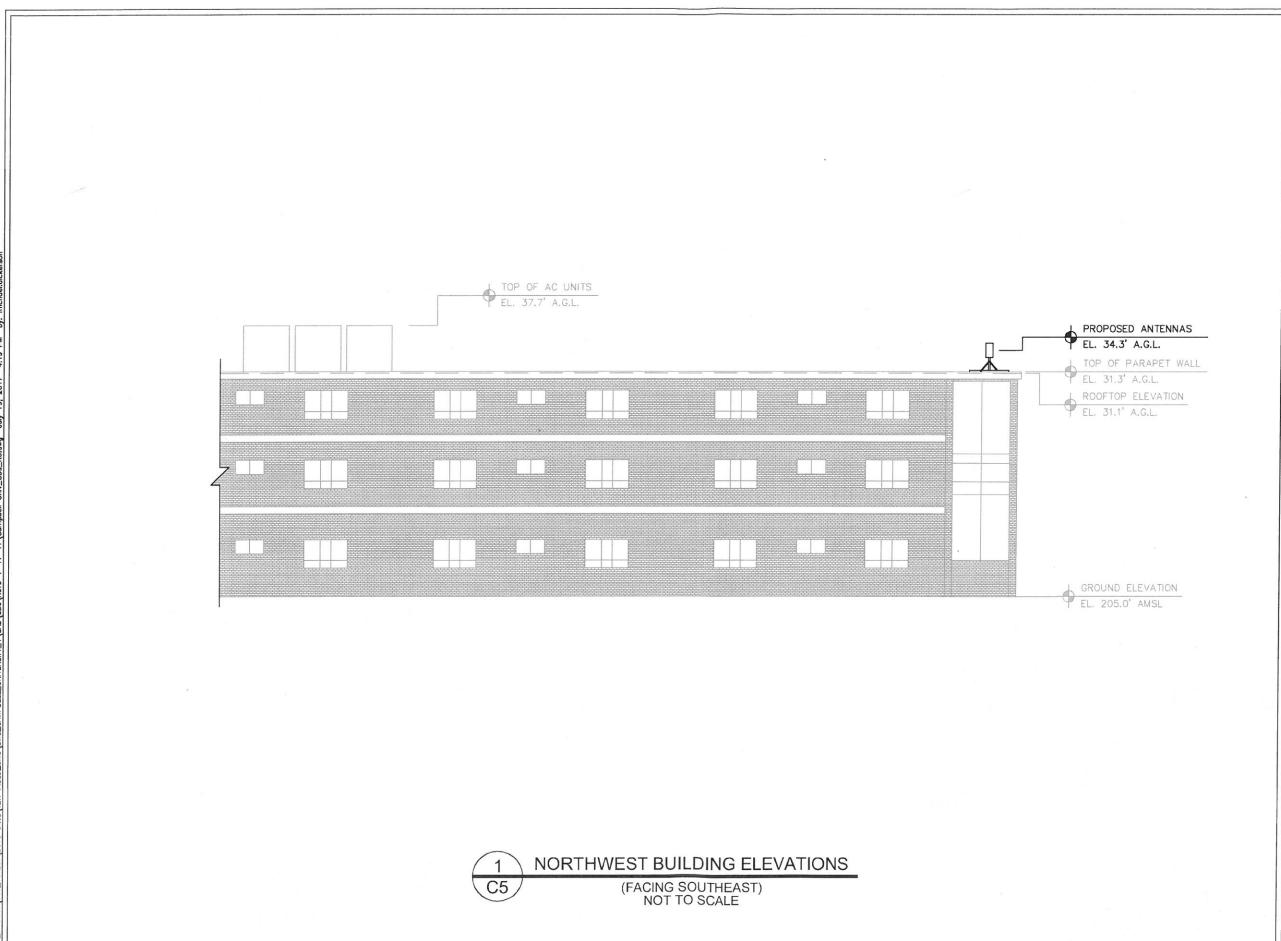
ROOFTOP LAYOUT

SHEET NUMBER: REVISION:

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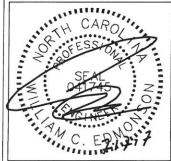
### Kimley»Horn

2 SUN COURT, SUITE 450
PEACHTREE CORNERS, GA 30092
PHONE: 770-825-0744
WWW.KIMLEY-HORN.COM
NC License F-0102

CONSULTANT:

DRAWN BY:=CHK.: APV.:

MWD



SHEET TITLE:

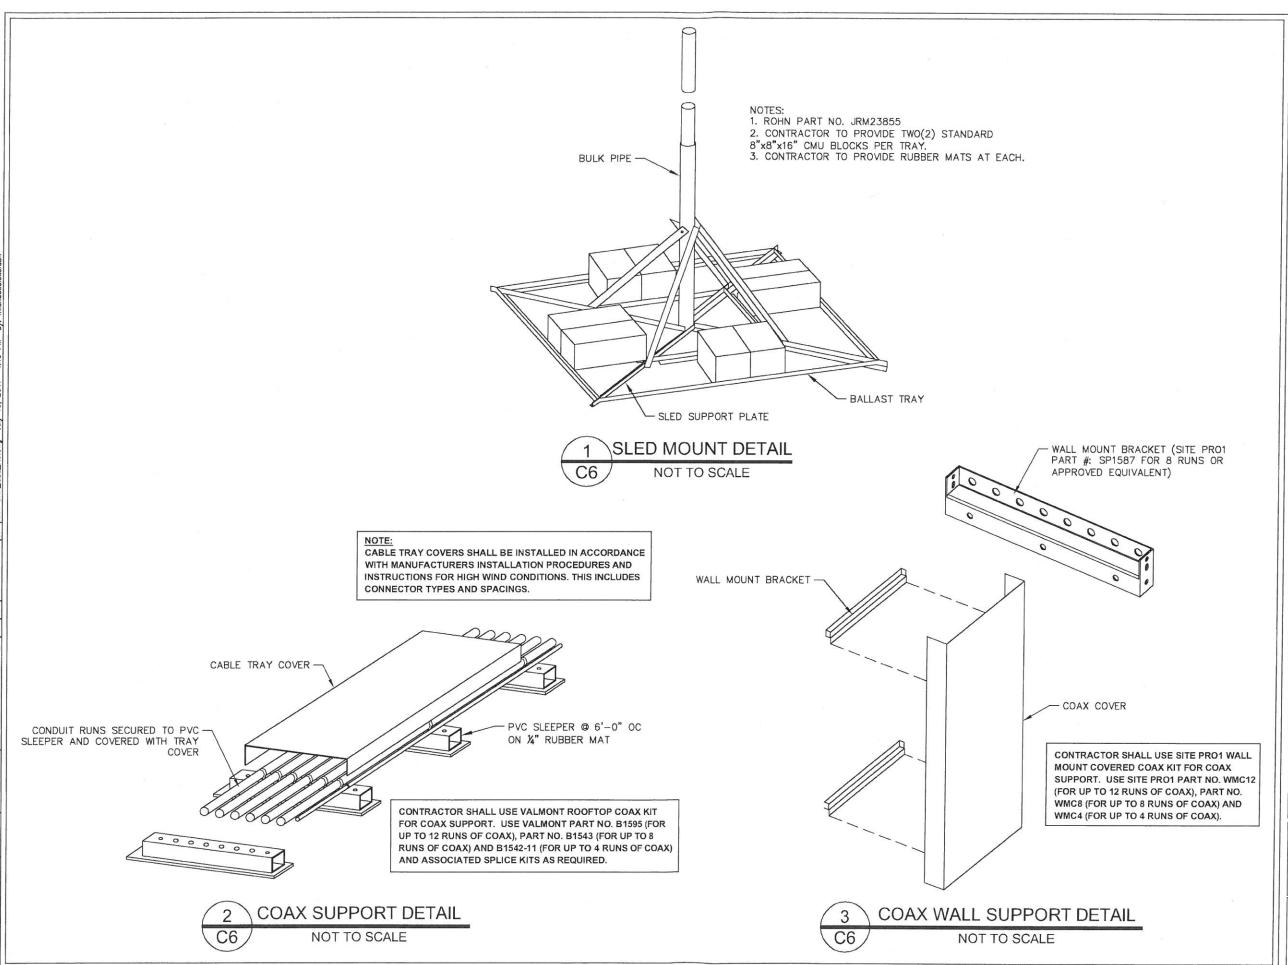
BUILDING ELEVATIONS

=SHEET NUMBER:====

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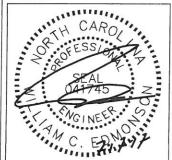
### **Kimley Whorn**

2 SUN COURT, SUITE 450
PEACHTREE CORNERS, GA 30092
PHONE: 770-825-0744
WWW.KIMLEY-HORN.COM
NC License F-0102

CONSULTANT:

DRAWN BY:-CHK.: APV.: WCE WCE

MWD LICENSER:



SHEET TITL

ANTENNA AND COAX MOUNT DETAILS

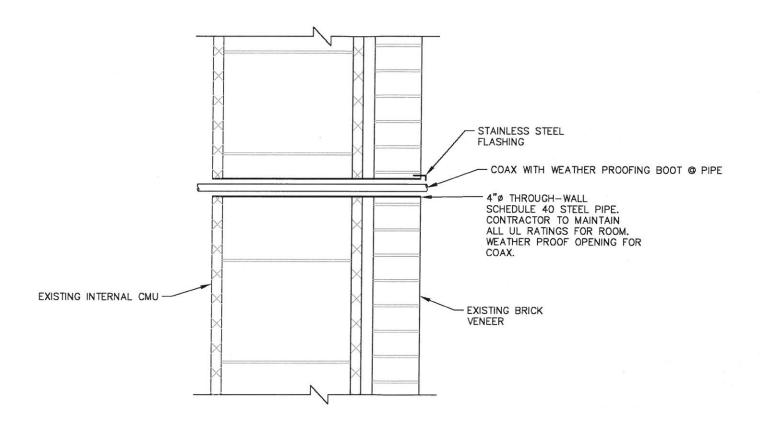
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THROUGH WALL PENETRATION DETAIL

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PEACHTREE CORNERS, GA 30092
PHONE: 770-825-0744
WWW.KIMLEY-HORN.COM
NC License F-0102

CONSULTANT:

DRAWN BY:=CHK.: APV.:

WCE

MWD WCE



SHEET TITLE:

WALL PENETRATION DETAILS

SHEET NUMBER: REVISION:

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#### 1.00 CODES, STANDARDS, AND SPECIFICATIONS

- 1.01 IT IS THE CONTRACTOR'S RESPONSIBILITY TO ENSURE THAT ALL MATERIALS AND LABOR RELATED DIRECTLY OR INDIRECTLY TO ALL ELECTRICAL WORK DOCUMENTED IN THESE DRAWINGS SHALL BE PROVIDED AND PERFORMED IN CONFORMANCE WITH ALL CURRENT GOVERNING CODES, STANDARDS, AND PROFESSIONAL STANDARD OF CARE TO INCLUDE THE AMERICAN SOCIETY FOR TESTING AND MATERIALS (ASTM), UNDERWRITERS LABORATORY (UL), NATIONAL ELECTRICAL MANUFACTURERS ASSOCIATION (NEMA), AMERICAN STANDARDS ASSOCIATION (ASA), NATIONAL FIRE PROTECTION ASSOCIATION (NFPA), AND THE NATIONAL ELECTRICAL CODE (NEC).
- 1.02 MATERIALS SHALL BE NEW AND SHALL CONFORM TO ALL APPLICABLE CURRENT GOVERNING STANDARDS ESTABLISHED FOR EACH ITEM BY ASTM, UL, NEMA, ASA, AND NFPA.
- 1.03 ALL ELECTRICAL WORK SHALL COMPLY WITH ALL APPLICABLE STATE, COUNTY, AND MUNICIPAL CODES AND ORDINANCES, AS WELL AS ALL CURRENT GOVERNING STANDARDS AND PRACTICES AS REQUIRED BY NEC, NEMA, ANSI, NFPA, UBC, UL, IEEE, AND THE LOCAL UTILITY COMPANY.
- 1.04 ALL ELECTRICAL GROUNDING SHALL COMPLY WITH THE CURRENT EDITION OF THE NEC.
- 1.05 CONTRACTOR SHALL MAINTAIN UL LISTED FIRE RATINGS AT ALL WALL PENETRATIONS.
- 1.06 CONTRACTOR SHALL MAINTAIN A MINIMUM CLEARANCE OF 36" IN FRONT OF ALL ELECTRICAL EQUIPMENT AS REQUIRED BY NEC.

#### 2.00 GENERAL

- 2.01 CONTRACTOR SHALL BE RESPONSIBLE FOR ALL PERMITS AND ASSOCIATED FEES RELATED TO THE PROJECT AND SHALL DELIVER A COPY OF ALL PERMITS TO THE VERIZON REPRESENTATIVE.
- 2.02 CONTRACTOR SHALL SCHEDULE AND SHOULD ATTEND ALL INSPECTIONS REQUIRED BY THE JURISDICTION HAVING AUTHORITY.
- 2.03 CONTRACTOR SHALL FURNISH ALL LABOR, MATERIALS, TOOLS, ACCESSORIES, ETC., FOR A COMPLETE WORKING ELECTRICAL INSTALLATION.
- 2.04 ALL WORK SHALL BE PERFORMED IN STRICT ACCORDANCE WITH APPLICABLE BUILDING CODES AND LOCAL ORDINANCES, INSTALLED IN A NEAT MANNER, AND SHALL BE SUBJECT TO APPROVAL BY THE ENGINEER.
- 2.05 CONTRACTOR SHALL PROTECT ADJACENT EQUIPMENT AND FINISHES FROM DAMAGE AND SHALL REPAIR TO ORIGINAL CONDITION ANY ITEMS DAMAGED AS A RESULT OF THE WORK.
- 2.06 IF CONDUIT RUNS HAVE MORE THAN THREE (3) CONSECUTIVE 90 DEGREE TURNS THE CONTRACTOR SHALL INSTALL PULL BOXES AS REQUIRED BY NEC.

#### 3.00 MATERIALS

- 3.01 ALL EQUIPMENT AND MATERIALS SHOWN SHALL BE CONSIDERED NEW UNLESS SPECIFICALLY NOTED OTHERWISE ON THE DRAWINGS.
- 3.02 FINAL CONNECTIONS OF EQUIPMENT SHALL BE PER MANUFACTURER'S APPROVED WIRING DIAGRAMS, DETAILS, AND INSTRUCTIONS. THE ELECTRICAL CONTRACTOR SHALL PROVIDE MATERIALS AND EQUIPMENT COMPATIBLE WITH EQUIPMENT SUPPLIED BY VERIZON.
- 3.03 CONTRACTOR SHALL PROVIDE AN UPDATED PANELBOARD DIRECTORY FOR THE PANEL FROM WHICH THE NEW VERIZON EQUIPMENT CIRCUIT WILL BE CONNECTED. CONTRACTOR SHALL SUBMIT UPDATED DIRECTORY IN A PLASTIC COVER TO THE BUILDING OWNER FOR APPROVAL PRIOR TO INSTALLATION.
- 3.04 ALL CONDUIT WITHIN THE INTERIOR OF THE BUILDING SHALL BE EMT UNLESS OTHERWISE NOTED. ALL CONDUIT ON THE BUILDING EXTERIOR SHALL BE GALVANIZED RIGID STEEL. ALL EXTERIOR CONDUIT CONNECTIONS SHALL BE MADE WITH THREADED HUBS.

- 3.05 CONTRACTOR SHALL FIELD DETERMINE ACTUAL CONDUIT ROUTING AND SHALL OBTAIN APPROVAL FROM THE BUILDING OWNER OF THE PROPOSED ROUTING PRIOR TO CONDUIT INSTALLATION.
- 3.06 ALL CONDUCTORS SHALL BE COPPER WITH THWN INSULATION AND ALL TERMINATIONS SHALL BE RATED FOR AT LEAST 75 DEGREES CELSIUS.
- 3.07 ALL NEUTRAL CONDUCTORS SHALL HAVE WHITE INSULATION. ALL GROUND CONDUCTORS SHALL HAVE GREEN INSULATION. COLOR TAPE IDENTIFICATION OF THESE CONDUCTORS IS NOT PERMITTED.

#### 4.00 PRE-CONSTRUCTION COORDINATION

- 4.01 CONTRACTOR SHALL VISIT THE SITE PRIOR TO BID AND NOTE EXISTING CONDITIONS THAT MIGHT AFFECT THEIR WORK. ALL SUCH CONDITIONS SHALL BE REPORTED TO THE ENGINEER PRIOR TO BID.
- 4.02 CONTRACTOR SHALL PROVIDE A UTILITY LOCATOR AND SHALL VERIFY THE ACTUAL LOCATION OF ALL UTILITIES PRIOR TO CONSTRUCTION. THE CONTRACTOR SHALL BE RESPONSIBLE FOR PROTECTING ALL EXISTING UTILITIES. ANY DAMAGE TO EXISTING UTILITIES SHALL BE REPAIRED AT THE CONTRACTOR'S EXPENSE.
- 4.03 CONTRACTOR SHALL VERIFY, PRIOR TO ROUGH—IN, THAT SITE CONDITIONS ALLOW FOR THE PLACEMENT OF THE ELECTRICAL EQUIPMENT AS SHOWN ON THE PLANS.
- 4.04 ALL OUTAGES SHALL BE CONDUCTED AT A TIME AGREED UPON IN WRITING WITH THE BUILDING OWNER. POWER OUTAGE DURATION SHALL BE PRE-APPROVED IN WRITING BY THE BUILDING OWNER.
- 4.05 CONTRACTOR SHALL PERFORM AN ARC FLASH ANALYSIS AT THE LOAD CENTER ON THE VERIZON TELECOMMUNICATIONS CABINET AND PROVIDE ARC FLASH LABEL PER NEC.
- 4.06 WHEN A NEW ELECTRICAL SERVICE IS REQUIRED, CONTRACTOR SHALL COORDINATE WITH LOCAL ELECTRICAL UTILITY REGARDING THE EXACT LOCATION OF THE TRANSFORMER, ALL METERING REQUIREMENTS, AND CONDUIT ROUTING BETWEEN TRANSFORMER AND METER.
- 4.07 ALL CIRCUIT BREAKERS AND EQUIPMENT SHALL HAVE A MINIMUM AIC RATING OF 10,000 AMPS. IF THE RATING OF THE UTILITY TRANSFORMER PROVIDING THE ELECTRICAL SERVICE IS GREATER THAN 75 kVA, THE CONTRACTOR SHALL PERFORM A SHORT CIRCUIT CURRENT ANALYSIS TO DETERMINE THE REQUIRED AIC RATING FOR THE CIRCUIT BREAKERS AND THE EQUIPMENT. PRIOR TO PURCHASING EQUIPMENT, THE CONTRACTOR SHALL CONTACT THE ELECTRIC UTILITY AND OBTAIN IN WRITING THE MAXIMUM AVAILABLE FAULT CURRENT (AFC) AT THE UTILITY SERVICE POINT. PROVIDE MAX. AFC SIGNAGE AS REQUIRED PER NEC 110.24. THE CONTRACTOR SHALL ENSURE ALL ELECTRICAL EQUIPMENT, CIRCUIT BREAKERS, DISCONNECTS, FUSES, AND PANELBOARDS HAVE A FAULT CURRENT INTERRUPTING RATING GREATER THAN THE AVAILABLE FAULT CURRENT.

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179 DAY DORM ROAD LILLINGTON, NC 27546 HARNETT COUNTY

CURRENT ISSUE DATE:

07/17/17

ISSUED FOR:

#### CONSTRUCTION

CONSULTANT:

=CONSULTANT: =

### **Kimley** » Horn

2 SUN COURT, SUITE 450
PEACHTREE CORNERS, GA 30092
PHONE: 770-825-0744
WWW.KIMLEY-HORN.COM
NC License F-0102

DRAWN BY: CHK.: APV.: CH

SEAL 040828

SHEET TITLE:

ELECTRICAL NOTES

=SHEET NUMBER:====

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EXISTING ELECTRICAL -PANEL ROUTE NEW CONDUCTORS IN EMT CONDUIT -FROM EXISTING PANEL TO NEW VERIZON PANEL, SEE SHEET E3 - PROPOSED CONDUCTORS TO VERIZON EQUIPMENT RACK, SEE SHEET E3 PROPOSED VERIZON PANEL, SEE SHEETS E3 & E4 EXISTING 2"Ø FLOOR PENETRATION THIRD FLOOR STORAGE ROOM ROUTING PLAN SCALE: 1" = 3'

GRAPHIC SCALE: 1" = 3'



8921 RESEARCH DRIVE CHARLOTTE, NORTH CAROLINA 28262

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CONSULTANT:

# **Kimley Horn**

2 SUN COURT, SUITE 450
PEACHTREE CORNERS, GA 30092
PHONE: 770-825-0744
WWW.KIMLEY-HORN.COM
NC License F-0102

CONSULTANT:

DRAWN BY:-CHK.: APV.: WCE MWD

LICENSER: = CO. NGINE.

STORAGE ROOM **ROUTING PLAN** 

SHEET NUMBER: REVISION:

018985165

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#### **KEY NOTES - CONDUIT, CONDUCTORS, & MISC**

- EXISTING UTILITY FEEDERS FROM EXISTING UTILITY TRANSFORMER SECONDARY TO EXISTING ELECTRICAL PANEL.
- ROUTE THREE (3) #2 COPPER CONDUCTORS AND ONE (1) #6 COPPER GROUND IN 13" EMT CONDUIT TO NEW VERIZON PANEL.
- OUTGOING CIRCUITS TO VERIZON EQUIPMENT RACK. FOR EACH CIRCUIT ROUTE TWO (2) #12 COPPER CONDUCTORS AND ONE (1) #12 COPPER GROUND IN  $\frac{1}{2}$ " EMT CONDUIT TO VERIZON EQUIPMENT RACK. SEE PANEL SCHEDULE ON SHEET "E4" FOR ADDITIONAL DETAILS.
- FURNISH AND INSTALL NEW 90 AMP 3-POLE CIRCUIT BREAKER FOR POWER FEED TO VERIZON PANEL, CIRCUIT BREAKER MANUFACTURER, TYPE, ADJUSTABLE TRIP RATING, AND CURRENT INTERRUPTION CAPACITY SHALL MATCH EXISTING CIRCUIT BREAKERS IN THE PANEL. CONTRACTOR SHALL PROVIDE AND INSTALL AN ENGRAVED MICARTA NAMEPLATE NEXT TO THE CIRCUIT BREAKER WHICH SHALL READ "VERIZON PANEL".

#### **KEY NOTES - ELECTRICAL EQUIPMENT**

- EXISTING 208/120 VOLT, 400 AMP RATED PANEL IN THIRD FLOOR STORAGE ROOM. SEE PHOTO #1
- FURNISH AND INSTALL NEW 208/120 VOLT, 100 AMP, THREE-PHASE, 18 SPACE LOAD CENTER, CONTRACTOR SHALL PROVIDE AND INSTALL AN ENGRAVED HIGH ANAMEPLATE FOR THE PANEL WHICH SHALL READ "VERIZON PANEL".



PHOTO #1 - EXISTING ELECTRICAL PANEL IN THIRD FLOOR STORAGE ROOM.

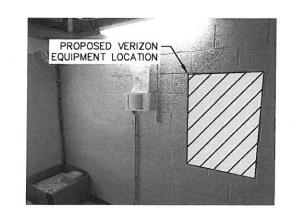


PHOTO #2 - PROPOSED LOCATION OF NEW VERIZON EQUIPMENT IN THIRD FLOOR STORAGE ROOM.





verizon 8921 RESEARCH DRIVE CHARLOTTE, NORTH CAROLINA 28262

PROJECT INFORMATION:

**VERIZON NAME: CAMPBELL UNIVERSITY VERIZON No.: TBD** 179 DAY DORM ROAD LILLINGTON, NC 27546 HARNETT COUNTY

CURRENT ISSUE DATE:

07/17/17

ISSUED FOR:

CONSTRUCTION

A 06/05/17 PRELIMINARY DAJ 0 07/17/17 CONSTRUCTION CCH

CONSULTANT:

2 SUN COURT, SUITE 450
PEACHTREE CORNERS, GA 30092
PHONE: 770-825-0744
WWW.KIMLEY-HORN.COM NC License F-0102

CONSULTANT:

DRAWN BY:-CHK.:-APV.: MWD WCE

LICENSER: = PARTITION OF THE PARTIES

SINGLE-LINE

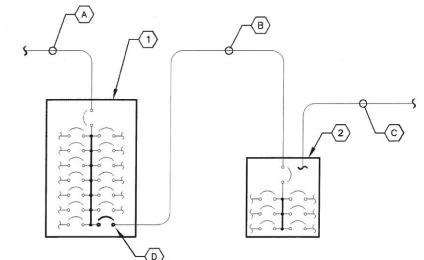
DIAGRAM

SHEET NUMBER: REVISION:

SHEET TITLE:

018985165

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THIRD FLOOR STORAGE ROOM

SINGLE-LINE DIAGRAM

NOT TO SCALE

#### **VERIZON PANEL SCHEDULE**

Voltage: 208/120 Volts Phase, Wires: Three Phase, 4 Wire MCB Size: 90 Amps

AIC Rating: 10,000 Amps min (see electrical notes)

Mounting Type: Surface

Enclosure Type: NEMA 1R

Bus Rating: 100 Amps Neutral Rating: 100%

	Lo	ad (kVA	.)	Circuit	Ckt	Phase	Ckt	Circuit	Lo	oad (kVA	A)	15
Load Served	Α	В	С	Bkr Size	Nbr	ABC	Nbr	Bkr Size	Α	В	С	Load Served
RECTIFIER #1	1.35			2P-20	1	<b>-</b> ↑++++•	2		0.00			SPACE
		1.35			3		4	2P-20		1.35		RECTIFIER #2
RECTIFIER #3			1.35	2P-20	5		6				1.35	
	1.35				7		8.	2P-20	1.35			RECTIFIER #4
		0.00			9		10			1.35		
SPACE			0.00		11	•    •	12				0.00	SPACE
SPACE	0.00				13	•	14		0.00			SPACE
SPACE		0.00			15	• •	16			0.00		SPACE
GFCI QUAD OUTLET			1.92	1P-20	17	•••	18				0.00	SPACE
Sub-Total (kVA)	2.70	1.35	3.27						1.35	2.70	1.35	Sub-Total (kVA)

					Α	В	С	_
					4.05	4.05	4.62	W. 180 W. S.R. 180 NO.
LOAD SUMMARY						12.72		Total Connected Load (kVA)
S 862 * 8.50			d (kVA)	Demand Factor	0000	nd Load		
Load Description	Α	В	С	ractor	Α	В	С	
RECTIFIERS	4.05	4.05	2.70	1.25	5.06	5.06	3.38	
LARGEST MOTOR	0.00	0.00	0.00	1.25	0.00	0.00	0.00	
ALL OTHER MOTORS	0.00	0.00	0.00	1.00	0.00	0.00	0.00	
LIGHTING	0.00	0.00	0.00	1.25	0.00	0.00	0.00	
OUTLETS	0.00	0.00	1.92	1.00	0.00	0.00	1.92	
TOTAL MISCELLANEOUS	0.00	0.00	0.00	1.25	0.00	0.00	0.00	(B
	Tota	al Dema	nd Powe	r per Phase	5.06	5.06	5.30	kVA
	Total	Deman	d Curren	t per Phase	42.20	42.20	44.10	Amps
		т	otal Den	nand Power		15.42		kVA

PANEL SCHEDULE NOT TO SCALE

### **CAPACITY VERIFICATION - EXISTING PANEL**

Name of local utility: DUKE ENERGY

Total Connected Load (Current): 280 Amps

Total demand current for Verizon panel: 90 Amps

New phase current demand on existing 200 Volt, 3 phase service: 370 Amps B

Service Size: 400 Amps (A)

(A) > (B), Therefore, the service has sufficient capacity for the additional load.

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**Kimley** Whorn

2 SUN COURT, SUITE 450
PEACHTREE CORNERS, GA 30092
PHONE: 770-825-0744
WWW.KINLEY-HORN.COM
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CONSULTANT:

DRAWN BY:-CHK.: APV.:

WCE

CCH

MWD

PANEL

**SCHEDULE** 

SHEET NUMBER:

SHEET TITLE:

E4

0

==REVISION:=

018985165