



Plan Review, Inspection, and Permit Fees

Application Number	:	165004046	56	
\$100.00		DRB Major Sub Division Prelim Site Plans	\$	_
\$200.00		Explosive Material (90 Days)	\$	_
\$100.00		Explosive Materials (72 Hours)	\$	_
\$100.00		Fireworks Public Display	\$	_
\$50.00	V	Final Inspection	\$	50.00
\$35.00 + \$2.00 per device		Fire Alarm Testing	\$	50.00
\$35.00 + \$2.00 per nozzle		Fixed Fire Suppression	\$	_
\$75.00		Insecticide Fog/Fumigation	\$	_
\$100.00		Pipe Test/UST/AGST	\$	_
\$50.00	V	Plans up to 5000 sq ft	\$	50.00
\$100.00		Plans 5001 sq ft to 10,000 sq ft	\$	-
\$150.00		Plans 10,001 sq ft to 25,000 sq ft	\$	_
\$250.00		Plans 25,001 sq ft and over	\$	_
\$35.00 + 2.00 per head		Sprinkler Certification Test	\$	_
\$50.00		Standpipe Testing	\$	_
\$50.00		Special Assembly	~	_
755.00		(ie. amusement buildings, carnivals, fairs)	\$	-
\$75.00		Tents/Canopies/Air Supported Structure	\$	_
\$100.00		Tank Installation (charge for each tank)		
\$100.00		Tank Removal (charge for each tank)	\$	-
		Total Devices/Heads	\$	-
		Total Cost	\$	
		TOTAL COST	\$	100.00
Code Enforcement Official		Rodney Daniels		1/17/2017



Fire Marshal Division

January 17, 2017

Connie Sessoms, Jr. 319 Brewer Road Cameron, NC 28326

Re: True Victory Deliverance Tabernacle, Storage Shed

319 Brower Road Cameron, NC 28326

Application Number 16-50040466

Mr. Sessoms,

Thank you for submitting the plans for the new storage building. The plans have been carefully reviewed by a qualified code enforcement official to examine for compliance with the North Carolina Fire Prevention Code and all other fire protection regulatory documents. There are some items that were found during the plan review process that need to be addressed before a final inspection of the new facility can be given. These items are outlined and described below.

906.1 Fire Extinguishers

- A fire extinguisher shall be placed inside the shed.
- Fire extinguishers shall not be installed more than 60" above the walking surface.
- The fire extinguishers provided shall have a minimum rating of 2A 10B: C and shall not be installed higher than 5 feet above the finished grade.

503 Fire Department Access

- The fire department access shall extend to within 150 feet of all portions of the facility (current driveway and parking lot may suffice).
- The fire department access road shall be of an unobstructed width of not less than 20 feet and shall have an unobstructed vertical clearance of not less the 13 feet 6 inches.



Notes

- Please schedule fire final inspection through the Fire marshal's office.
- o 910-893-0743

Thank you again for submitting the plans for the new storage building. Please review the plans and adhere to any notes and alterations that were made in addition to the original drawings. These remarks are for the plans that were submitted and its original intent. These remarks do not apply if the original intent changes or what was submitted on the above date changes. If you have any questions, please do not hesitate to call this office

Again, thank you and we look forward to working with you during the construction period!

Sincerely,

Rodney Daniels Chief Deputy Fire Marshal

CODE CRITERIA:

THE CONTRACTOR/MANUFACTURER SHALL COMPLY WITH THE FOLLOWING CODES AND ALL APPLICABLE AMENDMENTS/SUPPLEMENTS:

INTERNATIONAL BUILDING CODE, 2015.

NETT COUNTY EMERGENCY SERVICES SHOULD NOT BE USED IN OTHER LOCATIONS. IEWED FOR CODE COMPLIANCE





PROJECT NOTE:

THIS BUILDING IS NOT DESIGNED FOR HUMAN HABITATION AND DOES NOT HAVE WATER, SEWER, FILECTRICAL OR HVAC SYSTEMS. THIS BUILDING IS DESIGNED AS A MINOR STORAGE OCCUPANCY ONLY.

GENERAL NOTES:

- 1. STRUCTURE HAS BEEN DESIGNED IN ACCORDANCE WITH THE INTERNATIONAL BUILDING CODE, 2012.
- 2. ALL MATERIALS AND LABOR SHALL BE IN ACCORDANCE WITH THE ABOVE CODE AND ALL OTHER APPLICABLE LOCAL CODES AT THE TIME OF MANUFACTURE.
- 3 DRAWINGS SHALL NOT BE SCALED FOR DIMENSIONS.
- 4. STRUCTURES ARE CLASSIFIED AS "MINOR STORAGE FACILITIES" (OCCUPANCY CATEGORY I) AND SHOULD NOT BE USED FOR HUMAN HABITATION.

- 5. STRUCTURES ARE DESIGNED FOR LOCATIONS THAT HAVE A 3 SECOND WIND GUST OF 150 MPH (MAX). STRUCTURES SHOULD NOT BE USED IN OTHER LOCATIONS.
- 6. STRUCTURES ARE DESIGNED FOR LOCATIONS WITH A SURFACE ROUGHNESS CATEGORY B AND A TOPOGRAPHICAL FACTOR OF 1.0. STRUCTURES
- 7. STRUCTURES SHOULD HAVE METAL ROOF OR OPTIONAL 25 YEAR RATED FIBERGLASS/ASPHALT SHINGLES WITH 1 LAYER OF 15 LB ROOFING FELT.
- 8. ALL STUDS, RAFTERS, COLLAR TIES, AND TRUSS CHORDS ARE SPF #2, U.N.O.
- 9. ALL EXTERIOR DIMENSIONAL WOOD IS TO BE PRESSURE TREATED
- 10. ALL ROOF DECKING IS TO BE 76" O.S.B.
- 11. ALL SIDING IS TO BE 1832 T-111 OR DURATEMP SIDING W/ 50 YR LTD MFG WARRANTY.
- 12. ALL FLOOR JOISTS ARE TO BE P.T. SYP #2.
- 13. ALL EXTERIOR NAILS ARE TO BE HOT DIPPED GALVANIZED.
- 14. ALL INTERIOR FLOOR DECKING IS TO BE %" PLYWOOD, EXTERIOR TO BE %" P.T.
- 15. ALL SKIDS ARE TO BE 4x6 P.T. SYP, RATED FOR GROUND CONTACT.
- 16. THE STRUCTURE HAS BEEN DESIGNED TO RESIST LOADS AS A COMPLETED STRUCTURE ONLY. APPLICATION OF CONSTRUCTION LOADS TO THE PARTIALLY COMPLETED STRUCTURE SHALL BE CONSIDERED BY THE CONTRACTOR AND INCLUDED IN THE DESIGN OF SHORING, BRACING, FORM WORK, AND OTHER SUPPORTING ELEMENTS PROVIDED FOR CONSTRUCTION OF THE STRUCTURE.
- 17. NO FIELD SUPERVISION OR CONSTRUCTION ADMINISTRATION WILL BE PROVIDED BY THE ENGINEER.

DESIGN CRITERIA:

- 1. INTERNATIONAL BUILDING CODE 2015
- 2. DEAD LOADS: FLOOR: 10 PSF LOFT: 5 PSF ROOF: 10 PSF
- LIVE LOADS: FLOOR: 40 PSF LOFT: 10 PSF ROOF: 20 PSF (REDUCIBLE)
- 4. SNOW LOADS: GROUND SNOW LOAD, Pg=25psf FLAT ROOF SNOW LOAD, Pf=20psf SNOW EXPOSURE FACTOR, Ce=1.2 SNOW LOAD IMPORTANCE FACTOR, 1=0.8 THERMAL FACTOR, Ct=1.2
- 5. WIND LOADS: BASIC WIND SPEED, V=150 MPH RISK CATEGORY = 1 WIND EXPOSURE C WIND LOAD IMPORTANCE FACTOR = 1.0 C&C ROOF-ZONE 1=23.3, -37.0 psf C&C ROOF-ZONE 2=23.3, -64.5 pst C&C ROOF-ZONE 3=23.3, -95.4 psf C&C WALL-ZONE 4=40.5, -43.9 psf C&C WALL-ZONE 5=40.5, -54.2 psf
- 6. SEISMIC LOADS: THIS STRUCTURE IS EXEMPT FROM SEISMIC DESIGN PER EXEMPTION 3 OF ASCE 7-10. SECTION 11 1.2

ITEMS BY OTHERS:

THE FOLLOWING ITEMS ARE NOT PROVIDED BY RAILROAD CONSULTANTS, PLLC AND ARE TO BE DESIGNED BY OTHERS IF APPLICABLE AND ARE TO BE SUPPLIED AND INSTALLED BY OTHERS. THESE ITEMS MAY BE SUBJECT TO LOCAL JURISDICTION APPROVAL. RAILROAD CONSULTANTS, PLLC IS NOT RESPONSIBLE THESE ITEMS.

- 1. RAMPS, STAIRS, AND GENERAL ACCESS
- 2. ELECTRICAL SERVICE HOOKUP

BUILDING SIZES:


12' WIDTH** **NOTE:(10'-11 ACTUAL) 12'x20' 12'x24' 12'x28'

12'x32'

INDEX OF SHEETS:

S-0-CP - COVER SHEET S-1-CP - FOUNDATION PLAN S-Z-CP - UPLIFT ANCHORAGE S-3-CP - FRAMING PLAN S-4-CP - BUILDING SECTIONS S-5-CP - ELEVATIONS S-6-CP - NAILING PATTERN S-7-CP - DETAILS S-8-CP - DETAILS



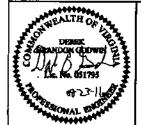

ORNER PORCH LBC--VA--V=150MPH--IBC 2




RAILROAD CONSULTANTS, PLLC 718B SOUTH CHURCH STREET MURFREESBORO, TN 37130 PHONE: (615) 663-1142



GRACELAND PORTABLE BUILDINGS, LLC 6807 HWY 62 WEST BARDWELL, KY 42023 PHONE: (866) 574-7446

PROJECT NO:	14017
DATE	08-23-16
DRAWN BY:	JGG
CHECKED BY:	DBG
REVISION:	01

SHEET NUMBER

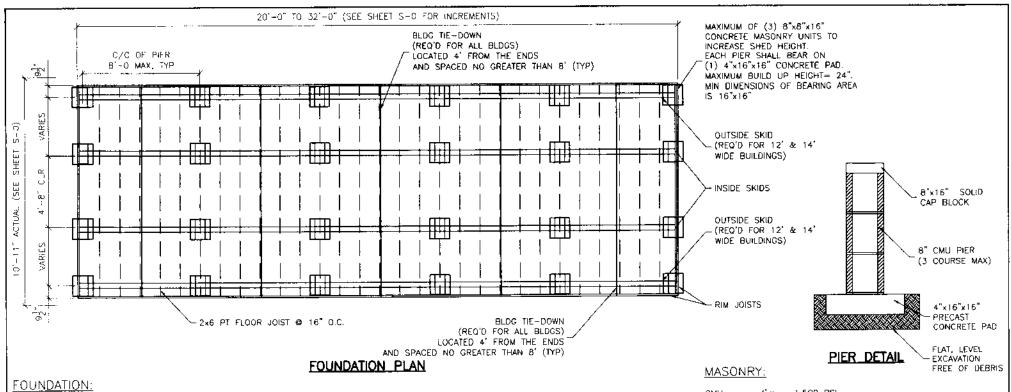

- ANCHORS ARE SPECIFIED ON SHEET S-2 AND SHALL BE INSTALLED PER MANUFACTURE'S RECOMMENDATIONS PER THE BUILDING CODE.
 ANCHORS AND STRAPS INCLUDING THE INSTALLATION SHALL MEET THE REQUIREMENTS OF APPENDIX E OF THE INTERNATIONAL RESIDENTIAL
- BUILDING CODE. 3. THE MINIMUM ALLOWABLE SOIL BEARING CAPACITY OF 2500 psf HAS BEEN ASSUMED FOR FOOTING DESIGN. CONTRACTOR TO HAVE THIS CAPACITY
- VERIFIED PRIOR TO CONSTRUCTION.
 4. IF A MINIMUM ALLOWABLE SOIL BEARING CAPACITY OF 1500 psf is used, then the PIER SPACING SHALL BE NO GREATER THAN 4'-O.
- 5. FOOTINGS SHALL BE CARRIED TO AN ELEVATION LOWER THAN THOSE SHOWN ON THE DRAWINGS IF REQUIRED TO REACH SUITABLE SOIL. 5. FOOTINGS SHALL BE PLACED ON SUITABLE SOIL THAT MEETS DESIGN ASSUMPTIONS.
- FOUNDATION MATERIALS AND LABOR IS PROVIDED BY CUSTOMER.
- 3. TIE DOWNS SHALL BE PLACED AT EACH OUTER PIER.
- SHED IS DESIGNED TO ALSO BE PLACED ON FLAT, LEVEL GROUND DIRECTLY ON THE SKIDS

CMU f'm = 1,500 PSI MORTAR f'm = 1,900 PSI GROUT f'm = 3,500 PSI

CONCRETE:

1. MATERIALS (COMPRESSIVE STRENGTH AT 28 DAYS)
FOOTINGS 3,000 PSI
FOOTINGS AND EXTERIOR CONCRETE SHALL BE AIR-ENTRAINED



CORNER PORCH LBC--VA--V=150MPH--IBC 2015




RAILROAD CONSULTANTS, PLLC 718B SOUTH CHURCH STREET MURFREESBORO, TN 37130 PHONE: (615) 663-1142



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	PROJECT NO:	14017
-	DATE	08-23-16
	DRAWN BY:	JGG
i	CHECKED BY:	DBG
١	REVESIONS	01

SHEET NUMBER
S-1-CP
SCALE: 1/4"=1'-0

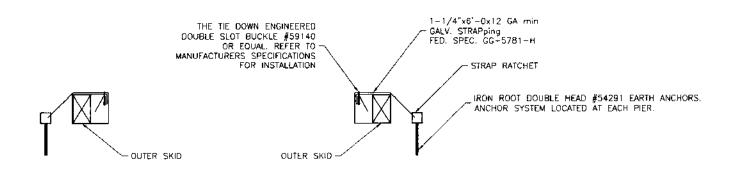

ANCHOR TIE DOWN DETAIL



CORNER PORCH LBC--VA--V=150MPH--IBC 2015



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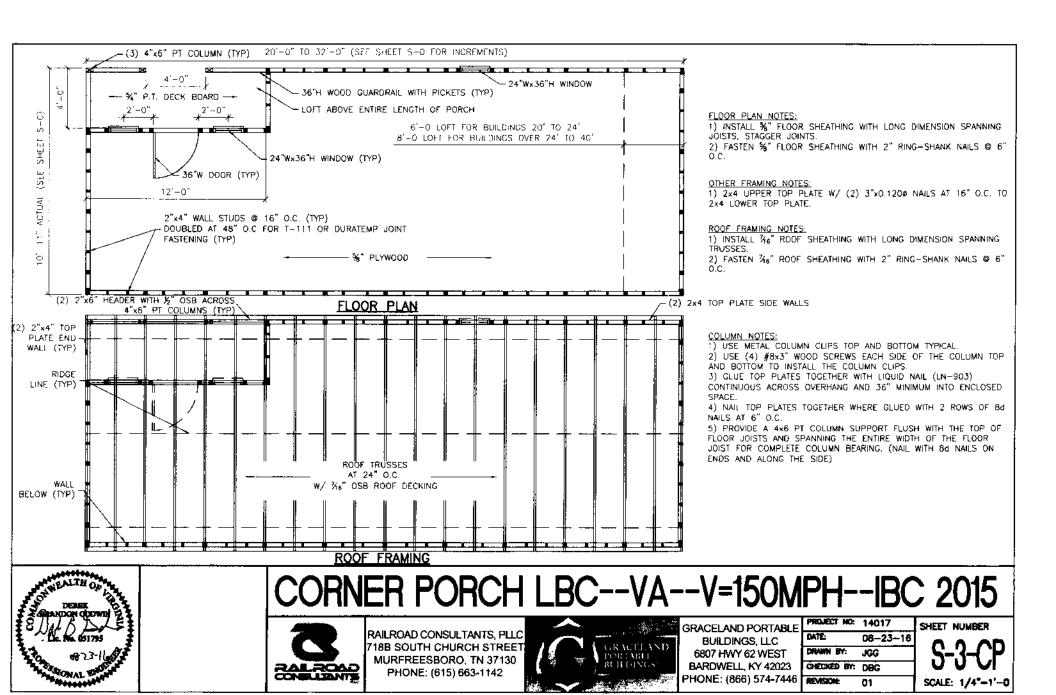



GRACELAND PORTABLE BUILDINGS, LLC 6807 HWY 62 WEST BARDWELL, KY 42023 PHONE: (866) 574-7446

F	PROJECT NO:	14017
_	DATE:	08-23-16
	DRAWN BY:	JGG
	CHECKED BY:	DBG
6	REVISION:	01

S-2-CP

SCALE: 1/4"=1'-0



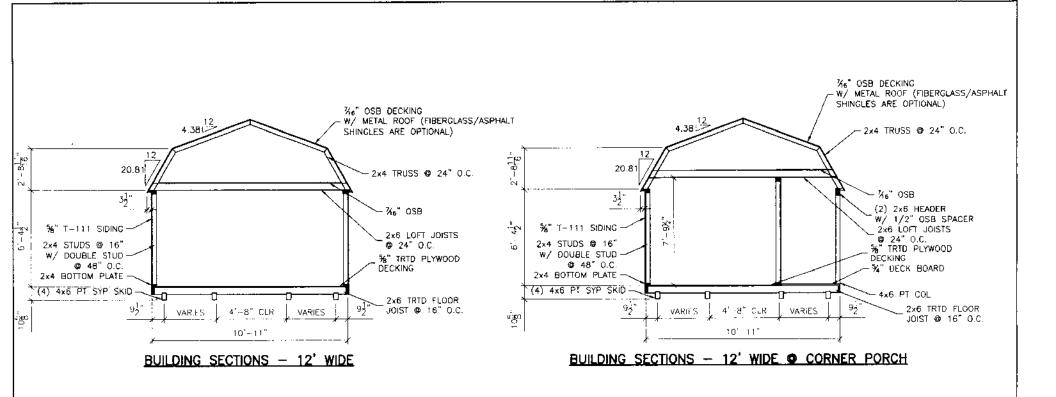



CORNER PORCH LBC--VA--V=150MPH--IBC 2015




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PROJECT NO:	14017
DATE	08-23-16
DRAWN BY:	JGG
CHECKED BY:	DBC
REVISION:	01

SHEET NUMBER
SCALE: 1/4"=1'-0





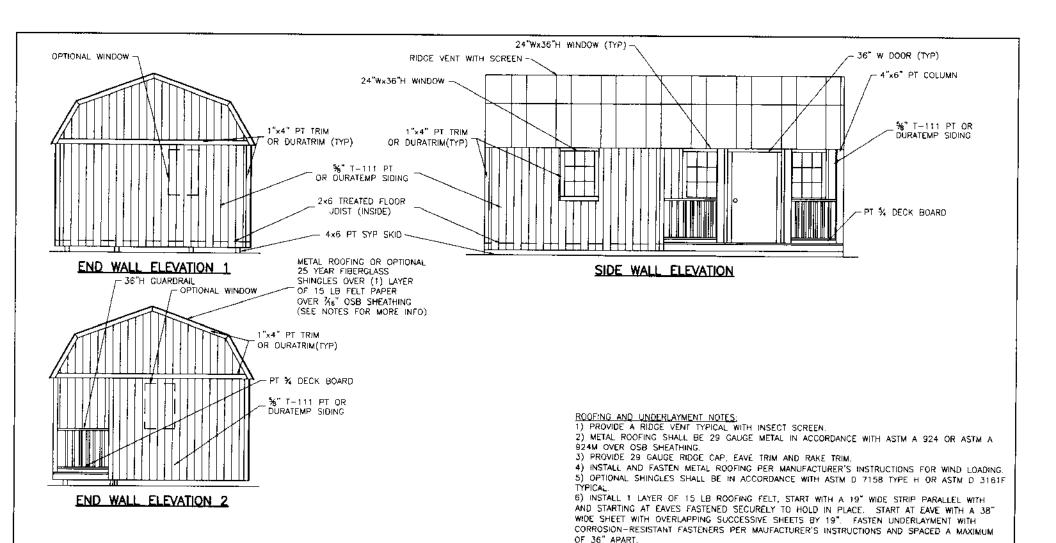


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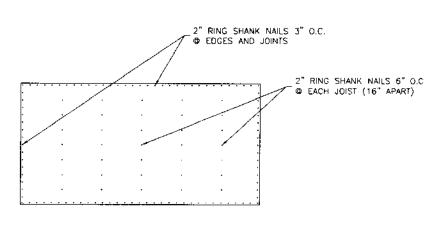


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REVISION:	01

SHEET NUMBER
S-5-CP
SCALE: 1/4"=1'-0



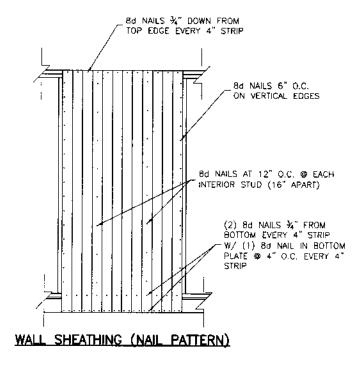

FLOOR SHEATHING (NAIL PATTERN)



CORNER PORCH LBC--VA--V=150MPH--IBC 2015



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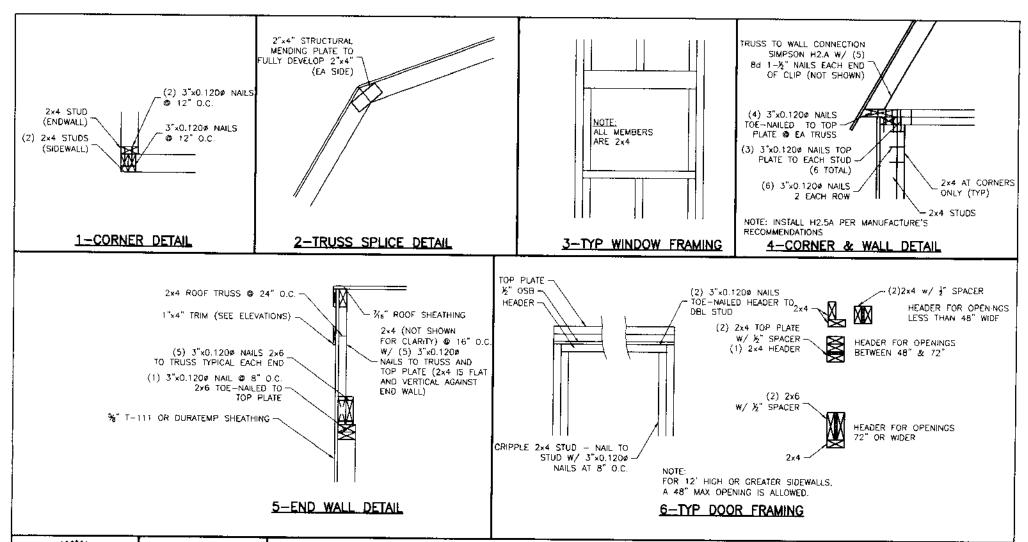
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CHECKED BY:	DBG
REVISION:	01

SHEET NUMBER

S-6-CF

SCALE: 1/2"-1"





CORNER PORCH LBC--VA--V=150MPH--IBC 2015




RAILROAD CONSULTANTS, PLLC 718B SOUTH CHURCH STREET MURFREESBORO, TN 37130 PHONE: (615) 663-1142




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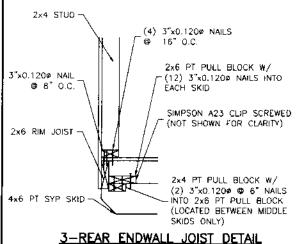
PROJECT NO:	14017
DATE:	0823-16
DRAWN BY:	JGG
CHECKED BY:	D B G
REVISION:	01


SHEET NUMBER
S-7-CP
SCALE: 1"-1"

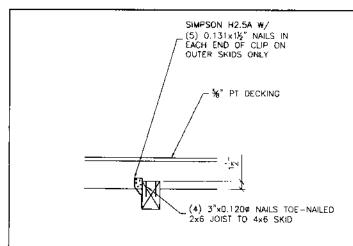

1-INNER & OUTER SKID DETAIL @ EVERY JOIST



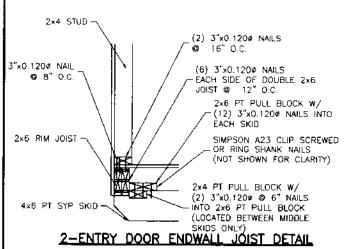

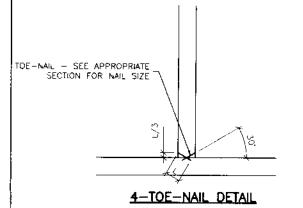

PT 2x4x48" LAP SPLICE FASTENED

WITH (2) - 3" RING-SHANK NAILS 3" O.C.


EACH SIDE OF SKID (24 PER 2x4)

4X6 SKID WITH 1½" WIDE x 1" DEEP NOTCHES

AT 16" O.C. ENTIRE LENGTH OF SKID TO

ACCOMMODATE FLOOR JOISTS (TYP)

5—SKID DETAIL

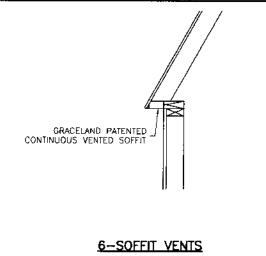



CORNER PORCH LBC--VA--V=150MPH--IBC 2015



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:	PROJECT NO:	14017
	DATE:	08-23-16
	DRAIN BY:	JGG
	CHECKED BY:	DBG
1	REVISIONS	01

SHEET NUMBER

S-8-CP

SCALE: 1"-1"