BUILDER SHALL VERIFY ALL DIMENSIONS AND CONDITIONS AT TIME OF CONSTRUCTION.

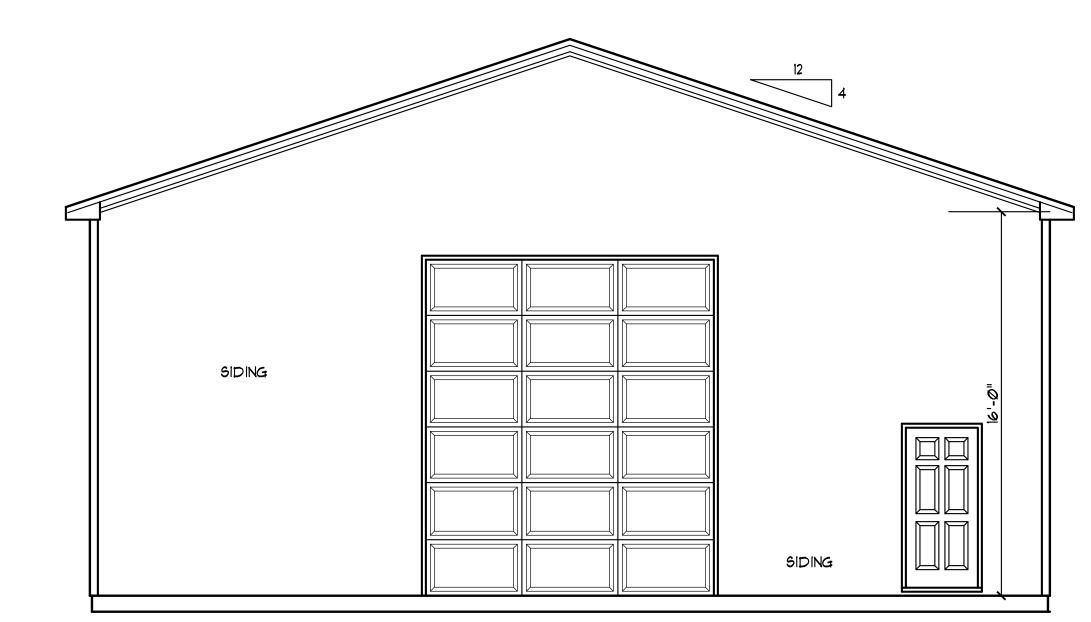
ALL CONSTRUCTION SHALL CONFORM TO THE 2018 EDITION OF THE NC STATE BUILDING CODE.

CODES GOVERN OVER DRAWINGS.


DIMENSIONS GOVERN OVER SCALE.

VERIFY ALL MECHANICAL REQUIREMENTS BEFORE FRAMING.

VUNCANNON DESIGNS DOES NOT ASSUME LIABILITY FOR ANY DEVIATION OF OR CONSTRUCTION METHODS OF THESE PLANS.



SCALE: 1/4" = 1'-0"

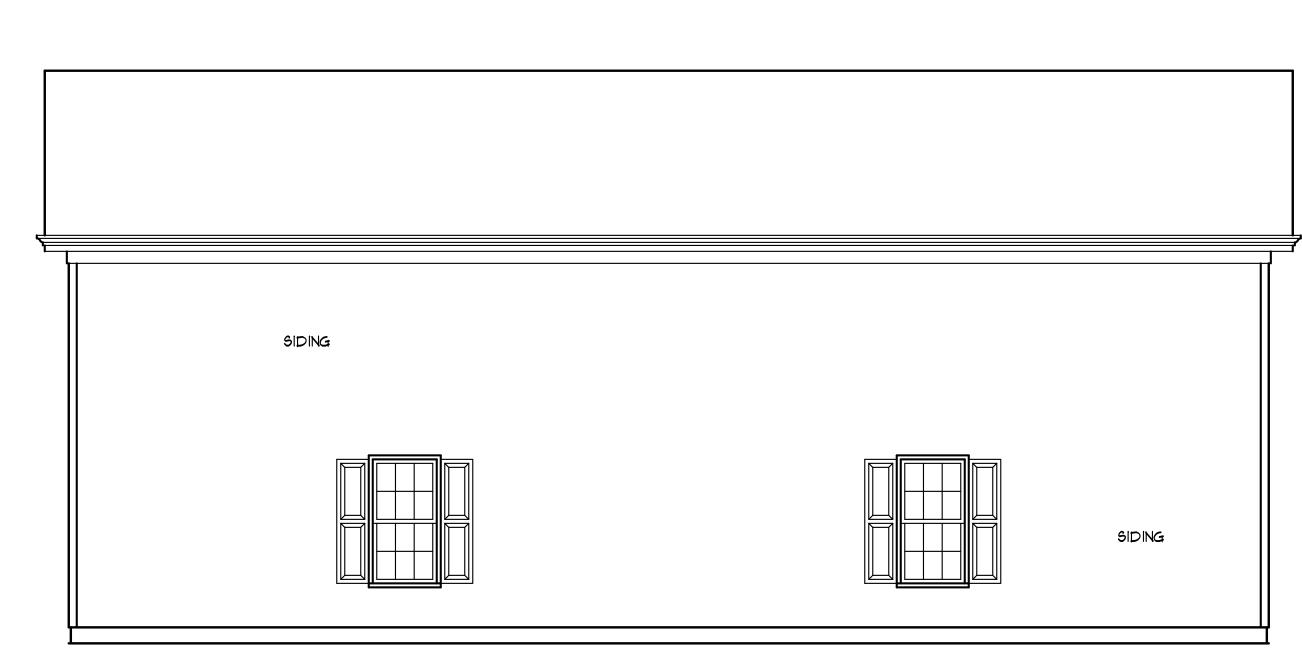

# STRUCTURAL EVALUATION BY:

HOWERTON SERVICES PLIC 3513 CATHEDRAL BELL ROAD RALEIGH, NC 27614 LICENSE P-1716

- \* ENGINEER'S SEAL APPLIES ONLY TO STRUCTURAL COMPONENTS ON THIS DOCUMENT. SEAL DOES NOT INCLUDE CONSTRUCTION REVIEW, MEANS, METHODS, TECHNIQUES, SEQUENCES, PROCEDURES OR SAFETY PRECAUTIONS.
- \* ANY DEVIATIONS OR DISCREPANCIES ON PLANS ARE TO BE BROUGHT TO IMMEDIATE ATTENTION OF THE ENGINEER. FAILURE TO DO SO WILL VOID ENGINEER'S LIABILITY.
- \* DO NOT SCALE THESE DRAWINGS ENGINEERING APPROVAL EXPIRES 07/01/2026



06 11 2025 EDT NOTE: () = # OF JACK STUDS UNDER BEAM

#### GENERAL ROOF NOTES:

- 1. THIS PLAN DESIGNED IN ACCORDANCE WITH NC RESIDENTIAL CODE, 2018 EDITION.
- 2. ROOF CLADDING DESIGN VALUES (POSITIVE/NEGATIVE) SHALL BE AS FOLLOWS:
  - 45.5 \*/SF FOR ROOF PITCHES FROM Ø /12 TO 2.25 /12 34.5 \*/6F FOR ROOF PITCHES FROM 2.25 /12 TO 7 /12
- 21 \*/SF FOR ROOF PITCHES FROM 7 /12 TO 12 /12
- 3. ALL ROOFING ELEMENTS SHALL MEET THE REQUIREMENTS OF CHAPTER 8 OF THE CODE. 4. ALL LUMBER SHALL BE #2 SPF OR BETTER. RAFTERS MAY BE FINGER JOINTED PER
- NATIONAL DESIGN SPECIFICATIONS FOR WOOD CONSTRUCTION, AND MUST HAVE THE STRUCTURAL CERTIFICATION STAMPED ON THE MEMBER.
- 5. RAFTER SIZES, SPANS AND SPACING SHALL NOT EXCEED THE FOLLOWING: 2×6 2×8 2×10
- SPACING 12" O.C. 14'-9" 19'-6" 24'-10" SPACING 16" O.C. 13'-5" 17'-9" 22'-3"
- 6. ALL RAFTERS TO BE 2X8 @ 16" O.C. #2 SPF UNLESS NOTED OTHERWISE.
- 1. 2-2XIØ HIPS MAY BE SPLICED WITH A MIN. 6'-Ø" OVERLAP.
- 8. PROVIDE DOUBLE RAFTER EACH SIDE OF DORMERS WITH DOUBLE HEADER. 9. ATTACH VAULTED RAFTERS WITH HURRICANE CLIP SIMPSON "H-5" OR EQUIVALENT.
- PROVIDE DOUBLE OPPOSING RAFTERS WHERE NOTED. 10. 2X8 RAFTERS @ CATHEDRAL OR VAULTED CEILINGS TO BE FURRED DOWN 2" OR USE
- 2XIØ RAFTERS FOR INSULATION PER CODE.
- 11. PROVIDE 2X4 COLLAR TIES EVERY SECOND RAFTER (TYPICAL)
- 12. PROVIDE 2X4 RAFTER TIES @ 32" O.C. (TYPICAL)
- 13. FRAME RAFTERS ON 2X4 PLATE ON TOP OF CEILING JOISTS UNLESS NOTED OTHERWISE. 14. SHINGLES ASSUMED TO BE 240 LB. FIBERGLASS, OR EQUAL. MINIMUM ROOF PITCH TO BE AS INDICATED ON ARCHITECTURAL PLAN SHEETS.
- 15. PROVIDE DOUBLE LAYER OF ROOF FELT WHERE ROOF PITCH IS LESS THAN 4 /12.
- 16. THESE DESIGN DRAWINGS WERE PRODUCED BY HOWERTON SERVICES, PLLC ASSUMES
- NO LIABILITY FOR THE CORRECTNESS OF ARCHITECTURAL FEATURES, DIMENSIONS OR FIXTURES. 17. ALL HIP RIDGES AND VALLEYS SHALL BE DOUBLE 2XIØ UNLESS NOTED OTHERWISE.
- 18. CONTRACTOR IS RESPONSIBLE FOR REVIEWING DRAWINGS FOR CONSTRUCTABILITY PRIOR TO BEGINNING CONSTRUCTION.
- 19. VALLEY RAFTERS WITH SPANS LONGER THAN 15' SHALL BE LVLS SUPPORTED AS NOTED. PROVIDE TEMPORARY STIFF KNEE SUPPORT UNTIL ALL SHEATHING AND RAFTER TIES/COLLARS ARE
- 20. DO NOT SCALE THESE DRAWINGS. IF DESCREPANCIES ARE NOTED, CONTACT THE DESIGNER.

- GENERAL FRAMING NOTES:
- I. THIS PLAN DESIGNED IN ACCORDANCE WITH NC RESIDENTIAL CODE, 2018 EDITION.
- 2. GLAZING AREAS SHOWN ON THESE DESIGN DRAWINGS DO NOT EXCEED 15% OF THE GROSS AREA OF THE EXTERIOR WALLS. THIS STRUCTURE MEETS THE REQUIREMENTS OF NIIØ1.2.1, RESIDENTIAL BUILDING, TYPE A-1.
- 3. WALL CLADDING IS DESIGNED FOR A 24.1 \*/SF OR GREATER POSITIVE/NEGATIVE PRESSURE.
- 4. ALL WALLS, FLOORS AND CEILINGS SHALL BE INSULATED IN ACCORDANCE WITH PART IV, ENERGY CONSERVATION, CHAPTER II, ENERGY EFFICIENCY OF THE CODE FOR ZONE 7 (TABLE NIIØ1.2).

5. DESIGN CRITERIA DEAD 10 PSF 40 PSF PRIMARY FLOOR 10 PSF 40 PSF SECONDARY FLOOR SLEEPING AREAS 10 PSF 30 PSF ATTIC 10 PSF ROOF 10 PSF 20 PSF WIND 120 MPH

DEFLECTION LIMITS FLOOR - L/360 (LIVE LOAD ONLY) ROOF - L/240

- 6. ALL HEADERS IN LOAD BEARING WALLS SHALL BE DOUBLE 2X10.
- 7. ALL WALLS ARE 2X4 @ 16" O.C. UNLESS OTHERWISE NOTED.
- 8. FLOOR INSULATION = R-19, EXTERIOR = R-15 AND CEILING = R-38.
- 9. PROVIDE DOUBLE FLOOR JOISTS OR TRUSS UNDER WALLS ABOVE.

#### R602.7.5 SUPPORTS FOR HEADERS:

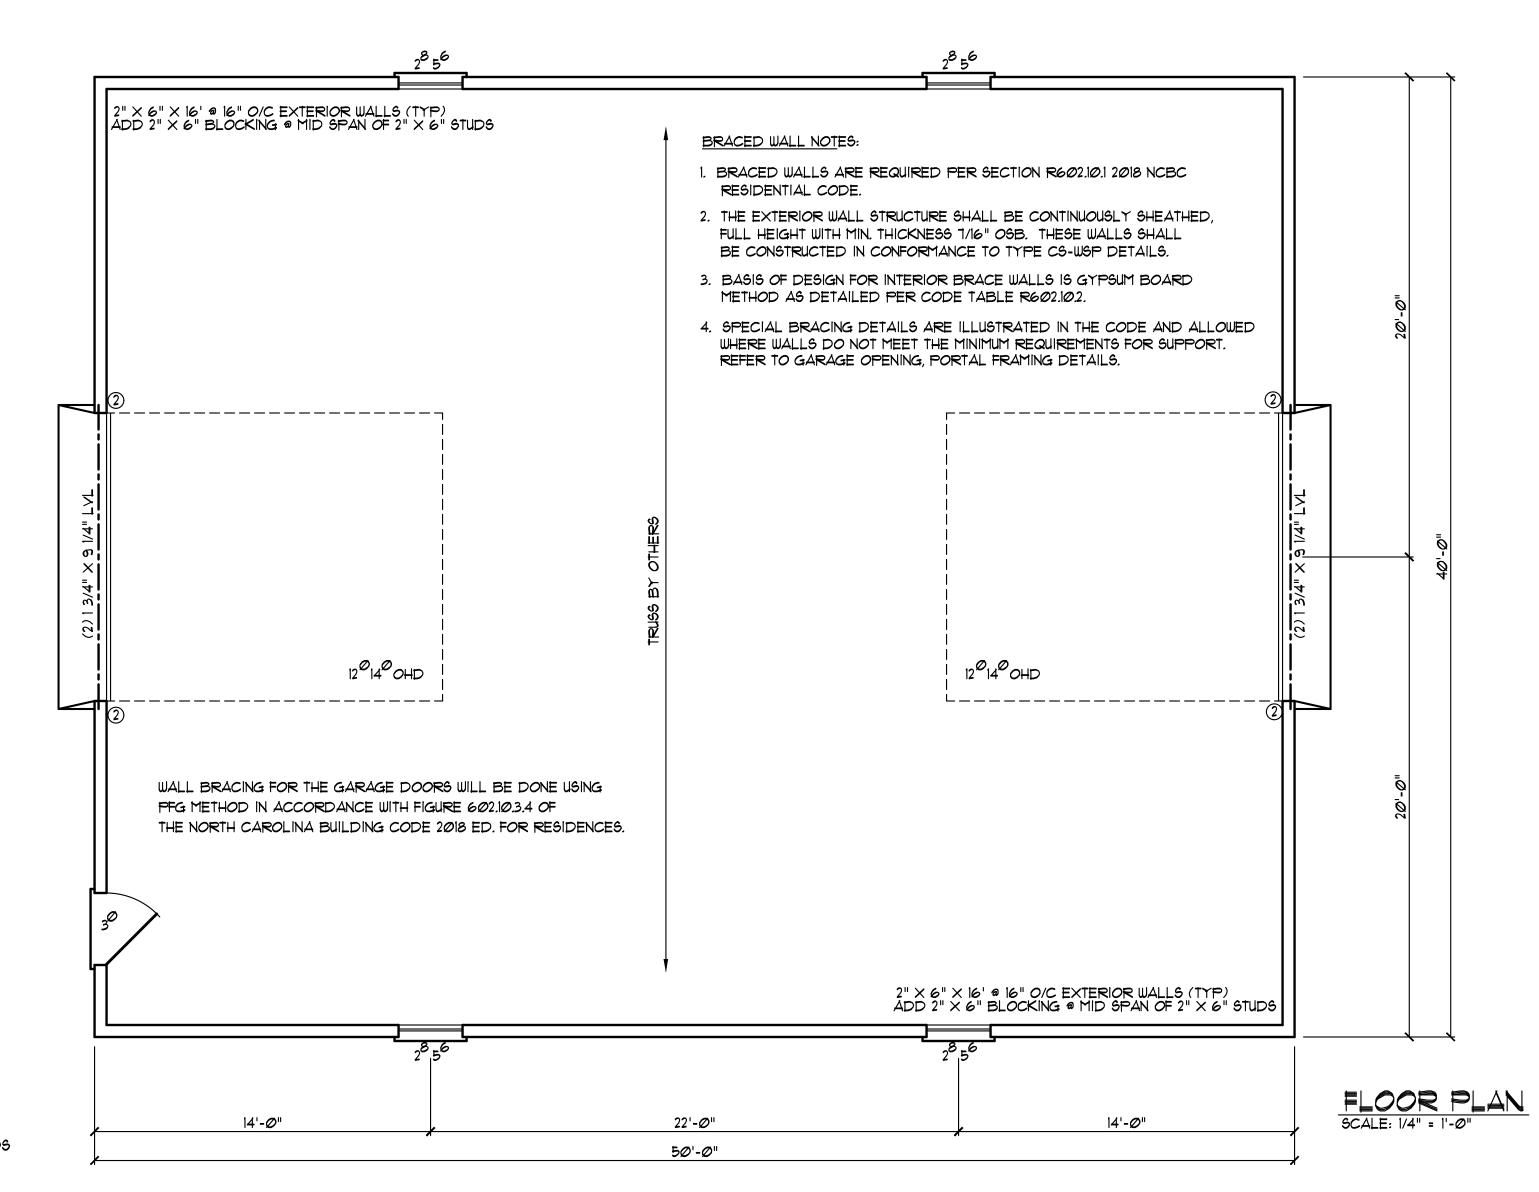
HEADERS SHALL BE SUPPORTED ON EACH END WITH ONE OR MORE JACK STUDS OR WITH APPROVED FRAMING ANCHORS IN ACCORDANCE WITH TABLE R602.7(1) OR R602.7(2). THE FULL-HEIGHT STUD ADJACENT TO EACH END OF THE HEADER SHALL BE END NAILED TO EACH END OF THE HEADER WITH FOUR-16D NAILS (3.5 INCHES X Ø.135 INCHES). THE MINIMUM NUMBER

OF FULL-HEIGHT STUDS AT EACH END OF A HEADER SHALL BE IN ACCORDANCE WITH TABLE R602.7.5.

### TABLE R602.7.5

MINIMUM NUMBER OF FULL-HEIGHT STUDS AT EACH END OF HEADERS IN EXTERIOR WALLS





DRAWN BY : WRV CHK'D BY : WRY DATE: Ø6/12/25 REVISIONS :

SHEET

BUILDER SHALL VERIFY ALL DIMENSIONS AND CONDITIONS AT TIME OF CONSTRUCTION.

ALL CONSTRUCTION SHALL CONFORM TO THE 2018 EDITION OF THE NC STATE BUILDING CODE. CODES GOVERN OVER DRAWINGS. DIMENSIONS GOVERN OVER SCALE. VERIFY ALL MECHANICAL REQUIREMENTS BEFORE FRAMING.

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# GENERAL FOUNDATION NOTES:


- 1. THIS PLAN DESIGNED IN ACCORDANCE WITH NC RESIDENTIAL CODE, 2018 EDITION.
- 2. EXTERIOR WALL FOOTING WHERE NOTED TO BE 16" X 10" 3000 PSI STRUCTURAL CONCRETE UNLESS OTHERWISE NOTED. CONCRETE TO BE PREPARED AND PLACED IN ACCORDANCE WITH ACI 318. FOR FOUNDATION WALL HEIGHT, THICKNESS AND BACKFILL REQUIREMENTS, REFER TO STATE AND LOCAL BUILDING CODES. NOTE: ASSUMED SOIL BEARING CAPACITY=2000 PSF. CONTRACTOR MUST VERIFY CONDITIONS AND CONTACT SOIL ENGINEER IF MARGINAL OR UNSTABLE SOILS ARE ENCOUNTERED.
- 3. FOOTINGS TO BEAR ON UNDISTURBED EARTH A MIN. OF 12" BELOW ADJACENT FINISH GRADE OR AS OTHERWISE DIRECTED BY LOCAL
- 4. FOUNDATION DRAINAGE SHALL BE IN ACCORDANCE WITH SECTION R405 OF THE CODE "FOUNDATION DRAINAGE".
- 5. THE FOUNDATION SHALL BE TREATED IN ACCORDANCE W/SECTION R406 OF THE CODE "FOUNDATION WATERPROOFING AND DAMPPROOFING".
- 6. THIS FOUNDATION DESIGN IS VALID FOR 115 MPH WIND ZONES ONLY. 7. FOUNDATION WALLS SHALL BE 8" BLOCK UNLESS NOTED
- OTHERWISE. 8. (2) \*4 BARS IN FOOTINGS RUN CONTINUOUSLY.


INDICATES POINT LOAD ABOVE

# STRUCTURAL EVALUATION BY:
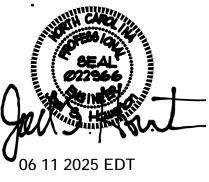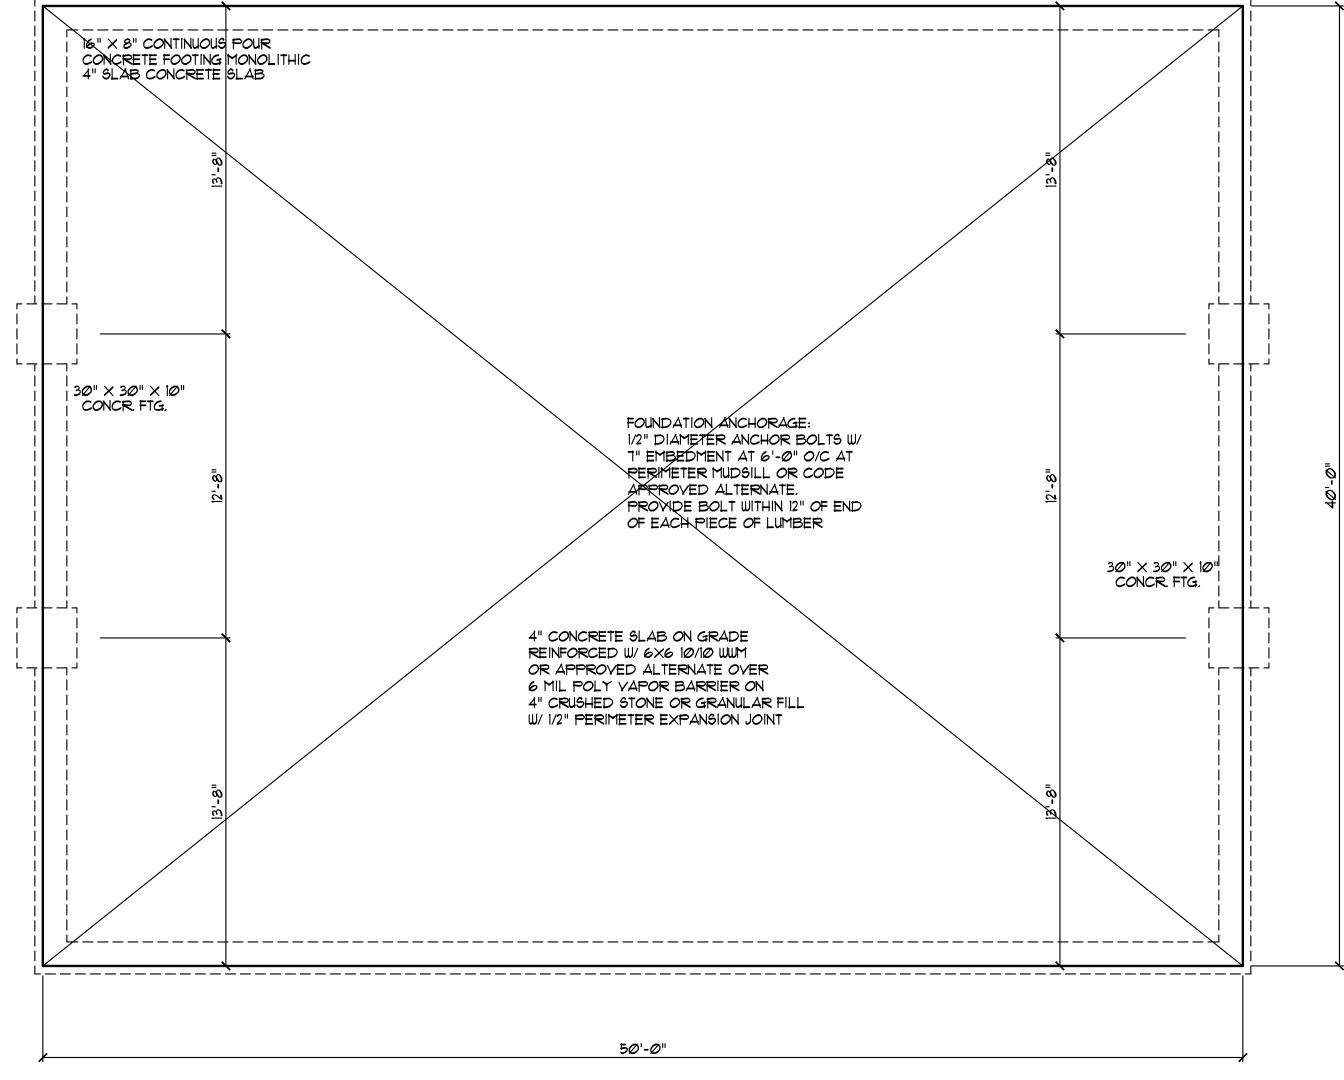
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FOUNDATION PLAN SCALE: 1/4" = 1'-0"

DRAWN BY : WRY CHK'D BY : WRY DATE: Ø6/12/25 REVISIONS :