THIS PLAN HAS BEEN DRAWN TO CONFORM TO THE 2018 NORTH CAROLINA RESIDENTIAL CODE

CONTRACTOR SHALL VERIFY ALL DIMENSIONS AND CONDITIONS PRIOR TO BEGGINING WORK. CONTRACTOR IS RESPONSIBLE FOR COMPLIANCE WITH ALL STATE AND LOCAL BUILDING CODES AND ORDINANCES. KADS CUSTOM HOME DESIGNS ASSUMES NO LIABILITY FOR SITE CONDITIONS, CONSTRUCTION METHODS OR ANY DEVIATION OF THESE PLANS.


NOTE:


ALL WINDOWS TO BE INSTALLED MUST MEET A MAXIMUM OF .32 U VALUE OR BETTER, UNLESS ENERGY CALCULATIONS ARE SUBMITTED WITH PLANS PROVIDED BY BUILDER AT TIME OF PLAN REVIEW.

SIDING AS SPEC. SIDING AS SPEC. TRIM TYP. SIDING AS SPEC. SIGN X A* TRIM TYP. SIDING AS SPEC. SIDING AS S


FRONT ELEVATION

SCALE: 1/4"=1'-0"

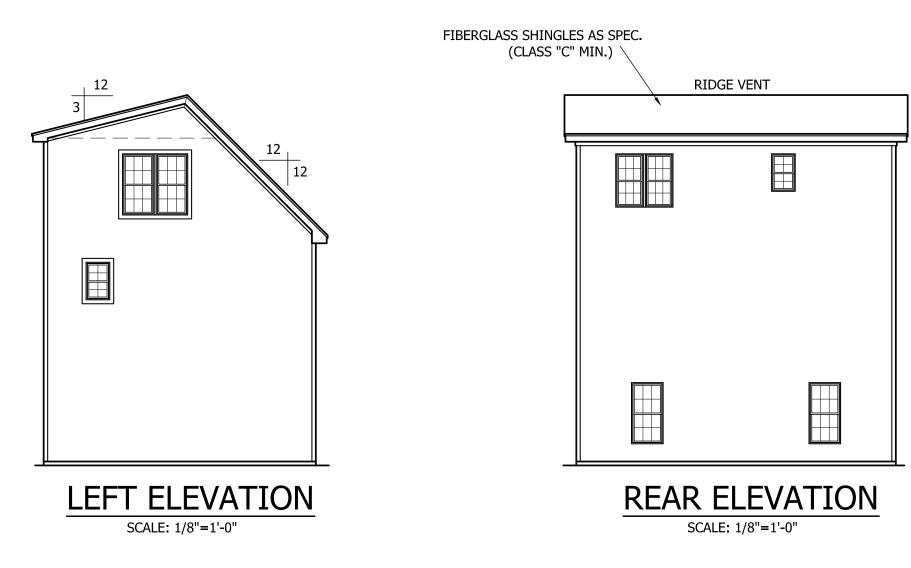

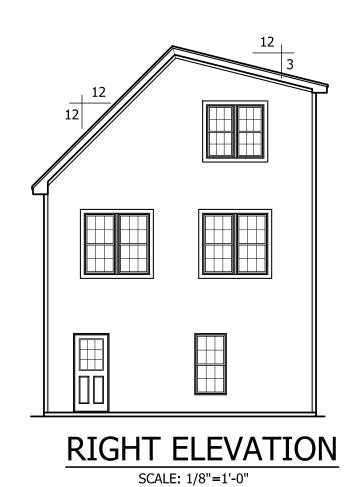

DINH TRAN KFITH HILLS

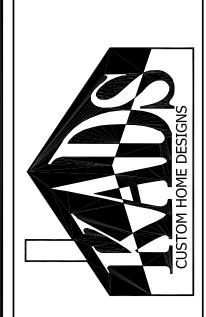

ANGIER, NC 919-369-7181

DRAWN BY:

D.W.O.

DATE:


5/19/25

PAGE NO

OF

2

3

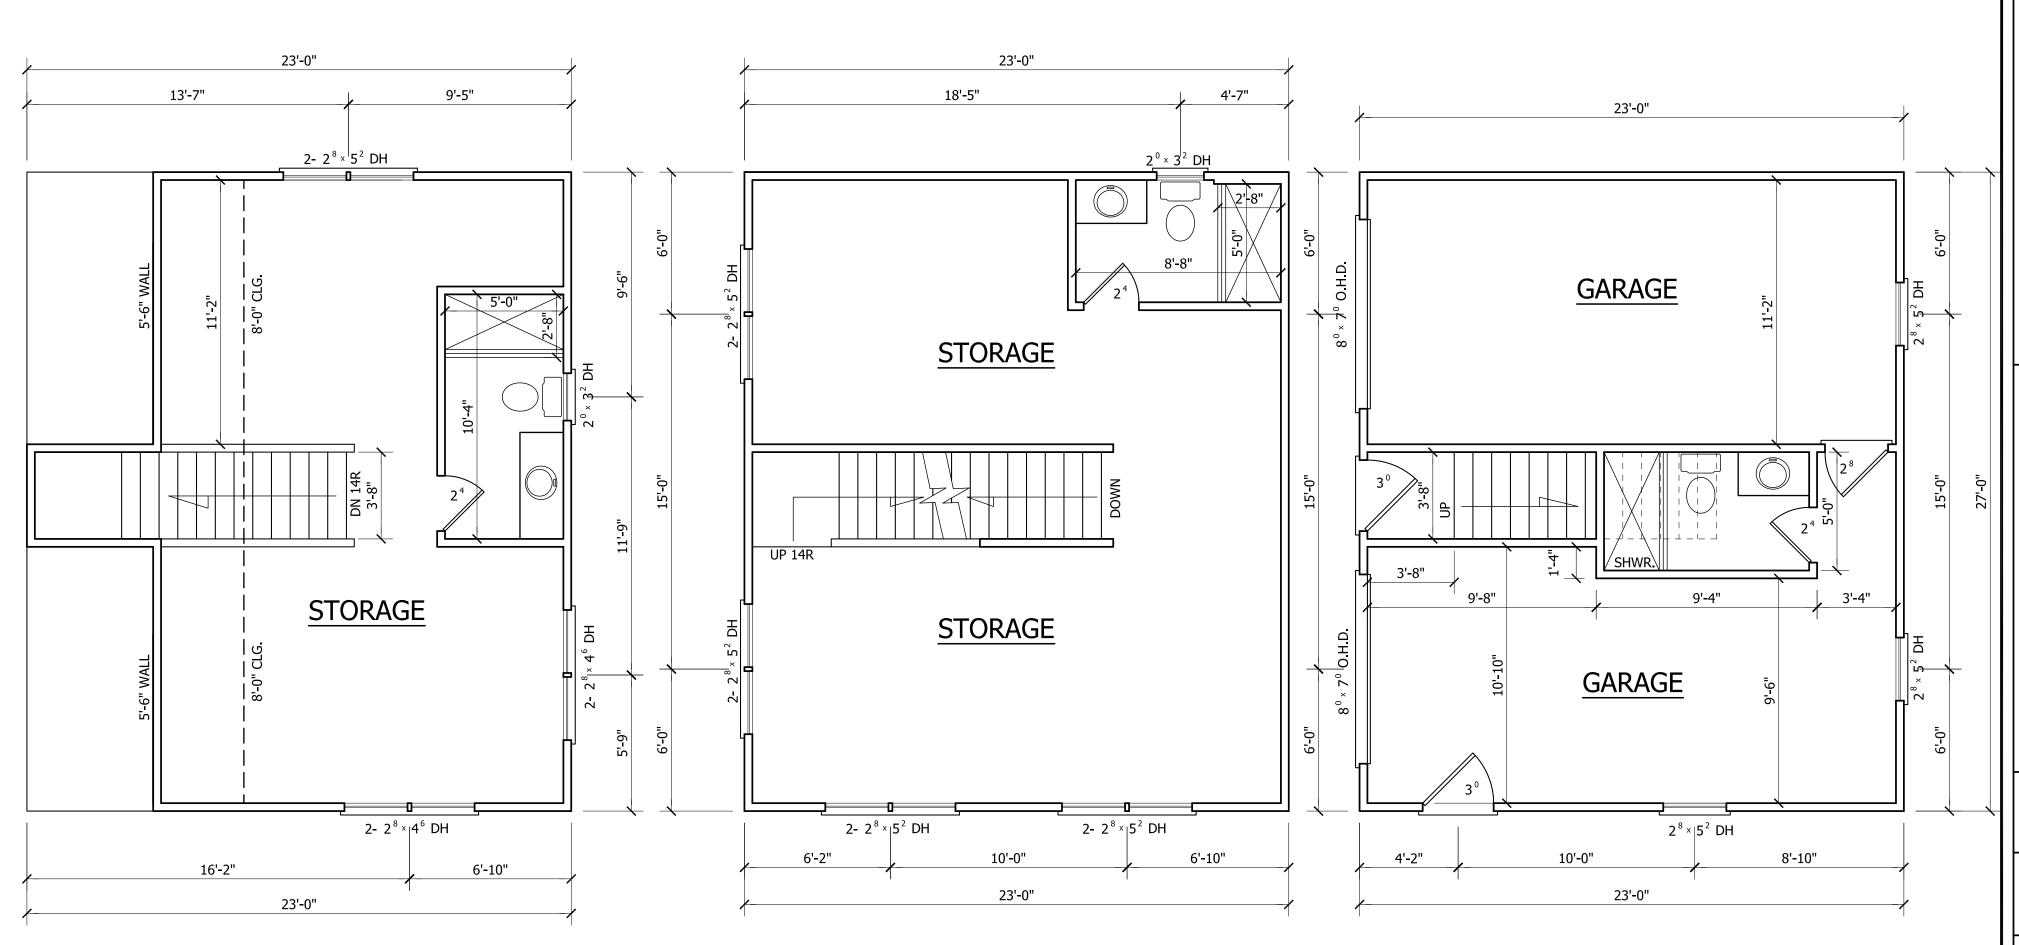

DINH TRAN KEITH HILLS



ANGIER, NC 919-369-7181

DRAWN BY:

<u>D.W.O.</u>

DATE:

5/19/25

PAGE NO

2

OF

3

SECOND FLOOR PLAN

SCALE: 1/4"=1'-0" 8'-0" CLG. HGT. SET WINDOWS AT 6'-8" A.F.F.

THIRD FLOOR PLAN


SCALE: 1/4"=1'-0" 8'-0" CLG. HGT.

SET WINDOWS AT 6'-8" A.F.F.

FIRST FLOOR SQ. FT. = 621 SECOND FLOOR SQ. FT. = 621 THIRD FLOOR SQ. FT. = 477 TOTAL SQ. FT. = 1719 FIRST FLOOR PLAN


SCALE: 1/4"=1'-0" 9'-0" CLG. HGT.

SET WINDOWS AT 6'-8" A.F.F.

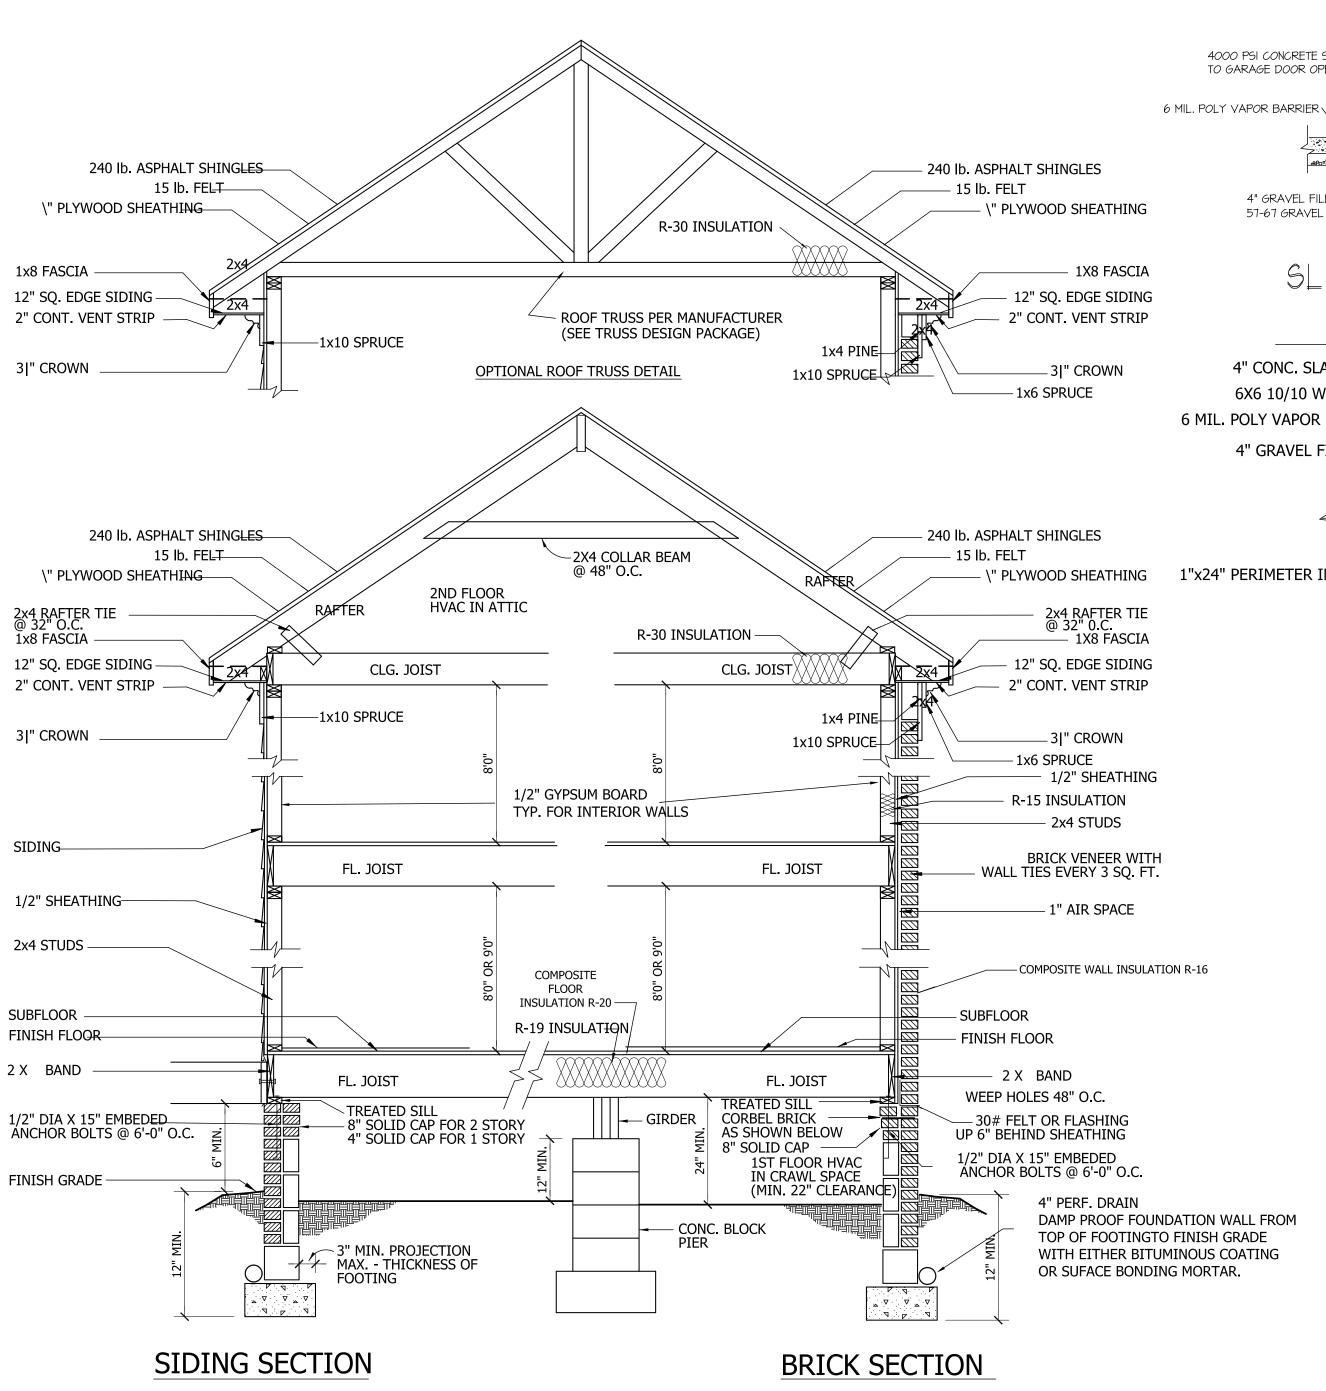


WALL SECTION

SCALE: \" = 1'-0"

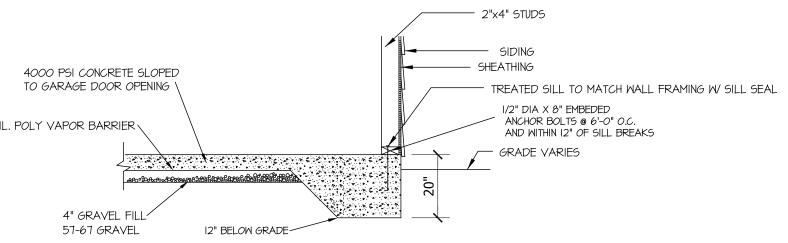


SLAB FDN. DETAIL

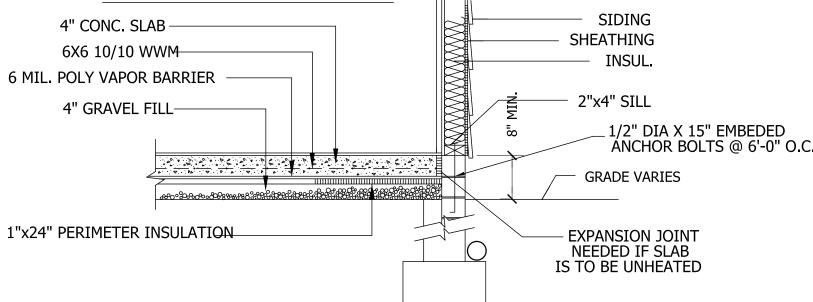

SLAB FDN. DETAIL

SCALE: 1'' = 1'-0''

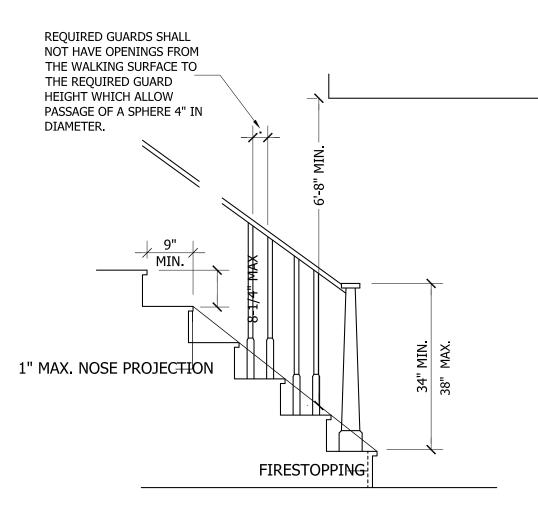


NOTE

Stairways shall not be less than 36 inches in clear width at all points above the permitted handrail height and below the required headroom height. Handrails shall not project more than 4.5 inches on either side of the stairway and the minimum clear width of the stairway at and below the handrail height, including treads and landings, shall not be less than 31-1/2 inches where a handrail is installed on one side and 27 inches where handrails are provided on both sides

STAIR DETAIL

SCALE: NTS

DINH TRAN KEITH HILLS

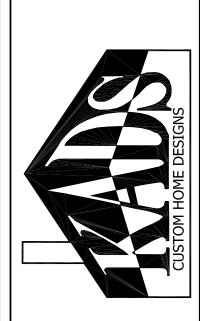

ANGIER, NC 919-369-7181

DRAWN BY:

D.W.O.

DATE:

5/19/25

PAGE NO

3

OF

3

ROOF VENTILATING REQUIREMENTS


= <u>4.14</u> SQ. FT. REQ'D


ROOF VENTILATING REQUIREMENTS


(POWER ROOF VENTILATOR REQUIRED)

= <u>2.07</u> SQ. FT. REQ'D

BUILDER TO PROVIDE APPROPRIATE VENTILATING AS REQUIRED.

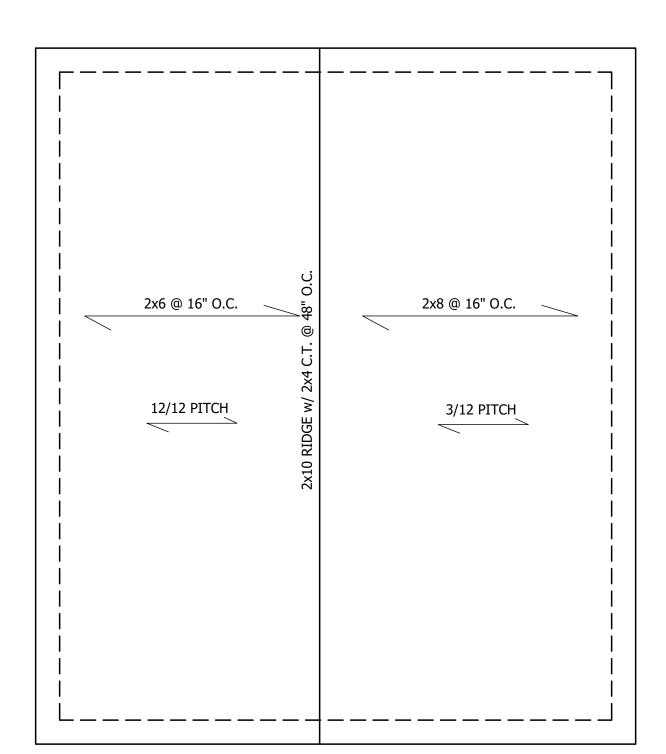

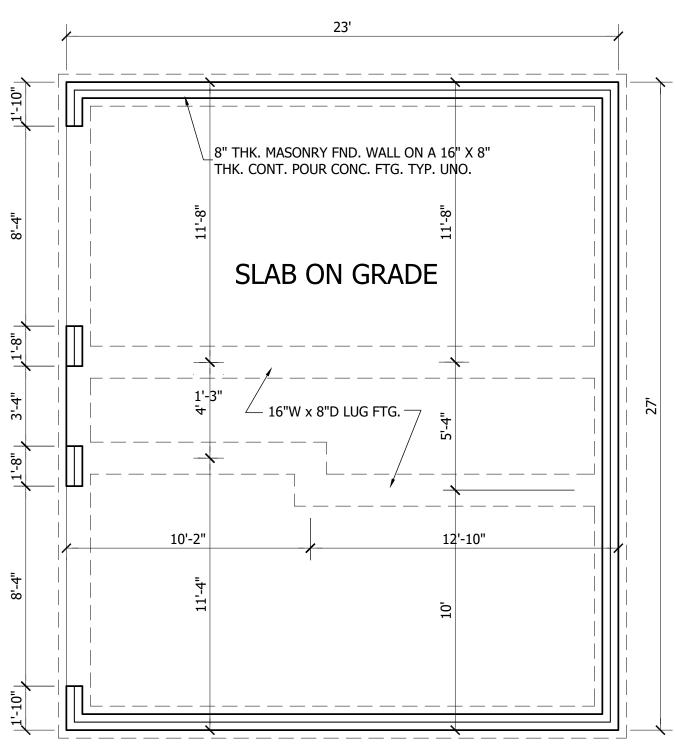

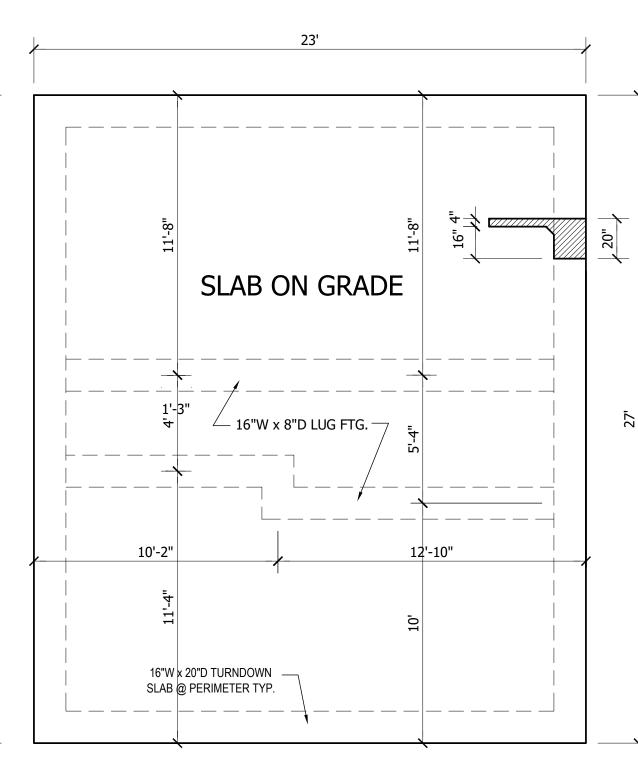


ROOF PLAN SCALE: 1/4"=1'-0"

STEM WALL SLAB PLAN

SCALE: 1/4"=1'-0"

MONOLITHIC SLAB PLAN


SCALE: 1/4"=1'-0"

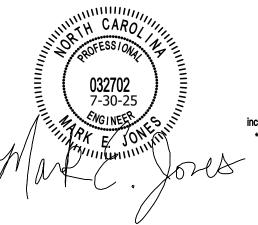

Structural Engineering by: Mark E. Jones, PE 6425 Glen Dean Court Raleigh, NC 27603 Phone: (919) 395-5618

*Engineers seal applies only to structural components on this document. Seal does not include construction means, methods, techniques, sequences, procures or safety precautions. *Any deviations or discrepancies on plans are to be brought to the immediate attention of Mark E. Jones, PE. Failure to do so will void Mark E. Jones, PE liability. Structural analysis based on NCResidential Building Code 2018.

Project No. 25-151

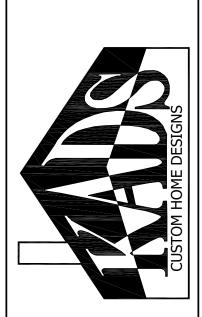

ANGIER, NC 919-369-7181

DRAWN BY:


D.W.O.


DATE: 5/19/25

PAGE NO

STRUCTURAL NOTES 1) ALL CONSTRUCTION SHALL CONFORM TO THE LATEST REQUIREMENTS OF "NORTH CAROLINA STATE 2018 RESIDENTIAL BUILDING CODE", IN ADDITION TO ALL LOCAL CODES AND REGULATIONS. 2) DESIGN LOADS:


	LIVE LOAD (PSF)	DEAD LOAD (PSF)	DEFLECTION (DL & LL)
ALL FLOORS	40	10	L/360
ATTIC (pull down access)	20	10	L/240
ATTIC (no access)	10	5	L/240
EXTERNAL BALCONY	60	10	L/360
ROOF	20	10	L/180
ROOF TRUSS	20	20	L/240
WIND LOAD	[BASED ON 120 MPH (3-second gusts)]		

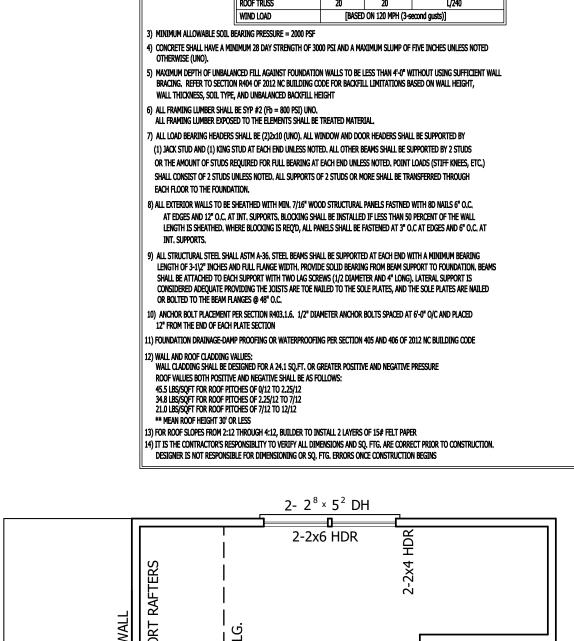

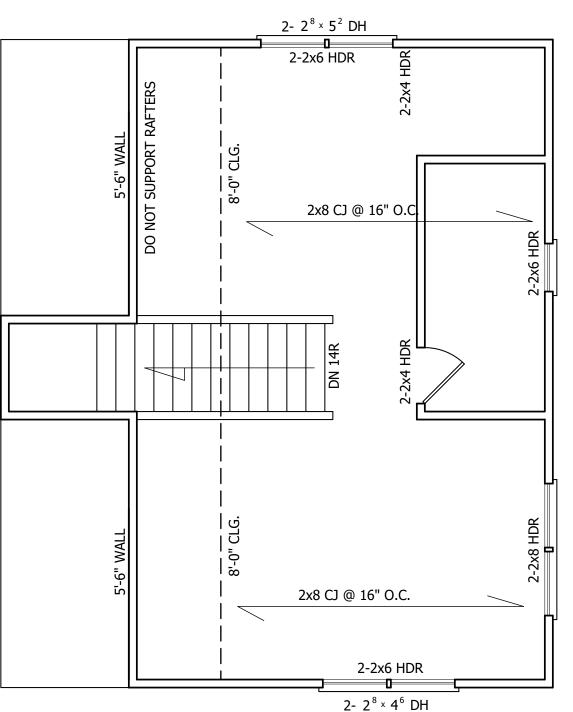


THIRD FLOOR PLAN

SCALE: 1/4"=1'-0" 8'-0" CLG. HGT. SET WINDOWS AT 6'-8" A.F.F.

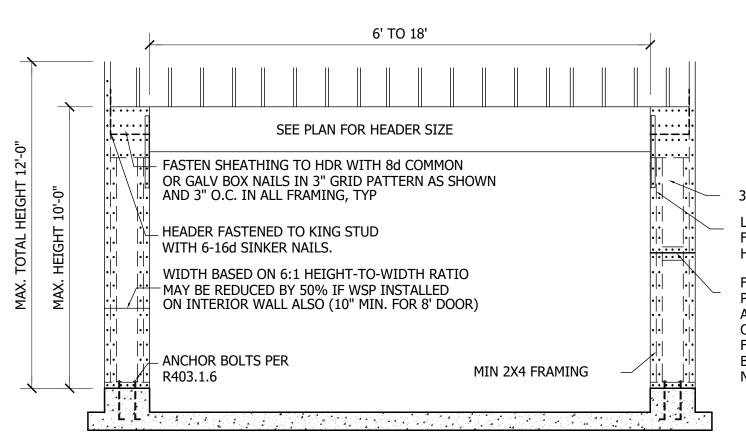

PORTAL FRAME DETAIL

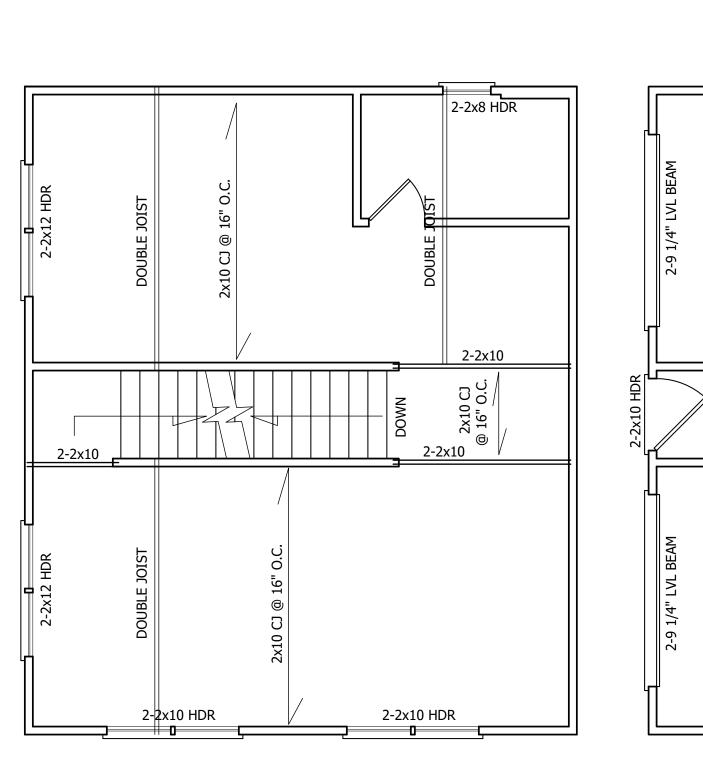

SECOND FLOOR PLAN

SCALE: 1/4"=1'-0" 8'-0" CLG. HGT. SET WINDOWS AT 6'-8" A.F.F.

FIRST FLOOR PLAN SCALE: 1/4"=1'-0" Structural Engineering by:

9'-0" CLG. HGT. SET WINDOWS AT 6'-8" A.F.F.

2-2x8 HDR

*Engineers seal applies only to structural components on this document. Seal does not include construction means, methods, techniques, sequences, procures or safety precautions. *Any deviations or discrepancies on plans are to be brought to the immediate attention of Mark E. Jones, PE. Failure to do so will void Mark E. Jones, PE liability. Structural analysis based on NCResidential Building Code 2018.

Mark E. Jones, PE

6425 Glen Dean Court Raleigh, NC 27603 Phone: (919) 395-5618


Project No. 25-151

2-2x8 HDR

3/8" MIN THK STRUCTURAL SHEATHING LSTA-24 STRAPS (INSIDE AND OUTSIDE) AT FIRST JACK, CENTERED AT BOTTOM OF HEADER, BOTH SIDES OF OPENING FOR A PANEL SPLICE (IF NEEDED), PANEL EDGES SHALL BE BLOCKED, AND OCCUR WITHIN 24" OF MID-HEIGHT. ONE ROW OF TYP SHEATHING-TO-FRAMING NAILING IS REQD IF 2X4 BLOCKING IS USED, THE 2X4's MUST BE NAILED TOGETHER WITH 3-16d SINKERS

2-2x10 HDR

2-2x10

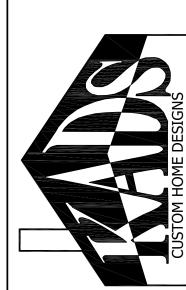

919-369-7181

DRAWN BY: D.W.O.

DATE:

PAGE NO

5/19/25

