

NOTES:

- NOMINATED CONTRACTOR SHALL CHECK AND VERIFY ALL HEIGHTS, LEVELS AND DIMENSIONS ON SITE PRIOR TO COMMENCING CONSTRUCTION.
- 2. NOMINATED CONTRACTOR TO CHECK AND LOCATE ALL EXISTING PUBLIC DRAINS AND SERVICES ON SITE PRIOR TO CONSTRUCTION.
- 3. THIS DRAWING SHALL BE READ IN CONJUNCTION WITH PROJECT SPECIFICATIONS AND ALL RELEVANT DOCUMENTS.
- 4. CONTRACTOR SHALL NOT SCALE OFF DRAWINGS.
- REFER TO STRUCTURAL ENGINEERS DRAWINGS FOR ALL STRUCTURAL MEMBER. REGISTERED ENGINEERS DRAWINGS AND SPECIFICATIONS OVERRIDE ALL DESIGN.
- 6. CONTRACTOR TO CONFIRM ON SITE. IN THE EVENT THAT ANY UNSTABLE OF SOFT GROUND IS ENCOUNTERED A REGISTERED ENGINEER MUST BE CONTACTED FOR FURTHER DIRECTIONS.
- 7. IF NOMINATED CONTRACTOR ENCOUNTERS ANY DISCREPANCIES IN THESE DRAWINGS, MACPHERSON ARCHITECTURE LTD. MUST BE CONTACTED BEFORE PROCEEDING.
- 8. NOMINATED CONTRACTOR SHALL SUPPLY AND FIX ALL NECESSARY FLASHINGS AND SEALANTS ACCORDING TO ROOFING STANDARDS TO PROVIDE A COMPLETE WEATHER- TIGHT BUILDING.
- 9. IT IS THE RESPONSIBILITY OF THE MAIN CONTRACTOR TO ADVISE ARCHITECTURE OF ANY CHANGES THAT OCCUR OR THAT VARY FROM PLANS.
- 10. ALL STRUCTURAL TIMBER TO BE A+GRADE

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Designer:	
LBP no.:	
Drawn:	
Scale:	
Date:	03 DEC 2024

Project:


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Title:

EXISTING AND PROPOSED FLOOR PLAN

Sheet

A-1.1

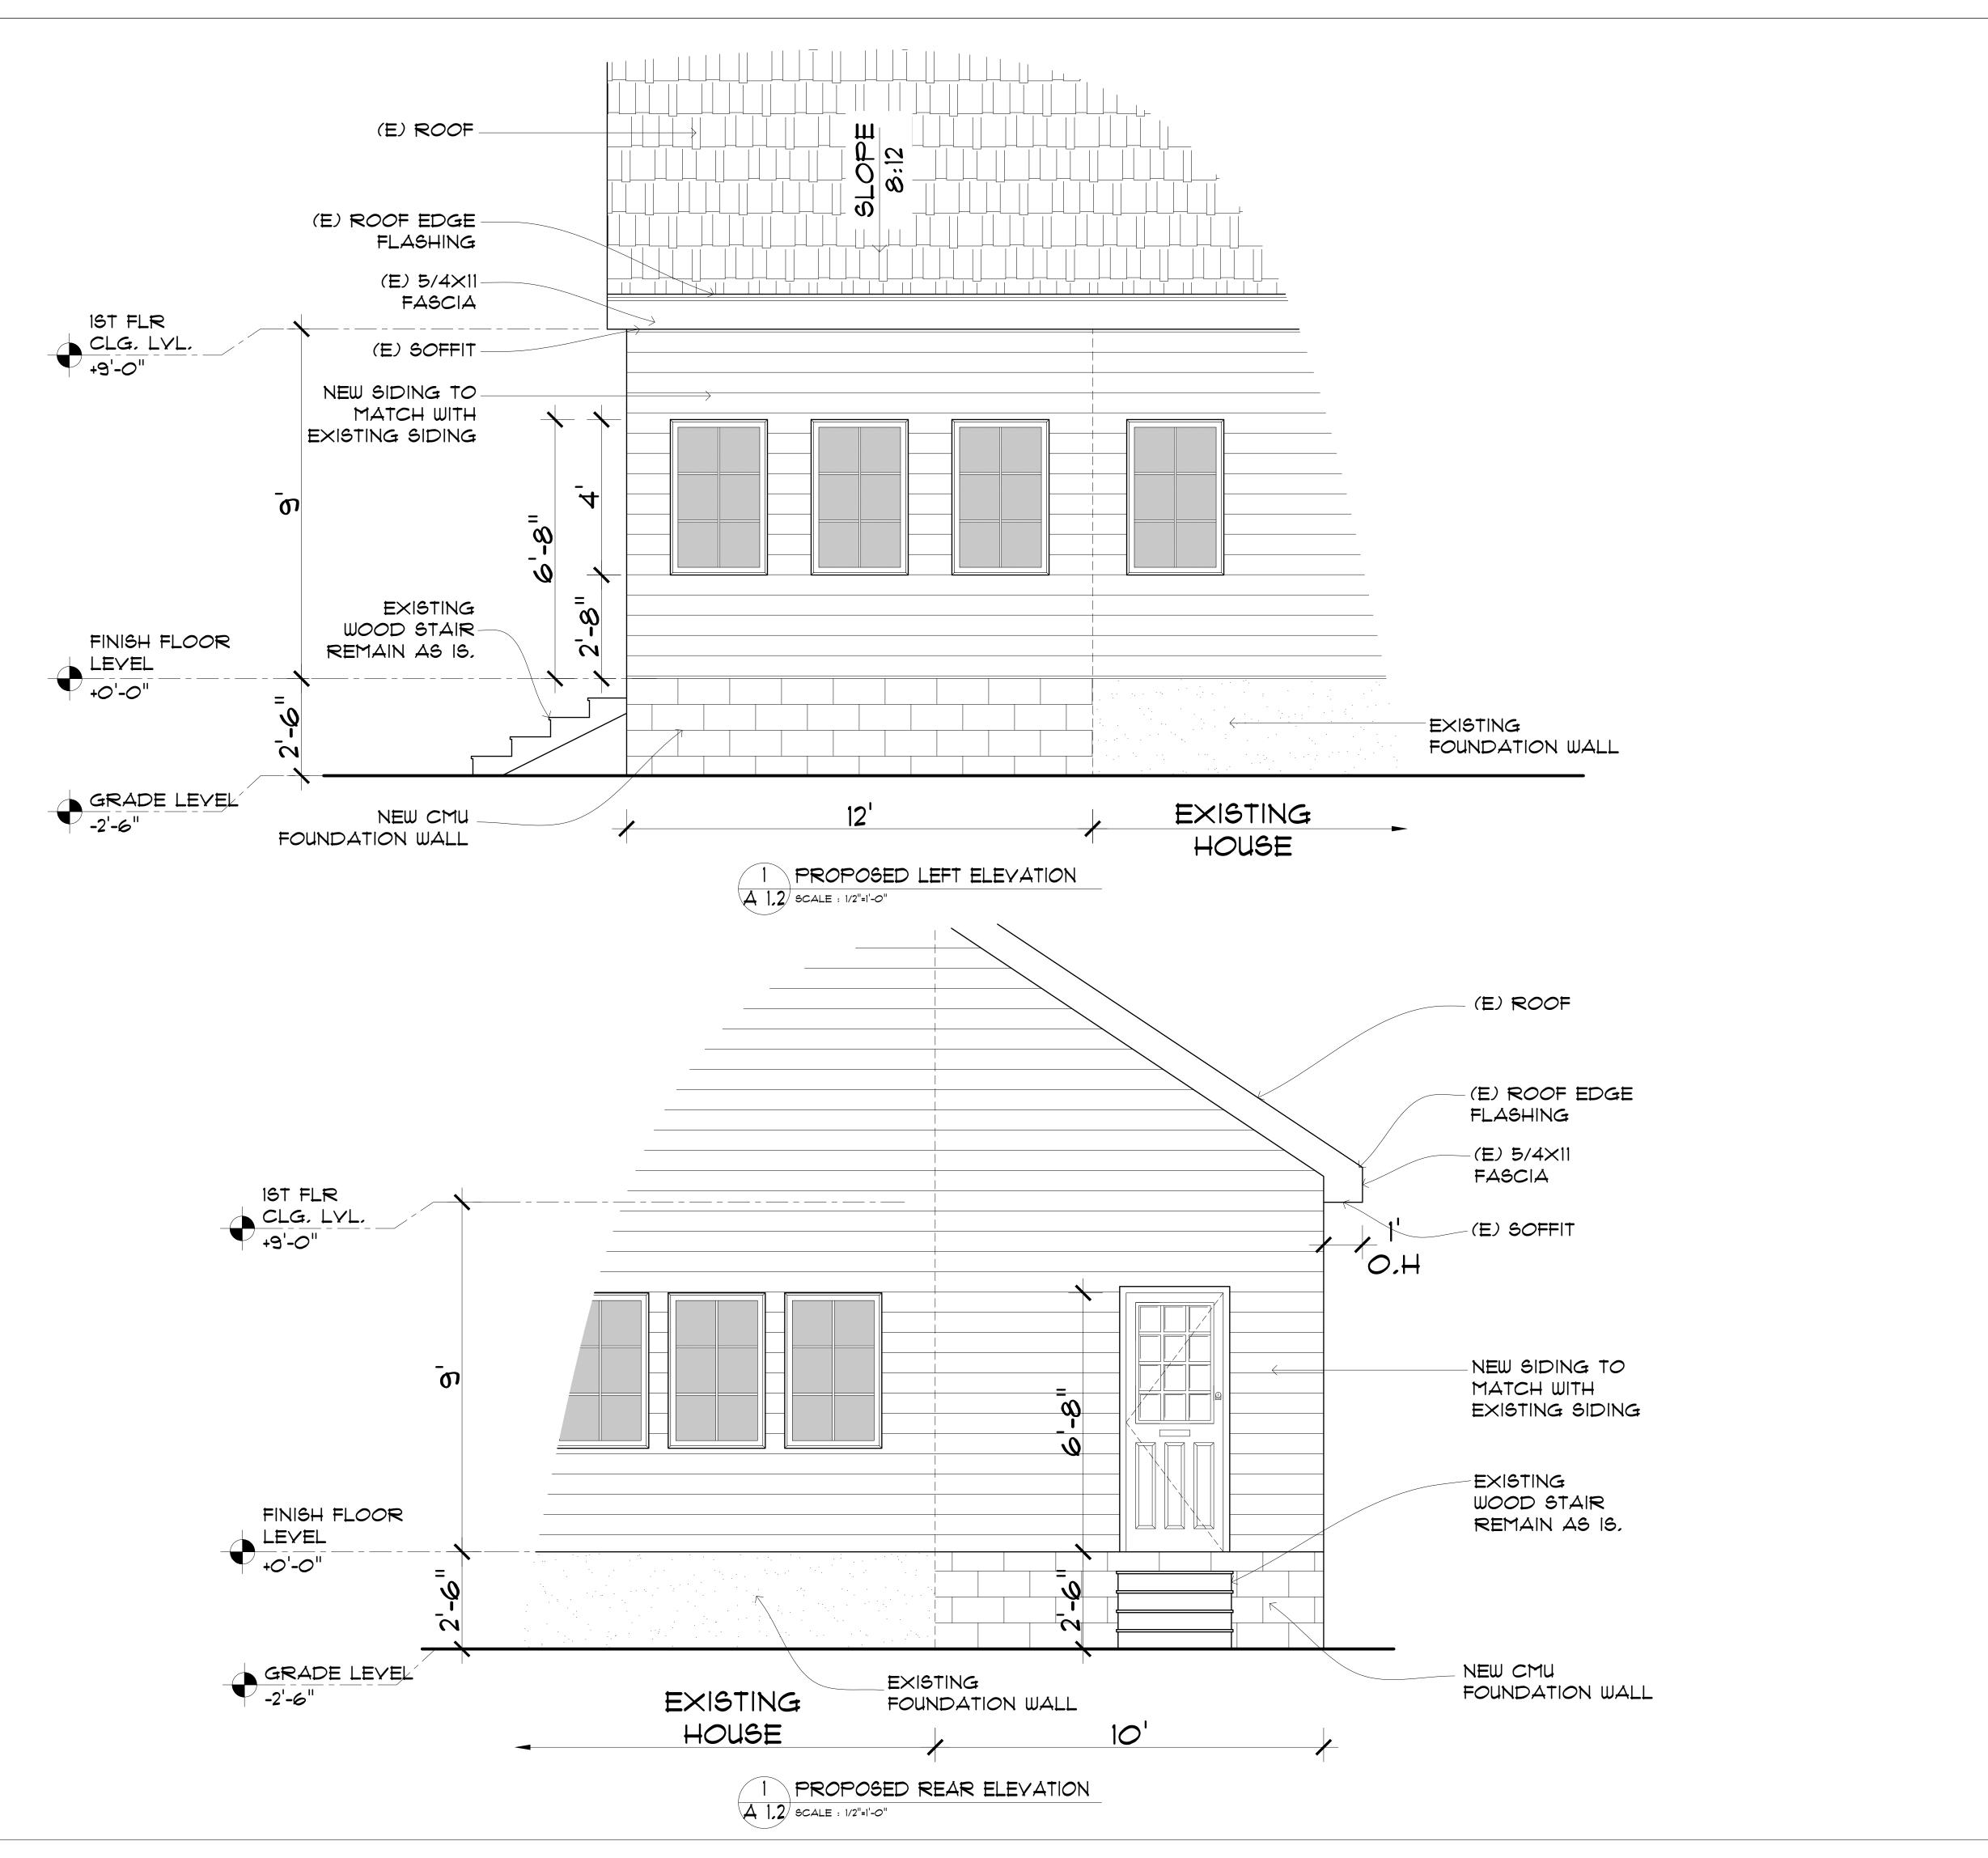

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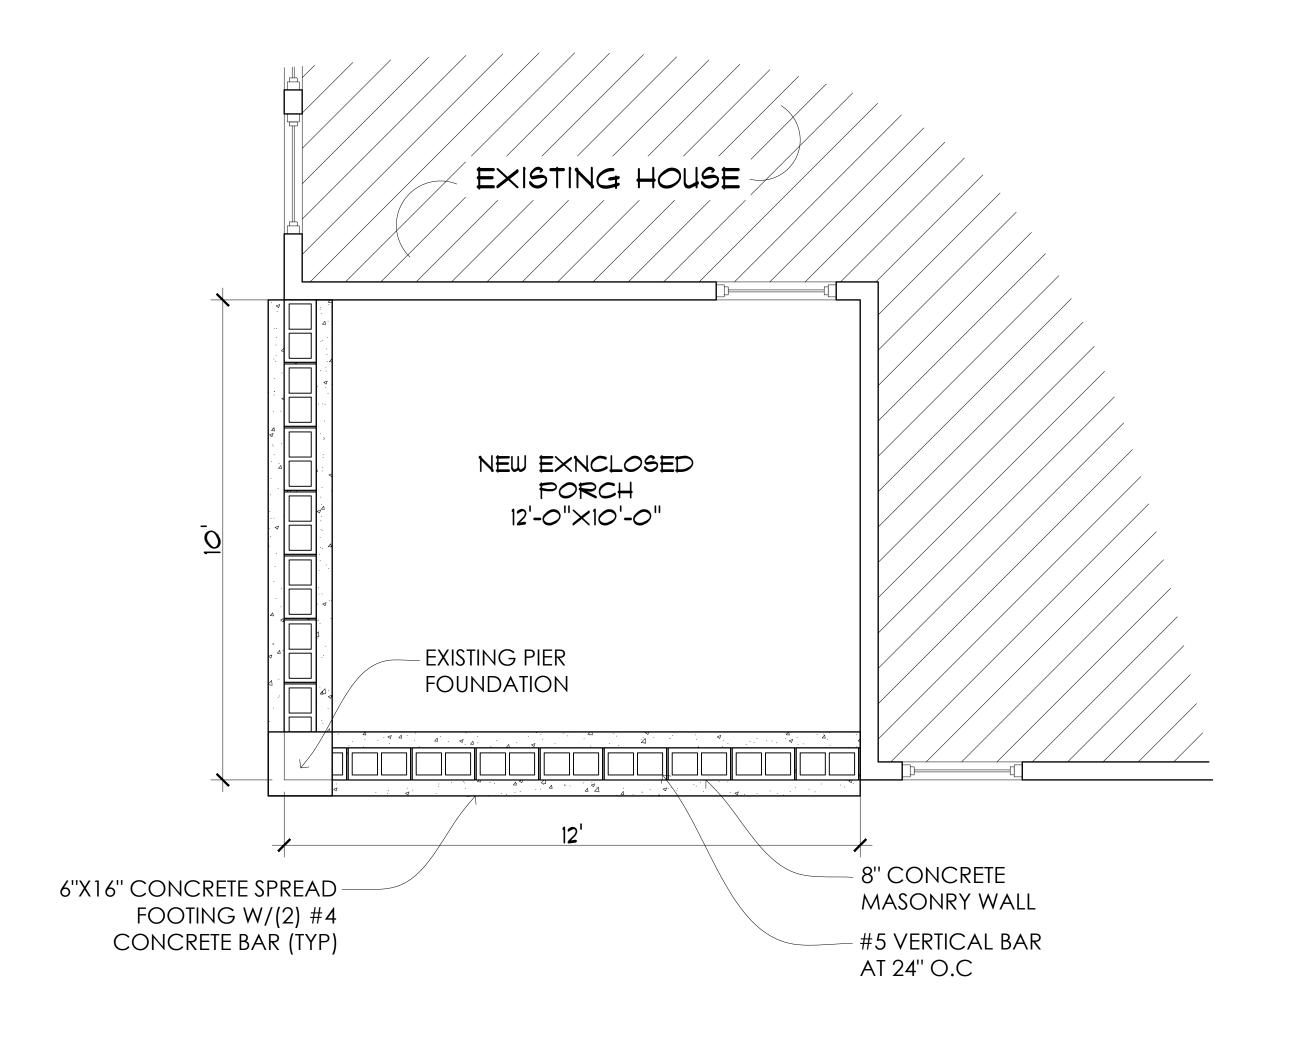
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PROPOSED ELEVATION

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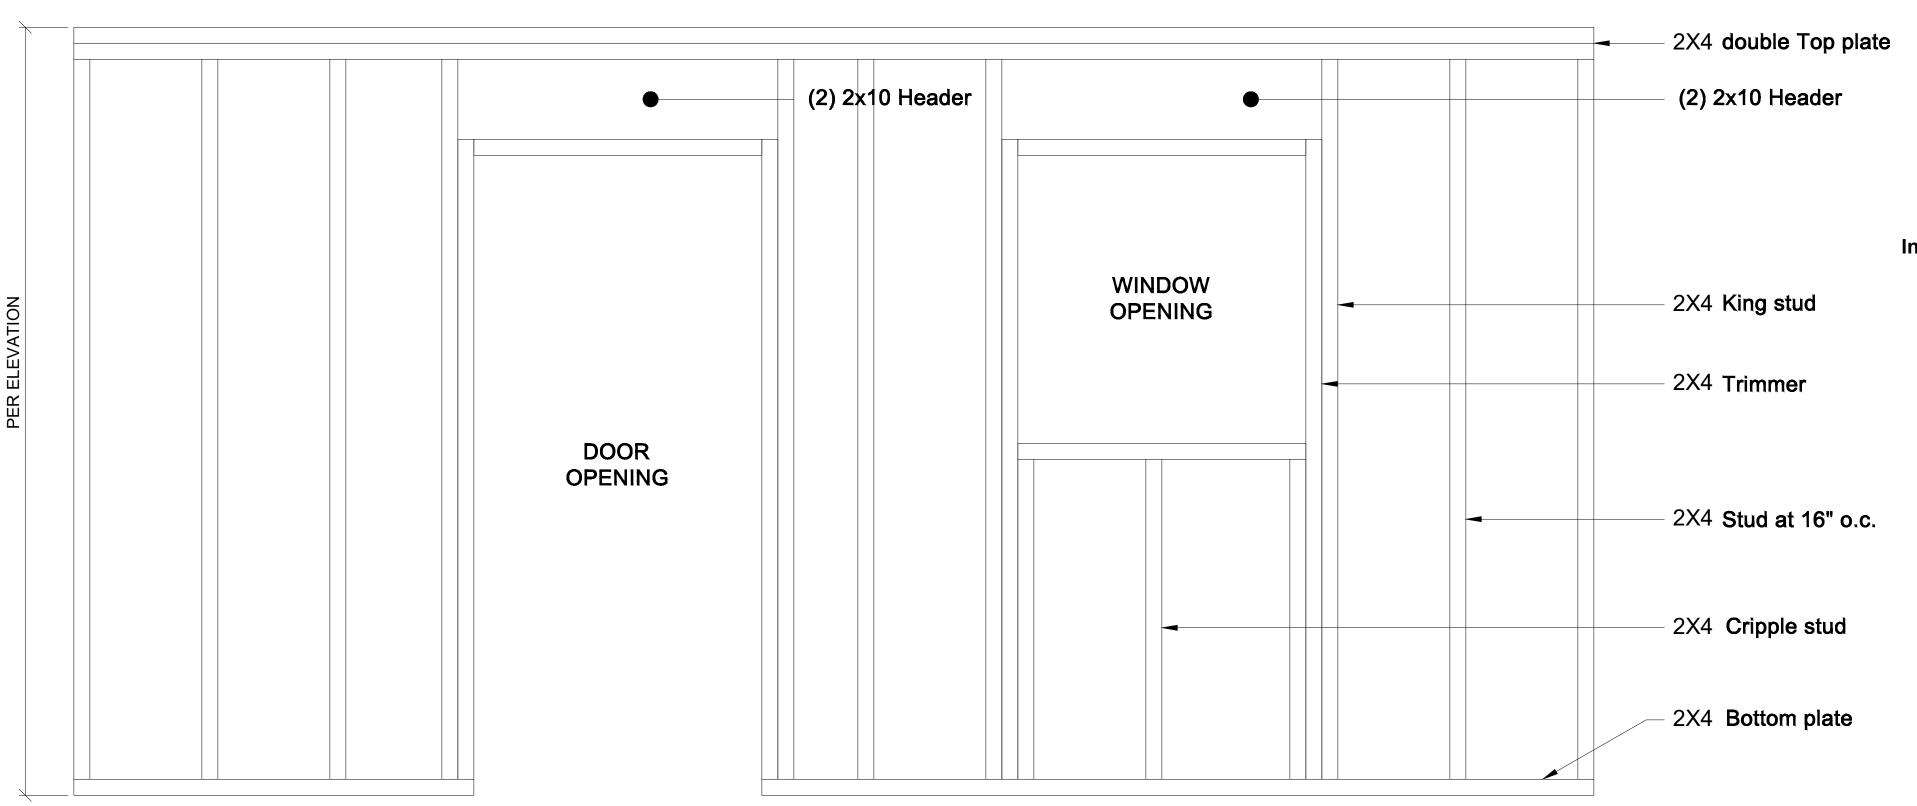
Existing stud wall and siding at ledger to be demolished/removed prior to installation Stagger 1/2"x5" lag screws at 8" o.c. in 2x Rim board (6) #9x1½" Face Fasteners (6) #9x1½" **Joist Fasteners EXISTING JOIST** Simpson strong-tie Joist Hanger Model LU28 2X10 PRESSURE foundation wall TREATED LEDGER

2 CONNECTION OF FLOOR LEDGER TO
A-2.1 THE HOUSE FLOOR BAND JOIST
SCALE: NTS

2X4 STRUCTURE

1 PROPOSED FOUNDATION PLAN

A 2.1 SCALE : 1/2"=1'-0"



STUD AT 16" O.C W/R19 INSULATION 1/2"x10" J-Bolt at 12" o.c. 3in²x3/16" thick washers 2X4 BOTTOM **PLATE Concrete Masonry EXISTING** Units filled solid **SHEATHING** with grout x8 floor joist t 16" o.c. w/ **Insulation R-38 #5 VERTICAL** BAR @ 24" O.C 6-MIL POLY VAPOR **BARRIER TO CONTROL GROUND MOISTURE** Mortar 3/4" Stone surround Type S 4" drain pipe 8" Concrete Masonry Wall w/ #5 Vertical bar at 24" o.c. 6"x16" Concrete spread footing w/ (2) #4 cont. bar

DETAILED WALL SECTIONS

SCALE: NTS

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FOUNDATION PLAN AND DETAILS

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A-2.1

TYPICAL WALL FRAMING DETAIL

SCALE: NTS