
PROPOSED ADDITION FOR MORRIS-EYE RESIDENCE

369 KINSMAN CT. FUQUAY VARINA, NC 27526

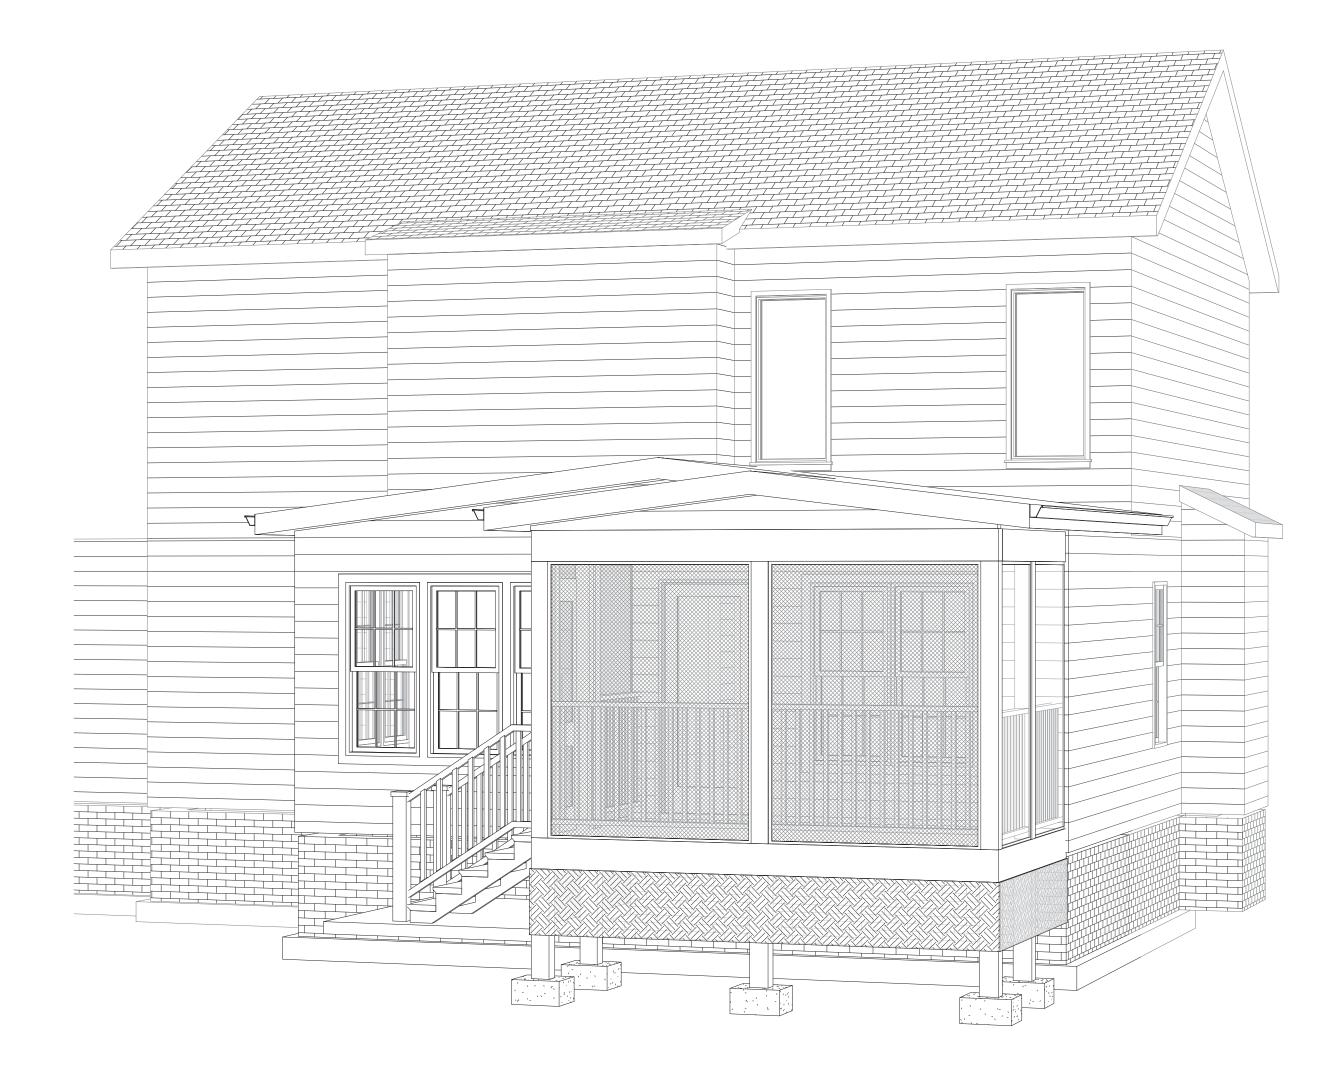

INDEX OF DRAWINGS

SHEET NUMBER	SHEET NAME	ISSUE DATE	REVISION
C0	Cover Sheet	08/28/2024	
C1	Rough Site Plan	08/28/2024	
A1	Foundation Plan, Framing Plan	08/28/2024	
A2	Floor Plan, Demo Plan, Wall Section	08/28/2024	
A3	Elevations, Roof Plan	08/28/2024	

AREA TABULATION				
FIRST FLOOR				
HEATED -	216 SF			
UNHEATED -	115 SF			
SECOND FLOOR				
HEATED -	N/A			
GARAGE				
UNHEATED -	N/A			
SUITE				
HEATED -	N/A			
MEAN ROOF HEIGHT				
HEIGHT -	19' - 11"			
TOTAL				
NEW ADDITION HEATED -	216 SQUARE FEET			
NEW ADDITION UNHEATED -	115 SQUARE FEET			
* AREA IS MEASURED TO	O INSIDE OF STUDS.			

GENERAL NOTES

- ALL WORK SHALL BE PERFORMED IN ACCORDANCE WITH 2018 NC IRC CODE.
- THE DOCUMENTS REFLECT CONDITIONS REASONABLY INTERPRETED FROM THE EXISTING VISIBLE CONDITIONS, OR FROM DRAWINGS, OR INFORMATION FURNISHED BY THE OVERTICAL CONTRACTOR SHALL VISIT THE SITE AND EXAMINE CONDITIONS OF THE PREMISES AND THE CHARACTER AND EXTENT OF WORK REQUIRED PRIOR THE USE OF THE WORDS "PROVIDE" OR "PROVIDED" IN CONNECTION WITH ANY ITEM SPECIFIED, IS INTENDED TO MEAN, UNLESS OTHERWISE NOTED, THAT SUCH
- SHALL BE FURNISHED AND INSTALLED, AND CONNECTED WHTERE SO REQ'D BY GC. ALL MATERIALS AND INFORMATION NOTED ON ANY OF THE SECTIONS OR DETAILS APPLY TO ALL OTHER SECTIONS AND DETAILS WHERE SIMILAR CONDITIONS OCCUR ALL INTERIOR DIMENSIONS ARE FROM WALL STUD TO WALL STUD & TO CENTERLINE OF OPENING, U.NO. ALL DIMENSIONS REFERENCED HEREIN ARE IMPERIAL
- STANDARD, U.N.O. ALL EXTERIOR DIMENSIONS ARE FROM FACE OF STUD, FACE OF CONCRETE, FACE OF CMU., OR TO CENTERLINE OF OPENING, U.N.O.
- EXTERIOR DOORS AND WINDOWS ARE DIMENSIONED TO CENTERLINE. WALL ANGLES ARE PARALLEL, PERPENDICULAR OR 45 DEGREE ANGLES TO BUILDING PERIMETER UNLESS NOTED OTHERWISE. FOOTINGS, FOUNDATION WALLS, SUPPORT COLUMNS AND/OR PIERS ARE TO BE CONSTRUCTED TO LOCAL CODE AND SOIL REQUIREMENTS. CONTRACTOR TO
- PROVIDE STRUCUTRAL AND SOIL INFORMATION IF REQUIRED BY LOCAL CODES. FOOTINGS, FOUNDATION WALLS, SUPPORT COLUMNS AND/OR PIERS SHALL BE STEPPED IN ACCORDANCE WITH SITE SPECIFIC CONDITIONS AND LOCAL CODE REQUIREMENTS.
- CONTRACTOR TO VERIFY ALL DIMENSIONS AND LOADS PRIOR TO CONSTRUCTION. PENETRATIONS THROUGH THE FOUNDATION OR PERIMETER FLOOR FRAMING OF THE BUILDING, FOR INSTALLATIONS OF PIPES, VENTS, ETC. SHALL BE IN ACCORDANCE WITH LOCAL REQUIREMENTS.
- DO NOT SCALE DIMENSIONS FROM PRINTS. USE DIMENSIONS GIVEN OR CONSULT DESIGNER FOR FURTHER CLARIFICATION.
- ALL POSTS AND EXTERIOR FRAMING TO BE MININUM #2 GRADE, PRESSURE TREATED WOOD. EXTERIOR WALLS TO BE BRACED PER TABLE R602.10.1 OF THE NC IRC BUILDING CODE.
- ALL NOMINAL LUMBER TO BE #2 SOUTHERN YELLOW PINE OR EQUIVALENT AND ALL LUMBER IN CONTACT WITH GRADE, EXPOSED, OR CONCRETE SLAB TO BE
- PROVIDE SUPPLEMENTAL FRAMING, METAL BLOCKING / STRAPPING AND BRACING AS REQ'D FOR SUPPORT OF FIXTURES, EQUIPMENT, TOILET ACCESSORIES, FURNISHINGS, FURNITURE / EQUIPMENT, AND SIMILAR CONSTRUCTION.

AREA TABL	JLATION
FIRST FLOOR	
HEATED -	216 SF
UNHEATED - SECOND FLOOR	115 SF
HEATED - GARAGE	N/A
UNHEATED - SUITE	N/A
HEATED -	N/A
MEAN ROOF HEIGHT HEIGHT -	19' - 11"
TOTAL	
NEW ADDITION HEATED -	216 SQUARE FEET
NEW ADDITION UNHEATED -	115 SQUARE FEET
* AREA IS MEASURED TO) INSIDE OF STUDS.


08/28/2024

Scale:

Project Number:

AS NOTED

Carolina East Designs 2024 24 x 36 This document, and the information contained herein, are the sole property of Carolina East Designs. Any use or modification of this document, in whole or in part, without the written approval of Carolina East Designs, is strictly prohibited.

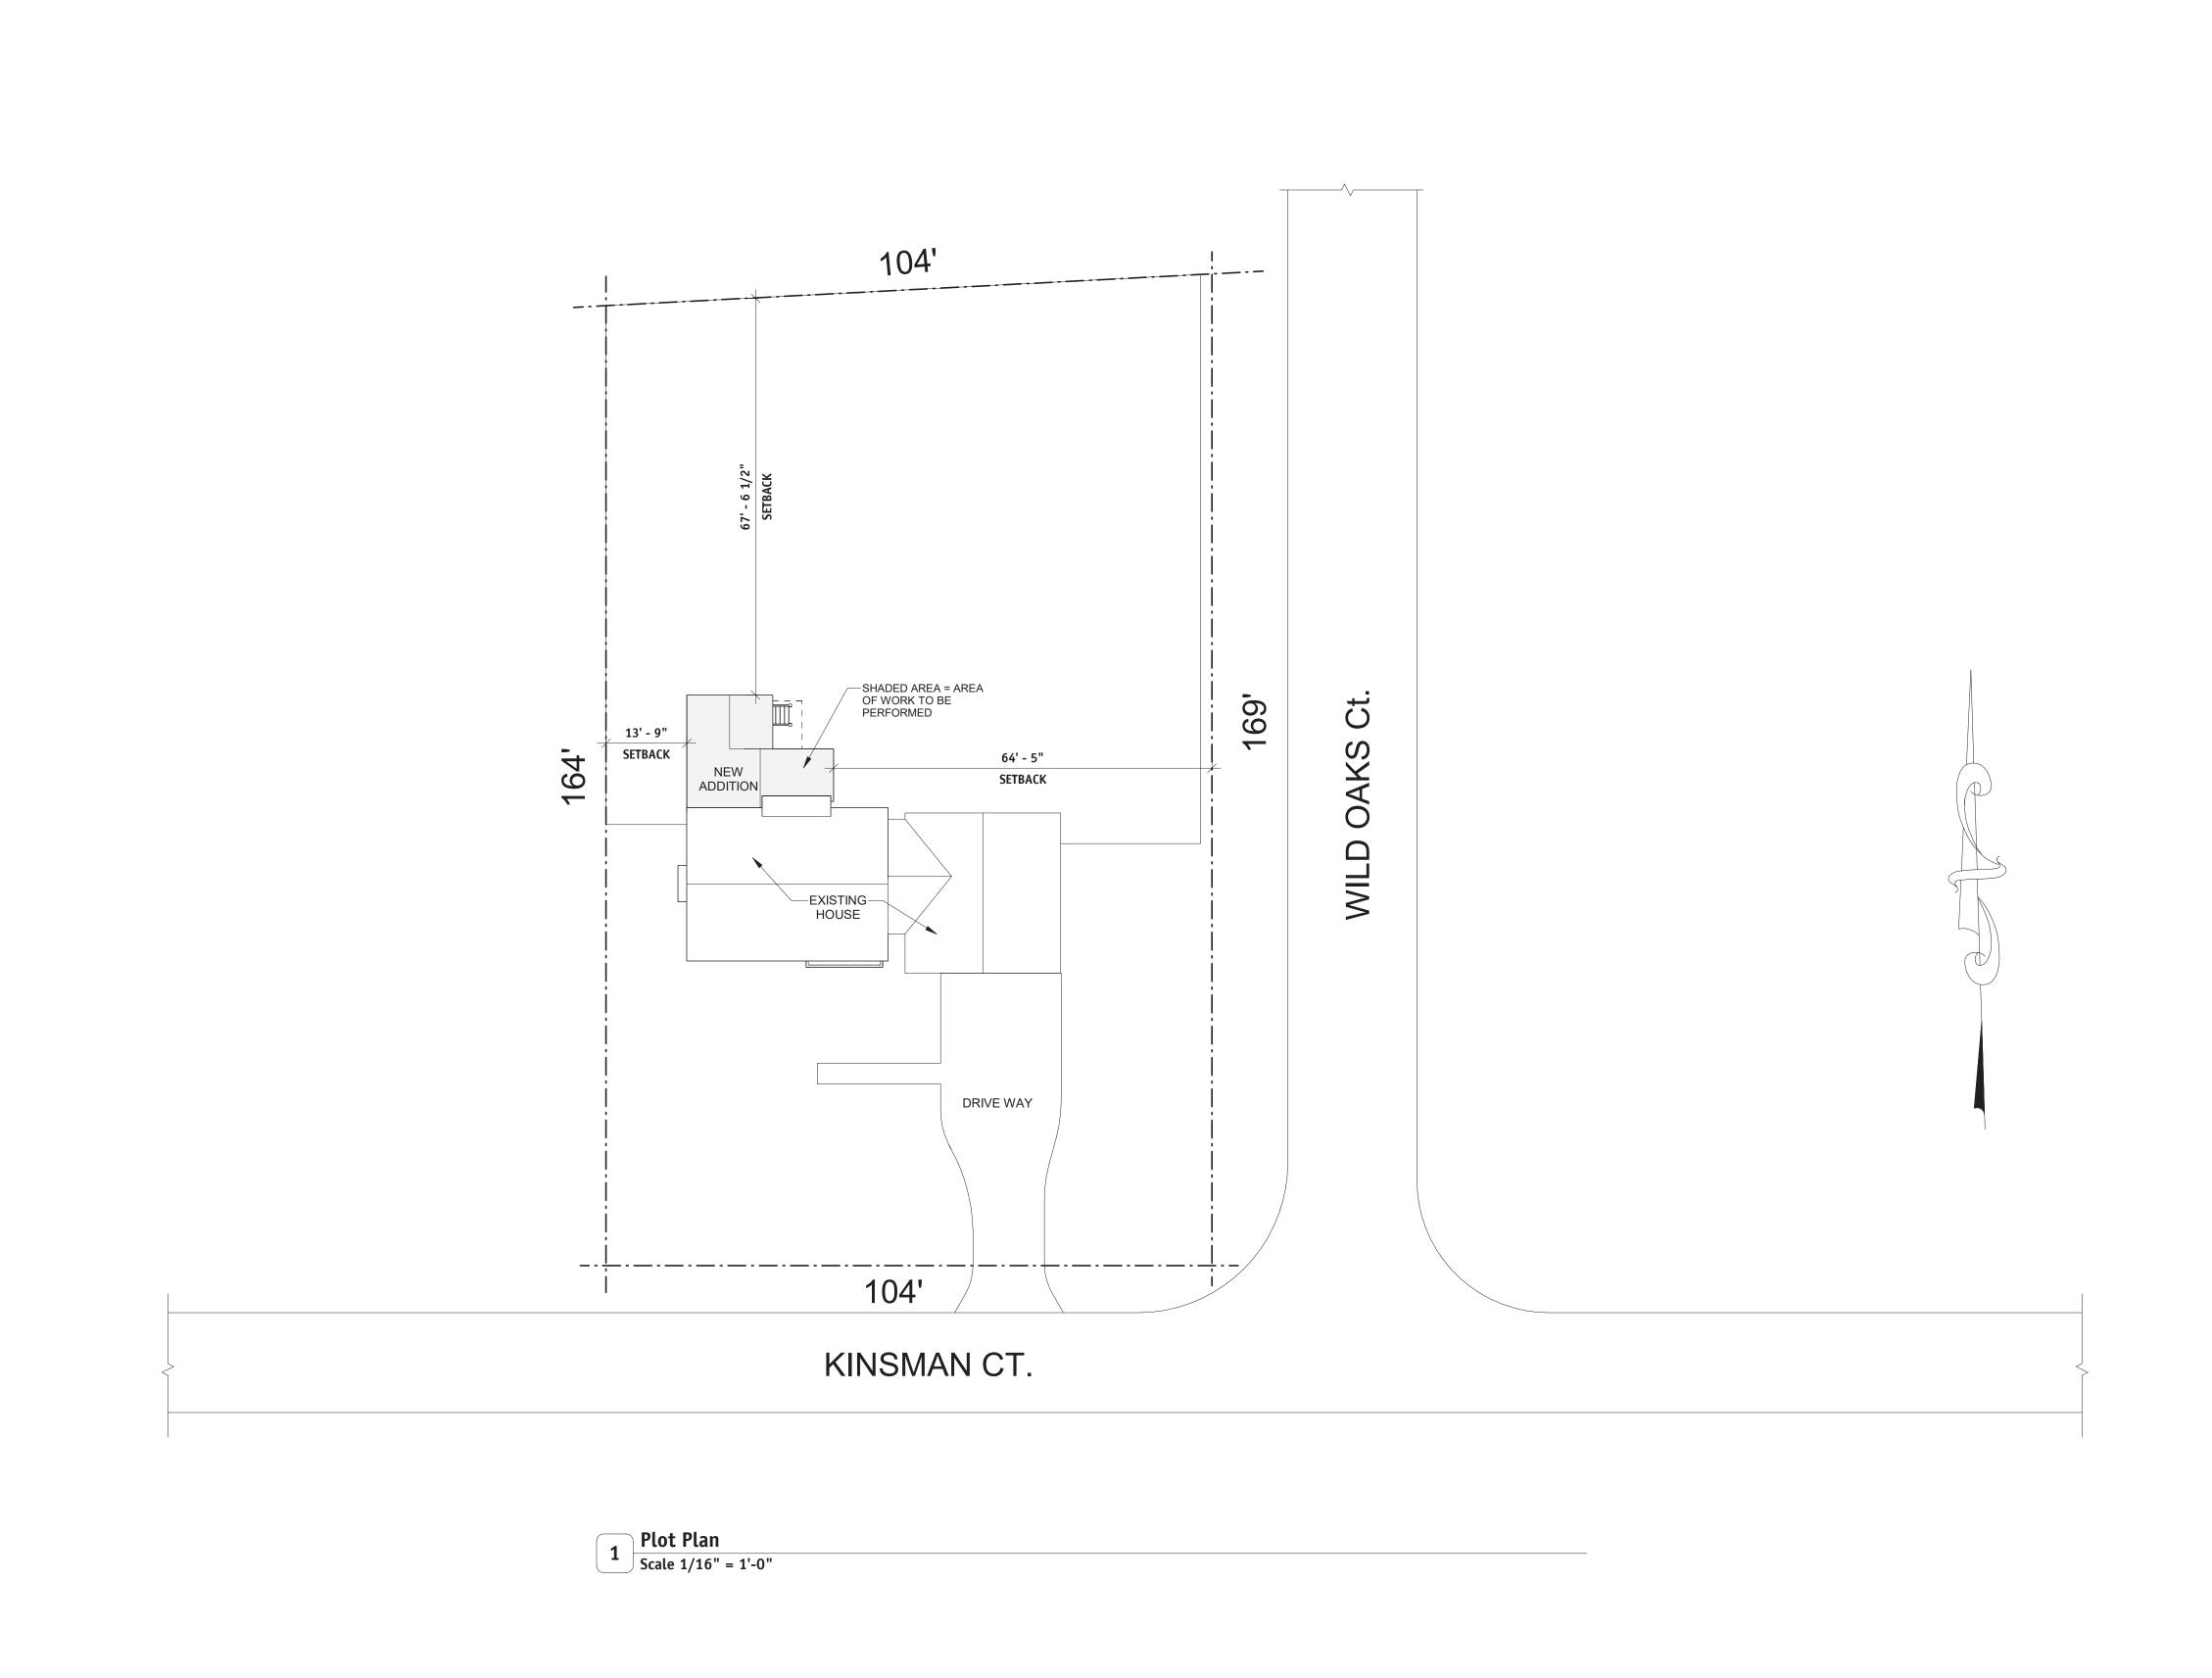

Carolina East Designs 2024 24 x 36 This document, and the information contained herein, are the sole property of Carolina East Designs. Any use or modification of this document, in whole or in part, without the written approval of Carolina East Designs, is strictly prohibited.

Rough Site Plan 08/28/2024

Scale:


Project Number:

AS NOTED

CAROLINA EA
1602 TOMMY
GOLDSBORO,

TORI EYE & SARAH MOI

Project Name Project Address

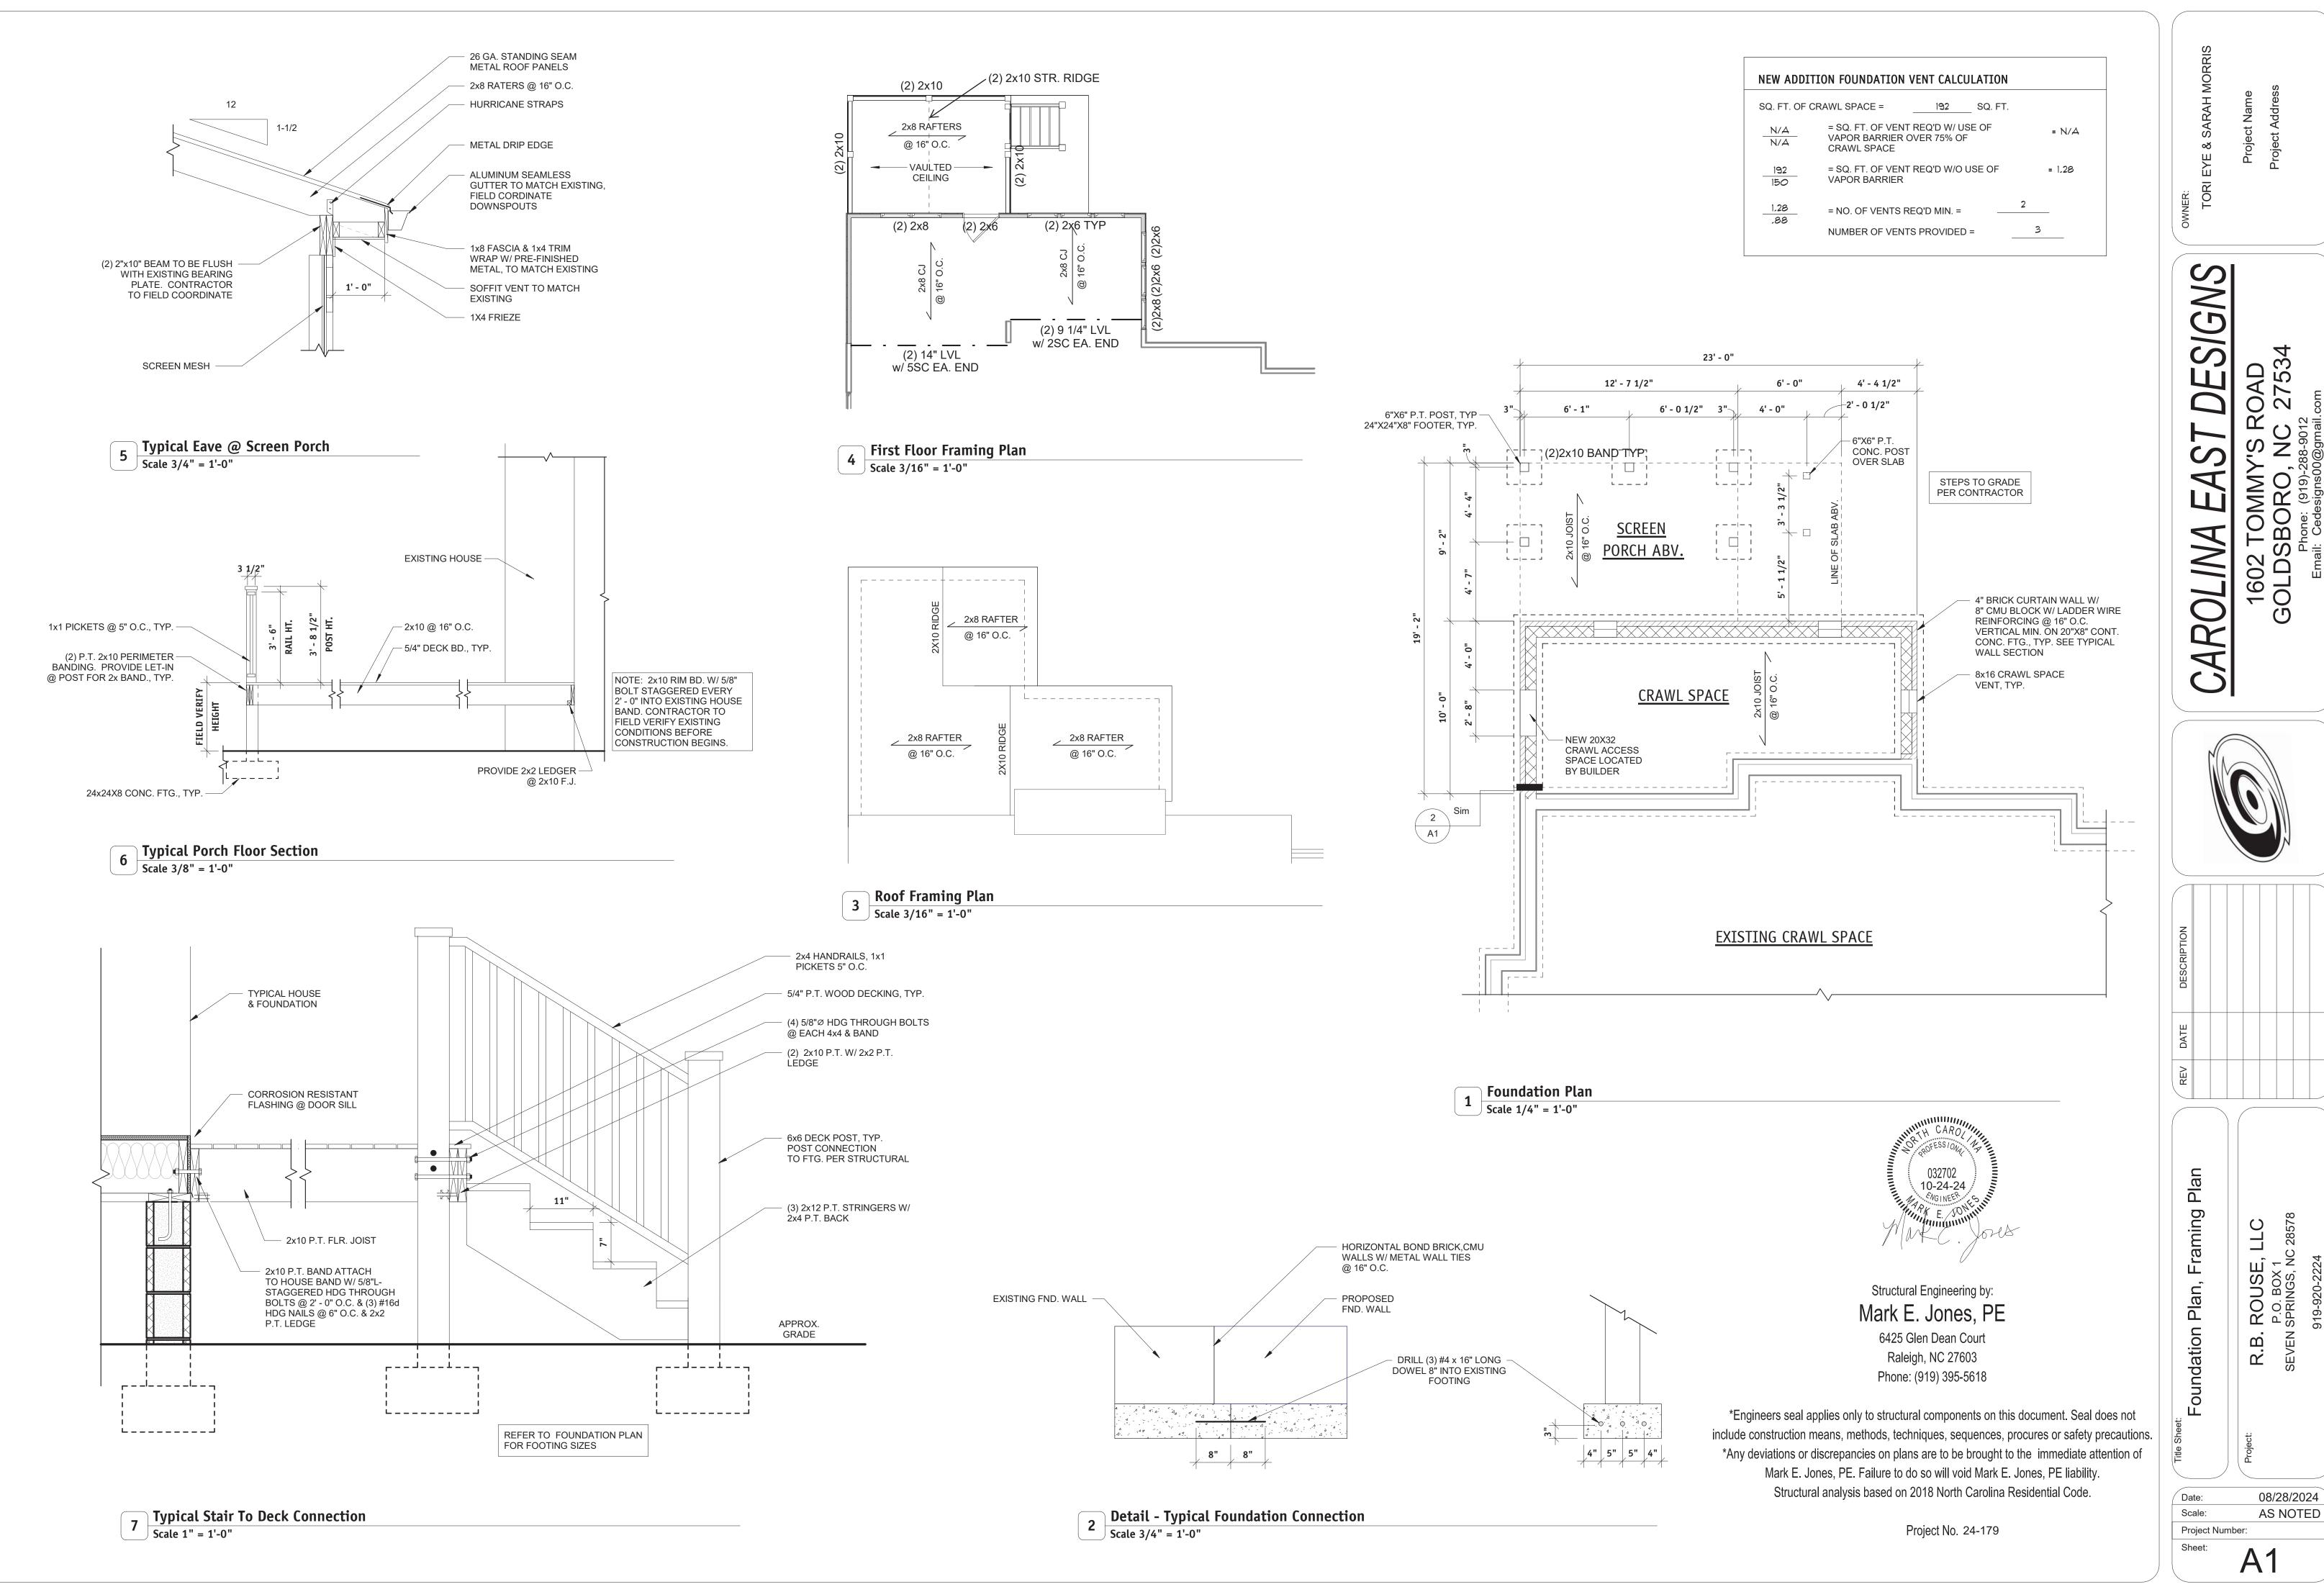

This document, and the information contained herein, are the sole property of Carolina East Designs. Any use or modification of this document, in whole or in part, without the written approval of Carolina East Designs, is strictly prohibited.

8/28/2024 12:42:15 AM

DEMOLITION NOTES: CONTRACTOR TO FIELD VERIFY EXISTING CONDITIONS BEFORE CONSTRUCTION BEGINS. CONTRACTOR SHALL CHECK, AND IDENTIFY ALL EXISTING WATER, SANITARY AND ELECTRIC LINES WHICH ARE TO REMAIN AND BE PROTECTED FROM DAMAGE DURING DEMOLITION AND ALTERATION OF WORK. CONTRACTOR SHALL EXCERCISE EXTREME CARE WHEN PENETRATING EXISTING WALLS OR FLOOR/CEILING SLABS SO STRUCTURAL INTEGRITY OF SUCH ELEMENTS IS NOT DEGRADED. CONTRACTOR SHALL RESTORE EXISTING SURFACES SCHEDULED TO REMAIN THAT ARE AFFECTED BY PATCH AND REPAIR ALL EXISTING SURFACES DAMAGED BY DEMOLITION AND/OR INSTALLATION OF NEW WORK AND/OR UTILITES, AS REQUEIRED TO MATCH ADJACENT SURFACES AND/OR TO RECEIVE NEW DEMOLISH AND REMOVE EXISTING CONDITIONS AS SHOWN BY DASHED LINES/ OR AS NOTED, U.N.O.

EXTERIOR SIDING OF EXISTING WALL AND PREP FOR NEW EXTERIOR SIDING.

SHOW A DEMOLITION SYMBOL. EVERYTHING ELSE IN NON-SHADED AREA SHALL REMAIN.

CONTRACTOR SHALL CHECK AND VERIFY ALL NOTES AND DIMENSIONS BEFORE PROCEEDING WITH

CONTRACTOR TO BUILD EXISTING WALL UP TO EXISTING TOP PLATE HEIGHT. CONTRACTOR TO FIELD VERIFY EXISTING CONDITIONS BEFORE CONSTRUCTION BEGINS. CONTRACTOR TO STRIP EXISTING

ONLY ITEMS DEMOLISHED IN NON-SHADED AREA ARE ITEMS THAT ARE NOTED TO BE DEMOLISHED OR


DEMOLITION LEGEND	
SYMBOL	DESCRIPTION
	EXISTING WALLS TO REMAIN
	ITEM TO BE DEMOLISHED
	ITEM TO BE DEMOLISHED

AREA HVAC TOTALS 216 SF 216 SF 115 SF Screen Porch TOTAL 216 SF

FLOOR PLAN NOTES

- ALL INTERIOR DIMENSIONS ARE FROM WALL STUD TO WALL STUD & TO CENTERLINE OF OPENING, U.NO. ALL DIMENSIONS REFERENCED HEREIN
- ARE IMPERIAL STANDARD, U.N.O. ALL EXTERIOR DIMENSIONS ARE FROM FACE OF STUD, FACE OF CONCRETE, FACE OF CMU., OR TO CENTERLINE OF OPENING, U.N.O.
- EXTERIOR DOORS AND WINDOWS ARE DIMENSIONED TO CENTERLINE. WALL ANGLES ARE PARALLEL, PERPENDICULAR OR 45 DEGREE ANGLES TO
- BUILDING PERIMETER UNLESS NOTED OTHERWISE. DO NOT SCALE DIMENSIONS FROM PRINTS. USE DIMENSIONS GIVEN OR CONSULT DESIGNER FOR FURTHER CLARIFICATION.
- ALL INTERIOR WALLS AT BATHROOMS ARE TO BE INSULATED WITH SOUND BATT INSULATION. MIN. R-13 BATT INSULATION TO BE PROVIDED TO ALL EXTERIOR WALLS U.N.O. MIN. R-19 INSULATION TO BE PROVIDED AT 6" EXTERIOR WALLS
- PROVIDE WATER RESISTANT GYPSUM WALL BOARD AT ALL WET WALLS
- INCLUDING, BUT NOT LIMITED TO WALLS AT BATHROOMS AND KITCHEN. PROVIDE SUPPLEMENTAL FRAMING, METAL BLOCKING / STRAPPING AND BRACING AS REQ'D FOR SUPPORT OF FIXTURES, EQUIPMENT, TOILET ACCESSORIES, FURNISHINGS, FURNITURE / EQUIPMENT, AND SIMILAR
- CONSTRUCTION. ALL DOORS TO BE POSITIONED WITH MIN. 2" GAP BETWEEN DOOR FRAME AND ADJACENT WALL UNLESS DIMENSIONED OTHERWISE.

FLOOR PLAN LEGEND	
SYMBOL	DESCRIPTION
	EXISTING WALLS
	NEW EXTERIOR WALLS
	NEW INTERIOR WALLS

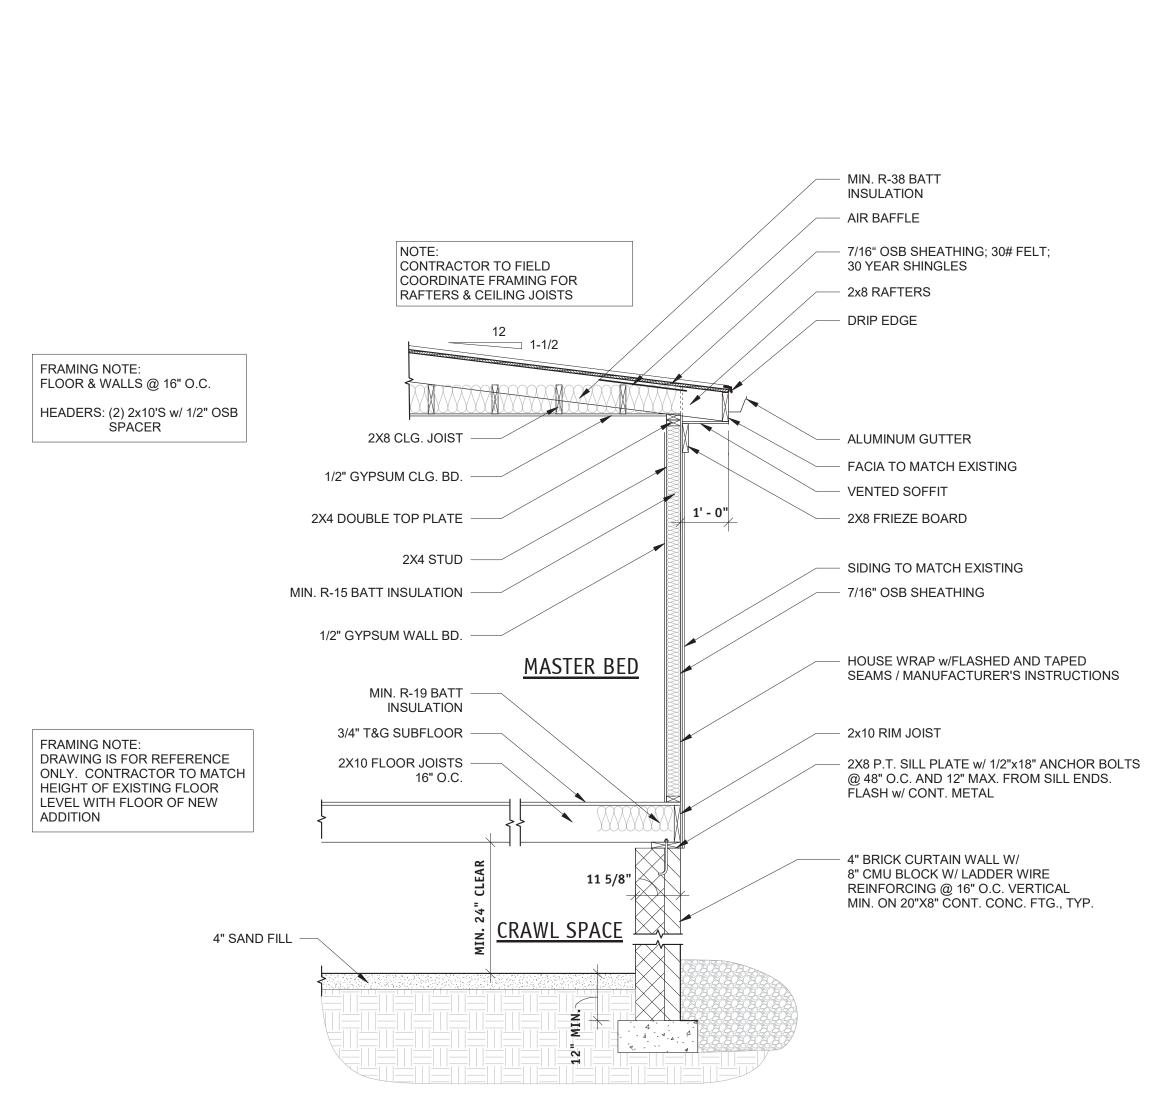


EXISTING NOOK

EXISTING LIVING

Demolition Plan Scale 1/4" = 1'-0"

2 Typical Wall Section
Scale 1/2" = 1'-0"

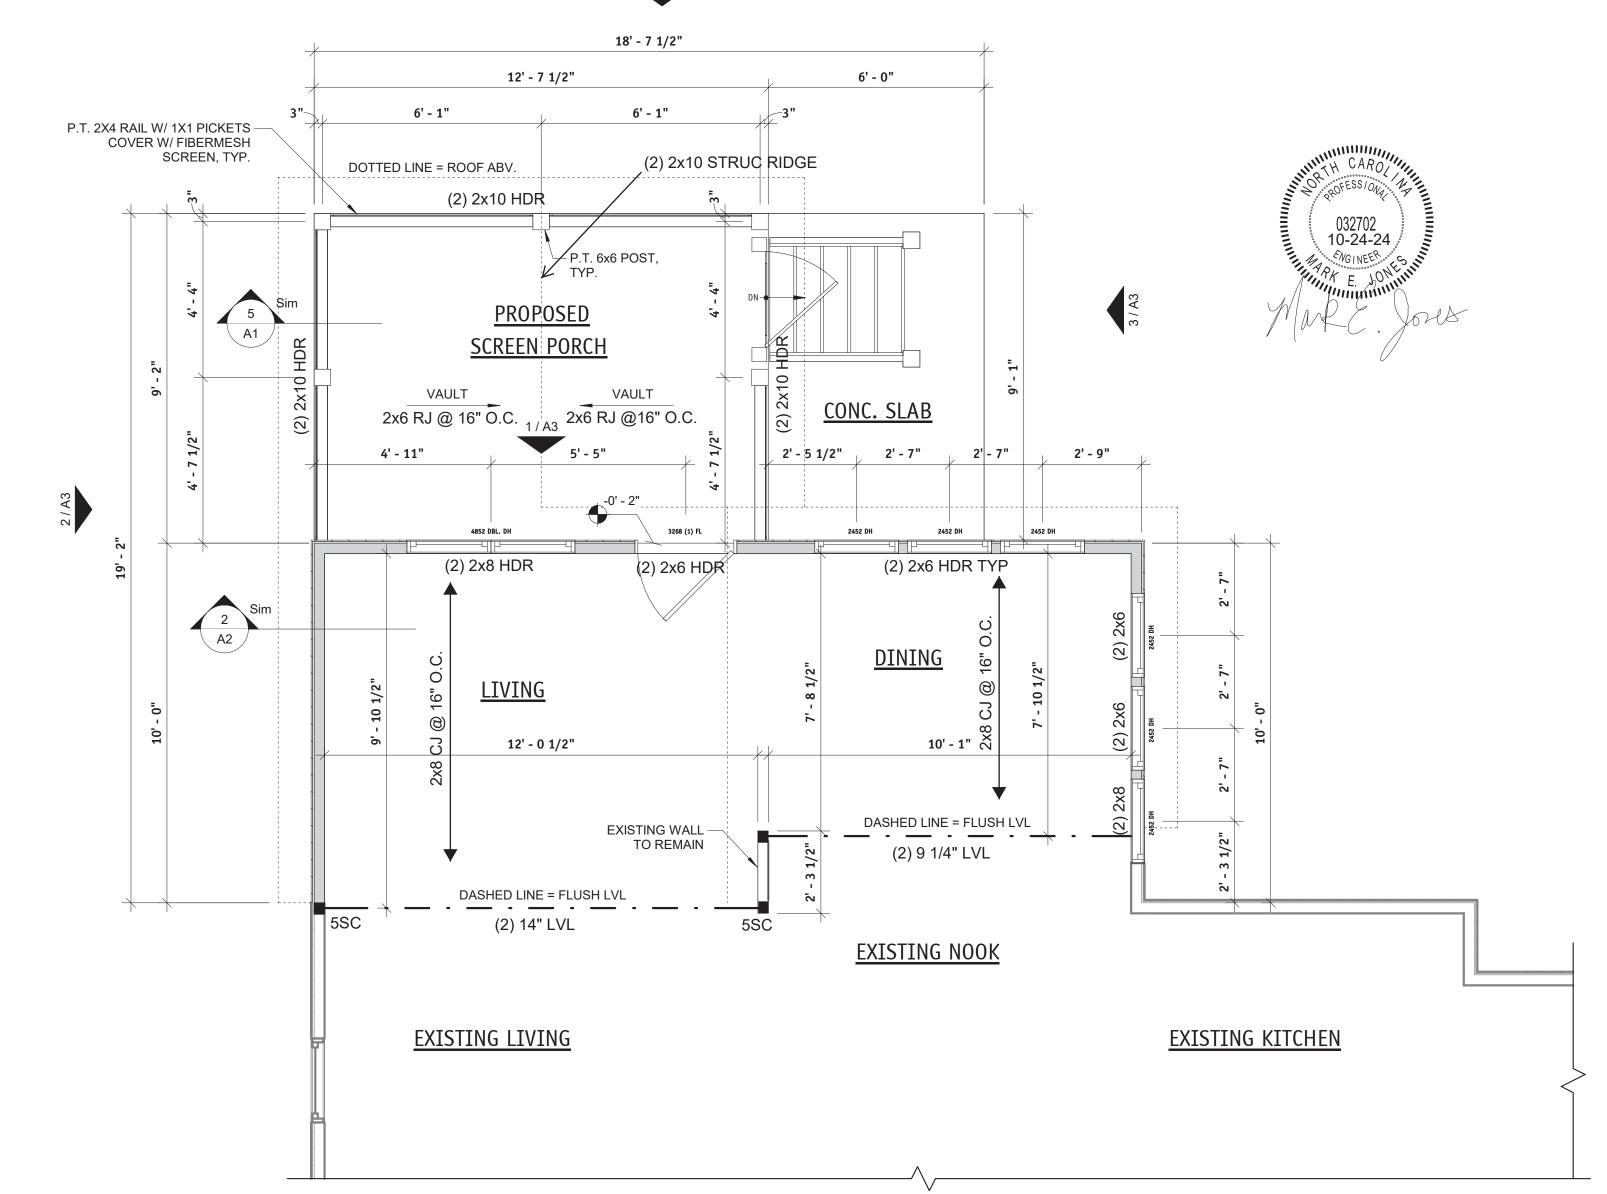


4 / A3


First Floor Plan Scale 3/8" = 1'-0"

m

08/28/2024 Scale: AS NOTED

Project Number: A2

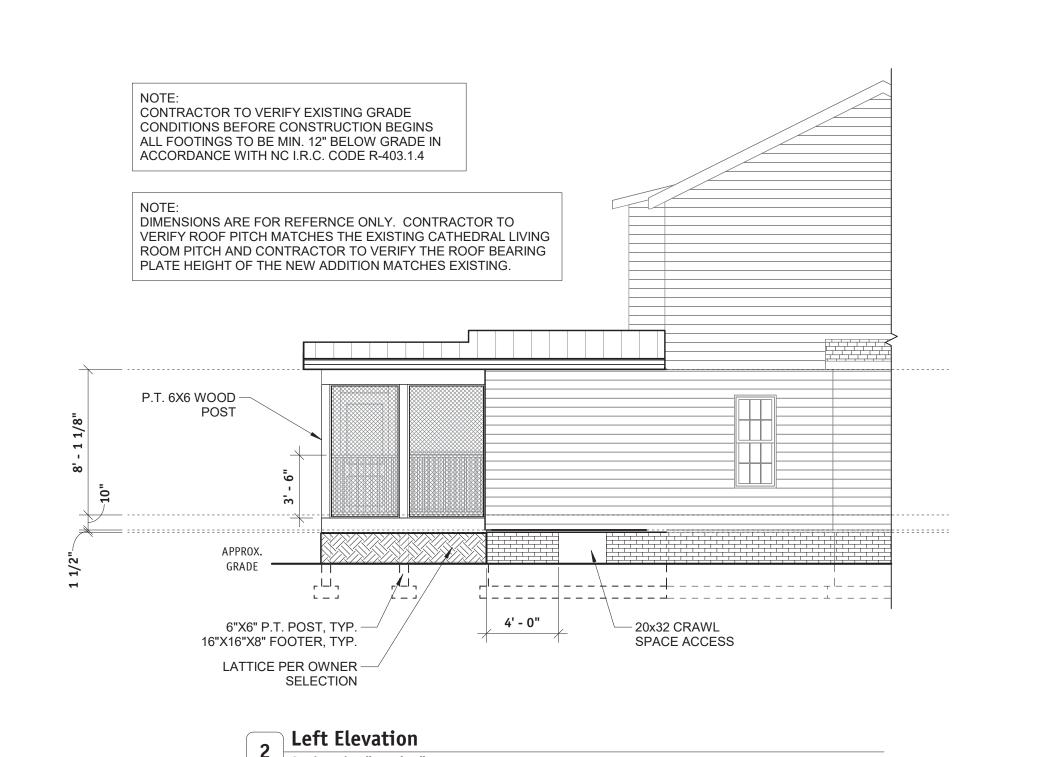

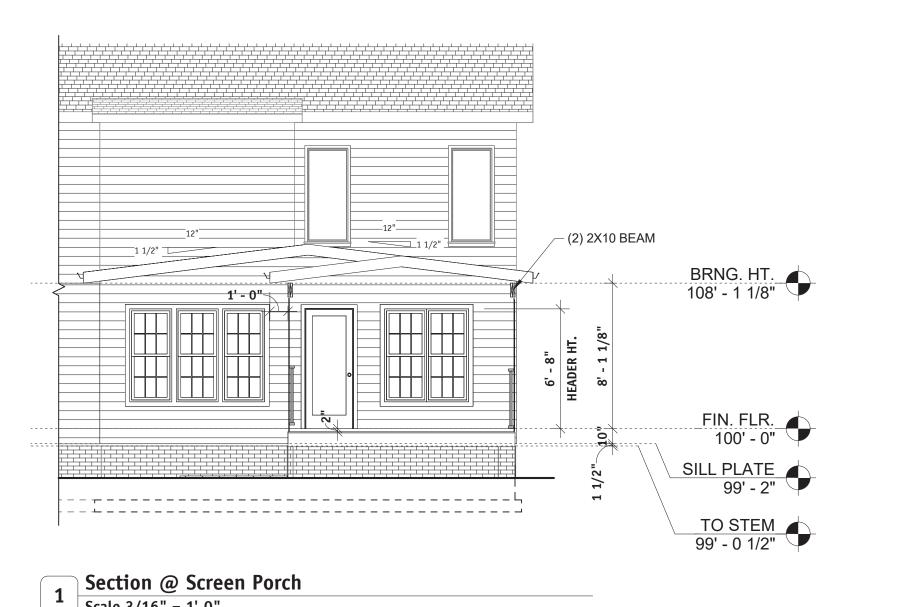



- ROOF DIMENSIONS ARE TAKEN FROM EXTERIOR FACE OF WALL TO EXTERIOR EDGE OF RAFTER / TRUSS.
- VERIFY LOCATIONS OF ALL ROOF PENETRATIONS WITH STRUC., MECH, AND PLUMBING DWGS. IT IS THE CONTRACTOR'S RESPONSIBILITY TO VERIFY, COORDINATE AND /OR INSTALL ALL ADJACENT AND/OR RELATED FLASHINGS, BLOCKING, NAILERS, INSULATION STOPS, CRICKETS, ETC. NECESSARY FOR THE COMPLETE INSTALLATION OF THE ROOF MEMBRANE WHICH ARE REQUIRED FOR A COMPLETE, WARRANTED, WATERTIGHT, WATERPROOF
- ROOF DRAINAGE IS CALCULATED FOR A 100-YEAR, 1-HR. RAINFALL AS REQUIRED BY THE NCIBC PLUMBING CODE FOR PRIMARY ROOF DRAINS (FIGURE 1106.1(a).
- CONDUCTORS, DOWNSPOUTS, & SCUPPERS TO BE LOCATED BY CONTRACTOR IN FIELD.

ENGINEERED ROOF TRUSSES PER MANUFACTUER DESIGN.

ELEVATION NOTES

- CONTRACTOR TO FIELD VERIFY ALL EXISTING CONDITIONS BEFORE CONSTRUCTION BEGINS. ANY DISCREPANCIES BETWEEN EXISTING CONDITIONS AND PLANS SHALL BE BROUGHT TO THE ATTENTION OF DESIGNER.
- ALL MATERIALS AND INFORMATION NOTED ON ANY OF THE ELEVATIONS APPLY TO ALL OTHER ELEVATIONS WHERE SIMILAR CONDITIONS OCCUR WHETHER NOTED OR NOT.

NEW ADDITION ATTIC VENTILATION

R806.2 MINIMUM VENT AREA

TOTAL NET FREE VENTILATING AREA RATIO = 1/150.

TOTAL ATTIC AREA (SF). = 235 (SF)


235 (SF) / 150 = 1.56 (SF) OF TOTAL NET FREE AREA

1.56 (SF) / 2 = .78 (SF) OF INTAKE NET FREE AREA & .78 (SF) OF EXHAUST NET FREE


.78 (SF) X 144 = 113 (SQ. IN.) OF INTAKE NET FREE ARE & 113 (SQ. IN.) OF EXHAUST NET FREE AREA.


MINIMUM RIDGE VENT PER UNIT = (3) PIECES OF 4'-0" SHINGLE OVER RIDGE VENT PER UNIT.


MINIMUM EAVE VENT PER UNIT = (2) PIECES OF 12" X 12' PERFORATED EAVE VENT. MINIMUM EAVE VENT PER UNIT = (N/A) PIECES OF 6" X 12' PERFORATED EAVE

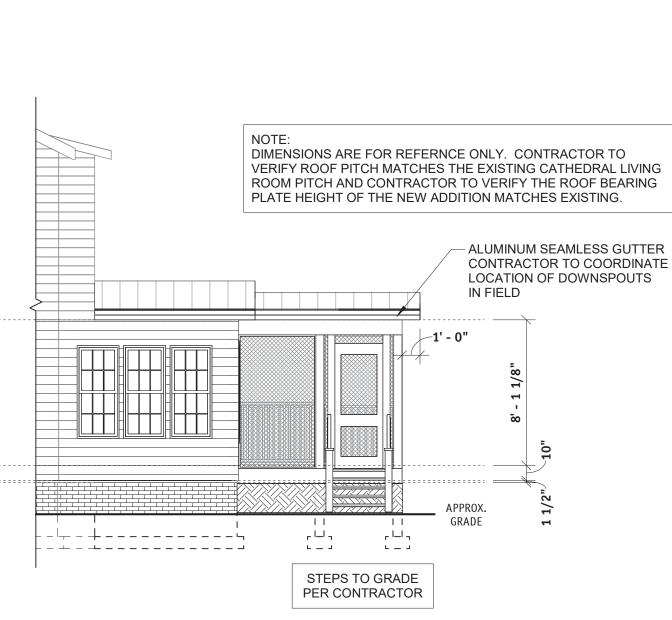



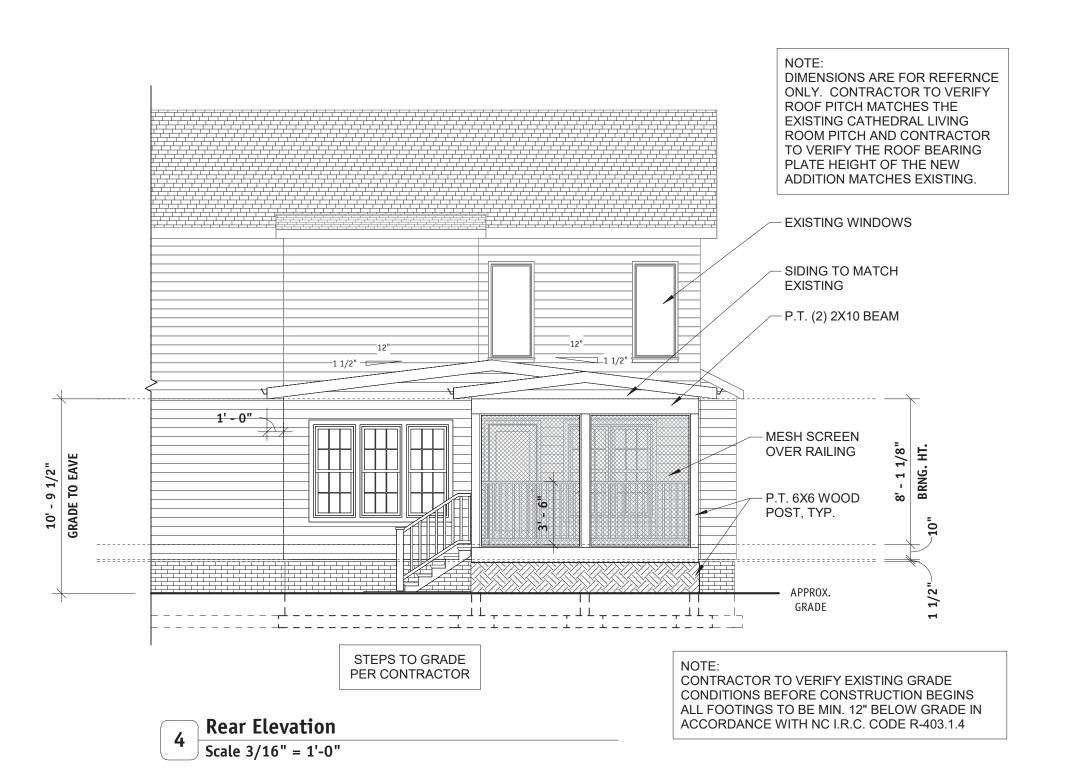

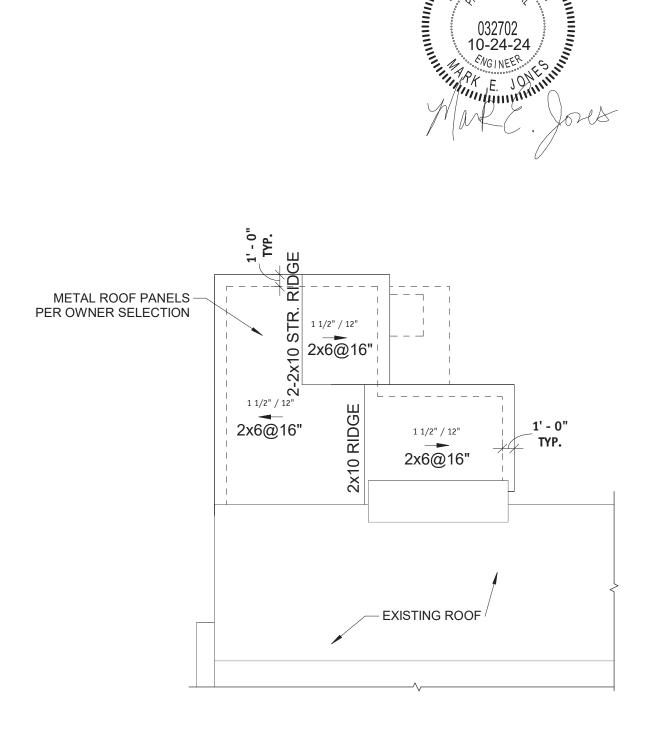

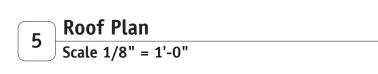



ROUSE,
P.O. BOX 1
SPRINGS, NO ä α

Elevations,

08/28/2024

Scale: AS NOTED Project Number:

This document, and the information contained herein, are the sole property of Carolina East Designs. Any use or modification of this document, in whole or in part, without the written approval of Carolina East Designs, is strictly prohibited.

8/28/2024 12:42:16 AM