MISCELLANEOUS NOTES

Design Documents and Construction Based on:

2018 NC Resdiential Building Code & 2018 NC Energy Conservation Code

GENERAL NOTES:

The notes, recommendation and considerations included herein are offered in good faith for the contractors reference. These notes are not all-inclusive and do not by any means include all the information necessary about all aspects of the construction project. These notes are superseded by the contractor's experience, best judgment, and local applicable building codes. The drawings, Illustrations and diagrams included in this package represent the design intended for the building and are to be used in the coordination of work. The contractor is responsible for the integrity of all assemblies and all work is to conform to accepted residential construction standards.

CONCRETE:

- All material and workmanship shall conform to ACI 318. All detailing, fabrication, accessories, and placement of reinforcing shall conform to ACI Manual of Standard Practice for Detailing Reinforced Concrete Structures. - Concrete shall be normal weight gray concrete and develop a minimum

compressive strength of 3000 PSI at 28 days (about 4 weeks). - A 4-inch-thick base course consisting of clean graded sand, gravel, crushed stone, crushed concrete, or crushed blast furnace slag passing a 2" sieve shall be placed on the prepared sub-grade where the slab is below grade. Exception: A base course is not required where the concrete slab is installed on well-drained or sand-gravel mixture soils.

- A 6-mil polyethylene or approved vapor retarder with joints lapped not less than 6 inches shall be placed between the concrete slab and the base course of the prepared sub-grade where n base course exists. Exception: the vapor retarder is not required for the following: 1. Garages, utility buildings or other unheated accessory structures. 2.Carports and unheated storage rooms having an area less than 70 square feet. 3. Driveways, walks, patios, and other flatwork that are not likely to be enclosed and heated at a

later date. 4. Where approved by the building official. - Control joints in concrete slabs shall be located so the maximum area within joints is less than 600 square feet and the ratio of side dimensions is

- Provide expansion joints where required by local code.

 Lap all reinforcing bars a length of 30 bar diameters minimum. - Foundation bolts must be anchored to sill plate with 1/2" diameter anchor bolts embedded into foundation wall or concrete slab for monolithic slabs. Anchor bolts shall conform to ASTM A307. Bolts shall be located within 12" of each corner and spaced 6' on center.

WOOD FRAMING:

- All wood framing and materials shall comply with National Design Specifications for Wood Construction published by the National Forest Products Association.

- Unless noted otherwise, all framing members to be Spruce-Pine-Fir (SPF) #2, Southern Pine #2, or equal. - Lumber for 2x4 or 2x6 stud partitions shall be SPF #2 or equal at 16" on

- All exterior stud walls to be constructed of 2x4 or 2x6 SPF #2 or equal at

- All headers and beams are to be supported by built-up framing lumber or

- Any structural and/or framing members not indicated on the plan are to be sized by the contractor. Consult with a licensed structural engineer where

- Lumber that is in contact with concrete or masonry shall be pressure treated lumber - All exterior walls are dimensioned to the outside of ½" (nominal) plywood/

- All interior walls are dimensioned to the face of studs.

columns. Support is to be continuous to the foundation.

All trusses to be engineered and constructed by a PI member truss manufacturer. Install temporary and permanent bridging per truss manufacturer's recommendations.

- One row f 1x4 wood cross bracing or solid blocking on all spans over 16'0" - Collar ties to be spaced at 4'0" on center.

- All purlins and kickers are to be 2x6 unless otherwise noted. - Any hip or valley rafters of 28'-0" span or more to be Laminated Veneer

ELECTRICAL NOTES:

Lumber(LVL).

- Electrical receptacles shall be no more than 12 feet apart, including any wall 2 feet or wider. (Bathrooms, Kitchens, and Utility Rooms excepted) - GFCI outlets to be installed in Garages, Outdoors and in Laundry Rooms, Bathrooms and Kitchens within 6'0" measured horizontally from sinks.

- Bathrooms shall be provided with switches controlling light fixtures and mechanical ventilation.

- Exterior light fixtures shall be provided at all doors to the exterior. Switches shall be provided near doors controlling outdoor light fixtures. - Prewire for phone, data and/or TV in rooms decided by the contractor or

- Reinforce all ceiling-mounted lights, fixtures and/or devices.

- At least one light fixture and outlet shall be installed in attics and crawlspaces used for storage or where equipment is located. - Provide exterior outlets at the front and rear of the home. Outlets must be

within 6'6" of grade and weatherproof and GFCI protected. Electrical lighting fixtures in clothes closets shall be installed with a minimum of 18" clearance to combustible materials. Fixtures shall be vertically clear to the floor or recessed.

- Provide a minimum of one smoke detector per floor. Smoke detectors to be installed above door inside of each sleeping room

as well as being located outside of each sleeping room. Smoke detectors shall be connected to house power and install

interconnect so that when anyone is tripped all units will sound. - Smoke detectors must have a battery back-up.

PLUMBING NOTES:

- Plumbing fixtures shall have a water usage as stated; Toilet: 1.6 Gallons per flush maximum; Shower head: 2.5 GPM Maximum; Lavatory Faucets: 2.2 GPM maximum; Sink Faucets: 2.2 GPM maximum.


- All exterior hose bibs to have non-removable back flow prevention devices - Provide a minimum 30" wide space at water closet, extending at least 30" in front of toilet.

Water heater shall be provided with a temperature and pressure relief valve.

- All material and workmanship shall conform to AISC specifications for the de-sign, fabrication and erection of structural steel. - All structural steel beams and plates shall comply with ASTM A 572 Grade

- All structural steel columns shall comply with ASTM A 615 Grade 60 - All welds shall be made with E70XX electrodes. All butt welds shall be full penetration. Minimum size of fillet welds shall conform to AISC

specifications.

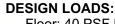

Floor: 40 PSF Live Load and 20 PSF Dead Load - Roof: 30 PSF Live Load and 15 PSF Dead Load - Attic: 30 PSF in storage areas and 10 PSF where no

- Assumed soil bearing capacity: 2000 PSF; Verify soil bearing capacity on site.

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SITE INFORMATION

SEE SITE PLAN PROVIDED BY

ENGINEER OR SURVEYOR

PROJECT INFORMATION

PROPOSED PROJECT FOR:

Tim & Janet Johnson

2467 Line Road, Cameron, NC 28326

Pilson Subdivision Book 221, Pg. 580 Deed Ref.: 4183, Pg. 1395 PID:099535 0002 10 PIN: 9535-72-2336.000

DESIGN DOCUMENTS REPARED BY: 13 THIRTEEN DESIGN & PLANNING

1,460 ft²

AREA CALCULATIONS NET AREA is calculated to outside edge of framing GROSS AREA is calculated ot outside edge of siding or veneer **HEATED SQUARE FOOTAGE**

Net Area Gross Area one Name

DETAIL IDENTIFICATION SHEET WHERE DETAIL IS DRAWN INTERIOR ELEVATION(S) 4 (A1) 2 INTERIOR ELEVATION(S)

SYMBOLS

ELEVATION IDENTIFICATION

SHEET WHERE ELEV. IS DRAWN

SECTION
SECTION IDENTIFICATION
SHEET WHERE SECTION IS DRAWN

SHEET WHERE INT. ELEV. IS DRAWN

WORK POINT, CONTROL

POINT or DATUM POINT

ROOM IDENTIFICATION ROOM NAME ROOM NO.

COLUMN LINE

WALL TYPE

WINDOW TYPE

DOOR SYMBOL DOOR MARK -HARDWARE GROUP

MATCH LINE SHADED PORTION IS THE SIDE CONSIDERED

UNHEATED SQUARE FOOTAGE Zone Name Net Area Gross Area PROJECT NAME: GARAGE 1,340 1,340 - FRONT PORCH 120

1,460 ft²

Tim & Janet Johnson 2467 Line Road, Cameron, NC 28326

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VERIFY ALL DIMENSIONS

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Concept and drawings contained on or within these

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installation procedures and to verify all dimen-

sions prior to construction.

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B D of Building Design

T Johnson Garage-2467 Line

American Institute

DOCUMENTS PREPARED FOR:

PROJECT NO: **AC27-24-4-13533** MODEL FILE: T Johnson Garage-2467 Line.pln

DRAWN BY: MM DESCRIPTION: NC/1 Story/2 Car

SHEET TITLE

TITLE SHEET / GENERAL INFO

A01

ABBREVIATIONS VICINITY MAP SHEET INDEX **ARCHITECTURAL DRAWINGS ANGLE** RESILIENT **ELEVATION** RESIL TEMPERED **ELEC** JOIST RETAINING TONGUE & GROOVE ELECTRICAL A01 TITLE SHEET / GENERAL INFO REVISION/REVISED/REVERSED POUND or NUMBER **EQUIP** FOUIPMENT I AMINATE PLUS or MINUS ROOM A02 FOUND., 1st & 2nd FLOOR PLAN TO MATCH EXISTING AIR CONDITIONING **EXIST** EXISTING LINEAR REMOV REMOVEABLE **APPROX** APPROXIMATE **EXPANSION** LIGHT ROUGH OPENING TOP OF CONCRETE A03 EXTERIOR ELEVATIONS **ARCHITECTURAL EXTERIOR** REDWOOD TOP OF PLATE MAXIMUM TOP OF PLYWOOD A04 ROOF PLAN & SECTIONS TOP OF WALL FIRE ALARM MECH MECHANICAL T.O.W. FLOOR DRAIN SOLID COVE MEMBRANE BLDG BLK BUILDING SOLID CORE DOOR FIXTURE UNIFORM BUILDING CODE MANUFACTURER U.B.C. BLOCK FLOOR S.D. STORM DRAIN BLKG **BLOCKING FLASH** FLASHING SCHEDULE UNEXCAVATED MISCELLANEOUS SECT UNFINISHED UNLESS NOTED OTHERWISE SEE SITE PLAN C.M.U. CONCRETE MASONRY FTG NOMINAL S.H. SPRINKLER HEAD COL CONC COND NOT TO SCALE SHR SHT **FURRING** SHOWER COLUMN VINYL COMPOSITION TILE SHFFT PROVIDED BY CONCRETE GAS OUTLET ON CENTER SHTG SHEATHING CONSTR CONDITION SIMII AR VERTICAL CONSTRUCTION GALVANIZED VESTIBULE **ENGINEER OR** CONTR SPECIFICATION OR SPECIAL VERTICAL GRAIN DOUGLAS FIR CONTINUOUS V.G.D.F. PLYWD PLYWOOD VERIFY IN FIELD SQUARE INTERRUPTER PER SQUARE INCH S.S. STAINLESS STEEL VOL **SURVEYOR** DBL DET DOUBLE PRESSURE TREATED SFRVICE SINK GYPSUM S.SK DETAIL WEST STD STANDARD DIAMETER HOSE BIBB QUARRY TILE DIMENSION WALL COVERING HARDWOOD DOOR WATER HEATER **RETURN AIR** SHEET VINYL HANGER S.V. D.W. DISHWASHER WITHOUT HEIGHT RADIUM SHEAR WALL DRWG DRW HORIZONTAL WORK POINT OR SYMMETRICAL DRAWING RECESSED WATERPROOF MEMBRANE DRAWER HOT WATER HEATER REFERANCE SYS SYSTEM WPM REFLECTED WAINSCOT INSIDE DIAMETER REFRIGERATOR **EXTERIOR INSULATION &** REGISTER TOWEL BAR WATER RESISTANT

BRACED WALL NOTES:

INDICATED IN CODE TABLES.

- 1. BRACED WAILS ARE REQUIRED PER SECTION R602.10.1 2018 NCBC RESIDENTIAL CODE
- 2. THE EXTERIOR WALL STRUCTURE SHALL BE CONTINUOUSLY SHEATHED, FULL HEIGHT WITH MIN. THICKNESS 7/16" OSB. THESE WALLS SHALL BE CONSTRUCTED IN CONFORMANCE TO TYPE CS-WSP DETAILS. REFER TO PLAN FOR LOCATION OF REQUIRED BRACING LABLED "CS BRACING" AND LENGTH OF WALL BRACING LABELED IN LINEAR FEET.
- 3. INTERIOR WALLS WHERE NOTED SHALL BE BRACED PER INDICATED METHOD IN REFERENCE TO NCBC-RESIDENTIAL CODE, TABLE R602.10.2.

LIB METHOD:
INSTALL 1X4 WOOD OR CONTINUOUS METAL STRAPPING AT 45 DEGREES TO 60
DEGREES FROM TOP PLATE TO BOTTOM PLATE ACROSS STUDS WITH MAXIMUM STUD
SPACING OF 16" ON CENTER. CONNECT AS INDICATED IN CODE SECTION.

GB METHOD: MINIMUM $\rlap{/}{b}2$ " Gypsum board turned vertically and continuou from top plate to bottom plate. Screw connection to framing using spacing criteria as

- 4. SPECIAL BRACING DETAILS ARE ILLUSTRATED IN THE CODE AND ALLOWED WHERE WALLS DO NOT MEET THE **MINIMUM** REQUIREMENTS FOR SUPPORT.
- 5. SEE TABLE R602.7.5 FOR CORRECT NUMBER OF KING STUDS PER HEADER.

GENERAL FRAMING NOTES:

- 1. THIS PLAN DESIGNED IN ACCORDANCE WITH NC RESIDENTIAL CODE. 2018
- 2. GLAZING AREAS SHOWN ON THESE DESIGN DRAWINGS DO NOT EXCEED 15%
 OF THE GROSS AREA OF THE EXTERIOR WALLS. THIS STRUCTURE MEETS THE
 REQUIREMENTS OF NI101.2.1, RESIDENTIAL BUILDING, TYPE A-1.
- 3. WALL CLADDING IS DESIGNED FOR A 24.1 #SF OR GREATER POSITIVE/NEGATIVE PRESSURE.
 - 4. ALL WALLS, FLOORS AND CEILINGS SHALL BE INSUIATED IN ACCORDANCE WITH CODE SUMMARY.
 - DESIGN CRITERIA: 10 PSF 40 PSF PRIMARY FLOOR 10 PSF SECONDARY FLOOR 40 PSF SLEEPING AREAS 10 PSF 30 PSF 10 PSF ATTIC 20 PSF **ROOF** 10 PSF 20 PSF DEFLECTION LIMITS:
 - FLOOR L/360(LIVE LOAD ONLY)
 - ROOF L/240
 - 6. ALL HEADERS IN LOAD BEARING WALLS SHALL BE DOUBLE 2X10 U.O.N.
 7. ALL WALLS ARE 2X4 @ 16" O.C. U.O.N.
 - 8. PROVIDE DOUBLE FLOOR JOISTS UNDER WALLS ABOVE.
 - 9. PROVIDE DOUBLE PLOOR JOISTS UNDER WALLS ABOVE.

 9. PROVIDE FOUNDATION VENT WITHIN 36" OF EACH CORNER.
 - 10. ALL JOISTS TO BE SPF.

<u>3'-6"</u>

30"x 30"x 10"
EXPANDED CONCRETE
FOOTINGS FOR POINT
LOADS

ALL ENGINEERED WOOD PRODUCTS AND STEEL USED

THROUGHOUT THIS PROJECT
TO BE SIZED AND DESIGNED
BY OTHERS.
ROOF SYSTEM TO BE WOOD

TRUSSES PER

MANUFACTURER.

8" MASONRY STEM WALL

4" CONCRETE SLAB 3000 PSI WITH WIRE MESH or ADDED FIBER & 6 MIL POLY ON 4" DRAINABLE FILL (IRC SECTION R506)


PROVIDE 1/2" DIA. ANCHOR BOLTS 1'-0" FROM CORNER AND 6'-0" O.C. EMBEDDED A MIN. 7"

IN MASONRY OR 7" IN CONCRETE, OR STRAPS PER MANUFACTURERS

RECOMMENDATION EMBEDDED A MIN. 7" IN MASONRY OR CONCRETE (NOT IMBEDDED IN BRICK). (IRC SECTION R403.1.6)

ON 16"x 8" CONTINUOUS

CONCRETE FOOTINGS

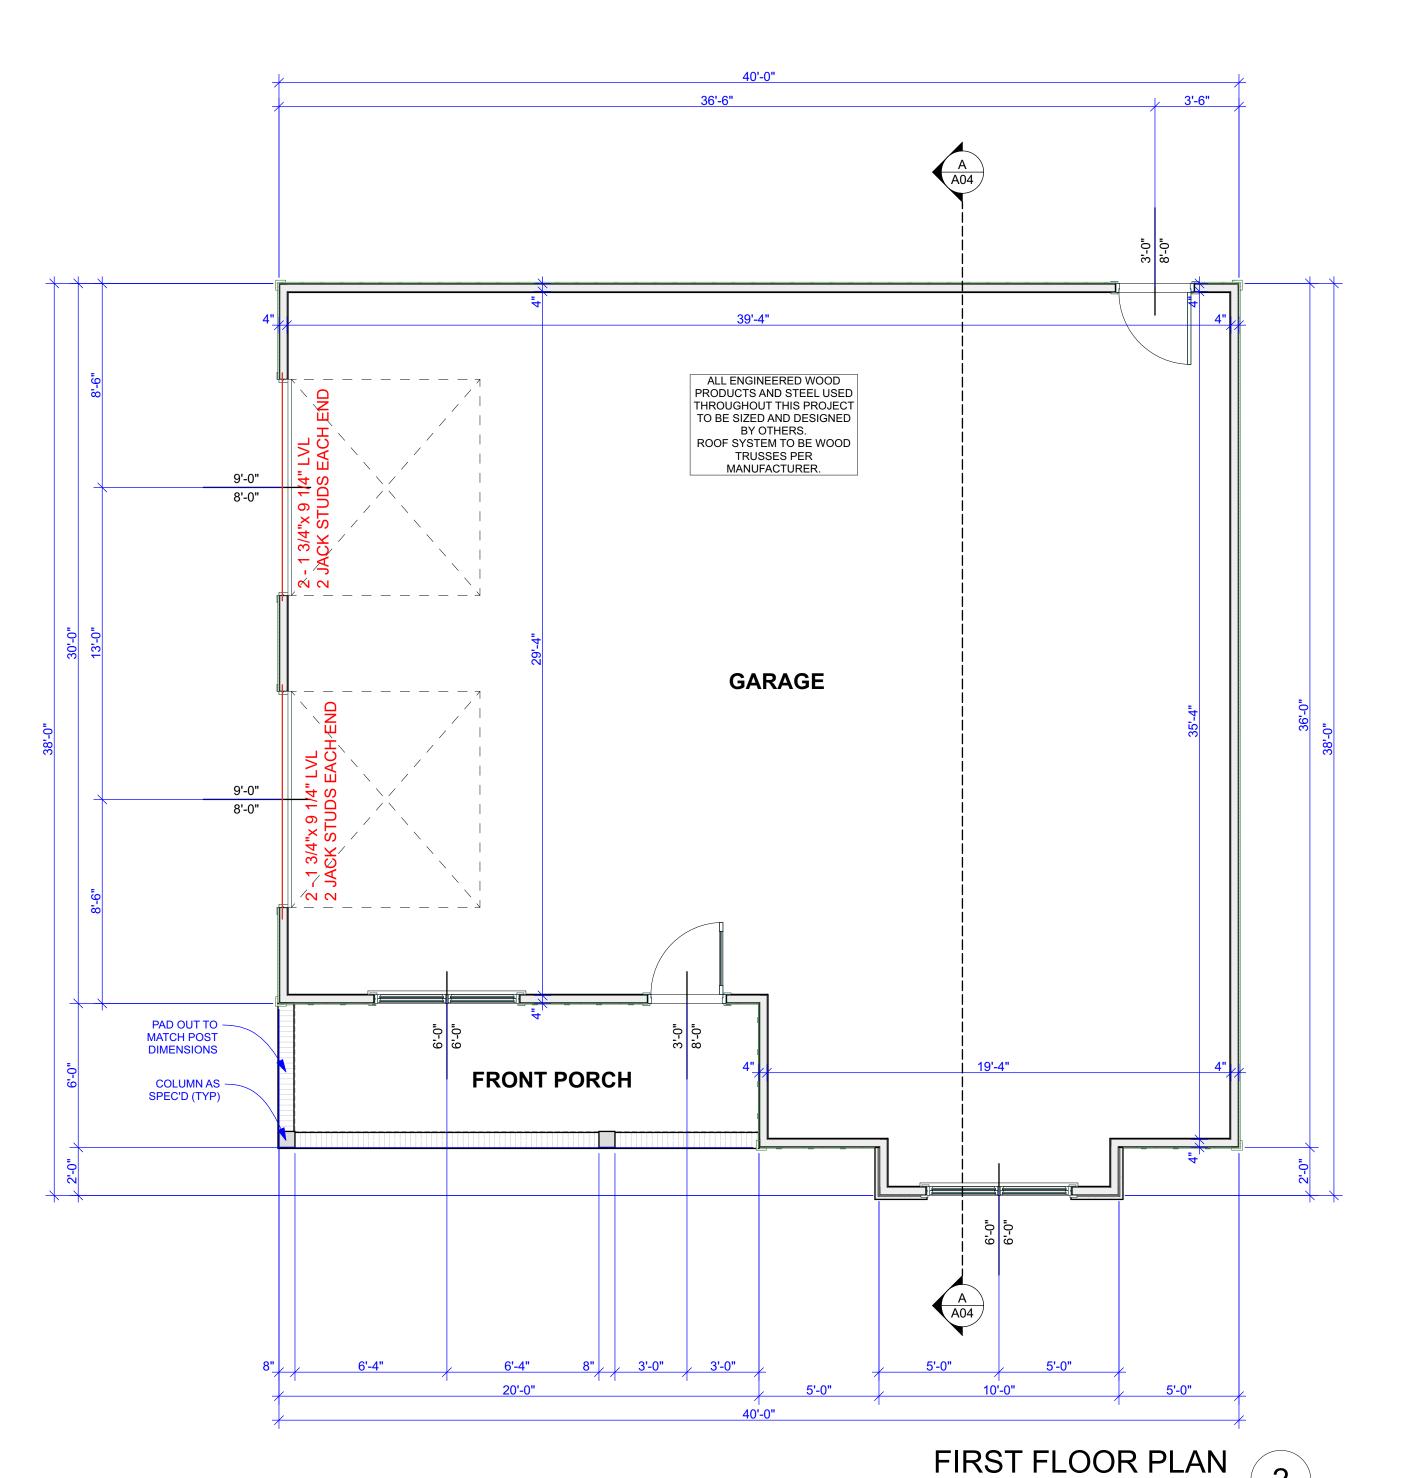

STRUCTURAL EVALUATION BY: HOWERTON SERVICES, PLLC 3513 CATHEDRAL BELL ROAD RALEIGH, NC 27614 LICENSE P-1716

* ENGINEER'S SEAL APPLIES ONLY TO STRUCTURAL COMPONENTS ON THIS DOCUMENT. SEAL DOES NOT INCLUDE CONSTRUCTION REVIEW, MEANS, METHODS, TECHNIQUES, SEQUENCES, PROCEDURES OR

SAFETY PRECAUTIONS.

* ANY DEVIATIONS OR DISCREPANCIES ON PLANS ARE TO BE BROUGHT TO IMMEDIATE ATTENTION OF THE ENGINEER. FAILURE TO DO SO WILL VOID ENGINEER'S LIABILITY.



08 29 2024 EDT



MICHAEL MOORE DESIGNS Residential Design & Planning

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PROJECT NAME:

T Johnson Garage-2467 Line
Tim & Janet Johnson
2467 Line Road, Cameron, NC
28326

DOCUMENTS PREPARED FOR:

PROJECT NO: AC27-24-4-13533
MODEL FILE:

T Johnson Garage-2467 Line.pln

DRAWN BY: MM

DESCRIPTION: NC/1 Story/2 Car

SHEET TITLE

FOUND., 1st & 2nd FLOOR PLAN

A02

FOUNDATION PLAN

SCALE: 1/4" = 1'-0"

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3'-0"





FRONT ELEVATION

SCALE: 1/4" = 1'-0" 2





REAR ELEVATION

SCALE: 1/4" = 1'-0"

4

RIGHT ELEVATION

SCALE: 1/4" = 1'-0" 1



PROJECT NO: AC27-24-4-13533 MODEL FILE:

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B D of Building Design

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Tim & Janet Johnson 2467 Line Road, Cameron, NC 28326

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PROJECT NAME:

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DRAWN BY: MM


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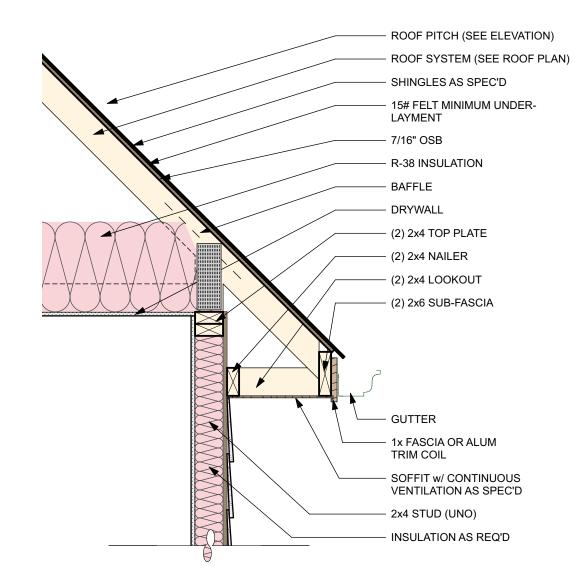
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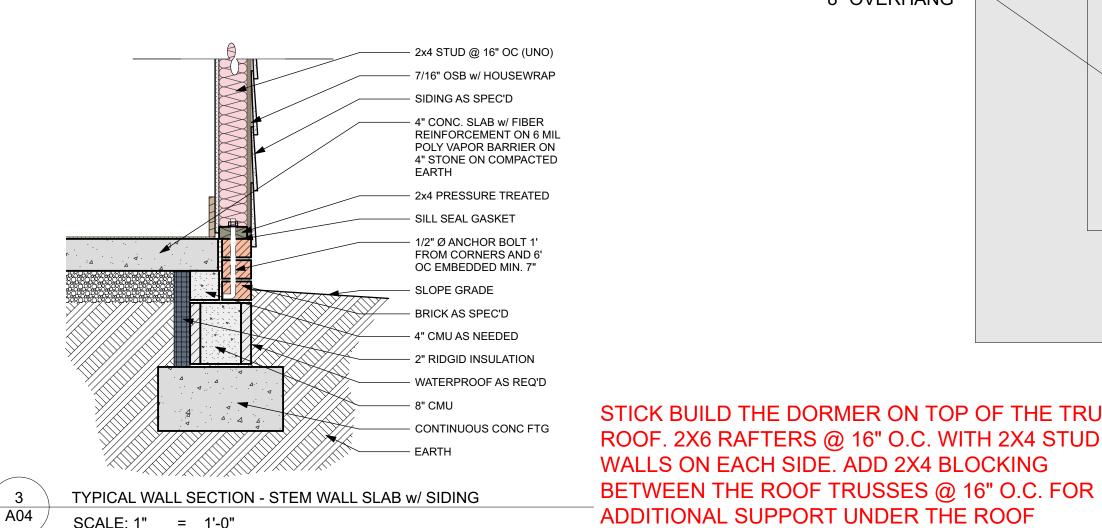
EXTERIOR ELEVATIONS

A03









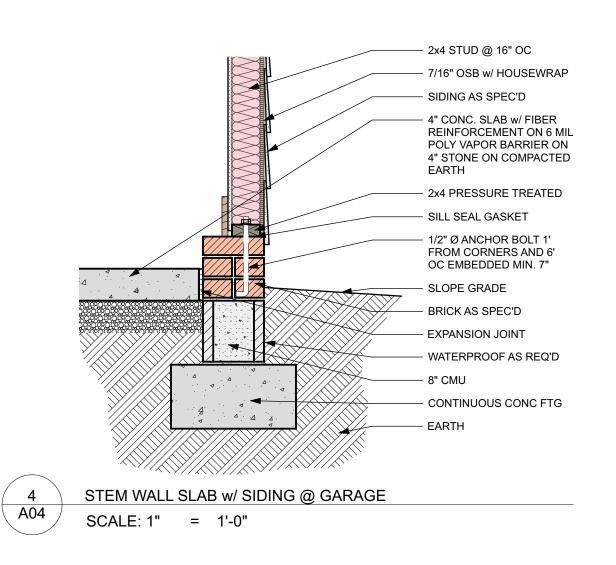

SHEATHING.

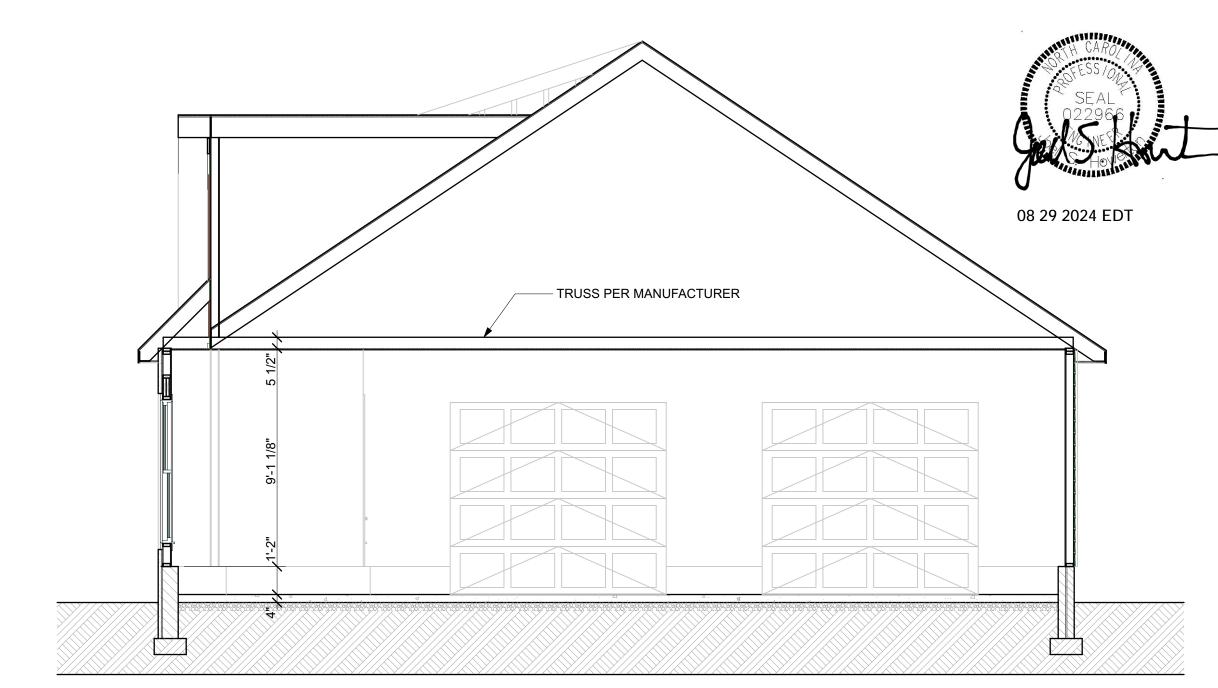

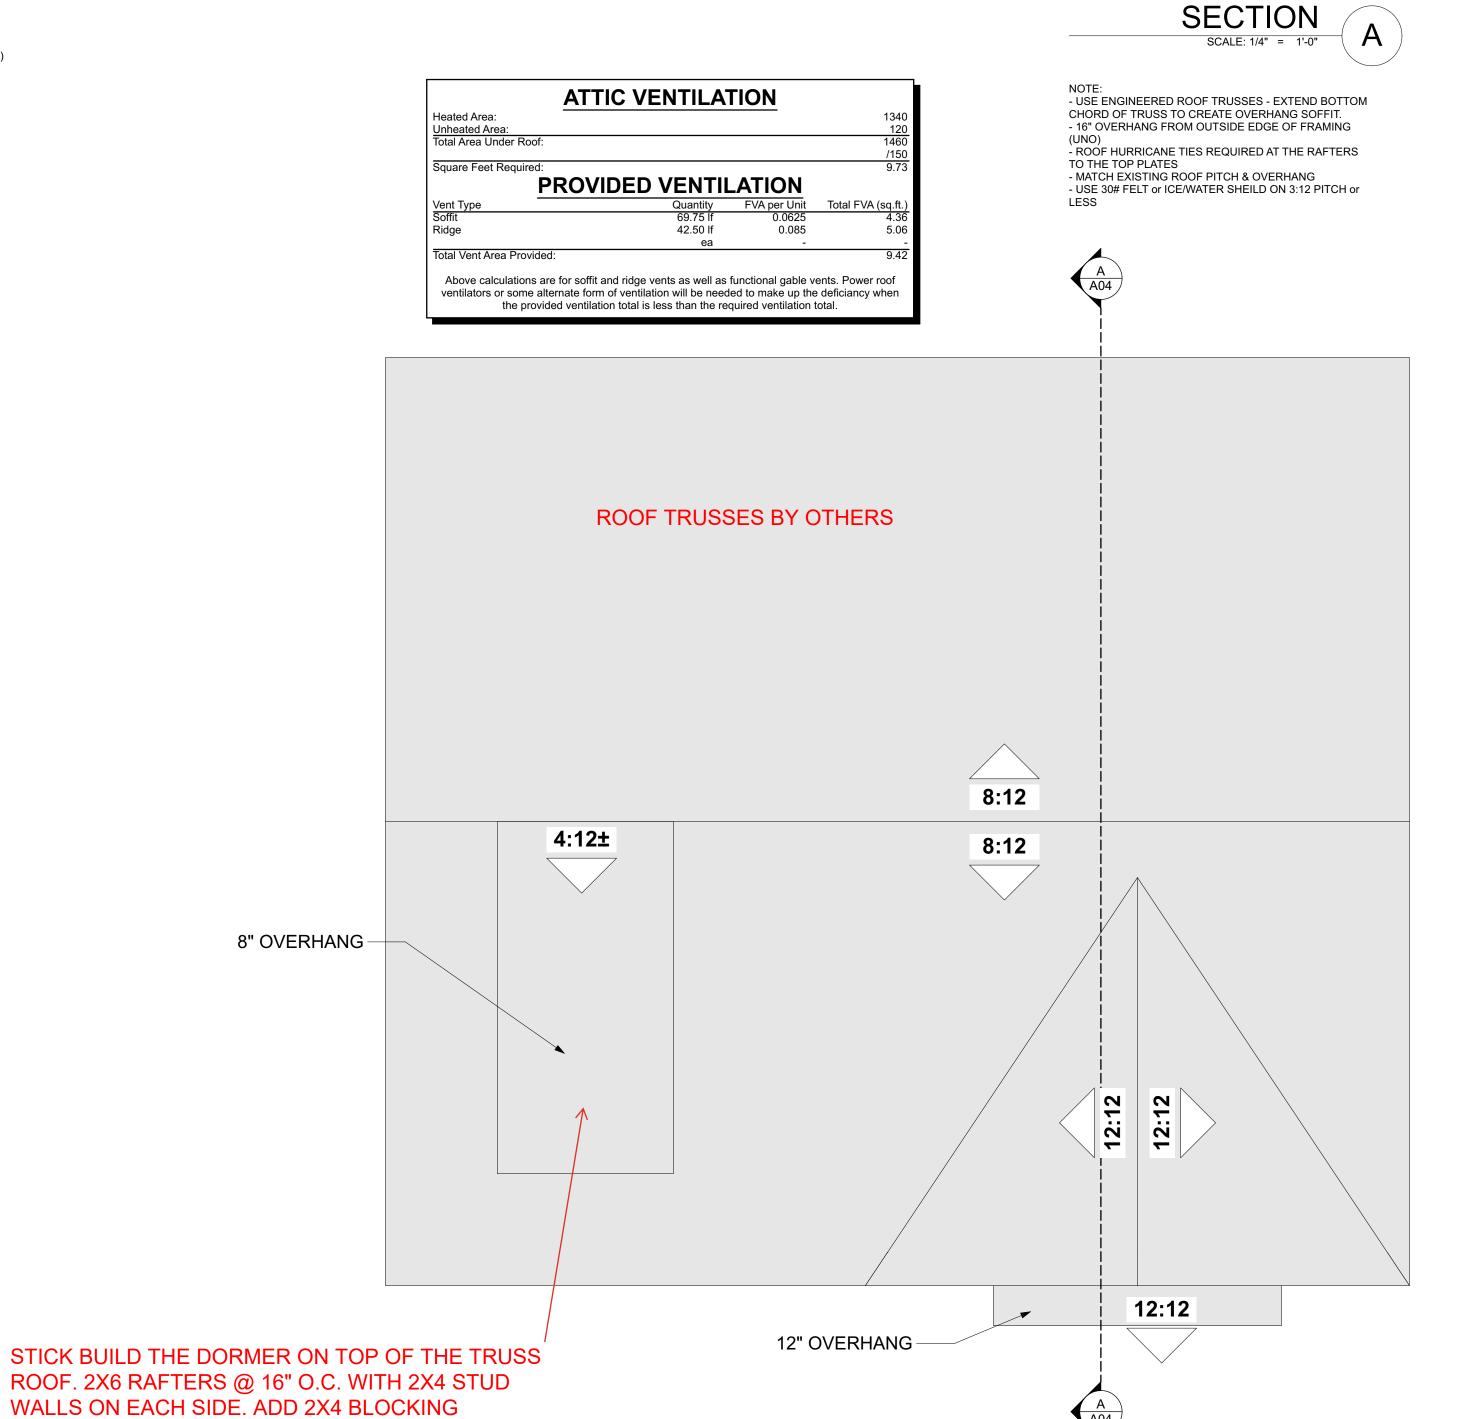



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DRAWN BY: MM

DESCRIPTION: NC/1 Story/2 Car

SHEET TITLE

ROOF PLAN

SCALE: 1/4" = 1'-0"

ROOF PLAN & SECTIONS

A04

