
THIS PLAN HAS BEEN DRAWN TO CONFORM TO THE 2018 NORTH CAROLINA RESIDENTIAL CODE

CONTRACTOR SHALL VERIFY ALL DIMENSIONS AND CONDITIONS PRIOR TO BEGGINING WORK. CONTRACTOR IS RESPONSIBLE FOR COMPLIANCE WITH ALL STATE AND LOCAL BUILDING CODES AND ORDINANCES. KADS CUSTOM HOME DESIGNS ASSUMES NO LIABILITY FOR SITE CONDITIONS, CONSTRUCTION METHODS OR ANY DEVIATION OF THESE PLANS.


NOT

NOTE:
ALL WINDOWS TO BE INSTALLED MUST MEET
A MAXIMUM OF .32 U VALUE OR BETTER, UNLESS
ENERGY CALCULATIONS ARE SUBMITTED WITH PLANS
PROVIDED BY BUILDER AT TIME OF PLAN REVIEW.

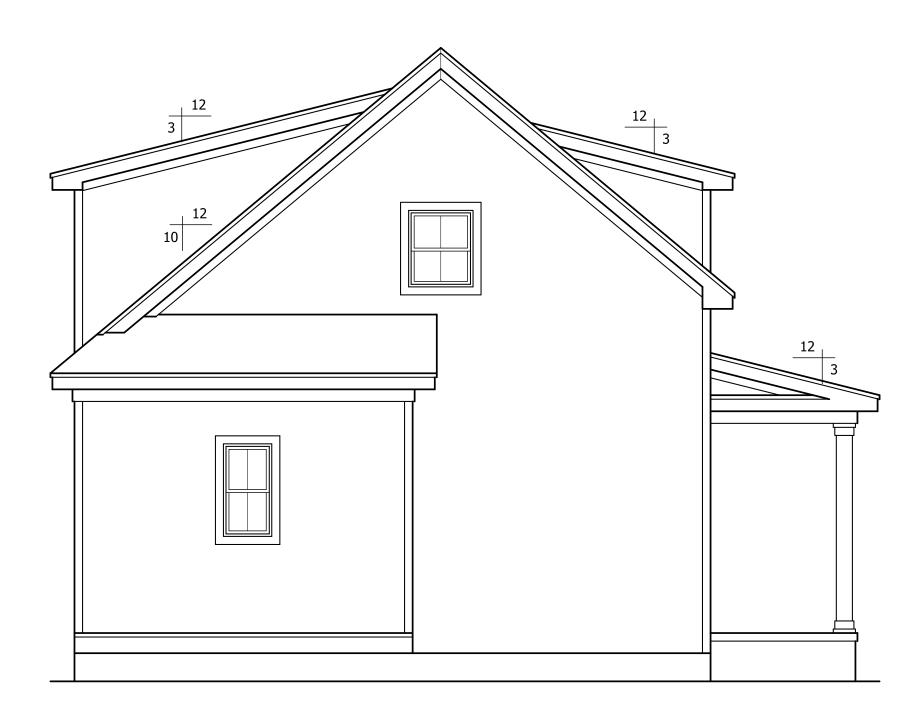


LEFT ELEVATION

SCALE: 1/4"=1'-0"

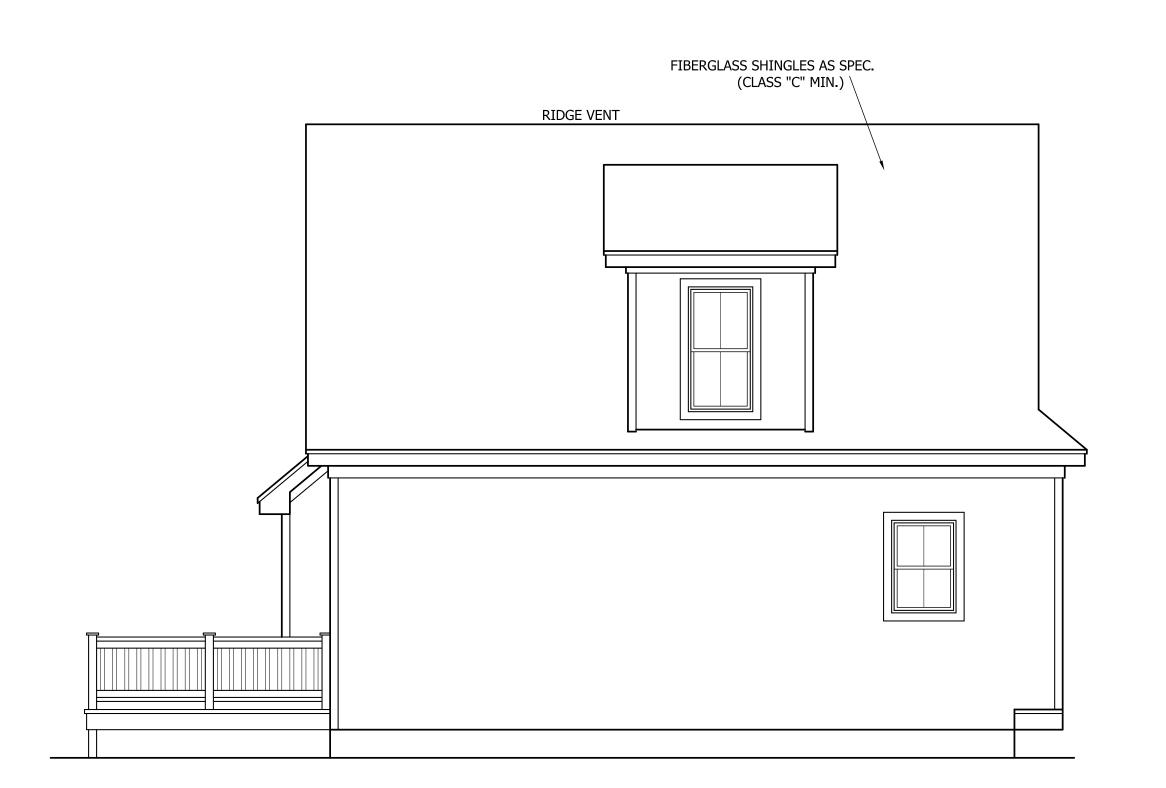

REAR ELEVATION

SCALE: 1/4"=1'-0"

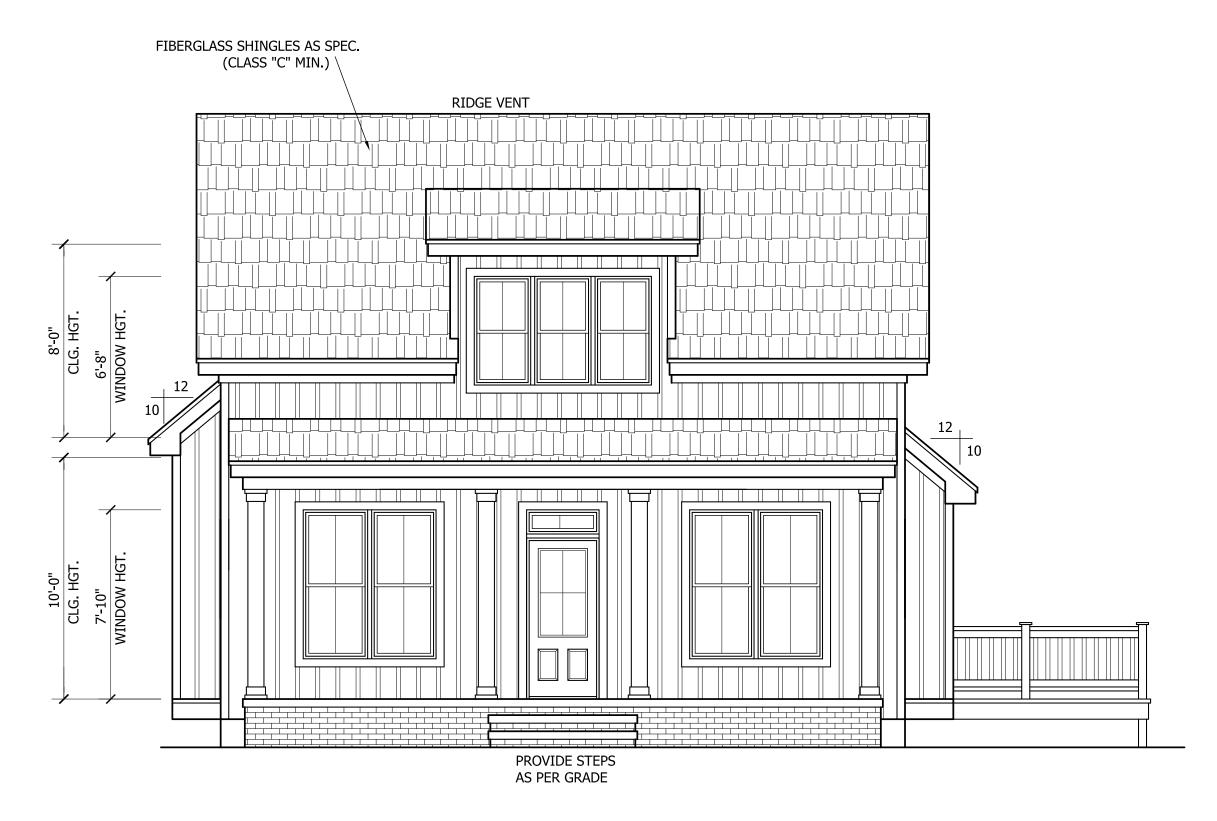

FRONT ELEVATION


SCALE: 1/4"=1'-0"



RIGHT ELEVATION

SCALE: 1/4"=1'-0"

TAYLOR RESIDENCE

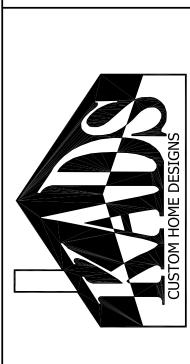

ANGIER, NC 919-369-7181

> DRAWN BY: D.W.O.


DATE: 2/9/23

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PLAN NO. DK1216



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DATE: 2/9/23

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HEATED
FIRST FLOOR HTD. SQ. FT. = 774
SECOND FLOOR HTD. SQ. FT. = 442

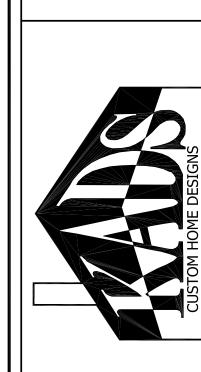= 1216


= 158 = 120

TOTAL HEATED SQ. FT.

UNHEATED FRONT PORCH SQ. FT. DECK SQ. FT.

OF

PLAN NO. DK1216

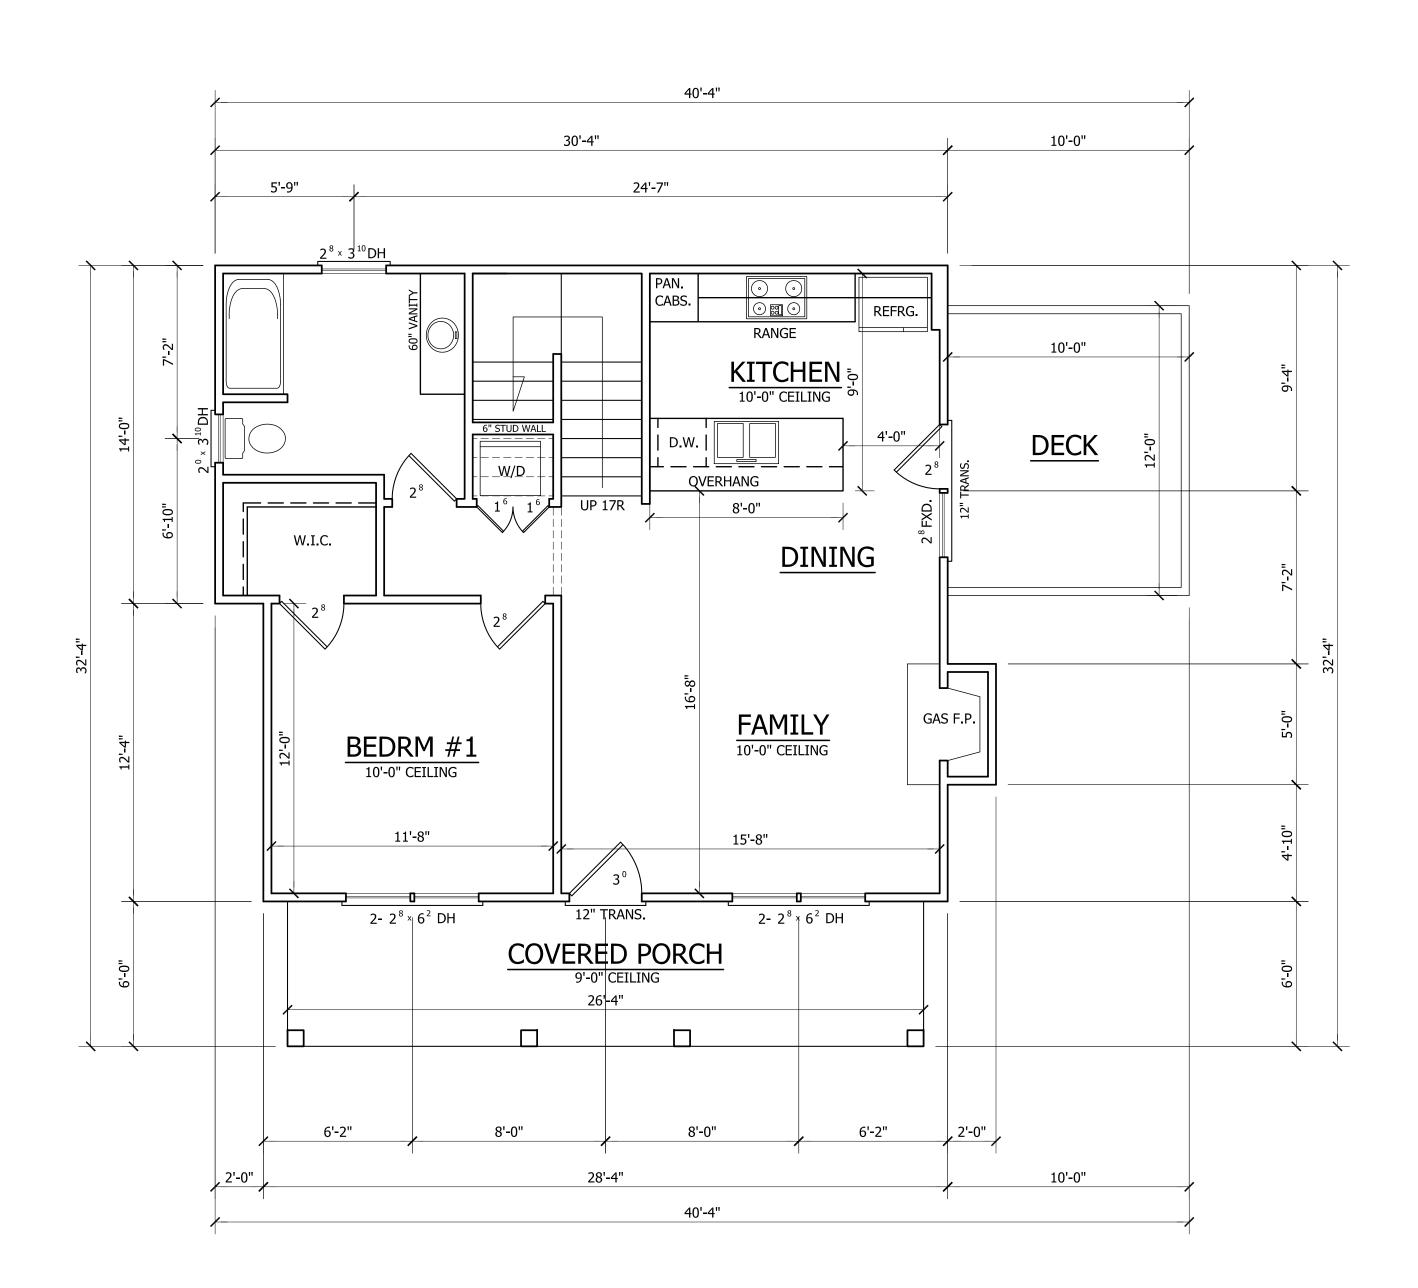

28'-4" 12'-4" 3'-10" 3'-10" 1/2 WALL 8'-0" CLG. BEDRM #2 5 CLOSET 8'-8" 3'-10" 3- 2⁴|× 4⁶ DH 4'-8" 4'-8" 28'-4"

FIRST FLOOR PLAN

SCALE: 1/4"=1'-0" 10'-0" CLG. HGT. SET WINDOWS AT 7'-10" A.F.F.

SECOND FLOOR PLAN

SCALE: 1/4"=1'-0" 8'-0" CLG. HGT. SET WINDOWS AT 6'-8" A.F.F.



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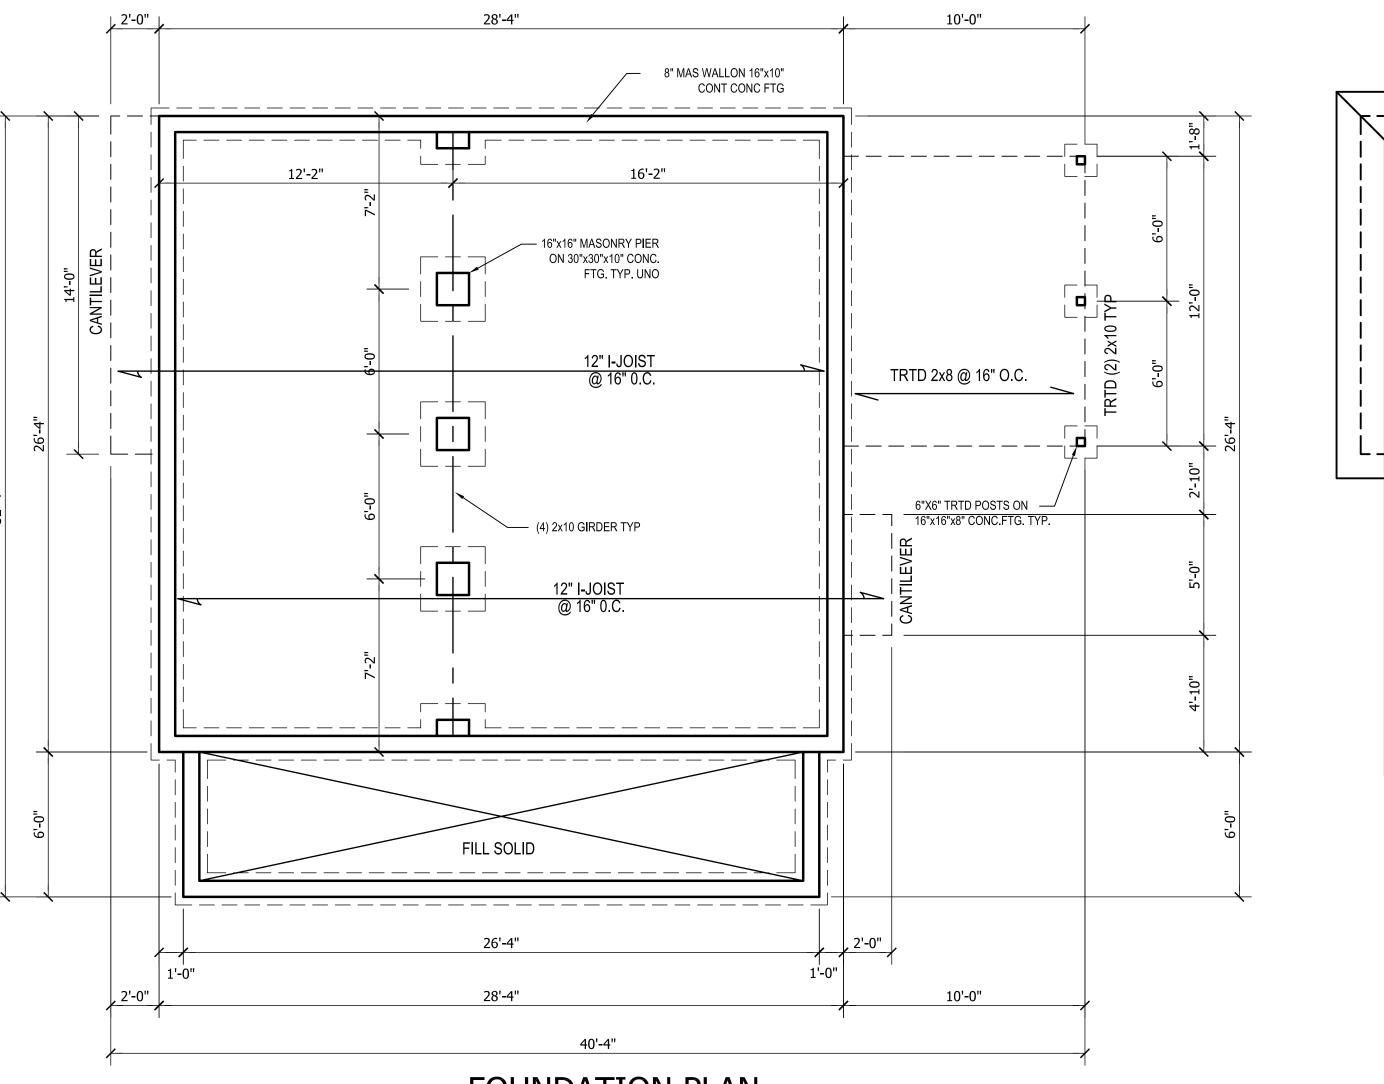
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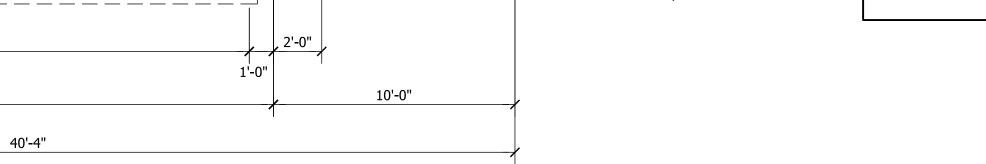
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3:12 PITCH

(2) 2x8

3:12 PITCH

3:12 PITCH

(3) 2x8

(2) 2x6

SCALE: 1/4"=1'-0"

SECOND FLOOR CLG. PLAN

8'-0" CLG.

42" KNEEWALL 2

ROOF PLAN

42" KNEEWALL

RAFTER SUPPORT

RAFTERS ON WALL

8'-0" WALL

10:12 PITCH

2x10 RIDGE w/ 2x4 CT @ 32" O.C.

RAFTER SUPPORT

DO NOT BREAK/SUPPORT


RAFTERS ON WALL


√42" KNEEWALL


8'-0" CLG.

10:12 PITCH


√42" KNEEWALL

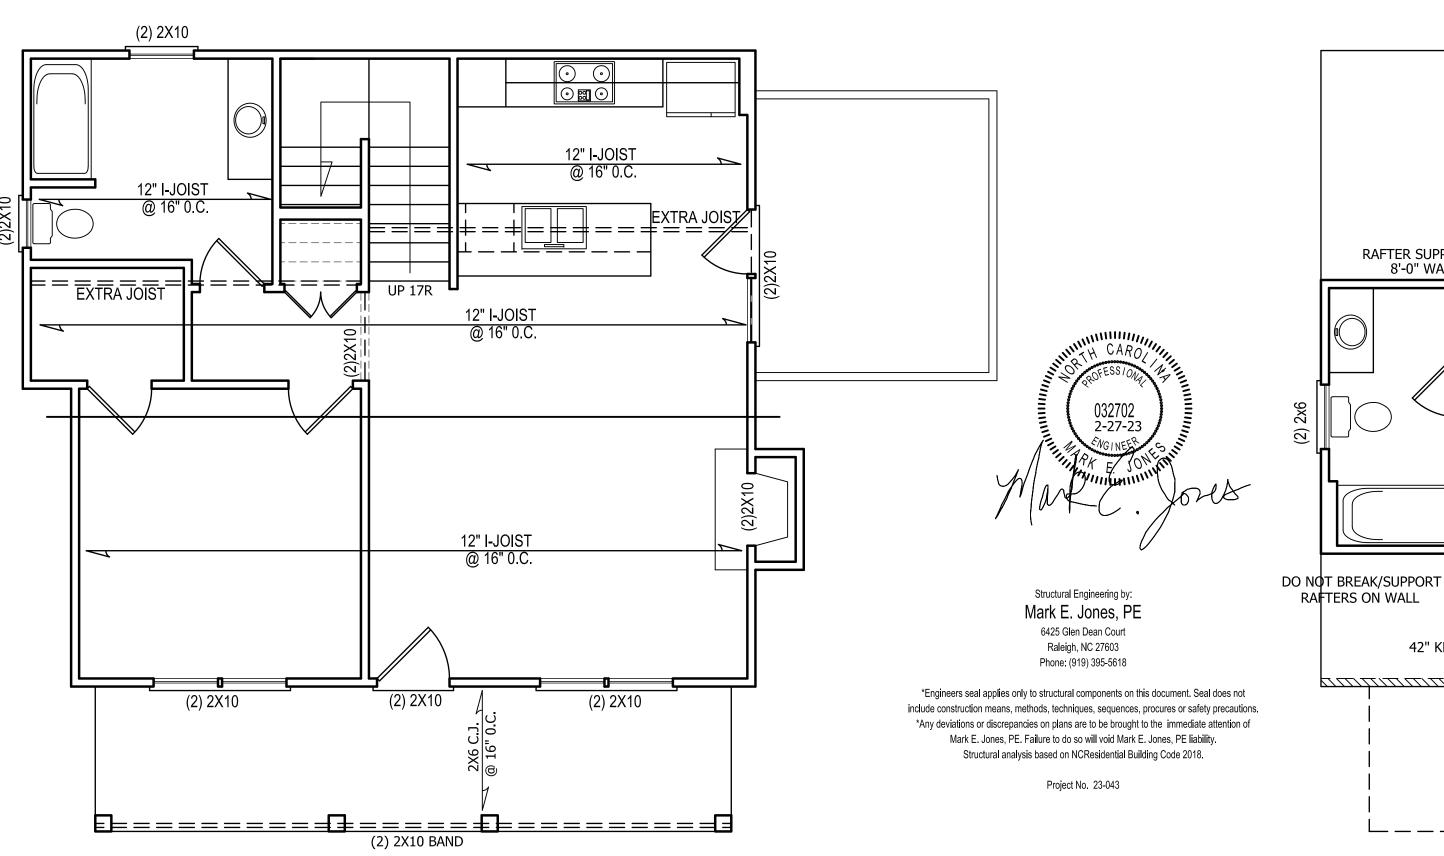

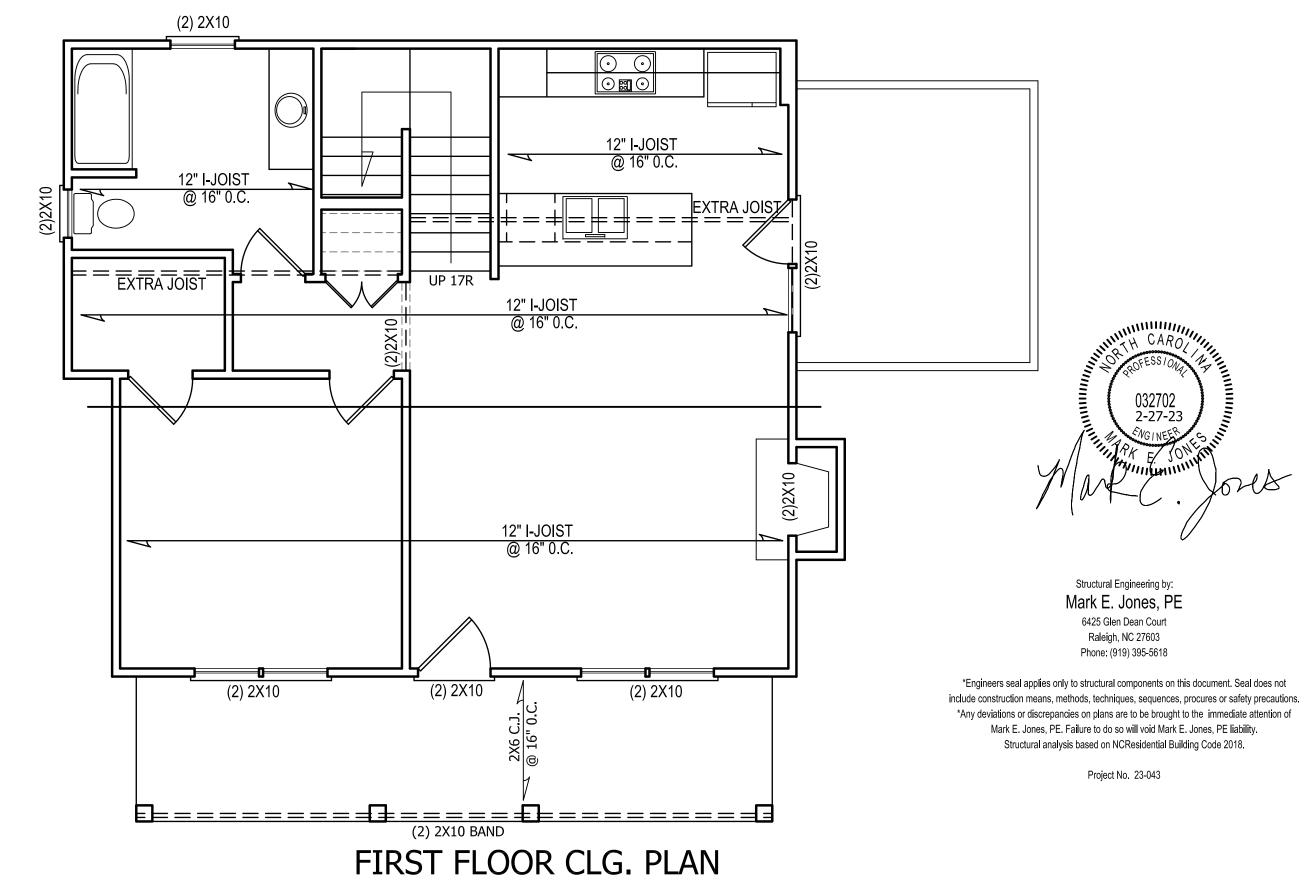

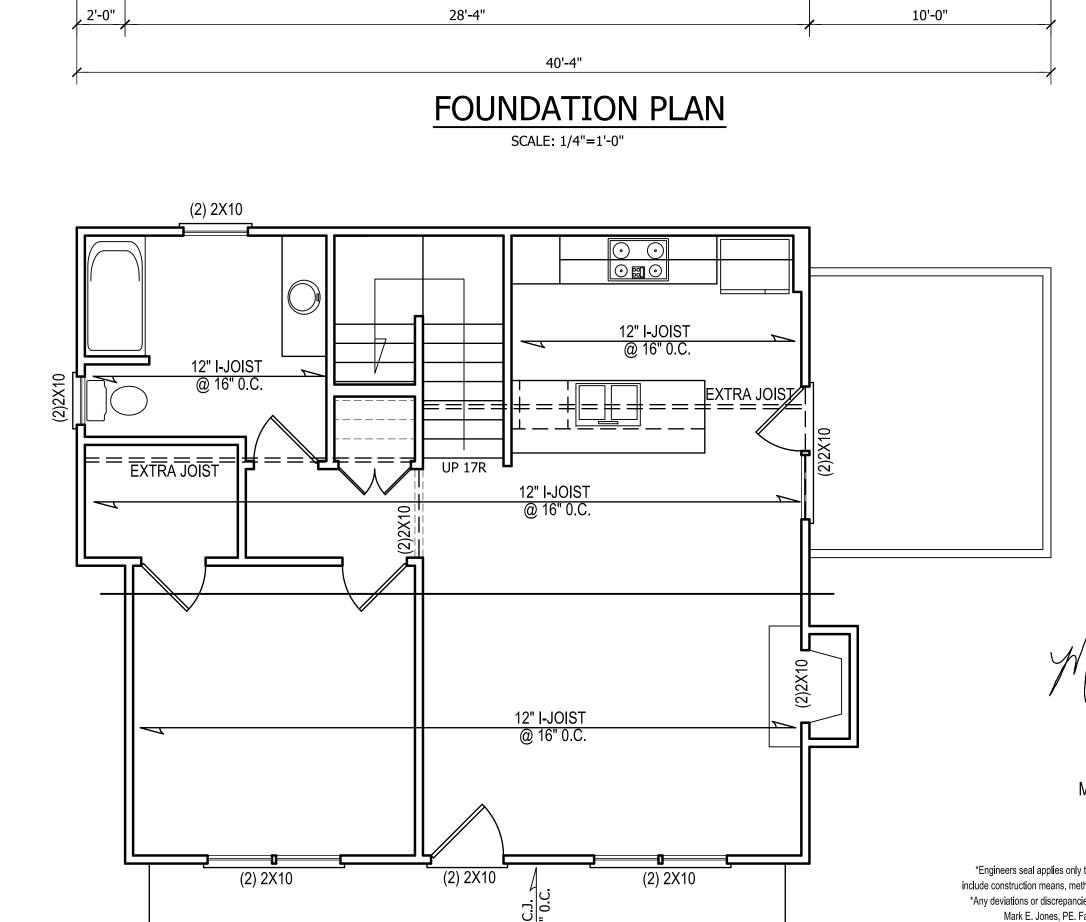

SCALE: 1/4"=1'-0"

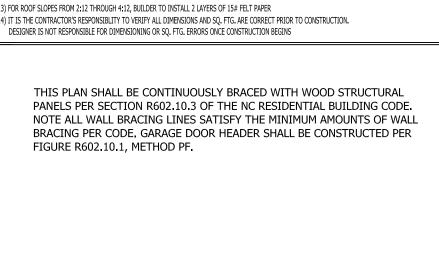

STRUCTURAL NOTES

1) ALL CONSTRUCTION SHALL CONFORM TO THE LATEST REQUIREMENTS OF "NORTH CAROLINA STATE 2018 RESIDENTIAL BUILDING CODE", IN ADDITION TO ALL LOCAL CODES AND REGULATIONS.

4) CONCRETE SHALL HAVE A MINIMUM 28 DAY STRENGTH OF 3000 PSI AND A MAXIMUM SLUMP OF FIVE INCHES UNLESS NOTED

5) MAXIMUM DEPTH OF UNBALANCED FILL AGAINST FOUNDATION WALLS TO BE LESS THAN 4-0" WITHOUT USING SUFFICIENT WALL BRACING. REFER TO SECTION R404 OF 2012 NC BUILDING CODE FOR BACKFILL LIMITATIONS BASED ON WALL HEIGHT,

') ALL LOAD BEARING HEADERS SHALL BE (2)2x10 (UNO). ALL WINDOW AND DOOR HEADERS SHALL BE SUPPORTED BY (1) JACK STUD AND (1) KING STUD AT EACH END UNLESS NOTED. ALL OTHER BEAMS SHALL BE SUPPORTED BY 2 STUDS OR THE AMOUNT OF STUDS REQUIRED FOR FULL BEARING AT EACH END UNLESS NOTED. POINT LOADS (STIFF KNEES, ETC.) SHALL CONSIST OF 2 STUDS UNLESS NOTED. ALL SUPPORTS OF 2 STUDS OR MORE SHALL BE TRANSFERRED THROUGH

8) ALL EXTERIOR WALLS TO BE SHEATHED WITH MIN. 7/16" WOOD STRUCTURAL PANELS FASTNED WITH 8D NAILS 6" O.C. AT EDGES AND 12" O.C. AT INT. SUPPORTS. BLOCKING SHALL BE INSTALLED IF LESS THAN 50 PERCENT OF THE WALL LENGTH IS SHEATHED. WHERE BLOCKING IS REQ'D, ALL PANELS SHALL BE FASTENED AT 3" O.C AT EDGES AND 6" O.C. AT)) ALL STRUCTURAL STEEL SHALL ASTM A-36. STEEL BEAMS SHALL BE SUPPORTED AT EACH END WITH A MINIMUM BEARING LENGTH OF 3-1\2" INCHES AND FULL FLANGE WIDTH. PROVIDE SOLID BEARING FROM BEAM SUPPORT TO FOUNDATION. BEAMS SHALL BE ATTACHED TO EACH SUPPORT WITH TWO LAG SCREWS (1/2 DIAMETER AND 4" LONG). LATERAL SUPPORT IS CONSIDERED ADEQUATE PROVIDING THE JOISTS ARE TOE NAILED TO THE SOLE PLATES, AND THE SOLE PLATES ARE NAILED

10) ANCHOR BOLT PLACEMENT PER SECTION R403.1.6. 1/2" DIAMETER ANCHOR BOLTS SPACED AT 6-0" O/C AND PLACED

1) FOUNDATION DRAINAGE-DAMP PROOFING OR WATERPROOFING PER SECTION 405 AND 406 OF 2012 NC BUILDING CODE

12) WALL AND ROOF CLADDING VALUES:
WALL CLADDING SHALL BE DESIGNED FOR A 24.1 SQ.FT. OR GREATER POSITIVE AND NEGATIVE PRESSURE
ROOF VALUES BOTH POSITIVE AND NEGATIVE SHALL BE AS FOLLOWS:

2) DESIGN LOADS:

MINIMUM ALLOWABLE SOIL BEARING PRESSURE = 2000 PSF

WALL THICKNESS, SOIL TYPE, AND UNBALANCED BACKFILL HEIGHT

EACH FLOOR TO THE FOUNDATION.

OR BOLTED TO THE BEAM FLANGES @ 48" O.C.


12" FROM THE END OF EACH PLATE SECTION

45.5 LBS/SQFT FOR ROOF PITCHES OF 0/12 TO 2.25/12 34.8 LBS/SQFT FOR ROOF PITCHES OF 2.25/12 TO 7/12 21.0 LBS/SQFT FOR ROOF PITCHES OF 7/12 TO 12/12

** MEAN ROOF HEIGHT 30' OR LESS

6) ALL FRAMING LUMBER SHALL BE SYP #2 (Fb = 800 PSI) UNO. ALL FRAMING LUMBER EXPOSED TO THE ELEMENTS SHALL BE TREATED MATERIAL.



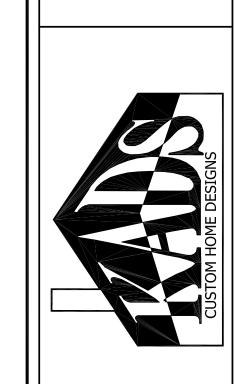

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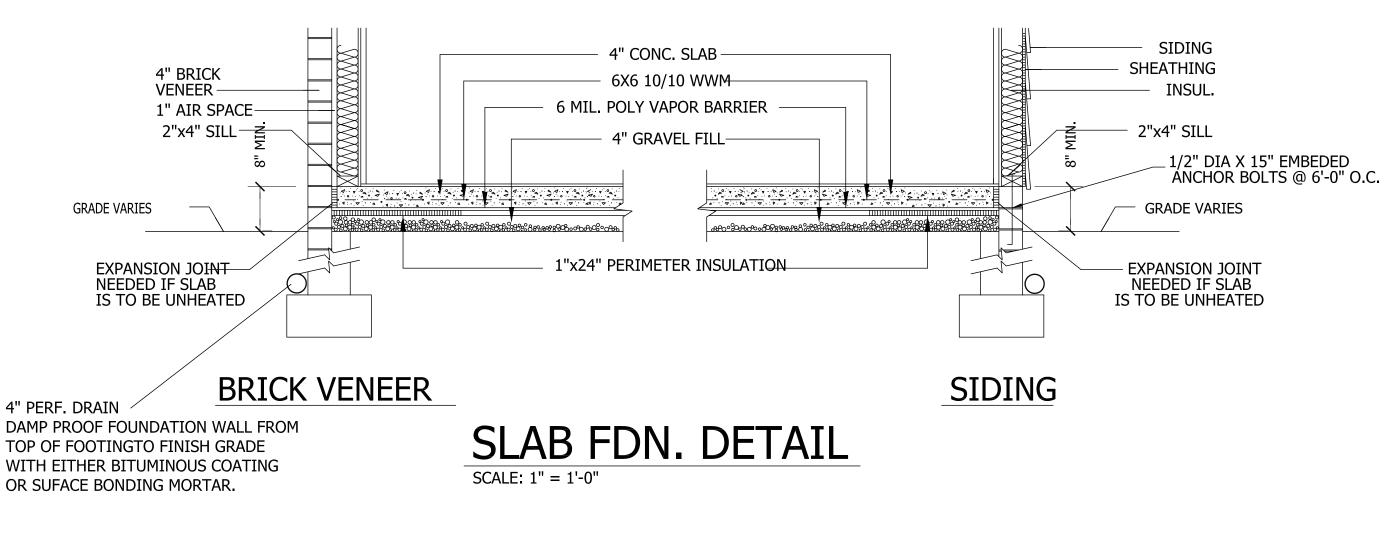
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REQUIRED GUARDS SHALL NOT HAVE OPENINGS FROM

HEIGHT WHICH ALLOW

1" MAX. NOSE PROJECTION

THE WALKING SURFACE TO THE REQUIRED GUARD

PASSAGE OF A SPHERE 4" IN

9" | MIN.

FIRESTOPPING:

handrail height and below the required headroom height.

on either side of the stairway and the minimum clear width

of the stairway at and below the handrail height, including

treads and landings, shall not be less than 31-1/2 inches where

Stairways shall not be less than 36 inches


in clear width at all points above the permitted

Handrails shall not project more than 4.5 inches

a handrail is installed on one side and 27 inches

where handrails are provided on both sides

STAIR DETAIL

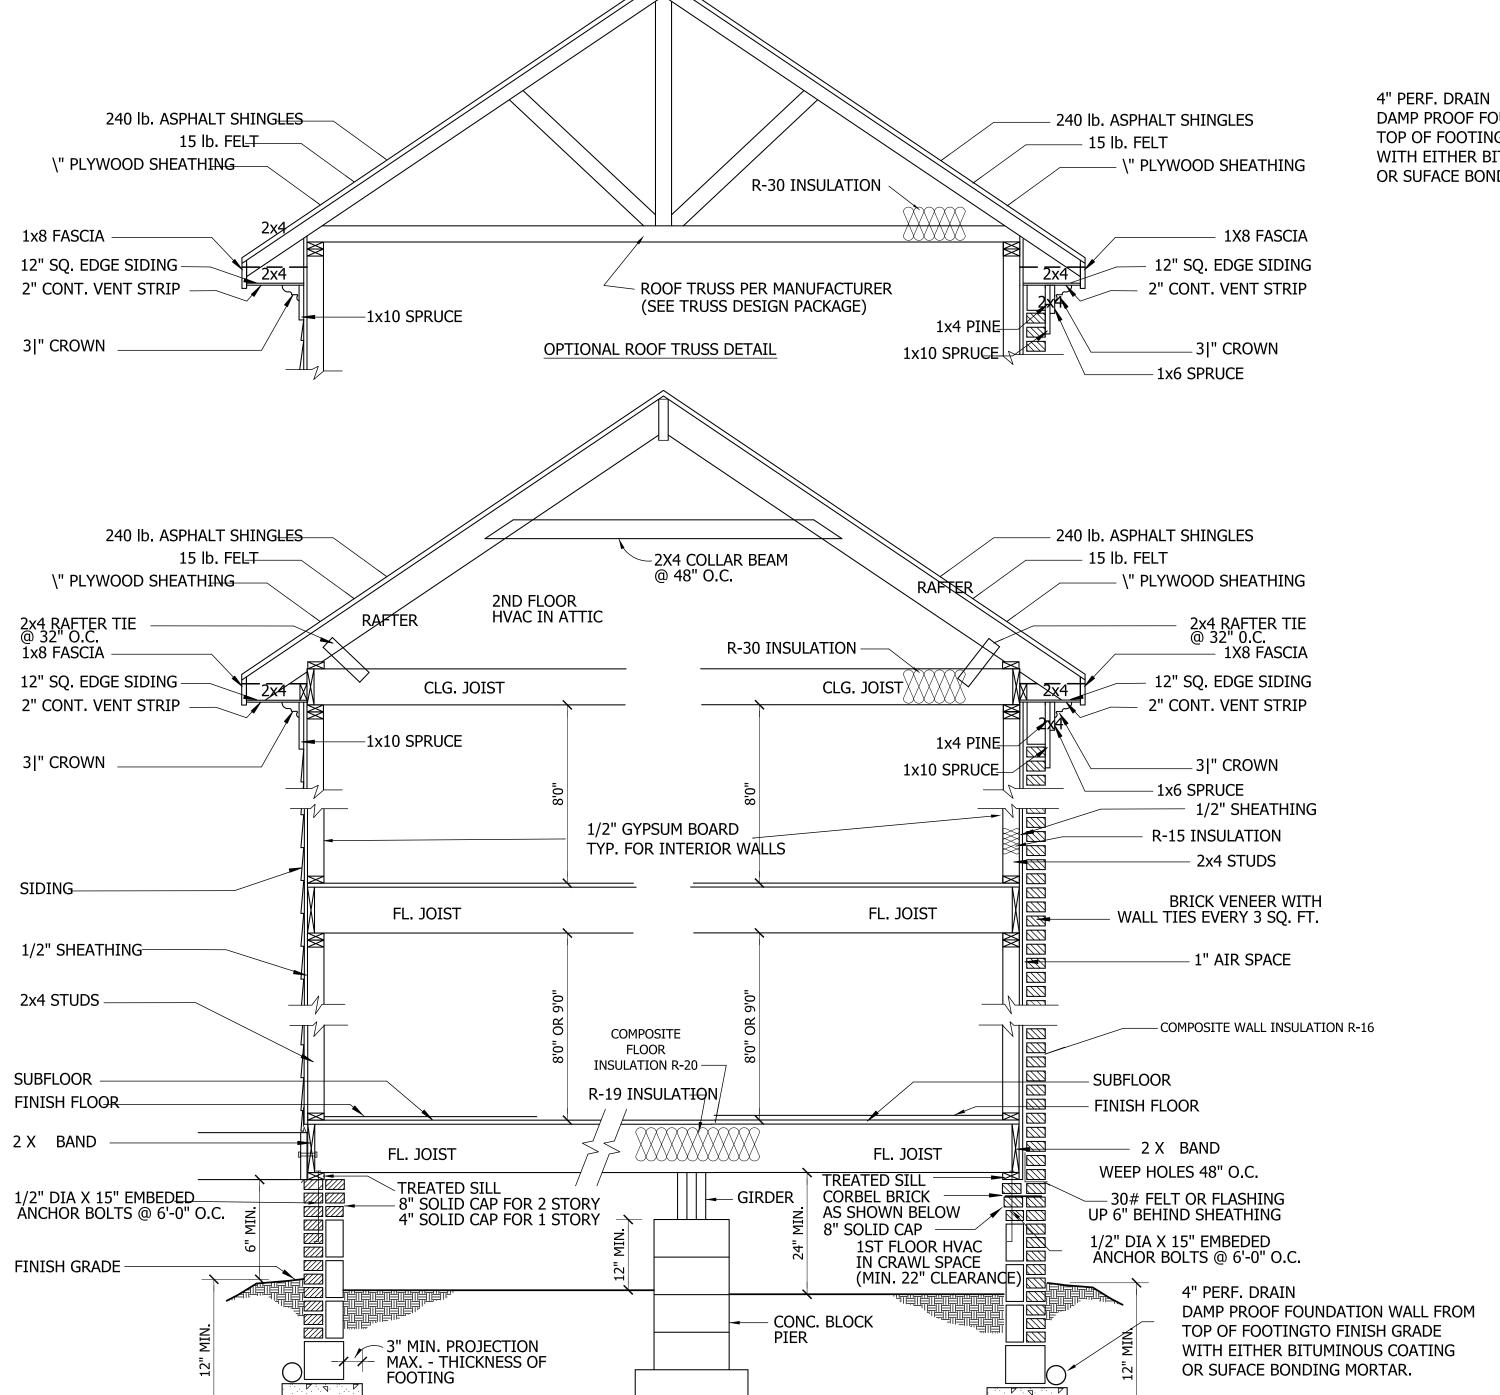


PROVIDE AT LEAST 1.0 SQ. FT. NET FREE VENTILATION AREA FOR EACH 150 SQ. FT. OF CRAWL SPACE. CRAWL SPACE AREA = 774 SQ.FT. 774/150 = 5.16 SQ. FT. REQ'D. REDUCE REQUIRED AREA TO 1.0 SQ. FT NET FREE VENTILATION AREA FOR EACH 1,500 SQ. FT. OF CRAWL SPACE WITH APPROVED VAPOR BARRIER. PROVIDE (1) VENT WITHIN 3'-0" OF EACH REFER TO MANUFACTURER SPECIFICATIONS FOR ACTUAL VENTS USED TO DETERMINE NUMBER OF VENTS REQUIRED.

CRAWL SPACE VENTILATION


ROOF VENTILATING REQUIREMENTS = <u>6.22</u> SQ. FT. REQ'D

ROOF VENTILATING REQUIREMENTS (POWER ROOF VENTILATOR REQUIRED) = <u>3.11</u> SQ. FT. REQ'D

BUILDER TO PROVIDE APPROPRIATE VENTILATING AS REQUIRED.

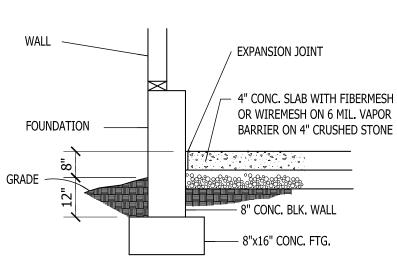

GARAGE SLAB

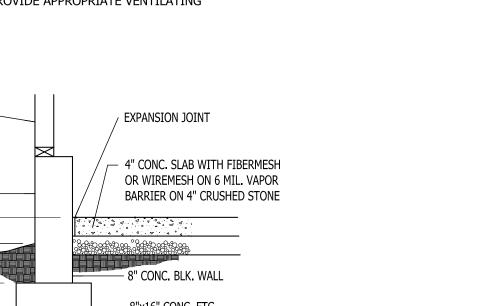

WALL SECTION SCALE: \" = 1'-0"

BRICK SECTION

SIDING SECTION