
HOUSE ADDITION FOR WILSON RESIDENCE

3008 RAWLS CHURCH ROAD FUQUAY-YARINA 27526

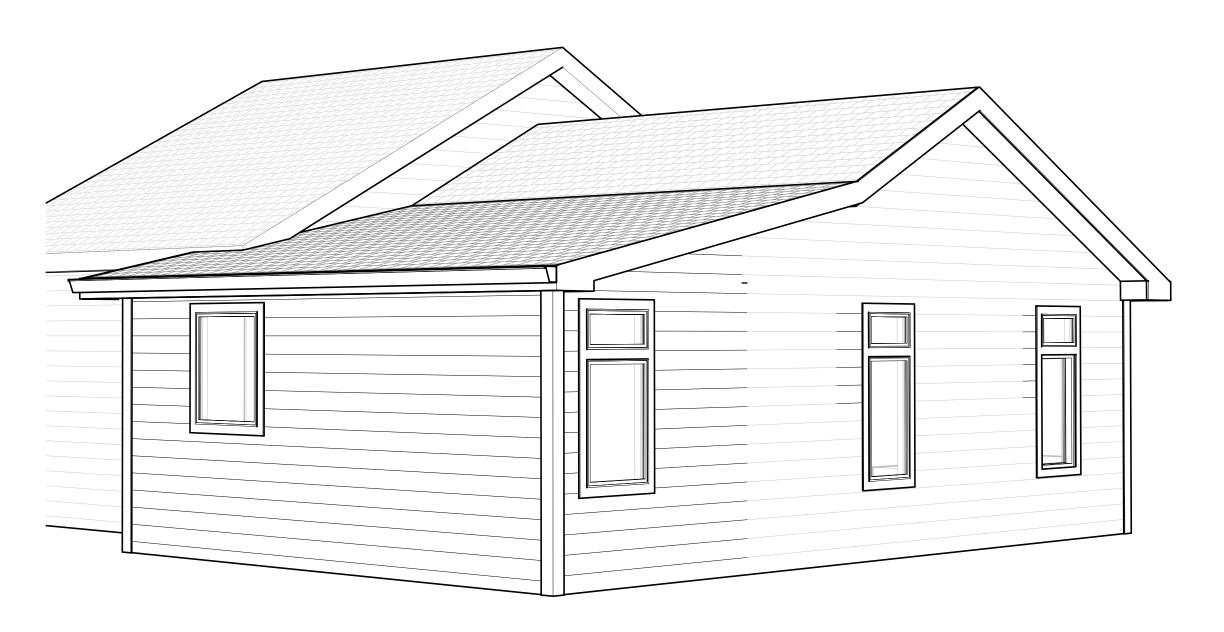

AREA TABULATION 96 SQUARE FEET HEATED -UNHEATED -N/A SQUARE FEET EXISITNG ADDITION 335 SQUARE FEET UNHEATED -N/A SQUARE FEET 431 SQUARE FEET N/A SQUARE FEET * AREA IS MEASURED TO INSIDE OF STUDS.

FRONT PERSPECTIVE



REAR PERSPECTIVE

INDEX OF DRAWINGS

SHEET NUMBER	SHEET NAME	ISSUE DATE REVISION
Cl	COVER SHEET	OT-2T-23
Δl	ASBUILT PLAN / DEMO PLAN / PLOT PLAN	<i>0</i> 7-27-23
A2	FLOOR PLAN / ROOF PLAN / EXTERIOR ELEVATIONS	<i>0</i> 7-27-23


GENERAL NOTES

- ALL INTERIOR DIMENSIONS ARE FROM WALL STUD TO WALL STUD & TO CENTERLINE OF OPENING, U.NO. ALL DIMENSIONS REFERENCED HEREIN ARE IMPERIAL STANDARD, U.N.O.
- ALL EXTERIOR DIMENSIONS ARE FROM FACE OF SHEATHING, FACE OF CONCRETE, FACE OF CMU., OR TO CENTERLINE OF
- EXTERIOR DOORS AND WINDOWS ARE DIMENSIONED TO CENTERLINE.
- FOOTINGS, FOUNDATION WALLS, SUPPORT COLUMNS AND/OR PIERS ARE TO BE CONSTRUCTED TO LOCAL CODE AND SOIL REQUIREMENTS, CONTRACTOR TO PROVIDE STRUCUTRAL AND SOIL INFORMATION IF REQUIRED BY LOCAL CODES. CONTRACTOR TO VERIFY EXISTING FOUNDATION CONDITIONS PRIOR TO CONSTRUCTION.
- CONTRACTOR TO VERIFY ALL DIMENSIONS AND LOADS PRIOR TO CONSTRUCTION. PENETRATIONS THROUGH THE FOUNDATION OR PERIMETER FLOOR FRAMING OF THE BUILDING, FOR INSTALLATIONS OF

EQUIPMENT, TOILET ACCESSORIES, FURNISHINGS, FURNITURE / EQUIPMENT, AND SIMILAR CONSTRUCTION.


- PIPES, YENTS, ETC. SHALL BE IN ACCORDANCE WITH LOCAL REQUIREMENTS. DO NOT SCALE DIMENSIONS FROM PRINTS. USE DIMENSIONS GIVEN OR CONSULT DESIGNER FOR FURTHER CLARIFICATION.
- ALL POSTS AND EXTERIOR FRAMING TO BE MININUM #2 GRADE, PRESSURE TREATED WOOD. EXTERIOR WALLS TO BE BRACED PER TABLE R602.10.1 OF THE NC IRC BUILDING CODE.
- ALL NOMINAL LUMBER TO BE #2 SOUTHERN YELLOW PINE AND ALL LUMBER IN CONTACT WITH GRADE, EXPOSED, OR CONCRETE SLAB TO BE PRESSURE TREATED. PROVIDE SUPPLEMENTAL FRAMING, METAL BLOCKING / STRAPPING AND BRACING AS REQ'D FOR SUPPORT OF FIXTURES,

YICINITY MAP

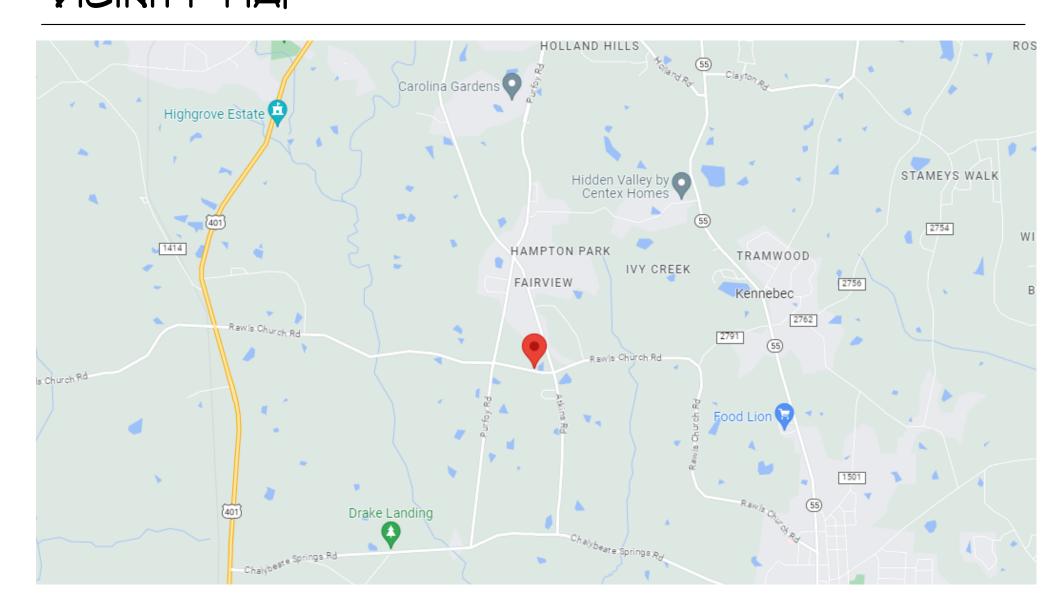

07-27-23 AS NOTED Project Number: 230101

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07-27-23 AS NOTED

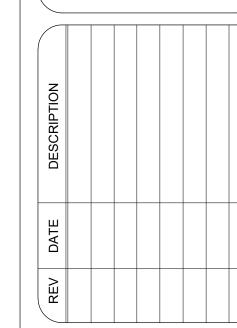Project Number: 230101 **A**1

DEMOLITION NOTES:

- I. CONTRACTOR TO FIELD YERIFY EXISTING CONDITIONS BEFORE CONSTRUCTION BEGINS. CONTRACTOR SHALL CHECK, AND IDENTIFY ALL EXISTING WATER, SANITARY AND ELECTRIC LINES WHICH ARE TO REMAIN AND BE PROTECTED FROM DAMAGE DURING DEMOLITION AND ALTERATION OF
- 2. CONTRACTOR SHALL EXCERCISE EXTREME CARE WHEN PENETRATING EXISTING WALLS OR FLOOR/CEILING SLABS SO STRUCTURAL INTEGRITY OF SUCH ELEMENTS IS NOT DEGRADED. CONTRACTOR SHALL RESTORE EXISTING SURFACES SCHEDULED TO REMAIN THAT ARE AFFECTED BY SCOPE
- OF WORK, 3. PATCH AND REPAIR ALL EXISTING SURFACES DAMAGED BY DEMOLITION AND/OR INSTALLATION OF NEW WORK AND/OR UTILITES, AS REQUEIRED TO MATCH ADJACENT SURFACES AND/OR TO RECEIVE NEW SCHEDULED FINISHES. 4. DEMOLISH AND REMOVE EXISTING CONDITIONS AS SHOWN BY DASHED LINES/
- OR AS NOTED, U.N.O. REFER TO DEMOLITION LEGEND. 5. CONTRACTOR SHALL CHECK AND VERIFY ALL NOTES AND DIMENSIONS
- BEFORE PROCEEDING WITH WORK. 6. CONTRACTOR TO BUILD EXISTING WALL UP TO EXISTING TOP PLATE HEIGHT. CONTRACTOR TO FIELD YERIFY EXISTING CONDITIONS BEFORE CONSTRUCTION BEGINS, CONTRACTOR TO STRIP EXISTING EXTERIOR SIDING
- OF EXISTING WALL AND PREP FOR NEW EXTERIOR SIDING. 7. ONLY ITEMS DEMOLISHED IN NON-SHADED AREA ARE ITEMS THAT ARE NOTED TO BE DEMOLISHED OR SHOW A DEMOLITION SYMBOL. EVERYTHING ELSE IN NON-SHADED AREA SHALL REMAIN.

NOTE: ALL ITEMS SHOWN AS DASHED LINES OR HATCH PATTERN TO BE


THE PROPERTY OF THE PROPERTY O

DEMOLITION PLAN

Scale: 1/4" = 1'-0"

DEMOLISHED

DEMOLITION LEGEND				
SYMBOL	DESCRIPTION			
	EXISTING WALLS TO REMAIN			
	ITEM TO BE DEMOLISHED			
	ITEM TO BE DEMOLIGHED			

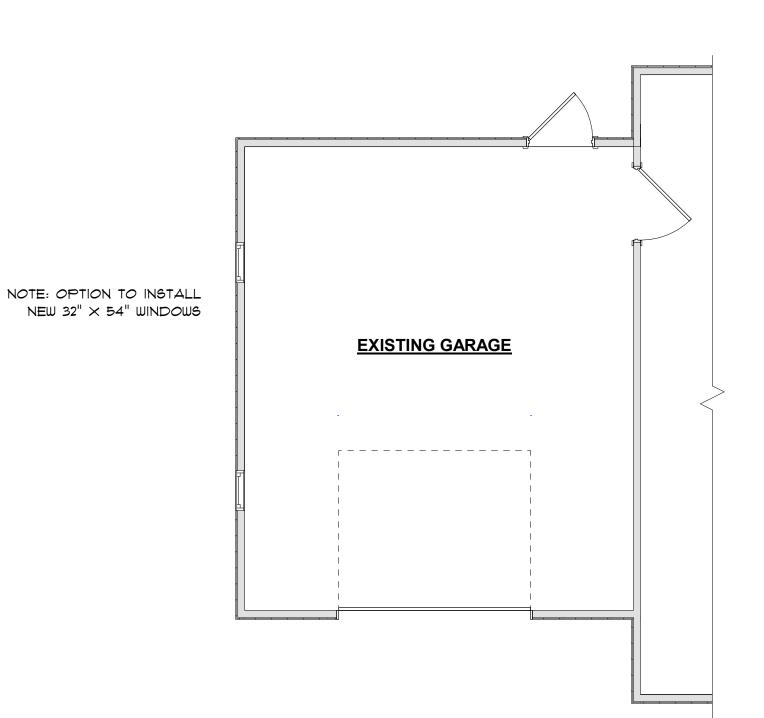



253'-3"

17'-0"

DETACHED STRUCTURE

MAIN SERVICE

- PROPERTY BOUNDARY

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ROOF PLAN NOTES

- 1. ROOF DIMENSIONS ARE TAKEN FROM EXTERIOR FACE OF WALL TO EXTERIOR EDGE OF
- 2. VERIFY LOCATIONS OF ALL ROOF PENETRATIONS WITH STRUC., MECH, AND PLUMBING DWGS.
- 3. IT IS THE CONTRACTOR 'S RESPONSIBILITY TO VERIFY, COORDINATE AND /OR INSTALL ALL ADJACENT AND/OR RELATED FLASHINGS, BLOCKING, NAILERS, INSULATION STOPS, CRICKETS, ETC. NECESSARY FOR THE COMPLETE INSTALLATION OF THE ROOF MEMBRANE WHICH ARE REQUIRED FOR A COMPLETE, WARRANTED, WATERTIGHT, WATERPROOF INSTALLATION.
- 4. ROOF DRAINAGE IS CALCULATED FOR A 100-YEAR, 1-HR. RAINFALL AS REQUIRED BY THE NCIBC PLUMBING CODE FOR PRIMARY ROOF DRAINS (FIGURE 1106.1(a).
- 5. CONDUCTORS, DOWNSPOUTS, & SCUPPERS TO BE LOCATED BY CONTRACTOR IN FIELD.

ATTIC VENTILATION

<u>R806.2 MINIMUM VENT AREA</u>

TOTAL NET FREE VENTILATING AREA RATIO = 1/150.

TOTAL ATTIC AREA (SF). = 2341 (SF)


203 (SF) / 150 = 1.3 (SF) OF TOTAL NET FREE AREA


1.3 (SF) / 2 = .67 (SF) OF INTAKE NET FREE AREA & .67 (SF) OF EXHAUST NET FREE AREA


.67 (SF) \times 144 = 96 (SQ. IN.) OF INTAKE NET FREE ARE & 96 (SQ. IN.) OF EXHAUST NET FREE AREA.


MINIMUM EAVE VENT PER UNIT = (2) PIECES OF 12" X 12' PERFORATED EAVE VENT.

MINIMUM EAVE VENT PER UNIT = (2) PIECES OF 6" X 12' PERFORATED EAVE VENT.

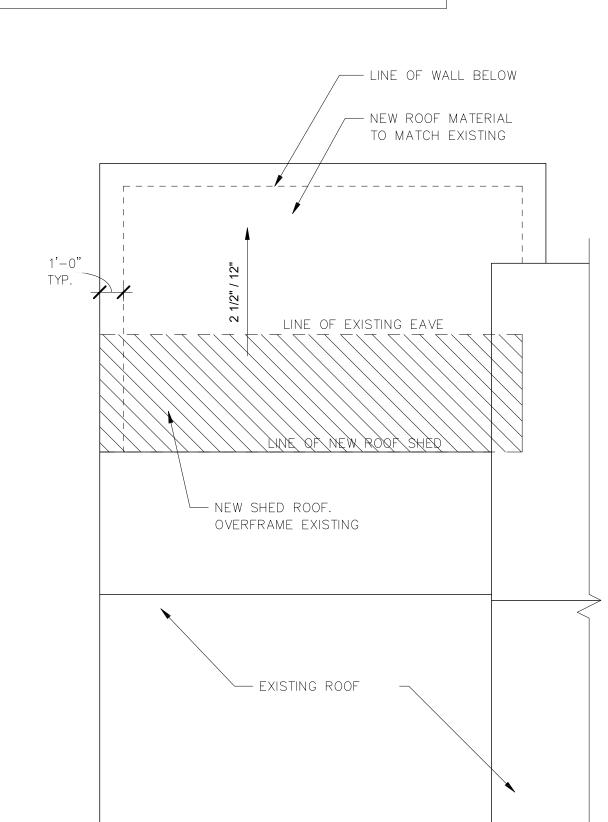

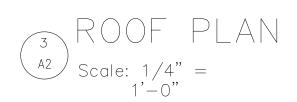

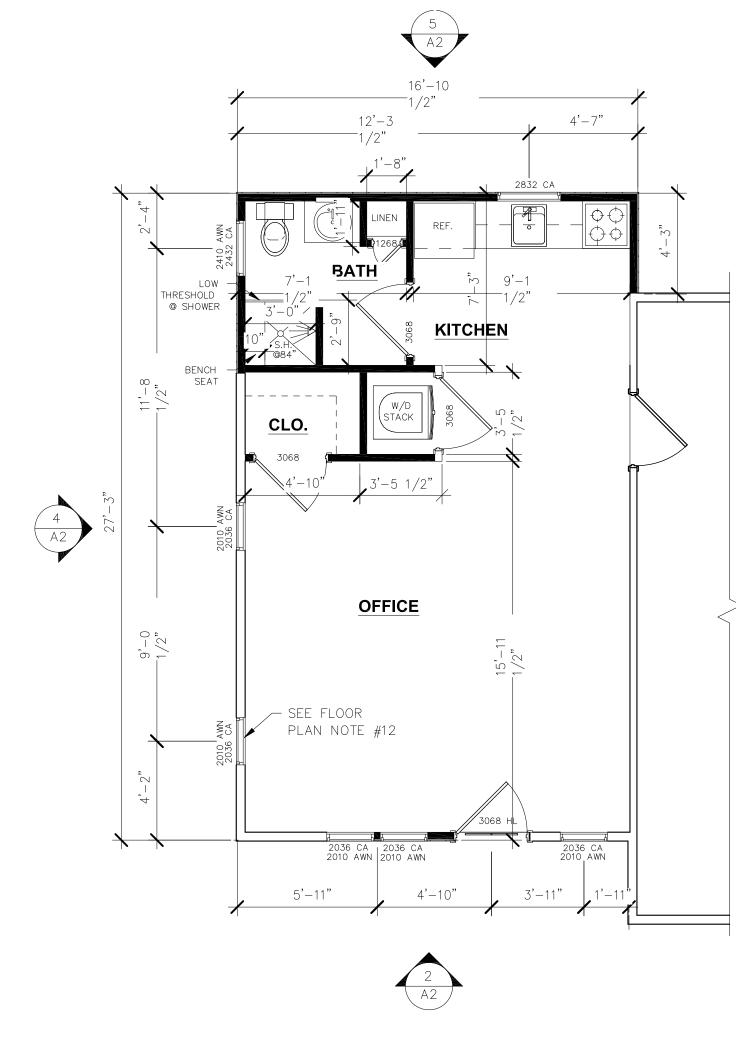

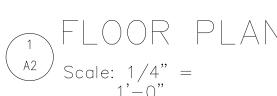




FLOOR PLAN NOTES

- 1. ALL INTERIOR DIMENSIONS ARE FROM WALL STUD TO WALL STUD & TO CENTERLINE OF OPENING, U.NO. ALL DIMENSIONS REFERENCED HEREIN ARE IMPERIAL STANDARD, U.N.O.
- 2. ALL EXTERIOR DIMENSIONS ARE FROM FACE OF SHEATHING, FACE OF CONCRETE, FACE OF CMU., OR TO CENTERLINE OF
- EXTERIOR DOORS AND WINDOWS ARE DIMENSIONED TO CENTERLINE.
 - WALL ANGLES ARE PARALLEL, PERPENDICULAR OR 45 DEGREE ANGLES TO BUILDING PERIMETER UNLESS NOTED
- DO NOT SCALE DIMENSIONS FROM PRINTS. USE DIMENSIONS GIVEN OR CONSULT DESIGNER FOR FURTHER CLARIFICATION. ALL INTERIOR WALLS AT BATHROOMS ARE TO BE INSULATED WITH SOUND BATT INSULATION.
- MIN. R-13 BATT INSULATION TO BE PROVIDED TO ALL EXTERIOR WALLS U.N.O.
- PROVIDE WATER RESISTANT GYPSUM WALL BOARD AT ALL WET WALLS INCLUDING, BUT NOT LIMITED TO WALLS AT BATHROOMS AND KITCHEN.
- PROVIDE SUPPLEMENTAL FRAMING, METAL BLOCKING / STRAPPING AND BRACING AS REQ'D FOR SUPPORT OF FIXTURES,
- EQUIPMENT, TOILET ACCESSORIES, FURNISHINGS, FURNITURE / EQUIPMENT, AND SIMILAR CONSTRUCTION. 10. ALL DOORS TO BE POSITIONED WITH MIN. 2" GAP BETWEEN DOOR FRAME AND ADJACENT WALL UNLESS DIMENSIONED
- OTHERWISE. 11. ALL WALLS AT TUB & SHOWER TO RECEIVE WALL TILE.
- 12. ALL NEW WINDOWS ARE TO BE PELLA BRAND.





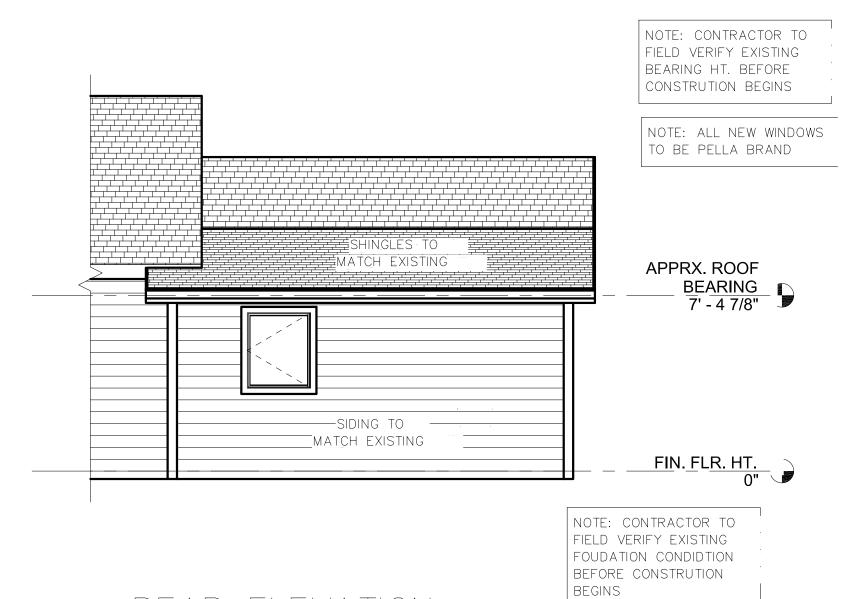

 $\begin{array}{c}
5 \\
A2
\end{array}$ Scale: 1/4" = 1'-0"

DESIGNS

PLAN / ROOF PLAN / EXTERIOR ELEVATIONS


07-27-23 AS NOTED


Title Sheet: FLOOR


Project Number: 230101

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FOUNDATION PLAN

STRUCTURAL PLAN

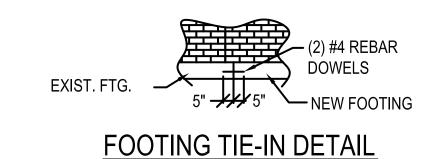
STRUCTURAL NOTES

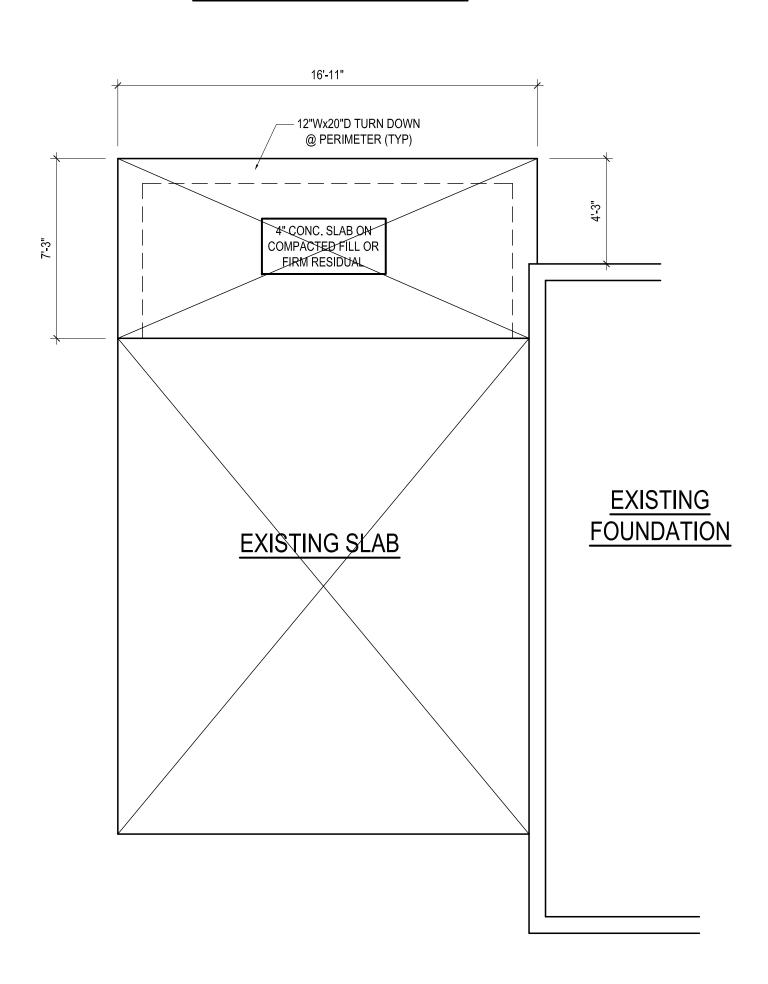1) ALL CONSTRUCTION SHALL CONFORM TO THE LATEST REQUIREMENTS OF "NORTH CAROLINA STATE 2018 RESIDENTIAL BUILDING CODE", IN ADDITION TO ALL LOCAL CODES AND REGULATIONS.

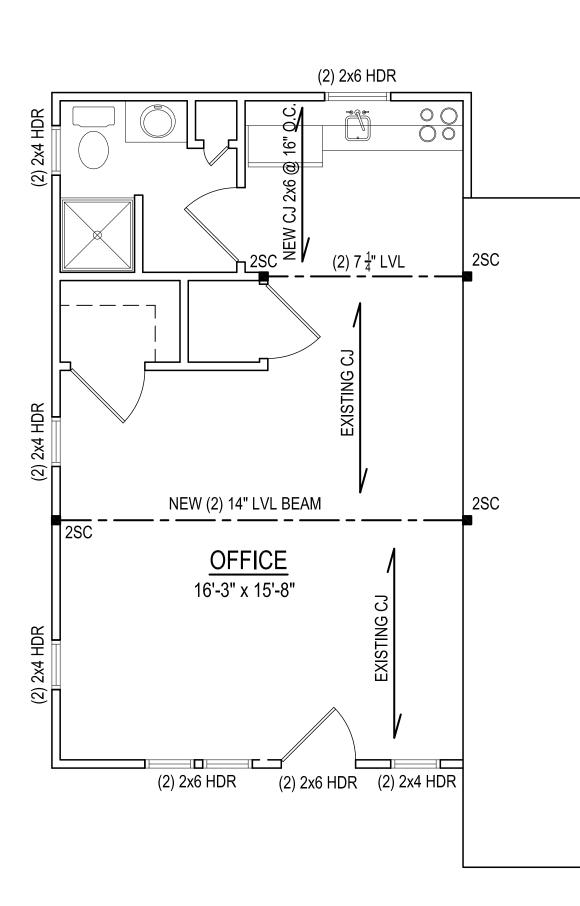2) DESIGN LOADS:

	LIVE LOAD (PSF)	DEAD LOAD (PSF)	DEFLECTION (DL & LL)
ALL FLOORS	40	10	L/360
ATTIC (pull down access)	20	10	L/240
ATTIC (no access)	10	5	L/240
EXTERNAL BALCONY	60	10	L/360
ROOF	20	10	L/180
ROOF TRUSS	20	20	L/240
WIND LOAD	[BASED ON 120MPH (3-second gusts)]		

- 3) MINIMUM ALLOWABLE SOIL BEARING PRESSURE = 2000 PSF
- 4) CONCRETE SHALL HAVE A MINIMUM 28 DAY STRENGTH OF 3000 PSI AND A MAXIMUM SLUMP OF FIVE INCHES UNLESS NOTED OTHERWISE (UNO).
- 5) MAXIMUM DEPTH OF UNBALANCED FILL AGAINST FOUNDATION WALLS TO BE LESS THAN 4'-0" WITHOUT USING SUFFICIENT WALL BRACING. REFER TO SECTION R404 OF 2018 NC BUILDING CODE FOR BACKFILL LIMITATIONS BASED ON WALL HEIGHT, WALL THICKNESS, SOIL TYPE, AND UNBALANCED BACKFILL HEIGHT
- 6) ALL FRAMING LUMBER SHALL BE SYP #2 (Fb = 800 PSI) UNO.
- ALL FRAMING LUMBER EXPOSED TO THE ELEMENTS SHALL BE TREATED MATERIAL.
- 7) ALL LOAD BEARING HEADERS SHALL BE (2)2x10 (UNO). ALL WINDOW AND DOOR HEADERS SHALL BE SUPPORTED BY (1) JACK STUD AND (1) KING STUD AT EACH END UNLESS NOTED. ALL OTHER BEAMS SHALL BE SUPPORTED BY 2 STUDS OR THE AMOUNT OF STUDS REQUIRED FOR FULL BEARING AT EACH END UNLESS NOTED. POINT LOADS (STIFF KNEES, ETC.) SHALL CONSIST OF 2 STUDS UNLESS NOTED. ALL SUPPORTS OF 2 STUDS OR MORE SHALL BE TRANSFERRED THROUGH EACH FLOOR TO THE FOUNDATION.
- 8) ALL EXTERIOR WALLS TO BE SHEATHED WITH MIN. 7/16" WOOD STRUCTURAL PANELS FASTNED WITH 8D NAILS 6" O.C. AT EDGES AND 12" O.C. AT INT. SUPPORTS. BLOCKING SHALL BE INSTALLED IF LESS THAN 50 PERCENT OF THE WALL LENGTH IS SHEATHED. WHERE BLOCKING IS REQ'D, ALL PANELS SHALL BE FASTENED AT 3" O.C AT EDGES AND 6" O.C. AT INT. SUPPORTS.
- 9) ALL STRUCTURAL STEEL SHALL ASTM A-36. STEEL BEAMS SHALL BE SUPPORTED AT EACH END WITH A MINIMUM BEARING LENGTH OF 3-1\2" INCHES AND FULL FLANGE WIDTH. PROVIDE SOLID BEARING FROM BEAM SUPPORT TO FOUNDATION. BEAMS SHALL BE ATTACHED TO EACH SUPPORT WITH TWO LAG SCREWS (1/2 DIAMETER AND 4" LONG). LATERAL SUPPORT IS CONSIDERED ADEQUATE PROVIDING THE JOISTS ARE TOE NAILED TO THE SOLE PLATES, AND THE SOLE PLATES ARE NAILED OR BOLTED TO THE BEAM FLANGES @ 48" O.C.
- (0) ANCHOR BOLT PLACEMENT PER SECTION R403.1.6. 1/2" DIAMETER ANCHOR BOLTS SPACED AT 6'-0" O/C AND PLACED 12" FROM THE END OF EACH PLATE SECTION
- 1) FOUNDATION DRAINAGE-DAMP PROOFING OR WATERPROOFING PER SECTION 405 AND 406 OF 2018 NC BUILDING CODE
- 2) WALL AND ROOF CLADDING VALUES: WALL CLADDING SHALL BE DESIGNED FOR A 24.1 SQ.FT. OR GREATER POSITIVE AND NEGATIVE PRESSURE
- ROOF VALUES BOTH POSITIVE AND NEGATIVE SHALL BE AS FOLLOWS:
- 45.5 LBS/SQFT FOR ROOF PITCHES OF 0/12 TO 2.25/12 34.8 LBS/SQFT FOR ROOF PITCHES OF 2.25/12 TO 7/12
- 21.0 LBS/SQFT FOR ROOF PITCHES OF 7/12 TO 12/12
- ** MEAN ROOF HEIGHT 30' OR LESS
- 3) FOR ROOF SLOPES FROM 2:12 THROUGH 4:12, BUILDER TO INSTALL 2 LAYERS OF 15# FELT PAPER
- 14) IT IS THE CONTRACTOR'S RESPONSIBLITY TO VERIFY ALL DIMENSIONS AND SQ. FTG. ARE CORRECT PRIOR TO CONSTRUCTION.
- DESIGNER IS NOT RESPONSIBLE FOR DIMENSIONING OR SQ. FTG. ERRORS ONCE CONSTRUCTION BEGINS

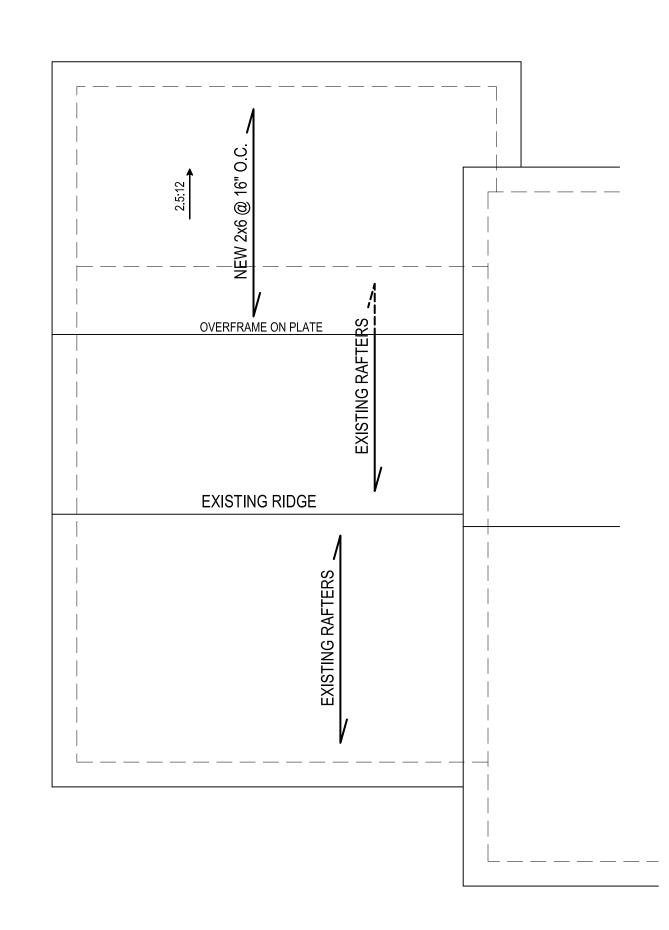


ROOF PLAN 1/4" = 1'-0"

means, methods, techniques, sequences, procedures or safety precaution.

* Any deviations or discrepancies on plans are to be brought to the immediate attention of Mark E. Jones, PE. Failure to do so will void Mark E. Jones, PE Ilability.

* Please review these documents carefully.
Mark E. Jones, PE will interpret
that all dimensions, recommendations,
etc. presented in these documents were
deemed acceptable once construction
begins.

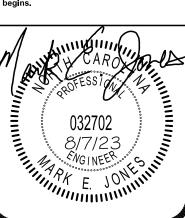

ean Cour C 27603 5-5618 Mark E.

425 Glen
Raleigh,
(919)

 ∞ Springs,

06CAB-001 1/30/2006 MEJ DWG. Checked By: MEJ Scale: 1/4"=1'-0"

	REVISIONS		
<u>No.</u>	Date:	<u>Remarks</u>	
1			
2			
3			
4			

STRUCTURAL

Sheet Number

S1