
图

THIS PLAN HAS BEEN DRAWN TO CONFORM TO THE 2018 NORTH CAROLINA RESIDENTIAL CODE

CONTRACTOR SHALL VERIFY ALL DIMENSIONS AND CONDITIONS PRIOR TO BEGGINING WORK. CONTRACTOR IS RESPONSIBLE FOR COMPLIANCE WITH ALL STATE AND LOCAL BUILDING CODES AND ORDINANCES. KADS CUSTOM HOME DESIGNS ASSUMES NO LIABILITY FOR SITE CONDITIONS, CONSTRUCTION METHODS OR ANY DEVIATION OF THESE PLANS.

NOTE:
ALL WINDOWS TO BE INSTALLED MUST MEET
A MAXIMUM OF .32 U VALUE OR BETTER, UNLESS
ENERGY CALCULATIONS ARE SUBMITTED WITH PLANS
PROVIDED BY BUILDER AT TIME OF PLAN REVIEW.

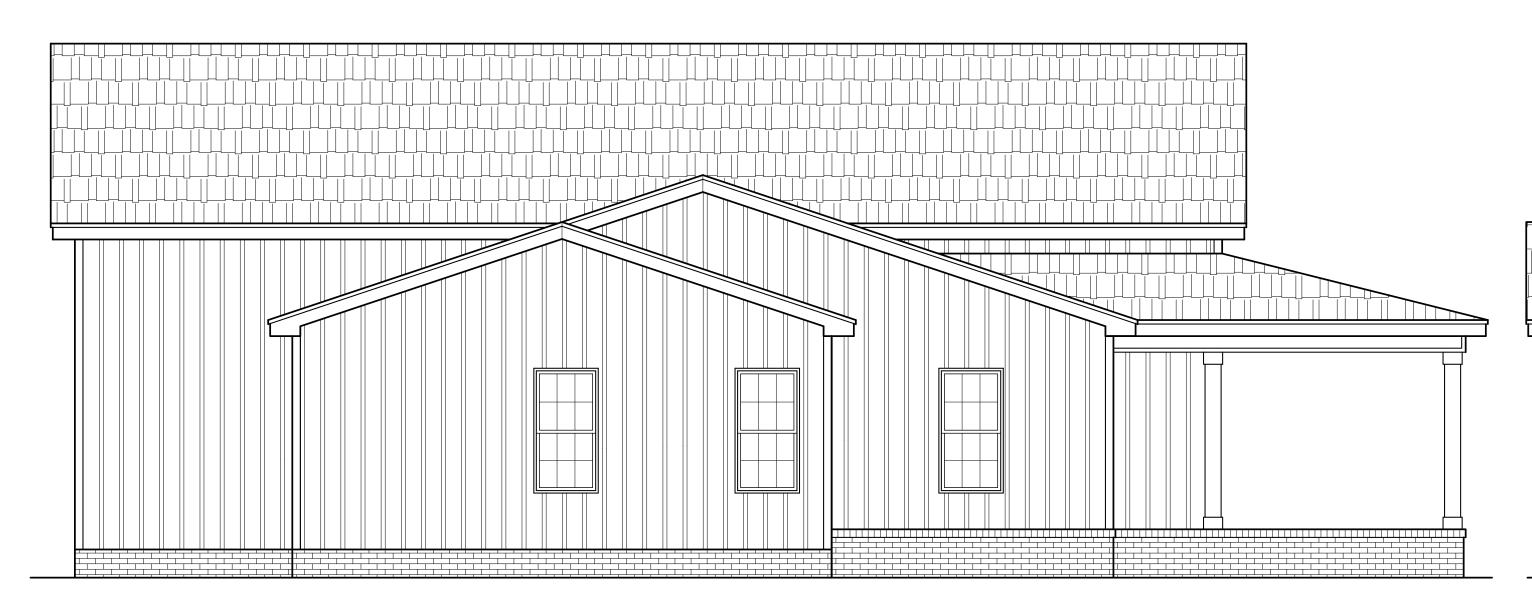

FIBERGLASS SHINGLES AS SPEC.
(CLASS "C" MIN.)


RIDGE VENT


LEFT ELEVATION

SCALE: 1/4"=1'-0"

FRONT ELEVATION

SCALE: 1/4"=1'-0"

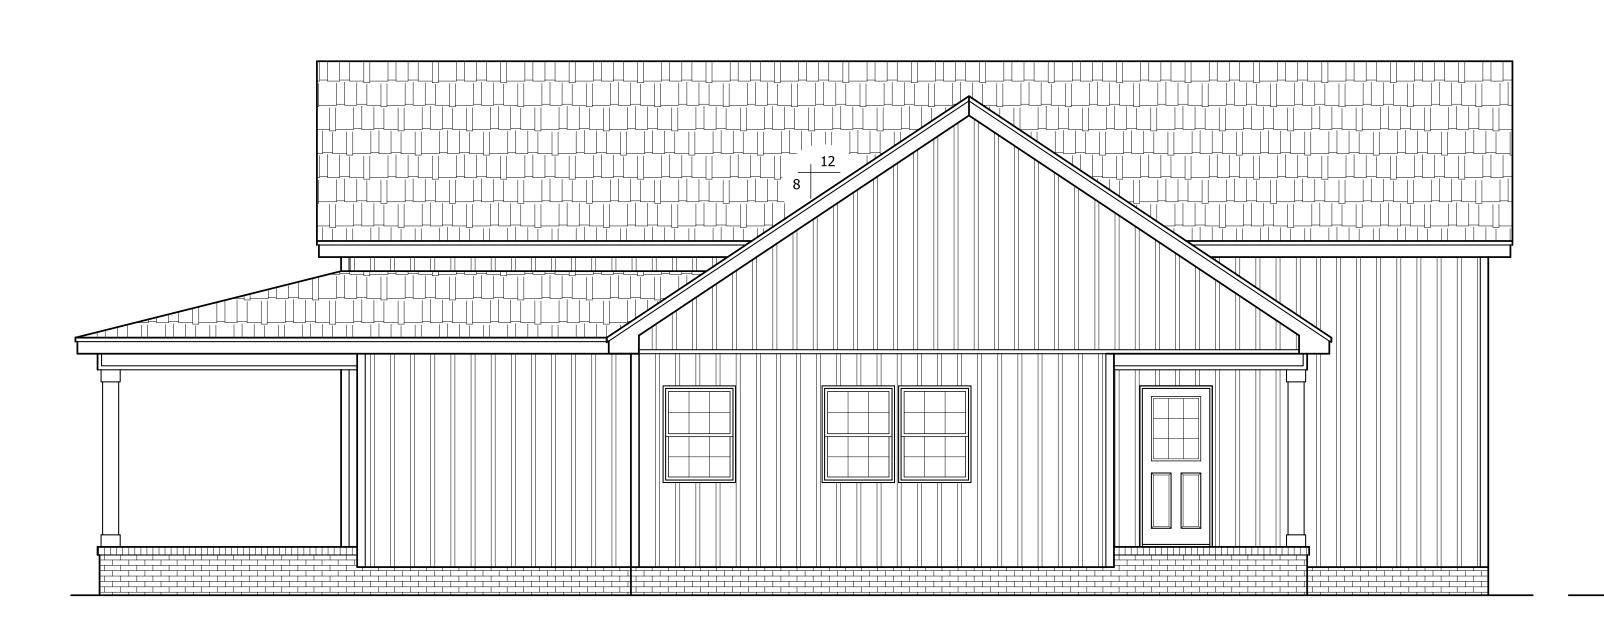

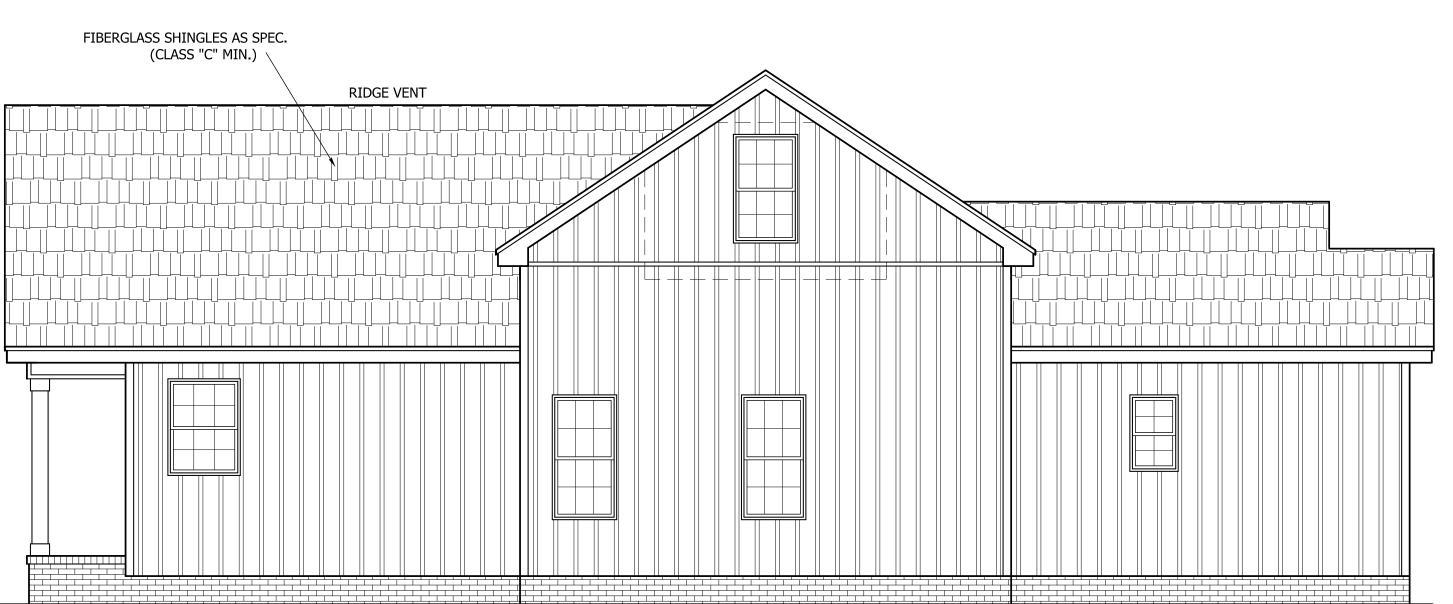

RIGHT ELEVATION

SCALE: 1/4"=1'-0"

REAR ELEVATION

SCALE: 1/4"=1'-0"



ANGIER, NC 919-369-7181

> DRAWN BY: D.W.O.


DATE: 3/3/23

PAGE NO

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PLAN NO.



include construction means, methods, techniques, sequences, procures or safety precautions.

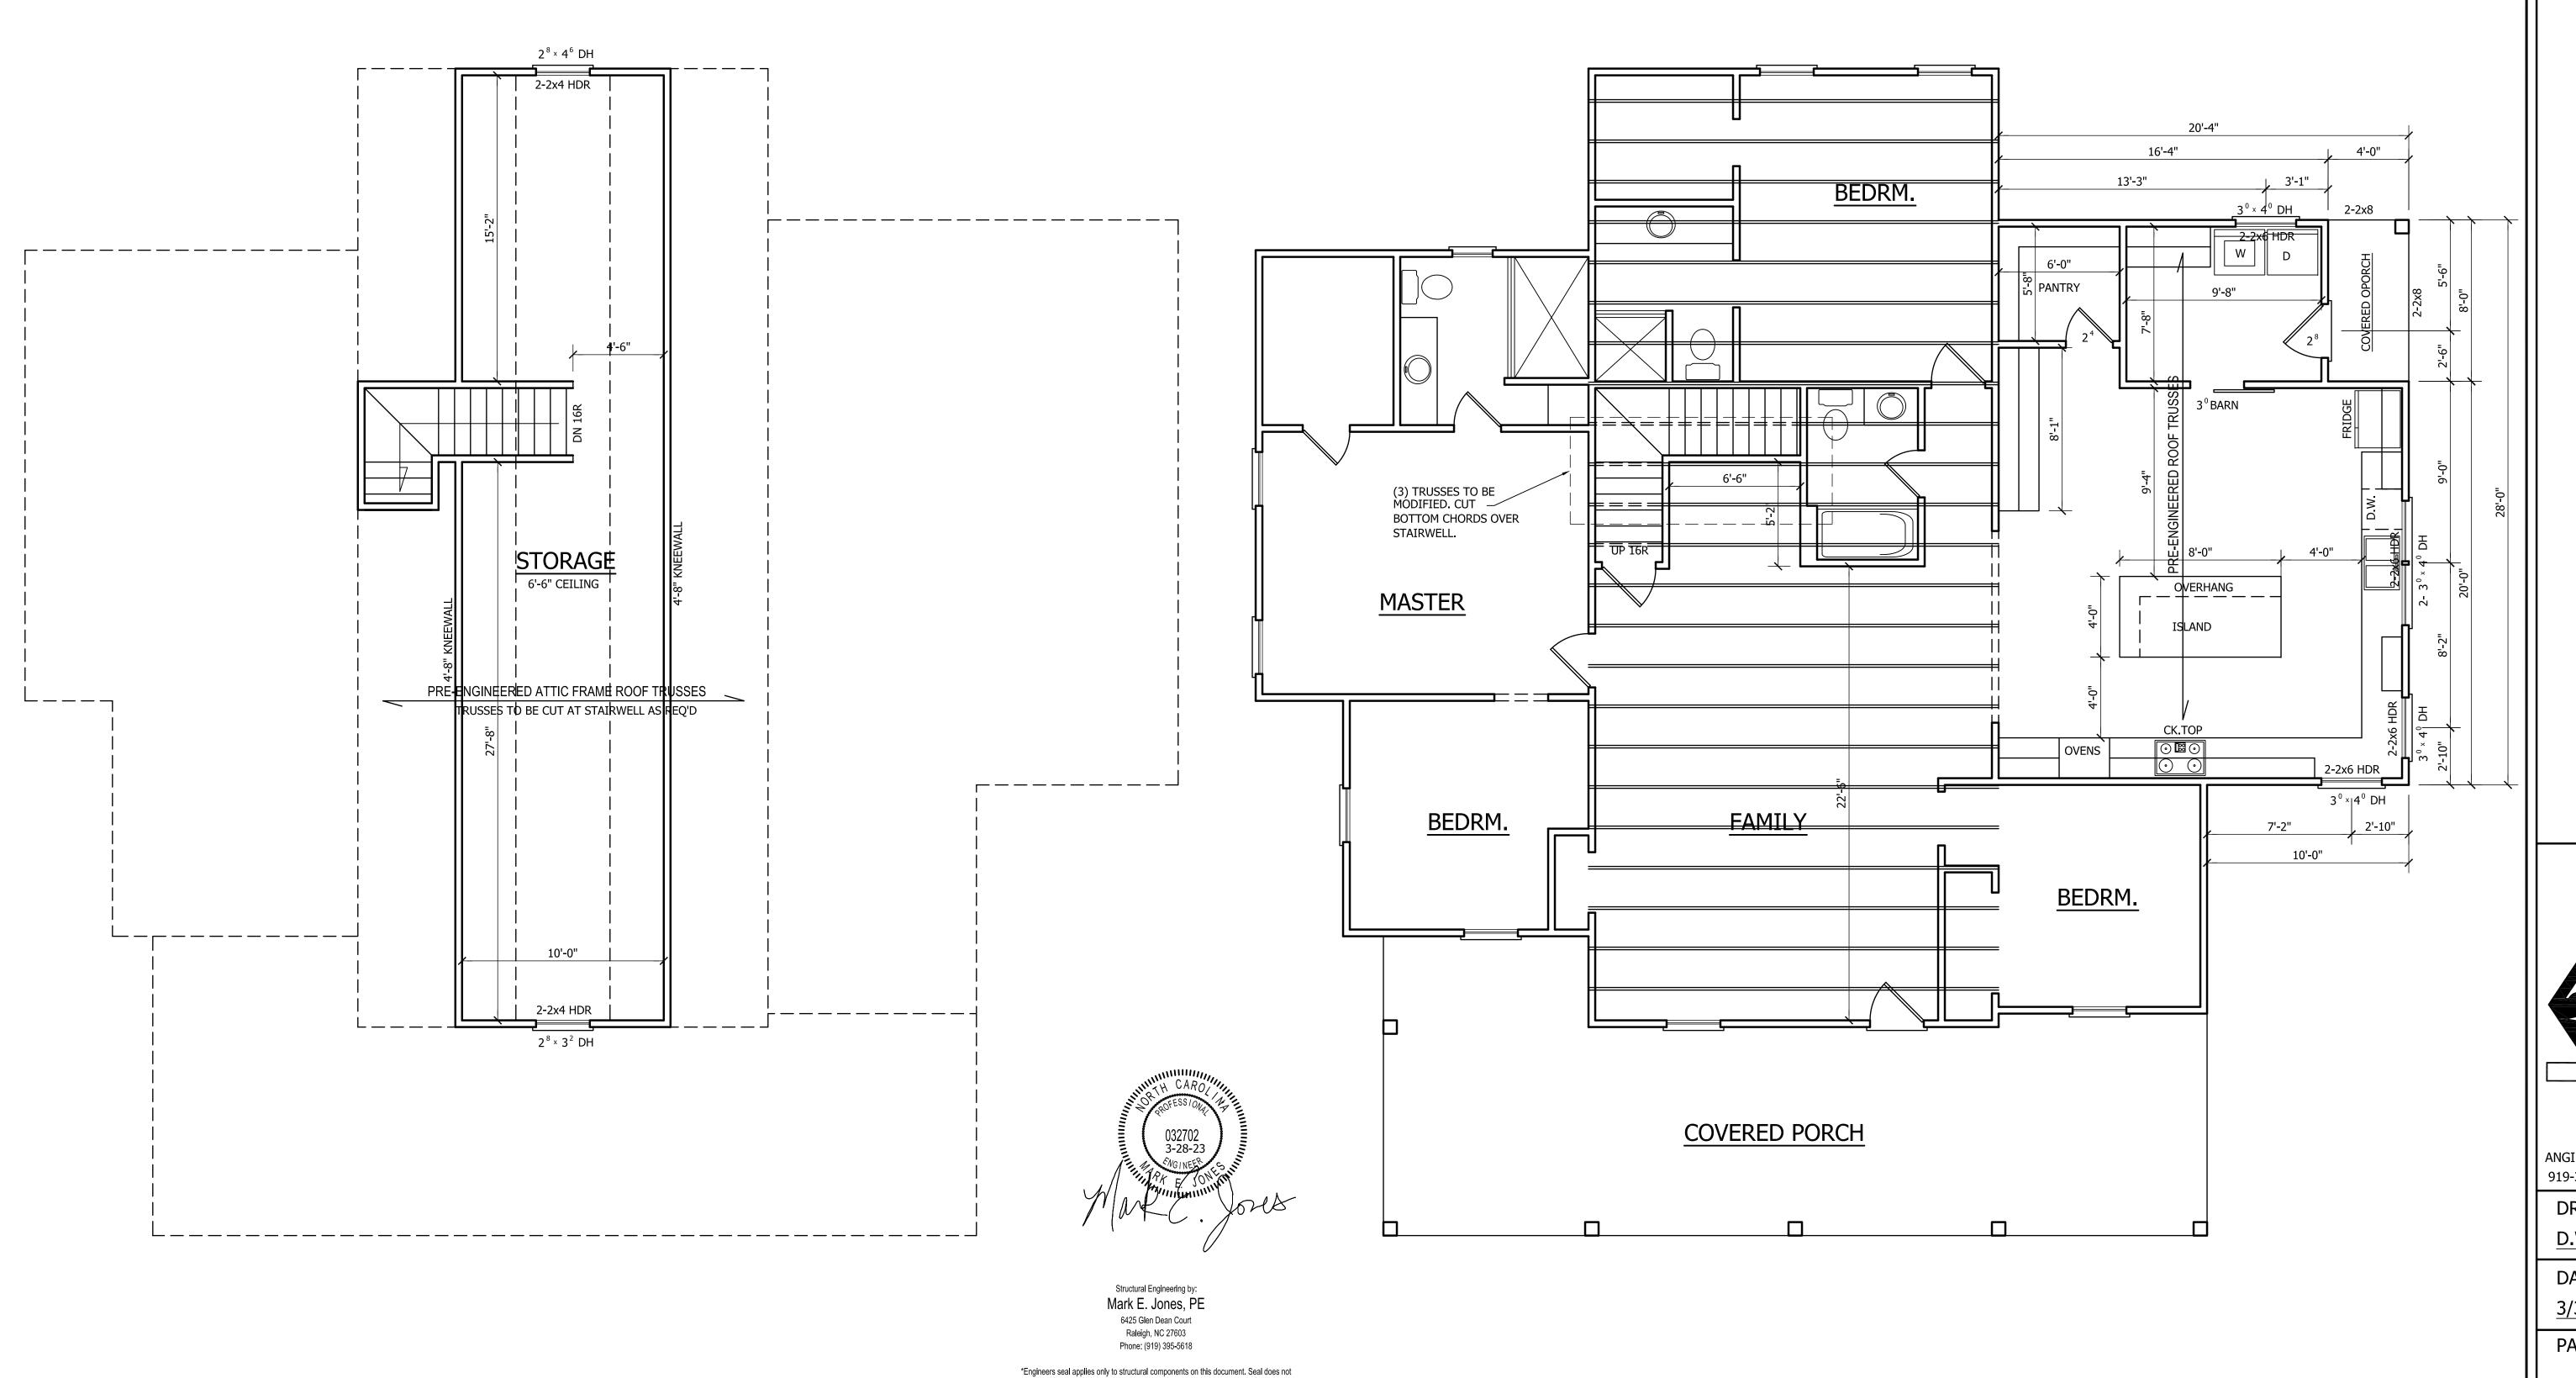*Any deviations or discrepancies on plans are to be brought to the immediate attention of
Mark E. Jones, PE. Failure to do so will void Mark E. Jones, PE liability.

Structural analysis based on NCResidential Building Code 2018.

Project No. 23-059

3LACKBURN RESIDENCE

CUSTOM HOME DESIGNS

ANGIER, NC 919-369-7181

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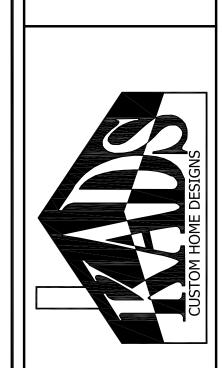
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PLAN NO. BLACKBURN



ANGIER, NC 919-369-7181


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3/3/23

PAGE NO

PLAN NO.



SCALE: 1/4"=1'-0"

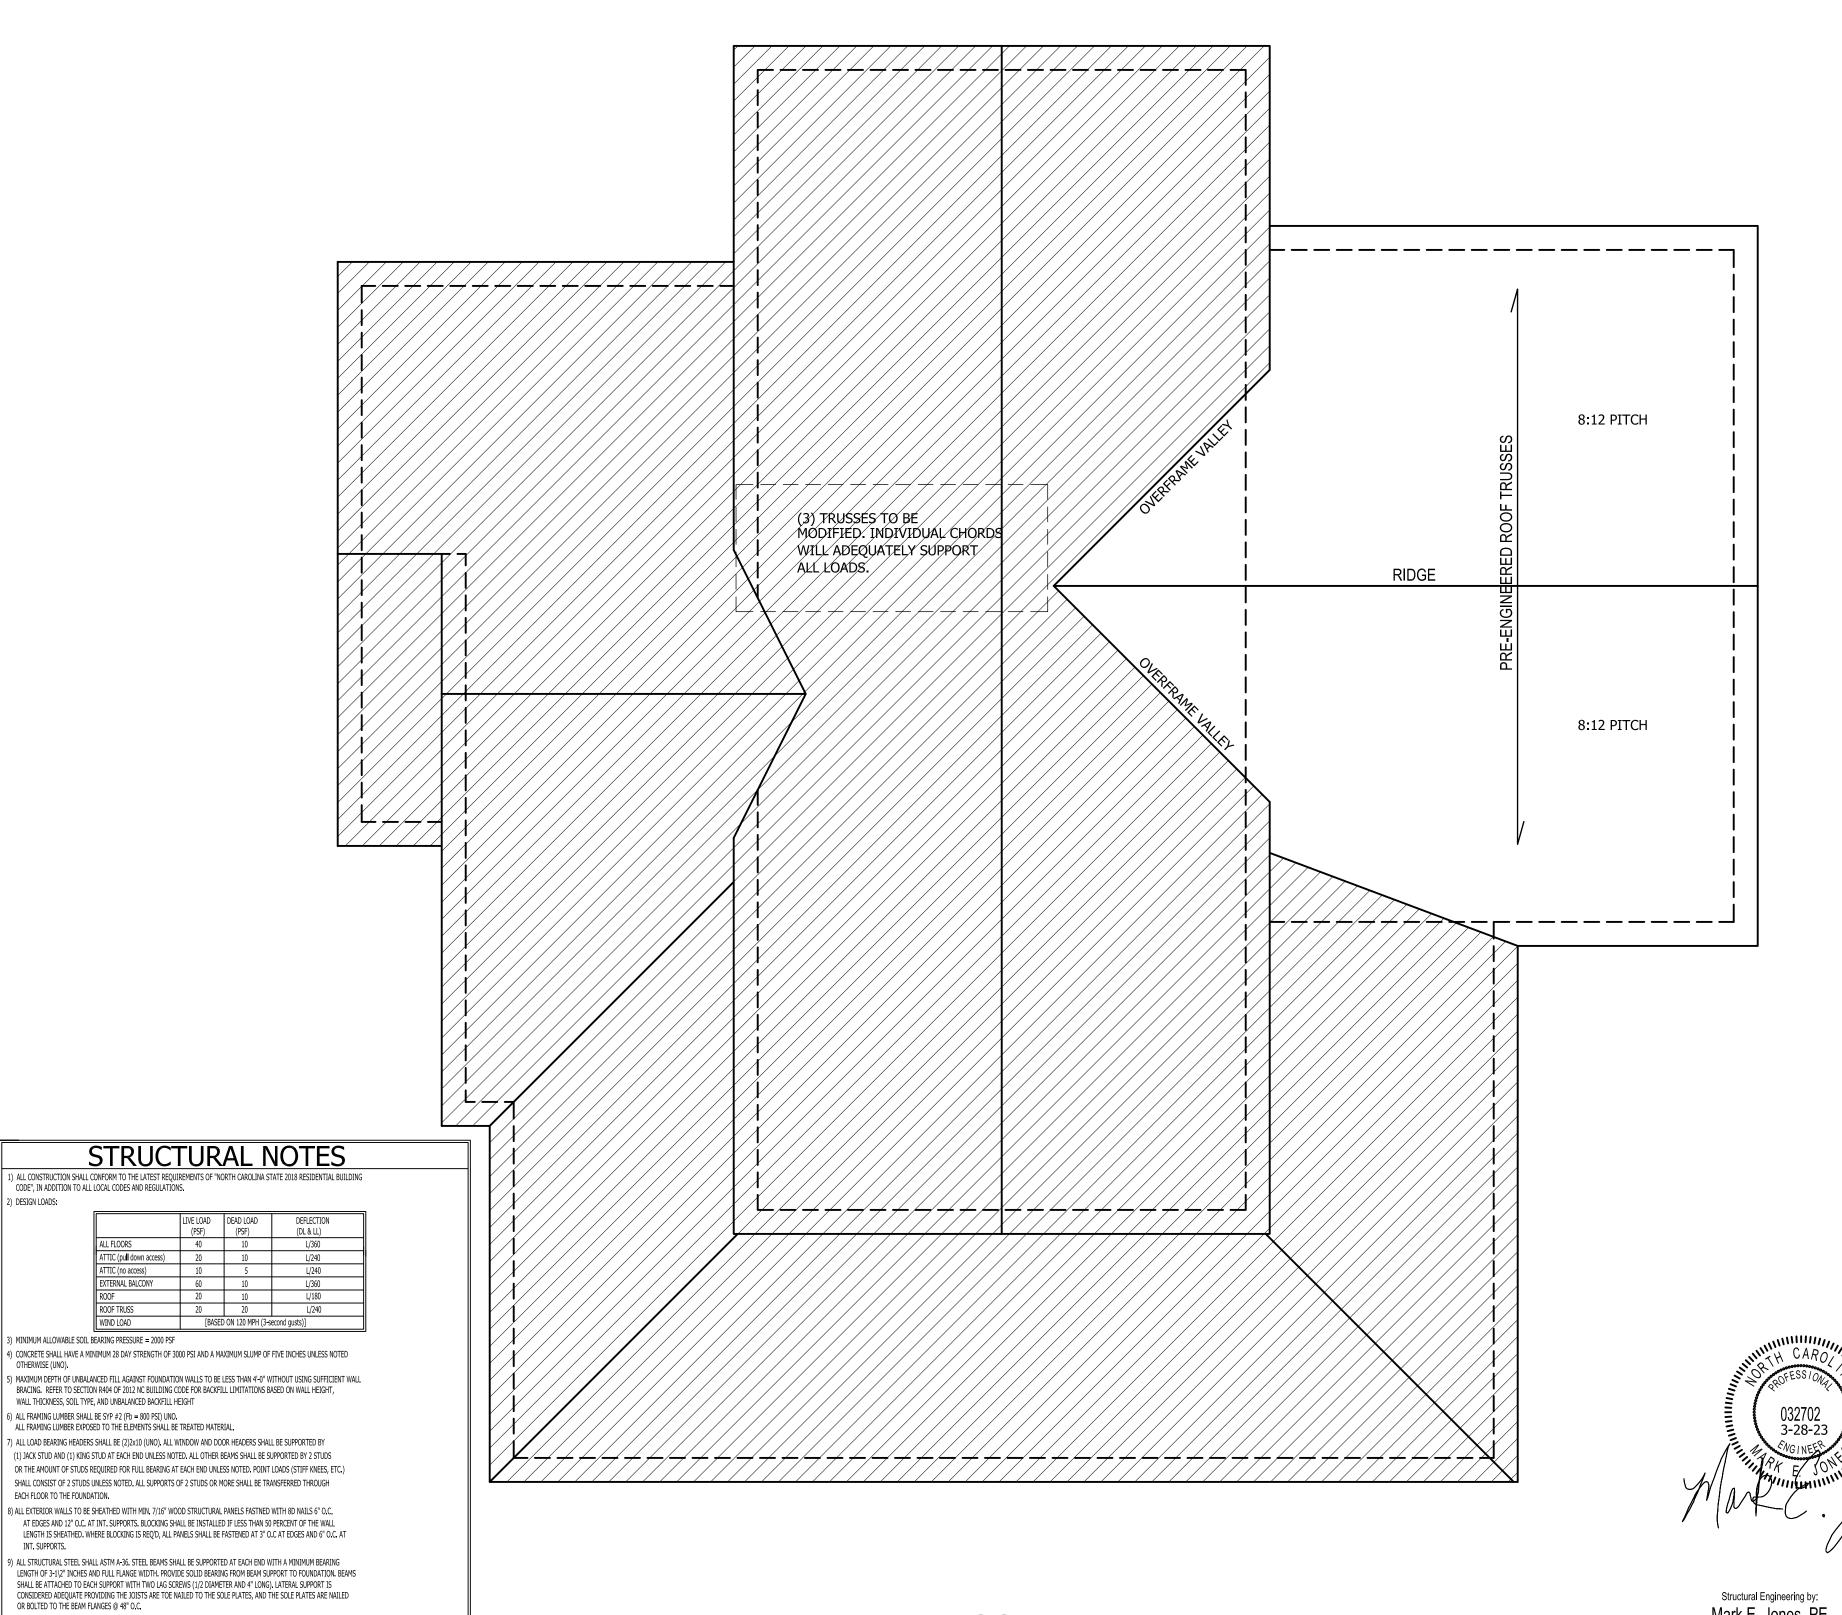10'-0" 2x8 @ 16" O.C. 8" MAS WALLON 16"x8" CONT CONC FTG

FOUNDATION PLAN

SCALE: 1/4"=1'-0"

Structural Engineering by: Mark E. Jones, PE 6425 Glen Dean Court Raleigh, NC 27603 Phone: (919) 395-5618

*Engineers seal applies only to structural components on this document. Seal does not include construction means, methods, techniques, sequences, procures or safety precautions. *Any deviations or discrepancies on plans are to be brought to the immediate attention of Mark E. Jones, PE. Failure to do so will void Mark E. Jones, PE liability. Structural analysis based on NCResidential Building Code 2018.

Project No. 23-059

THIS PLAN SHALL BE CONTINUOUSLY BRACED WITH WOOD STRUCTURAL PANELS PER SECTION R602.10.3 OF THE NC RESIDENTIAL BUILDING CODE. NOTE ALL WALL BRACING LINES SATISFY THE MINIMUM AMOUNTS OF WALL BRACING PER CODE. GARAGE DOOR HEADER SHALL BE CONSTRUCTED PER FIGURE R602.10.1, METHOD PF.

10) ANCHOR BOLT PLACEMENT PER SECTION R403.1.6. 1/2" DIAMETER ANCHOR BOLTS SPACED AT 6'-0" O/C AND PLACED 12" FROM THE END OF EACH PLATE SECTION

11) FOUNDATION DRAINAGE-DAMP PROOFING OR WATERPROOFING PER SECTION 405 AND 406 OF 2012 NC BUILDING CODE

14) IT IS THE CONTRACTOR'S RESPONSIBLITY TO VERIFY ALL DIMENSIONS AND SQ. FTG. ARE CORRECT PRIOR TO CONSTRUCTION.

DESIGNER IS NOT RESPONSIBLE FOR DIMENSIONING OR SQ. FTG. ERRORS ONCE CONSTRUCTION BEGINS

12) WALL AND ROOF CLADDING VALUES:

WALL CLADDING SHALL BE DESIGNED FOR A 24.1 SQ.FT. OR GREATER POSITIVE AND NEGATIVE PRESSURE
ROOF VALUES BOTH POSITIVE AND NEGATIVE SHALL BE AS FOLLOWS:

45.5 LBS/SQFT FOR ROOF PITCHES OF 0/12 TO 2.25/12
34.8 LBS/SQFT FOR ROOF PITCHES OF 7/12 TO 12/12

** MEAN ROOF HEIGHT 30' RESS

13) FOR ROOF SLOPES FROM 2:12 THROUGH 4:12, BUILDER TO INSTALL 2 LAYERS OF 15# FELT PAPER

2) DESIGN LOADS:

) MINIMUM ALLOWABLE SOIL BEARING PRESSURE = 2000 PSF


WALL THICKNESS, SOIL TYPE, AND UNBALANCED BACKFILL HEIGHT ALL FRAMING LUMBER SHALL BE SYP #2 (Fb = 800 PSI) UNO.
 ALL FRAMING LUMBER EXPOSED TO THE ELEMENTS SHALL BE TREATED MATERIAL.

EACH FLOOR TO THE FOUNDATION.







PLAN NO.

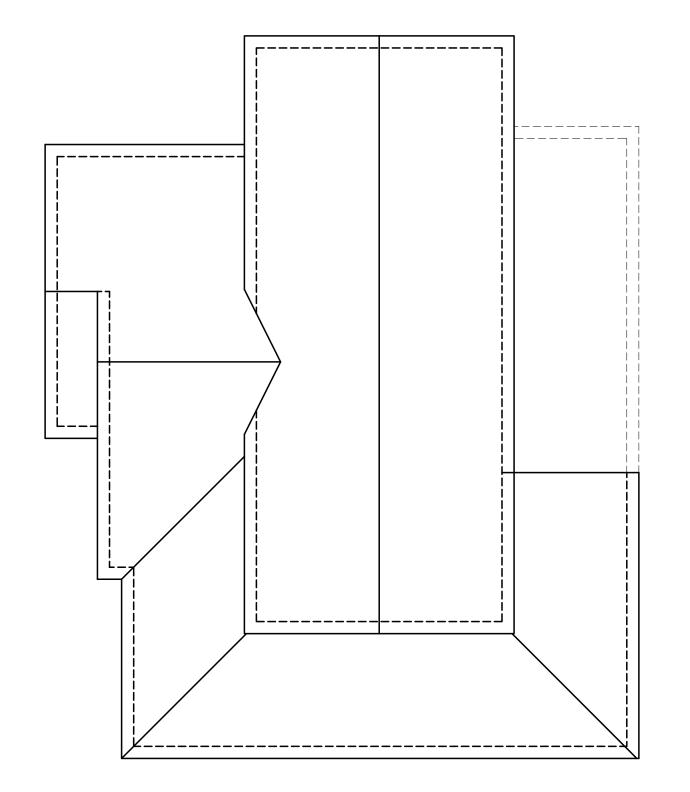

DEMO PLANS

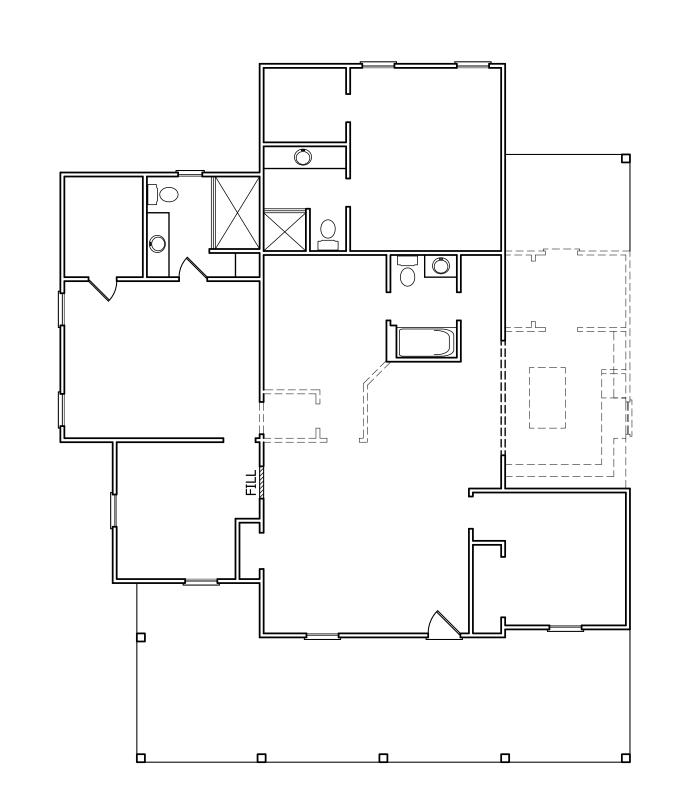

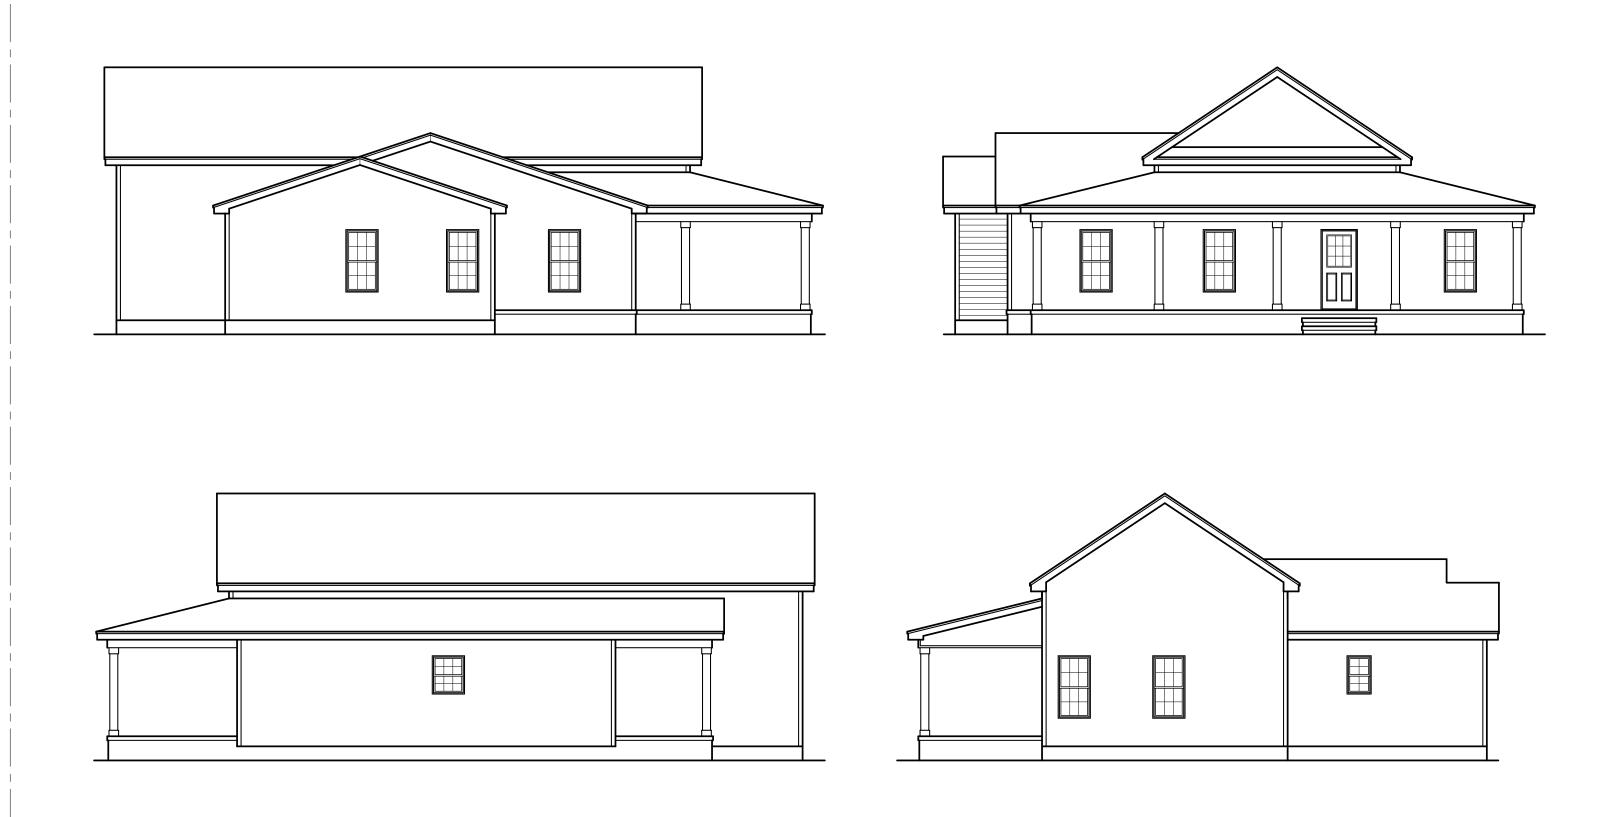

AS-BUILT PLANS

