BUILDER SHALL VERIFY ALL DIMENSIONS AND CONDITIONS AT TIME OF CONSTRUCTION.

ALL CONSTRUCTION SHALL CONFORM TO THE 2018 EDITION OF THE NC STATE BUILDING CODE.

CODES GOVERN OVER DRAWINGS.

DIMENSIONS GOVERN OVER SCALE.


VERIFY ALL MECHANICAL REQUIREMENTS BEFORE FRAMING.

VUNCANNON DESIGNS DOES NOT ASSUME LIABILITY FOR ANY DEVIATION OF OR CONSTRUCTION METHODS OF THESE PLANS.

ATTIC SPACE VENTILATION MAIN ROOF

ATTIC AREA = 720 SQ. FT. REQUIRED AREA = A/300 = 2.4 SQ. FT.

ALL EAVES TO HAVE 2" CONTINUOUS SOFFIT VENT ALLOW I" AIR SPACE ABOVE INSULATION FOR AIR FLOW

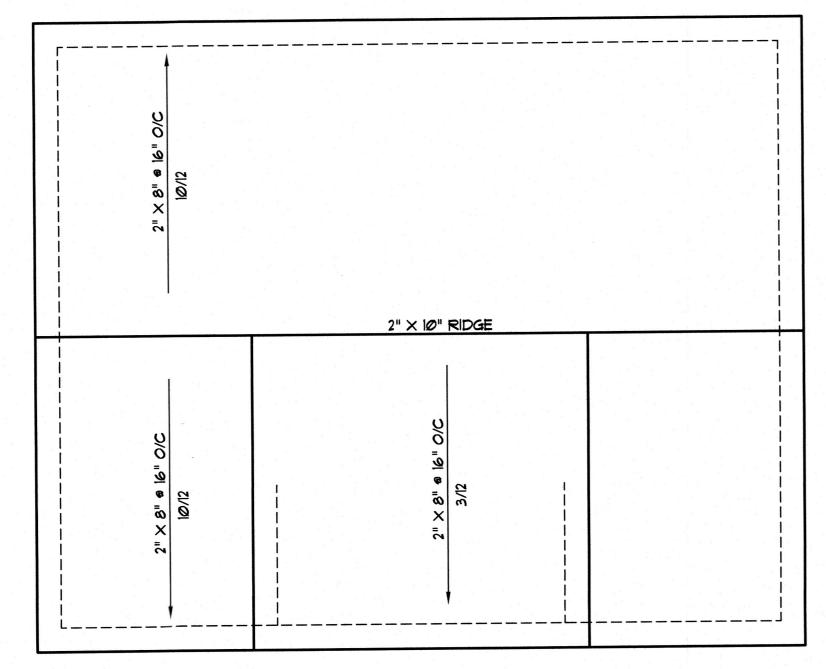


ROOF PLAN SCALE: 1/4" = 1'-0"



FRONT ELEV.

SCALE: 1/4" = 1'-0"

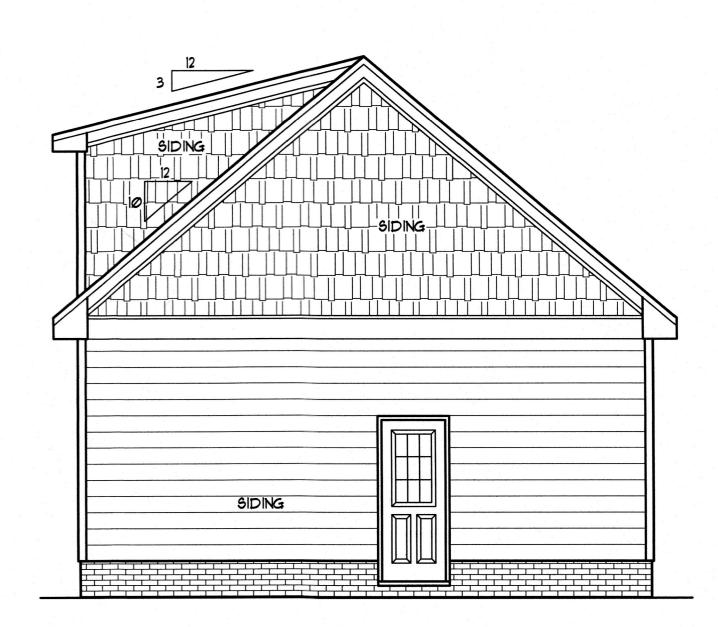

RIGHT SIDE SCALE: 1/4" = 1'-0"

FOUNDATION NOTES


) SPECIFIC NOTES ON THE PLANS TAKE PRECEDENCE OVER THE FOLLOWING GENERAL NOTES. NOTED DIMENSIONS GOVERN OVER SCALE. PLAN DESIGNER AND CONTRACTOR ARE SOLELY RESPONSIBLE FOR DIMENSIONAL ACCURACY. ALL CONSTRUCTION TO COMPLY WITH NC STATE BUILDING CODE, VOL. VII WITH CURRENT REVISIONS.

STRUCTURAL CONCRETE TO BE F'C=3000 PSI, PRE-PARED AND PLACED IN ACCORDANCE WITH ACI STANDARD 318.


3) FOOTINGS TO BEAR ON UNDISTURBED EARTH, A MIN. OF 12" BELOW ADJACENT FINISHED GRADE, OR AS OTHERWISE DIRECTED BY THE LOCAL INSPECTOR. 4) FOOTING SIZES BASED ON A PRESUMPTIVE SOIL BEARING CAPACITY OF 2000 PSF. CONTRACTOR IS SOLEY RESPONSIBLE FOR VERIFYING THE SUITABILITY OF THE SITE SOIL CONDITIONS AT THE TIME OF CONSTRUCTION.

5) FOOTINGS AND PIERS SHALL BE CENTERED UNDER THEIR RESPECTIVE ELEMENTS. PROVIDE 3" MIN. FOOTING PROJECTION FROM FACE OF MASONRY.

6) MAXIMUN DEPTH OF UNBALANCED FILL AGAINST MASONRY WALLS TO BE AS SPECIFIED IN VOLUME VII, SECTION R-3043 OF THE NC STATE CODE.

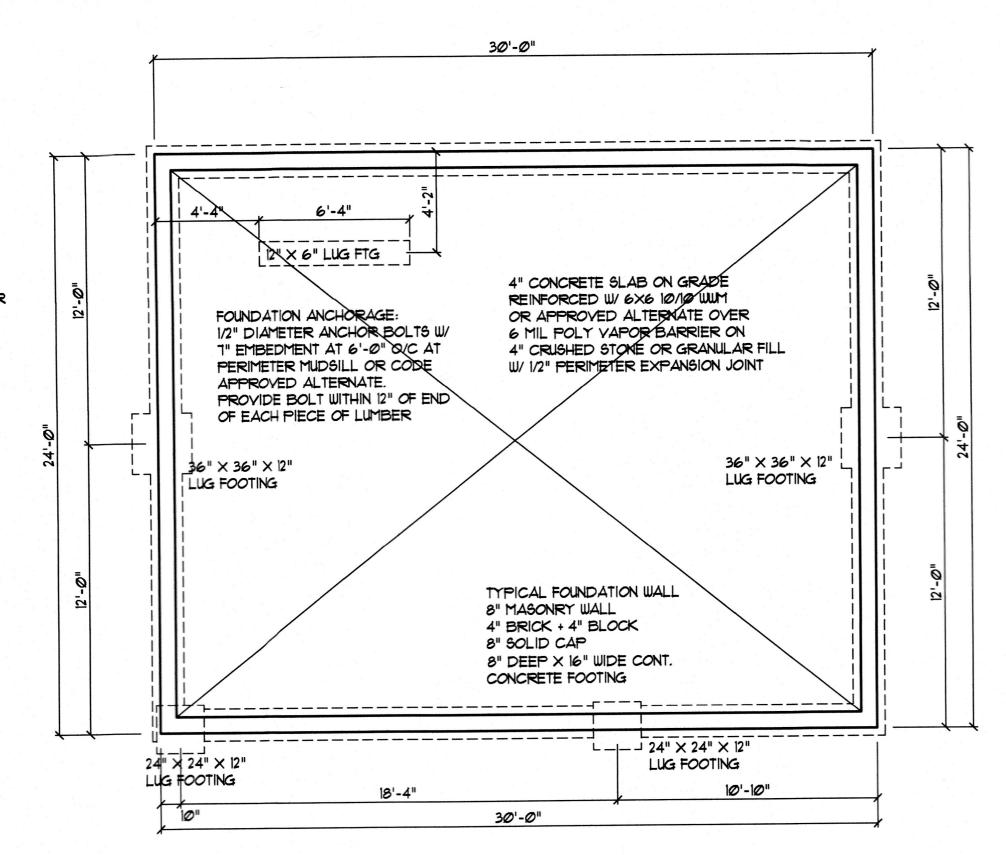

FOUNDATION PLAN SCALE: 1/4" = 1'-0"

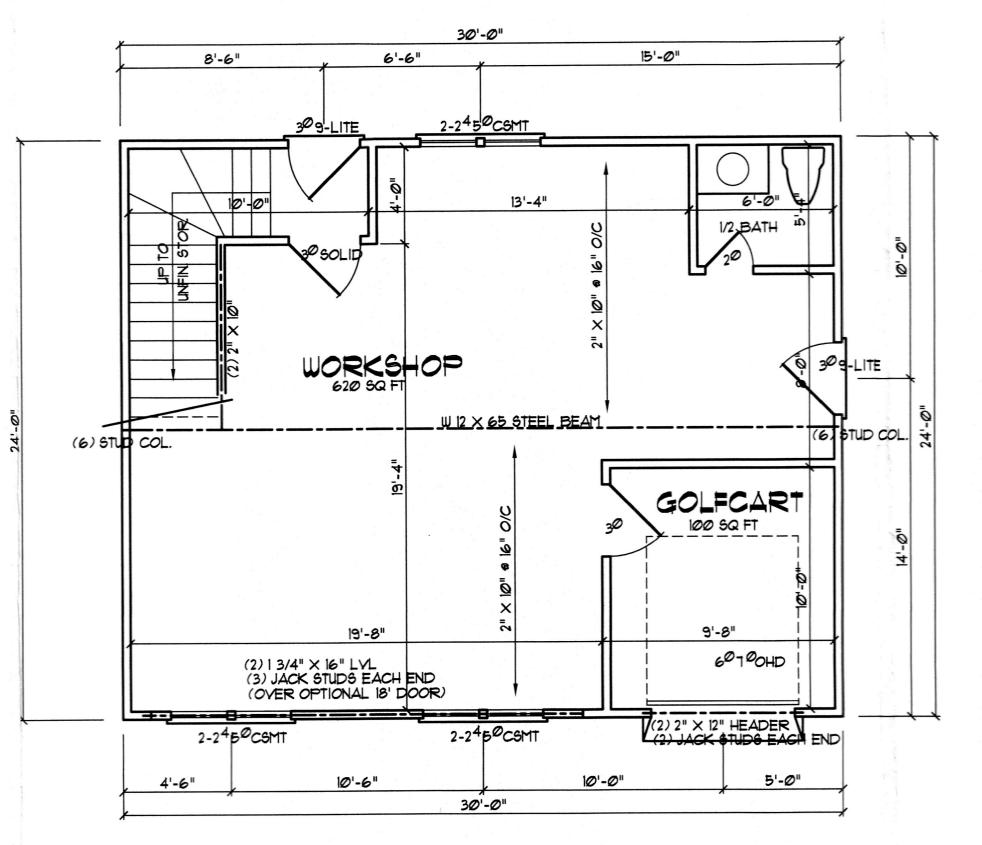

FLOOR PLAN 9CALE: 1/4" = 1'-0"

FRAMING NOTES

1) ALL FRAMING LUMBER SPF *2 GRADE (NLGA) OR BETTER, UNLESS NOTED.

2) JOIST SIZE AND SPACING BASED ON CODE MINIMUMS. BUILDER SHOULD CONSIDER STIFFENENING FLOOR SYSTEM IN LONG SPAN AREAS, TO REDUCE FLOOR FLEXIBILITY.

3) PROVIDE DOUBLE JOIST UNDER WALLS PARALLEL TO JOIST DIRECTION.

4) PROVIDE SOLID BLOCKING BETWEEN ALL POINT LOADS AND TOP OF GIRDER, PIER OR FOUNDATION WALL.

STRUCTURAL EVALUATION BY:

HOWERTON SERVICES. PLLC 3513 CATHEDRAL BELL ROAD RALEIGH, NC 27614 LICENSE P-1716

* ENGINEER'S SEAL APPLIES ONLY TO STRUCTURAL COMPONENTS ON THIS DOCUMENT. SEAL DOES NOT INCLUDE CONSTRUCTION REVIEW, MEANS, METHODS, TECHNIQUES, SEQUENCES, PROCEDURES OR SAFETY PRECAUTIONS.

* ANY DEVIATIONS OR DISCREPANCIES ON PLANS ARE TO BE BROUGHT TO MMEDIATE ATTENTION OF THE ENGINEER. FAILURE TO DO SO WILL VOID

ENGINEER'S LIABILITY. * DO NOT SCALE THESE DRAWINGS - ENGINEERING APPROVAL EXPIRES 01/01/2023



12 08 2022

SHEET

DRAWN BY : WRY CHK'D BY : WRY DATE: 12/08/22 REVISIONS :

strickland Strickland naton, NC

Y