

NOTES:

- * ALL WALLS DRAWN AT 3 1/2" U.N.O.
- * ALL DIMENSIONS ARE TO STUD FACE
- * ALL DOORS \$ WINDOWS TO BE SET AT 6'-8" A.F.F. @ FIRST FLOOR \$ 6'-8" A.F.F. @ SECOND FLOOR
- * ALL DOORS AND CASED OPENINGS TO BE 5" OFF WALL EDGE OR CENTERED IN THE WALL U.N.O. * ALL ANGLED WALLS SET AT 45° U.N.O.
- * VERIFY WITH WINDOW MANUF. THAT EACH WINDOW WIDTHS, HEIGHTS, TEMPERED, AND ANY OTHER LOCAL CODE REQUIREMENTS BEFORE ORDERING WINDOWS.
- * CONTRACTOR SHALL VERIFY ALL CONDITIONS AND DIMENSIONS AT SITE BEFORE BEGINNING CONSTRUCTION ANY DISCREPANCIES SHALL BE REPORTED FOR JUSTIFICATION AND/OR CORRECTION BEFORE PROCEEDING WITH WORK.
 CONTRACTORS SHALL ASSUME RESPONSIBILITY FOR ERRORS THAT ARE REPORTED. *ALL DIMENSIONS SHOULD BE READ OR CALCULATED AND NEVER SCALED.

GENERAL ADDITION NOTE:

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AGAINST EXISTING CONDITIONS. THE FOLLOWING, BUT NOT
LIMITED TO, IS A LIST OF KEY ITEMS TO VERIFY:

- EXISTING ROOF PITCHES NOTED, VERIFY THEY MATCH EXISTING CONDITIONS.
- EXISTING DOOR AND WINDOW SIZES, LOCATIONS, AND FRAMING HEIGHTS NOTED, VERIFY THEY MATCH EXISTING CONDITIONS.
- EXISTING WALL THICKNESS NOTED, VERIFY THEY MATCH EXISTING CONDITIONS.
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- MATCH EXISTING CONDITIONS EXISTING FOUNDATION WALL LOCATION, SIZE AND TYPE NOTED, VERIFY THEY MATCH EXISTING
- EXISTING POINT LOAD SUPPORTS NOTED, VERIFY THEY MATCH EXISTING CONDITIONS.
 ASSUMED BEARING CAPACITY OF SOIL IS FIGURED AT

CONTRACTOR TO FIELD VERIFIES EXISTING CONDITION AND IF ANY IS FOUND TO BE DIFFERENT FROM WHAT IS NOTED ON THESE PLANS JDS Consulting, PLLC IS TO BE CONTACTED PRIOR TO MATERIAL PURCHASING, DELIVERY, OR INSTALLATION OF MATERIAL OR METHODS IN QUESTION.

SQUARE FOOTAGE CALCS SUNROOM 229 SQ.FT

120 SQ.FT 60 SQ.FT

SCR. PORCH

BREEZEWAY

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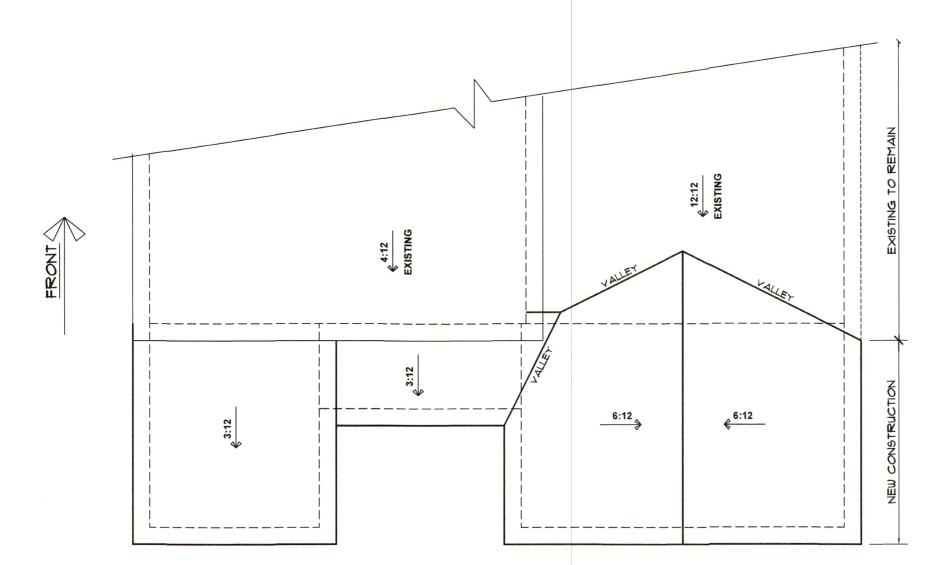
PORCH, AY ADD SUNROON BREEZEW

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5/18/2022

DRAWN BY:
TMH EXISTING DEMO AND PROPOSED FLOOR PLAN

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ROOF PLAN SCALE 1/8"=1'-0"

NOTES:

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EXISTING JOISTS SIZES, SPACING, AND DIRECTION NOTED, VERIFY THEY MATCH EXISTING CONDITIONS

EXISTING HEADERS, BEAMS, AND COLUMNS NOTED, VERIFY THEY MATCH EXISTING CONDITIONS.
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ATTIC VENTILATION

THE TOTAL NET-FREE VENTILATION AREA SHALL NOT BE LESS THAN 1/150 OF THE AREA OF THE ATTIC SPACE TO BE VENTILATED. THE TOTAL VENTILATION MAY BE REDUCED TO 1/300 PROVIDED AT LEAST 50% BUT NOT MORE THAN 80% OF THE REQUIRED VENTILATION BE LOCATED IN THE UPPER PORTION OF THE AREA TO BE VENTILATED, OR AT LEAST 3' ABOVE THE SOFFIT VENTILATION INTAKE.

300 SQUARE FEET OF TOTAL ATTIC / 150 =

SQUARE FEET OF NET-FREE VENTILATION REQUIRED

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FUQUAY, I, PORCH, AY ADD


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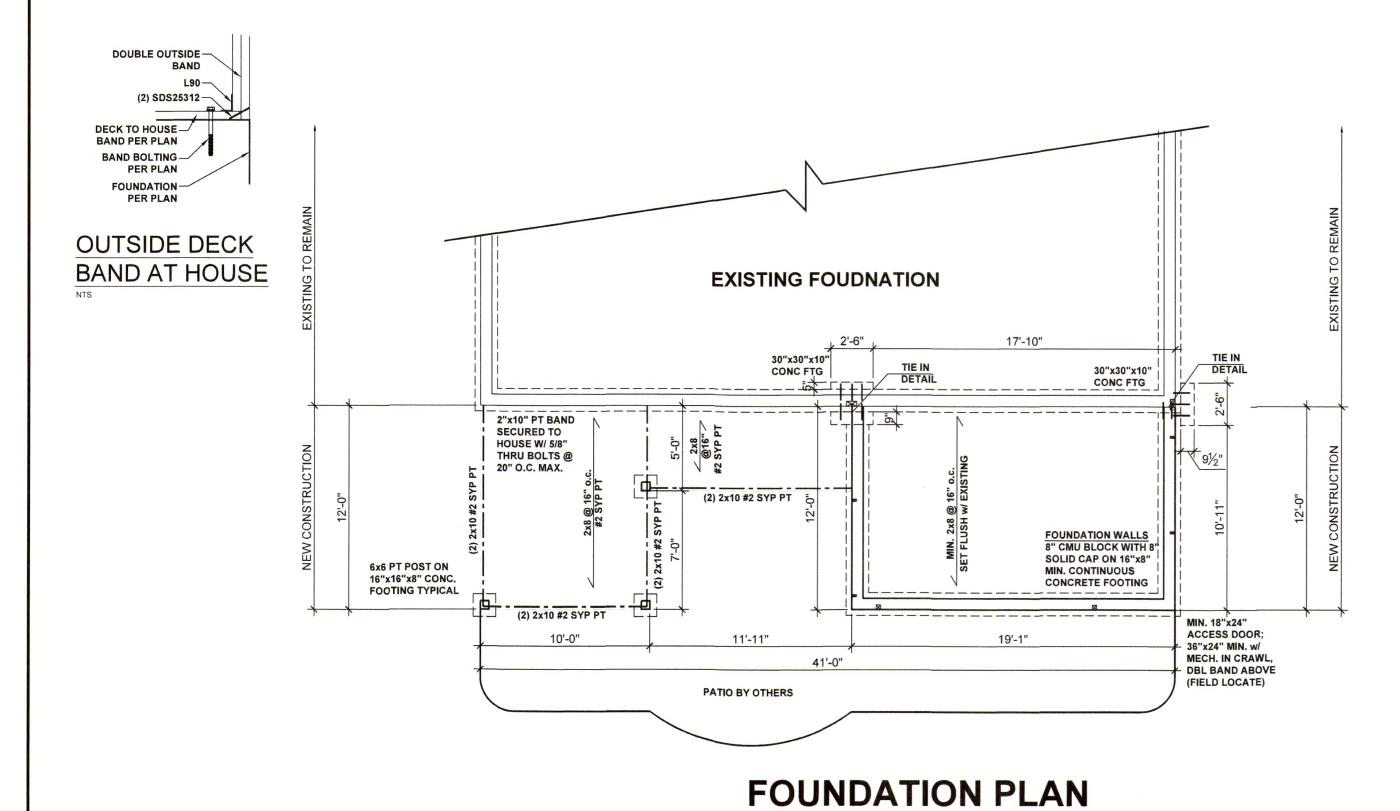
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DRAWN BY: **TMH**

ROOF PLAN

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BEAM & POINT LOAD LEGEND

INTERIOR LOAD BEARING WALL ROOF RAFTER / TRUSS SUPPORT

DOUBLE RAFTER / DOUBLE JOIST

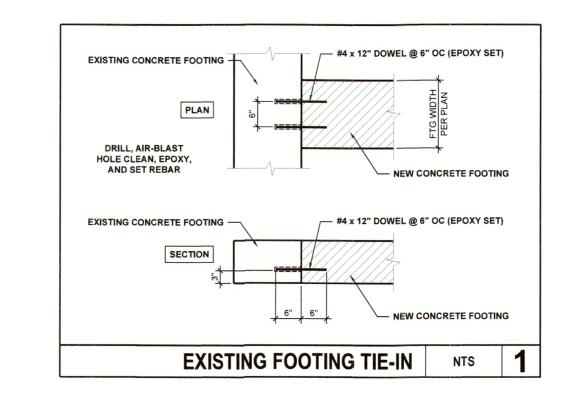STRUCTURAL BEAM / GIRDER

WINDOW / DOOR HEADER POINT LOAD TRANSFER

POINT LOAD FROM ABOVE BEARING ON BEAM / GIRDER

STRUCTURAL FRAMING NOTES - (SEE GENERAL NOTES SHEET FOR ADDITIONAL REQUIREMENTS.)

- ALL FRAMING TO BE #2 SPF MINIMUM.
- ALL BEARING HEADERS TO BE (2) 2x6 SUPPORTED w/ MIN (1) JACK AND (1) KING EACH END, UNO.
- **EXTERIOR WALL OPENINGS OVER 3' TO HAVE** MULTIPLE KING STUDS AS NOTED ON PLAN.
- ALL NON-BEARING HEADERS TO BE (2) 2x4 (1) J / (1) K, UNO.
- PROVIDE CONTINUOUS BLOCKING THROUGH STRUCTURE FOR ALL POINT LOADS.
- ALL HANGERS AND CONNECTORS SPECIFIED ARE TO BE SIMPSON STRONG-TIE OR EQUIVALENT.
- ALL BEAMS SPECIFIED ARE MINIMUM SIZES ONLY LARGER MEMBERS MAY SUBSTITUTED AS NEEDED FOR EASE OF CONSTRUCTION. MINIMUM BEAM SUPPORT IS (1) 2x4 STUD.
- ALL EXTERIOR WALLS TO BE FULLY SHEATHED WITH 7/16" OSB.
- FRONT PORCH COLUMNS TO BE MIN 4x4 PT ATTACHED AT TOP AND BOTTOM USING SIMPSON (OR EQUIV) COLUMN BASE OR SST A24 BRACKETS. TRIM OUT PER BUILDER.
- 10. PORCH COLUMNS TO BE MIN 4x4 PT ATTACHED AT BOTTOM USING SIMPSON (OR EQUIV) ABA44 AND AT TOP USING CS 16 STRAPPING (12" MIN) TO PORCH HEADER / BAND.
- 1. WHEN A 4-PLY LVL IS USED, ATTACH WITH (1) 1/2" Ø BOLT 12" OC STAGGERED, TOP AND BOTTOM, 1-1/2" MIN FROM ENDS. ALTERNATE ATTACHMENT EQUIVALENT METHOD MAY BE USED, SUCH AS SDW OR TRUSSLOK SCREWS (SEE MANUFACTURER'S SPECIFICATIONS).
- 2. FOR STUD COLUMNS OF 4 OR MORE, INSTALL SST CS16 STRAPS @ 30" OC, 6" MAX FROM PLATES, ON INSIDE FACE OF COLUMN (EXTERIOR WALL), ON BOTH FACES OF COLUMN (INTERIOR WALL).

CRAWL SPACE VENTILATION

THE MINIMUM NET AREA OF VENTILATION OPENINGS SHALL NOT BE LESS THAN 1 SQUARE FOOT FOR EACH 150 SQUARE FEET OF UNDERFLOOR SPACE AREA, AND ONE SUCH OPENING SHALL BE WITHIN 3 FEET OF EACH CORNER OF THE BUILDING.

EXCEPTION: THE TOTAL AREA OF VENTILATION MAY BE REDUCED TO 1/1500 OF THE UNDERFLOOR AREA WHERE THE GROUND SURFACE IS TREATED WITH AN APPROVED VAPOR RETARDER MATERIAL AND THE REQUIRED OPENINGS ARE PLACED SO AS TO PROVIDE CROSS-VENTILATION.

> SQUARE FEET OF TOTAL CRAWL SPACE / 150 =

SQUARE FEET OF NET-FREE VENTILATION REQUIRED

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FOUNDATION PLAN

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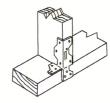


LCE4 BRACING CON.

☐ LCE4 CLIP TO HEADER JACK △ CONNECTION AND A35 CLIP AT THE JACK BOTTOM PLATE CONNECTION

CS16 STRAP FROM STUD, CROSS HEADER, TO WALL TOP PLATE, 36" LONG MIN.

SIMPSON HTT4 HOLD DOWN FOR ATTACHMENT TO CONCRETE OR MSTA18 STRAP FOR WOOD CONNECTIONS.




INSTALLATION



INSTALLATION

LOWER BRACING CON. NTS A35 CLIP WITH SD9112 SCREWS

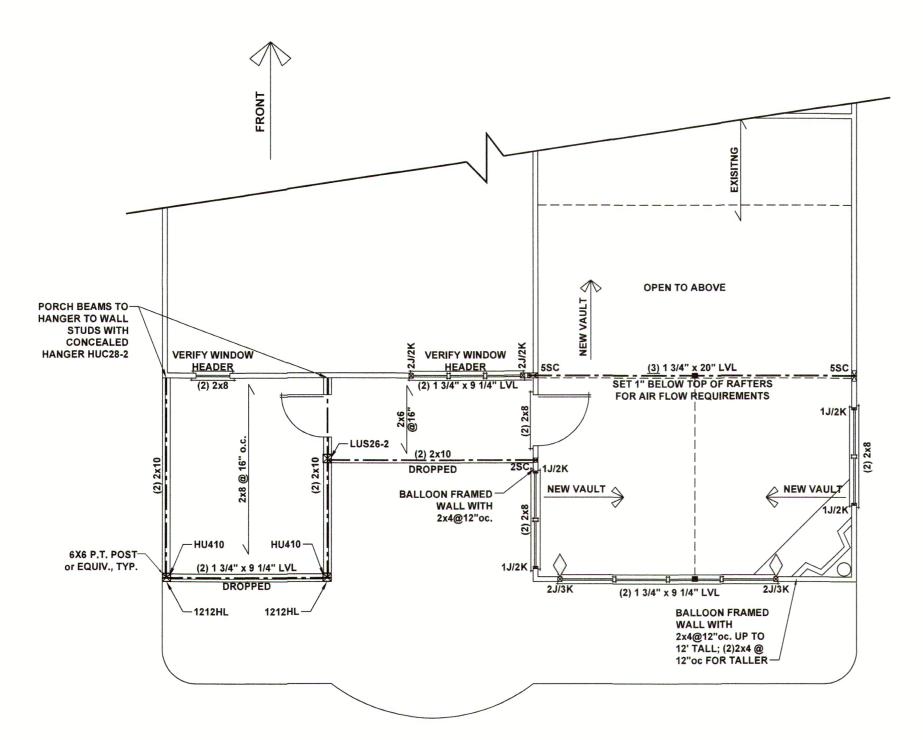

CEILING FRAMING PLAN

BEAM & POINT LOAD LEGEND

INTERIOR LOAD BEARING WALL ROOF RAFTER / TRUSS SUPPORT · DOUBLE RAFTER / DOUBLE JOIST

--- STRUCTURAL BEAM / GIRDER WINDOW / DOOR HEADER

POINT LOAD TRANSFER

POINT LOAD FROM ABOVE **BEARING ON BEAM / GIRDER**

STRUCTURAL FRAMING NOTES - (SEE GENERAL NOTES SHEET FOR ADDITIONAL REQUIREMENTS.)

ALL FRAMING TO BE #2 SPF MINIMUM.

2. ALL BEARING HEADERS TO BE (2) 2x6 SUPPORTED w/ MIN (1) JACK AND (1) KING EACH END, UNO.

EXTERIOR WALL OPENINGS OVER 3' TO HAVE MULTIPLE KING STUDS AS NOTED ON PLAN.

ALL NON-BEARING HEADERS TO BE (2) 2x4 (1) J / (1) K, UNO.

PROVIDE CONTINUOUS BLOCKING THROUGH STRUCTURE FOR ALL POINT LOADS.

ALL HANGERS AND CONNECTORS SPECIFIED ARE TO BE SIMPSON STRONG-TIE OR EQUIVALENT.

ALL BEAMS SPECIFIED ARE MINIMUM SIZES ONLY. LARGER MEMBERS MAY SUBSTITUTED AS NEEDED FOR EASE OF CONSTRUCTION. MINIMUM BEAM SUPPORT IS (1) 2x4 STUD.

ALL EXTERIOR WALLS TO BE FULLY SHEATHED WITH 7/16" OSB.

FRONT PORCH COLUMNS TO BE MIN 4x4 PT ATTACHED AT TOP AND BOTTOM USING SIMPSON (OR EQUIV) COLUMN BASE OR SST A24 BRACKETS. TRIM OUT PER BUILDER.

10. PORCH COLUMNS TO BE MIN 4x4 PT ATTACHED AT BOTTOM USING SIMPSON (OR EQUIV) ABA44 AND AT TOP USING CS 16 STRAPPING (12" MIN) TO PORCH HEADER / BAND.

1. WHEN A 4-PLY LVL IS USED, ATTACH WITH (1) 1/2" Ø BOLT 12" OC STAGGERED, TOP AND BOTTOM, 1-1/2" MIN FROM ENDS. ALTERNATE ATTACHMENT EQUIVALENT METHOD MAY BE USED, SUCH AS SDW OR TRUSSLOK SCREWS (SEE MANUFACTURER'S SPECIFICATIONS).

2. FOR STUD COLUMNS OF 4 OR MORE, INSTALL SST CS16 STRAPS @ 30" OC, 6" MAX FROM PLATES, ON INSIDE FACE OF COLUMN (EXTERIOR WALL), ON BOTH FACES OF COLUMN (INTERIOR WALL).

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ALL HANGERS TO BE LUS26-2 FOR TWO PLY SAWN LUMBER BANDS, JOISTS, HEADERS, AND BEAMS UNLESS OTHERWISE NOTED.



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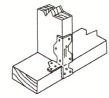
CEILING FRAMING PLAN

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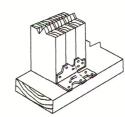


LCE4 BRACING CON.

- ∇ LCE4 CLIP TO HEADER JACK △ CONNECTION AND A35 CLIP AT THE **JACK BOTTOM PLATE CONNECTION**
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- SIMPSON HTT4 HOLD DOWN FOR ATTACHMENT TO CONCRETE OR MSTA18 STRAP FOR WOOD







ALTERNATE INSTALLATION

LOWER BRACING CON. NTS A35 CLIP WITH SD9112 SCREWS

WALL BRACING REQUIREMENTS

- MINIMUM PANEL WIDTH IS 24" FIGURES BASED ON THE CONTINUOUS SHEATHING METHOD USING THE RECTANGLE CIRCUMSCRIBED AROUND THE FLOOR PLAN OR PORTION OF THE FLOOR PLAN. IF NO RECTANGLE IS NOTED, THE STRUCTURE HAS BEEN FIGURED ALL WITHIN ONE RECTANGLE.
- ALL WSP NOTED ON PLAN ARE TO BE CONSIDERED
- PANELS MAY SHIFT UP TO 36" EITHER DIRECTION FOR EASE OF CONSTRUCTION (NAILING & BLOCK REQUIREMENTS STILL APPLY).
- FOR ADDITIONAL WALL BRACING INFORMATION, REFER TO WALL BRACING DETAIL SHEET(S). - SCHEMATIC BELOW INDICATES HOW SIDES OF RECTANGLE ARE TO BE INTERPRETED IN BRACING CHART WHEN APPLIED TO STRUCTURE:



ackslash CS16 STRAP FROM STUD, CROSS HEADER, TO ✓ WALL TOP PLATE, 36" LONG MINIMUM

SIMPSON MSTA15 HOLD DOWN CAPACITY OF 970 POUNDS PER ANCHOR WITH (12) 10d NAILS. STRAP TO BE LOCATED AT EDGE OF BRACED WALL PANEL. (CS16 STRAPPING MAY BE SUBSTITUTED w/ SIMILAR LENGTH AND NAILING PATTERN.) USE HTT4 FOR ATTACHMENT TO CONCRETE.

SCALED LENGTH OF WALL PANEL AT LOCATION -

-NUMERICAL LENGTH -PANEL TYPE

OF PANEL

WALL BRACING NOTE:

WALLS WITH PROVIDED LENGTH LISTED AS "N/A" DO NOT MEET THE REQUIREMENTS OF PRESCRIPTIVE WALL BRACING FOUND IN THE NCRC. THESE WALLS ARE ENGINEERED DESIGN BASED ON DESIGN GUIDELINES ESTABLISHED IN ASCE-07 AND THE NDS: WIND & SEISMIC PROVISIONS SUPPLEMENT.

ENGINEERED WALL SCHEDULE

- ENG1: CONTINUOUSLY SHEATH WITH 7/16" OSB ATTACHED WITH 8d NAILS @ 6" OC EDGE AND 12" OC FIELD. FULLY BLOCKED AT ALL PANEL
- ENG2: CONTINUOUSLY SHEATH WITH 7/16" OSB WITH 10d NAILS @ 3" OC EDGE AND 3" OC FIELD. FULLY BLOCKED AT ALL PANEL EDGES.
- ENG3: CONTINUOUSLY SHEATH 7/16" OSB ATTACHED BOTH SIDES WITH 8d NAILS @ 4" OC EDGE AND 8" OC FIELD. FULLY BLOCKED AT ALL PANEL EDGES.
- ENG4: CONTINUOUSLY SHEATH 7/16" OSB ATTACHED WITH 8d NAILS @ 4" OC EDGE AND 8" OC FIELD. FULLY BLOCKED AT ALL PANEL EDGES.



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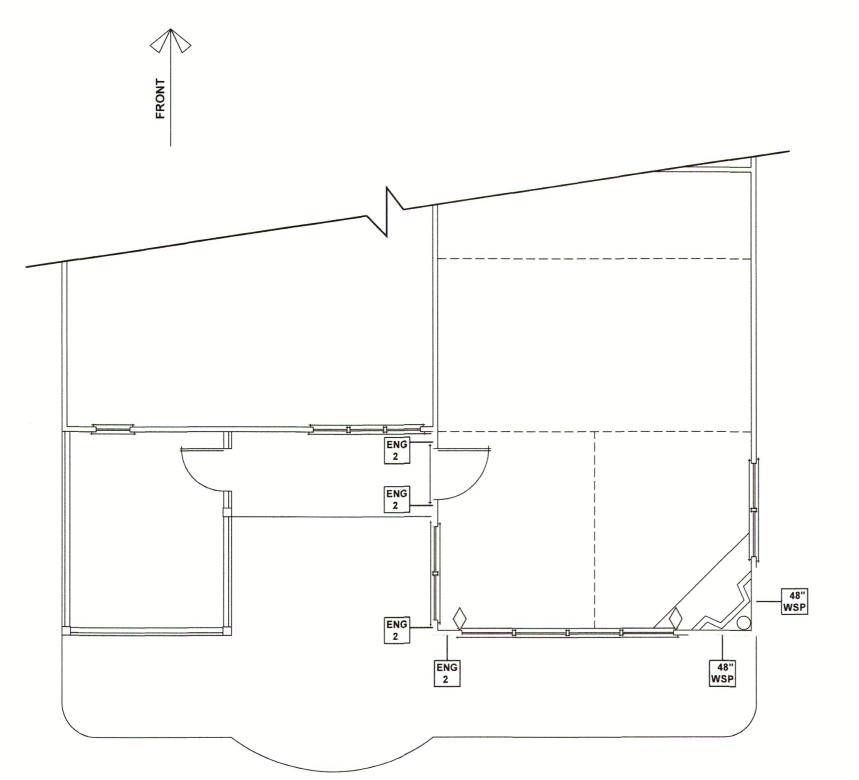
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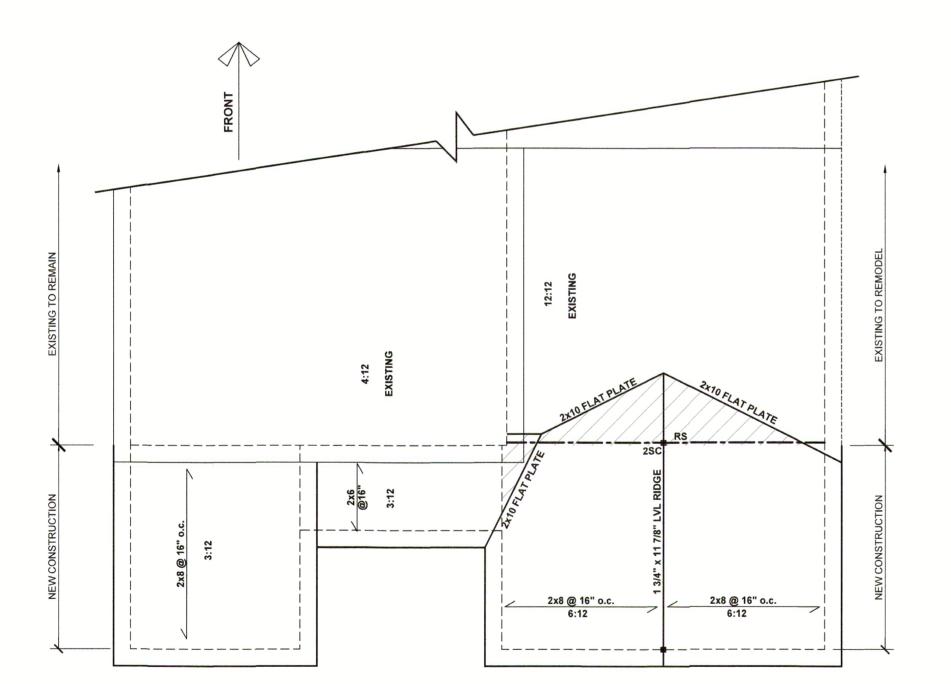
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WALL BRACING PLAN

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WALL BRACING PLAN



ROOF FRAMING PLAN

BEAM & POINT LOAD LEGEND

INTERIOR LOAD BEARING WALL

ROOF RAFTER / TRUSS SUPPORT
DOUBLE RAFTER / DOUBLE JOIST

STRUCTURAL BEAM / GIRDER
WINDOW / DOOR HEADER

POINT LOAD TRANSFER

POINT LOAD FROM ABOVE BEARING ON BEAM / GIRDER

STICK-FRAMED ROOF - STRUCTURAL NOTES

- 1. FRAMING SHALL BE #2 SPF OR BETTER, UNO.
- 2. PROVIDE 2x4 COLLAR TIES AT 48" OC AT UPPER THIRD OF RAFTERS, UNLESS NOTED OTHERWISE ON PLAN.
- 3. FUR RIDGES FOR FULL RAFTER CONTACT.
- 4. PROVIDE CONTINUOUS BLOCKING THROUGH STRUCTURE FOR ALL POINT LOADS.

DENOTES OVER-FRAMED AREA

- 6. MINIMUM 7/16" OSB ROOF SHEATHING
- PROVIDE 2x4 RAFTER TIES AT 16" OC AT 45°
 BETWEEN RAFTERS AND CEILING JOISTS. USE
 (4) 16d NAILS AT EACH CONNECTION. RAFTER
 TIES MAY BE SPACED AT 48" OC AT LOCATIONS
 WHERE NO KNEE WALLS ARE INSTALLED.
- PROVIDE H2.5A (MINIMUM) OR EQUIVALENT AT EACH RAFTER-TO-TOP PLATE CONNECTION AT OVER-FRAMED AREAS, UNLESS NOTED OTHERWISE
- UPLIFT CONNECTION TO BE CARRIED THROUGH TO FLOOR SYSTEM.

ATTIC VENTILATION - FOR NEW AREA ONLY

THE TOTAL NET-FREE VENTILATION AREA SHALL NOT BE LESS THAN 1/150 OF THE AREA OF THE ATTIC SPACE TO BE VENTILATED. THE TOTAL VENTILATION MAY BE REDUCED TO 1/300 PROVIDED AT LEAST 50% BUT NOT MORE THAN 80% OF THE REQUIRED VENTILATION BE LOCATED IN THE UPPER PORTION OF THE AREA TO BE VENTILATED, OR AT LEAST 3' ABOVE THE SOFFIT VENTILATION INTAKE.

408 SQUARE FEET OF TOTAL ATTIC / 150 =

2.72 SQUARE FEET OF NET-FREE VENTILATION REQUIRED

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ROOF FRAMING PLAN

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