

**EXISTING FRAMING PLAN** 

1/4" = 1'-0"

\* Engineers seal does not include construction means, methods, techniques, sequences, procedures or safety precaution.

\* Any deviations or discrepancies on plans are to be brought to the immediate attention of Tyndall Engineering & Design, P.A. Failure to do so will void Tyndall Engineering & Design, P.A. Liballity.

\* Please review these documents carefully.

Tyndall Engineering & Design, P.A. will interpret that all dimensions, recommendations, etc. presented in these documents were deemed acceptable once construction begins.




155 BLUE PINE DRIVE SPRING LAKE, NC



Project #: 2301-020116	
Date: 02/09/23	
Engineered By: AM	
DWG. Checked By: AWL	
Scale:	

	REVISIONS	
No.	Date:	Remarks
$\Lambda$		
2		
3		
4		

**S**1

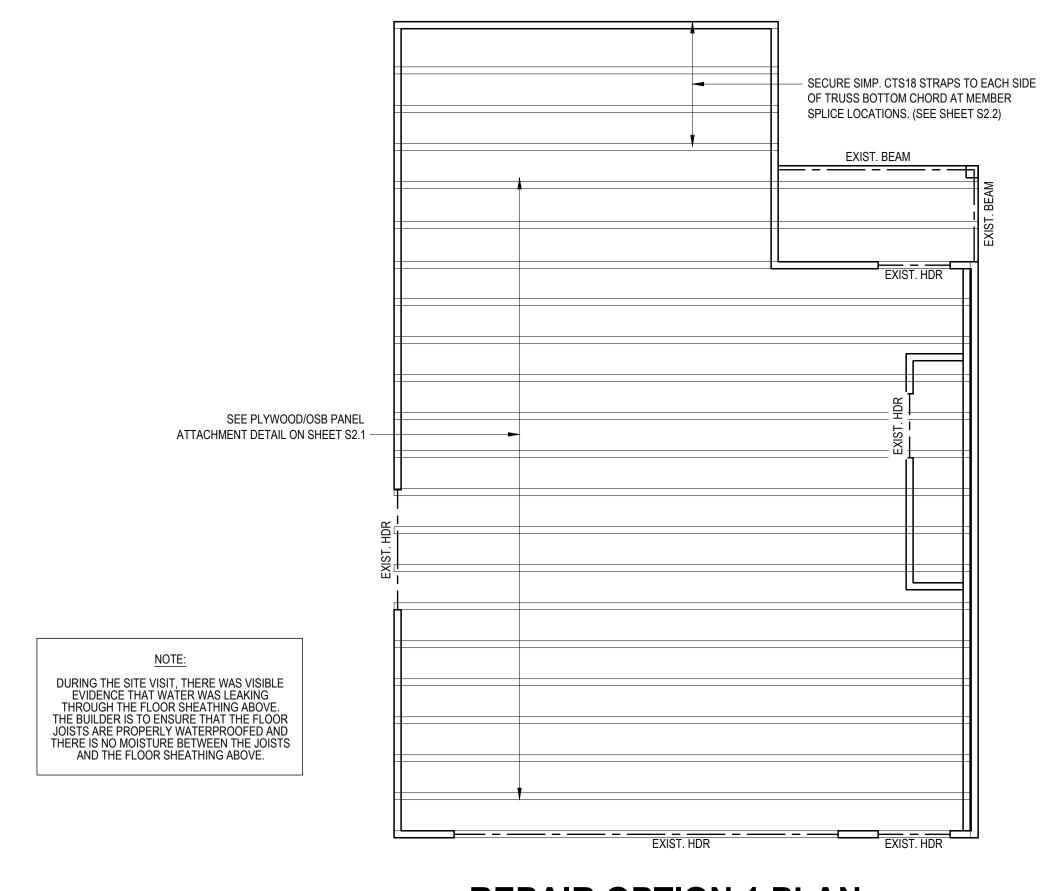

## **REPAIR OPTION 1 PLAN**

1/4" = 1'-0"

Engineers seal does not include con-means, methods, techniques, seque


means, methods, techniques, sequences, procedures or safety precaution.

\* Any deviations or discrepancies on plans are to be brought to the immediate attention of Tyndall Engineering & Design, P.A. Faliure to do so will void Tyndall Engineering & Design, P.A. liability.

\* Please review these documents carefully. Tyndall Engineering & Design, P.A. will interpret that all dimensions, recommendations, etc. presented in these documents were deemed acceptable once construction begins.





155 BLUE PINE DRIVE SPRING LAKE, NC

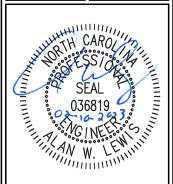

Project #: 2301-020116 Scale: SEE PLAN

	REVISIONS	
No.	Date:	Remarks
$\Lambda$		
2		
3		
4		

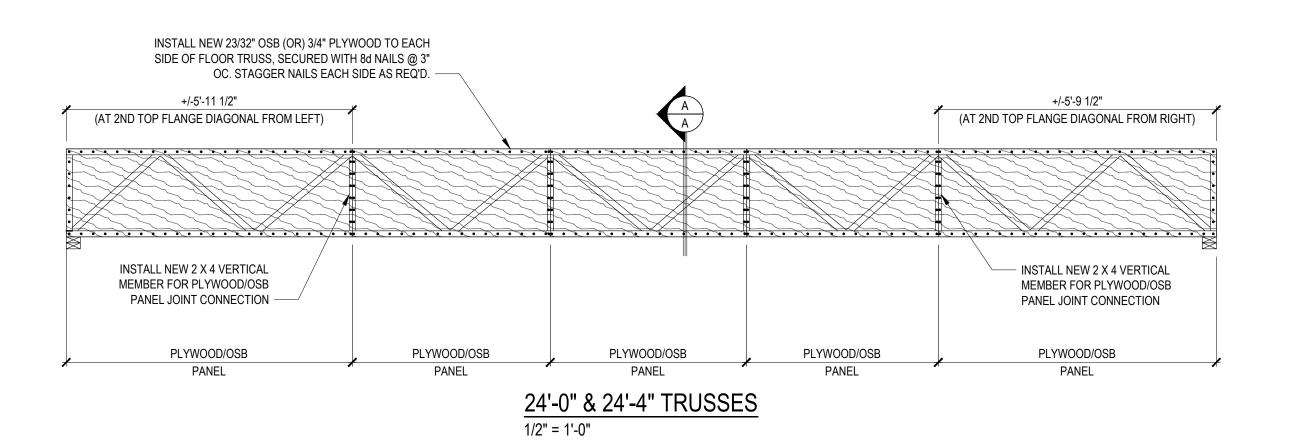

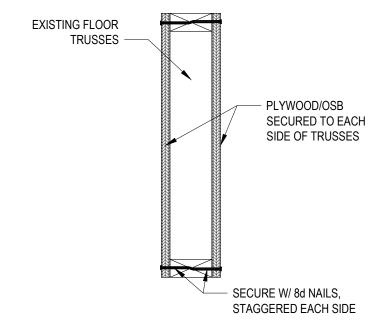

SECTON A-A

1-1/2" = 1'-0"

\* Engineers seal does not include construction means, methods, techniques, sequences, procedures or safety precaution.

- Any deviations or discrepancies on plans are to be brought to the immediate attention of Tyndall Engineering & Design, P.A. Failure to do so will void Tyndall Engineering & Design, P.A. Ilability.
- Tyndall Engineering & Design, P.A. will interpret that all dimensions, recommend etc. presented in these documents were deemed acceptable once construction begins.

LYNDALL.



Plan:



Project #:
2301-020116

Date:
02/09/23

Engineered By:
AM


DWG. Checked By:
AWL

Scale:
SEE PLAN

Sheet Number

S2.1

3 of 9

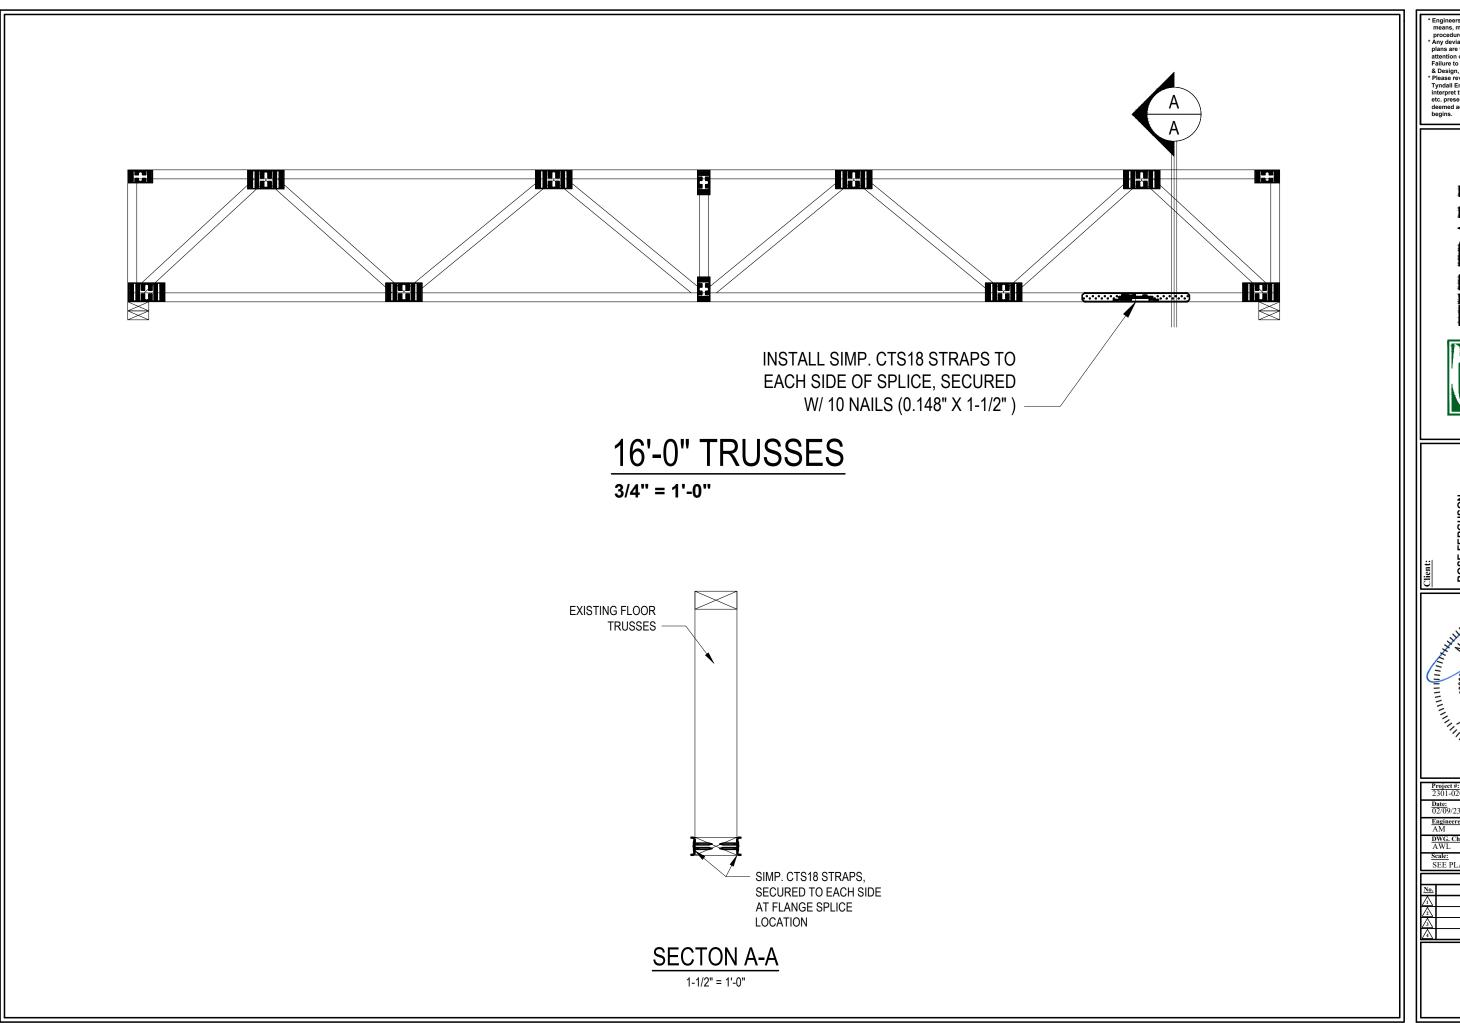

\* Engineers seal does not include construction means, methods, techniques, sequences,

> Any deviations or discrepancies on plans are to be brought to the immediate attention of Tyndall Engineering & Design Failure to do so will void Tyndall Enginee

Tylease review these documents carefull Tyndall Engineering & Design, P.A. will interpret that all dimensions, recommen etc. presented in these documents were deemed acceptable once construction begins.

TYNDALL ENGINEERING & DESIGN, P.A.



Plan:



Project #:
2301-020116

Date:
02(09)/23

Engineered By:
AM

DWG. Checked By:
AWL


Scale:
SEE PLAN

	REVISIO	ONS
No.	Date:	Remarks
$\Lambda$		
2		
3		
4		

Sheet Number

S2.2

1 -c 0

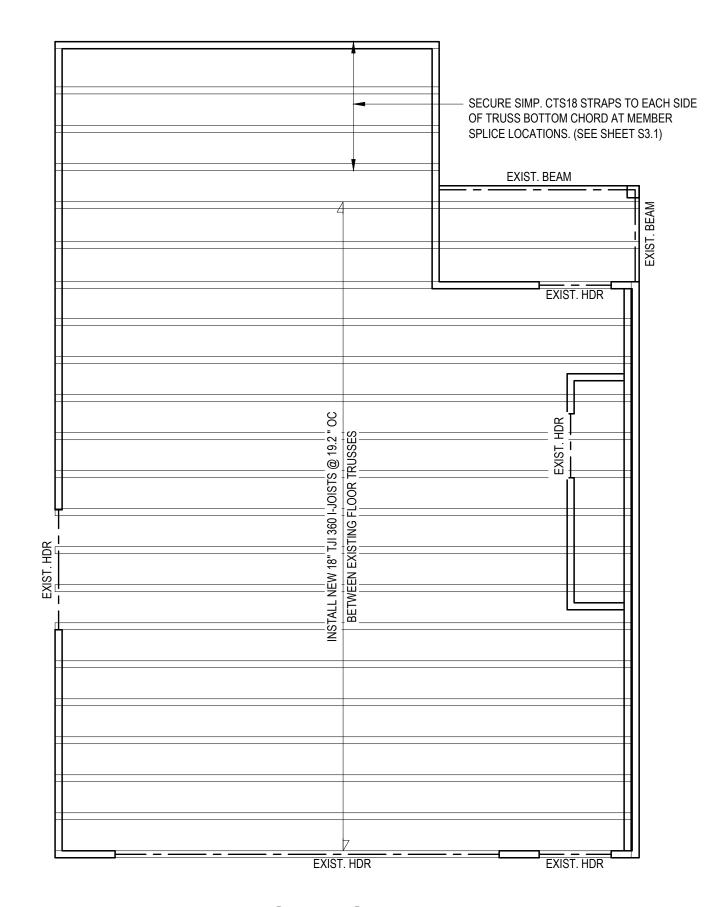

### NOTE:

DURING THE SITE VISIT, THERE WAS VISIBLE EVIDENCE THAT WATER WAS LEAKING THROUGH THE FLOOR SHEATHING ABOVE. THE BUILDER IS TO ENSURE THAT THE FLOOR JOISTS ARE PROPERLY WATERPROOFED AND THERE IS NO MOISTURE BETWEEN THE JOISTS AND THE FLOOR SHEATHING ABOVE.

## **REPAIR OPTION 2 PLAN**

1/4" = 1'-0"

Engineers seal does not include con-means, methods, techniques, seque


means, methods, techniques, sequences, procedures or safety precaution.

\* Any deviations or discrepancies on plans are to be brought to the immediate attention of Tyndall Engineering & Design, P.A. Faliure to do so will void Tyndall Engineering & Design, P.A. liability.

\* Please review these documents carefully. Tyndall Engineering & Design, P.A. will interpret that all dimensions, recommendations, etc. presented in these documents were deemed acceptable once construction begins.




155 BLUE PINE DRIVE SPRING LAKE, NC

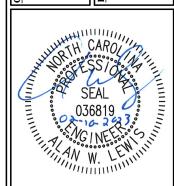

Project #: 2301-020116

**S**3

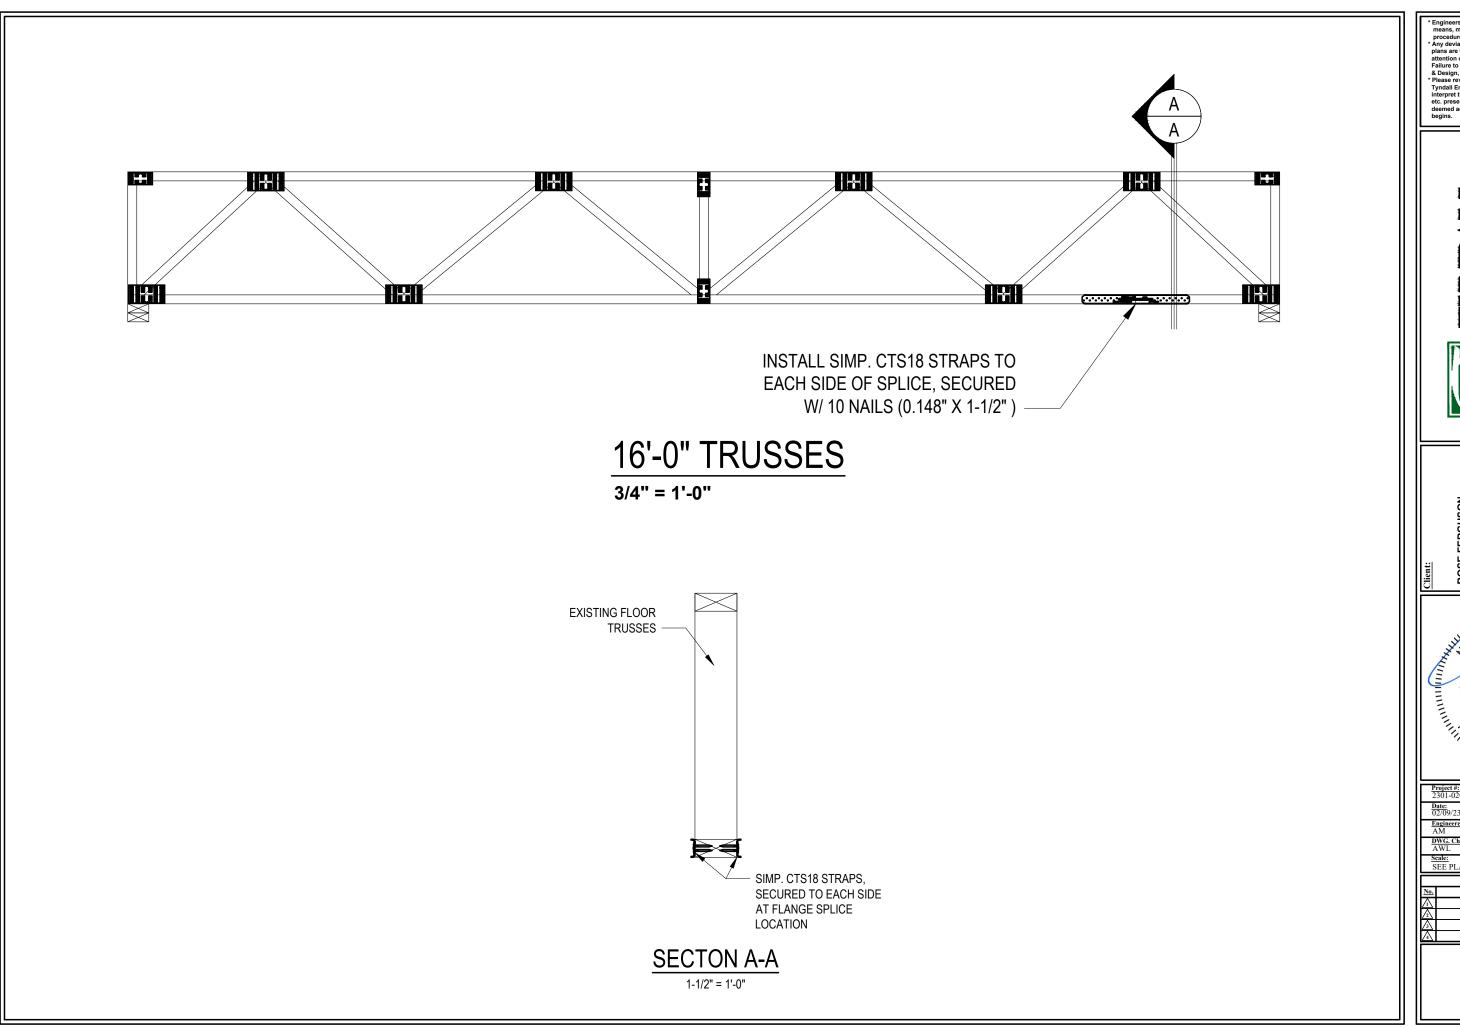

\* Engineers seal does not include constructio means, methods, techniques, sequences,

oroceaures or salety precaution. Any deviations or discrepancies on lans are to be brought to the immediate ttention of Tyndall Engineering & Design, l

Please review these documents carefully Tyndall Engineering & Design, P.A. will interpret that all dimensions, recommend etc. presented in these documents were deemed acceptable once construction

TYNDALL ENGINEERING & DESIGN, PA.



Plan: 445 RI HE DINE DRIVE



Project #:
2301-020116

Date:
02(09/23

Engineered By:
AM

DWG. Checked By:
AWL


Scale:
SEE PLAN

	REVISIO	ONS
No.	Date:	Remarks
$\Lambda$		
2		
3		
4		

Sheet Number

S3.1

6 . 0

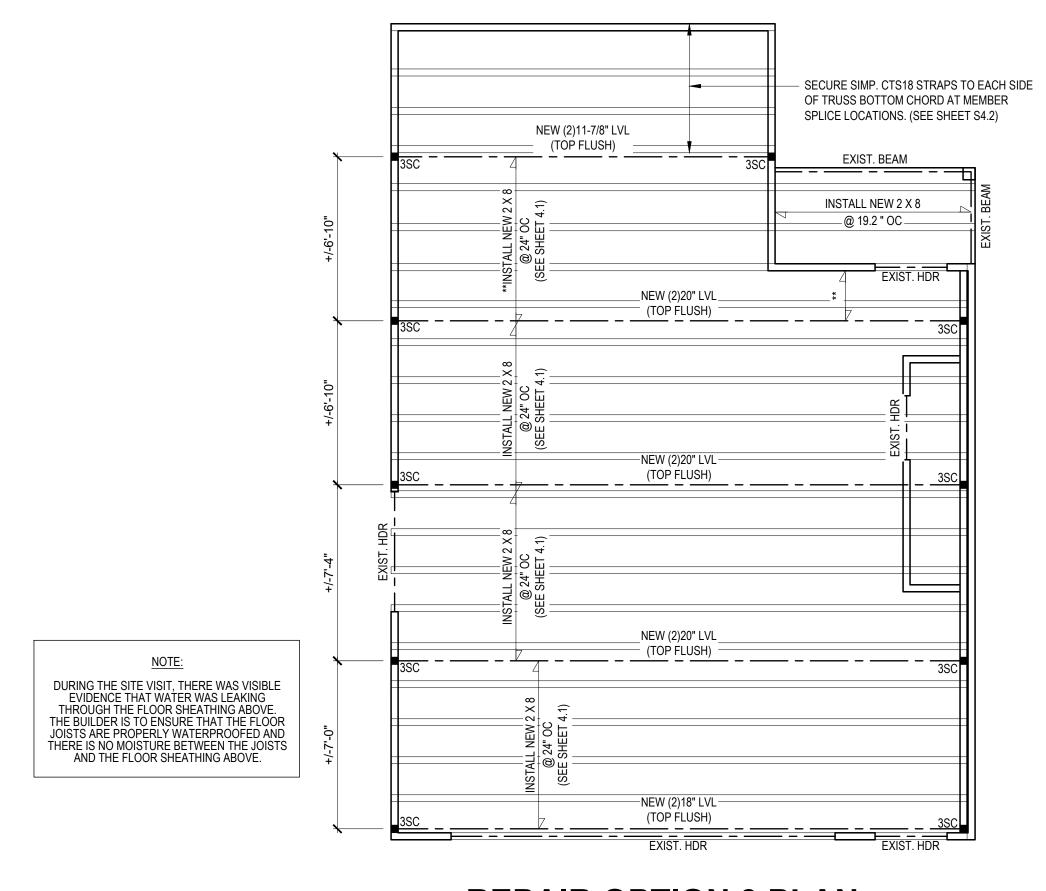

## **REPAIR OPTION 3 PLAN**

1/4" = 1'-0"

Engineers seal does not include co means, methods, techniques, sequ


means, methods, techniques, sequences, procedures or safety precaution.

Any deviations or discrepancies on plans are to be brought to the immediate attention of Tyndall Engineering & Design, P.A. Fallure to do so will void Tyndall Engineering & Design, P.A. liability.

Please review these documents carefully. Tyndall Engineering & Design, P.A. will interpret that all dimensions, recommendations, etc. presented in these documents were deemed acceptable once construction begins.



155 BLUE PINE DRIVE SPRING LAKE, NC

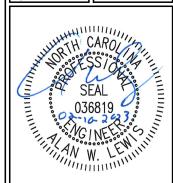


	Project #: 2301-020116
	Date: 02/09/23
	Engineered By: AM
	DWG. Checked By: AWL
-	Scale:

	REVISIONS	
No.	Date:	Remarks
$\Lambda$		
2		
3		
4		

**S4** 

7 of 9

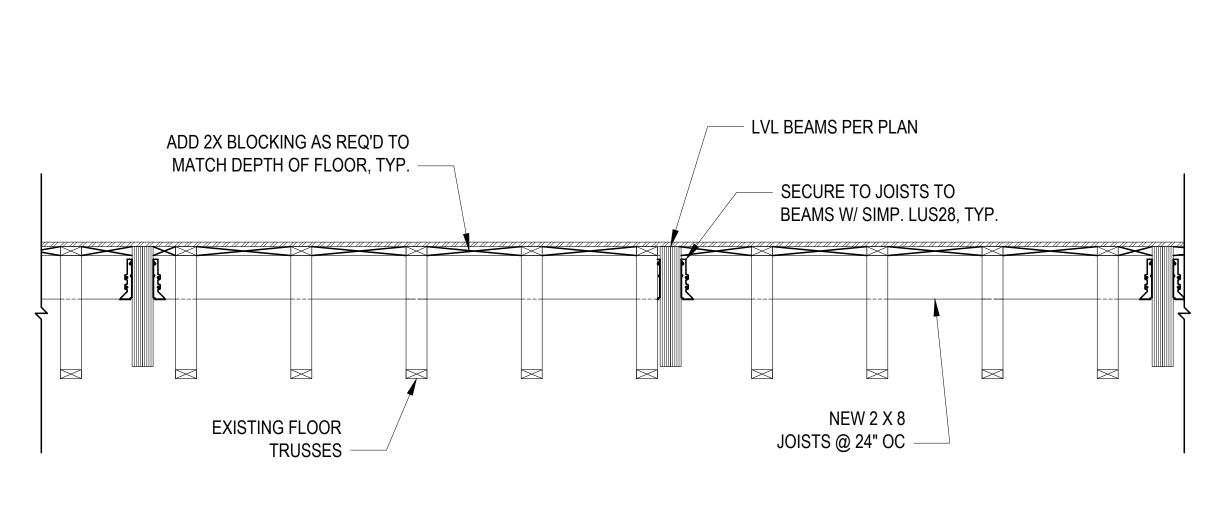

# NEW LVL BEAM INSTALLATION

SCALE: 3/4" = 1'-0"

\* Engineers seal does not include construct means, methods, techniques, sequences,

> ony deviations or discrepancies on lans are to be brought to the immediate ttention of Tyndall Engineering & Design, ailure to do so will void Tyndall Engineerin

> Please review these documents carefully. yndall Engineering & Design, P.A. will therpret that all dimensions, recommendat tc. presented in these documents were eemed acceptable once construction

TYNDALL ENGINEERING & DESIGN, P.A.



Plan:



Project #:
2301-020116

Date:
02/09/23

Engineered By:
AM


DWG. Checked By:
AWL

Scale:
SEE PLAN

Sheet Number

S4.1

Q of Q

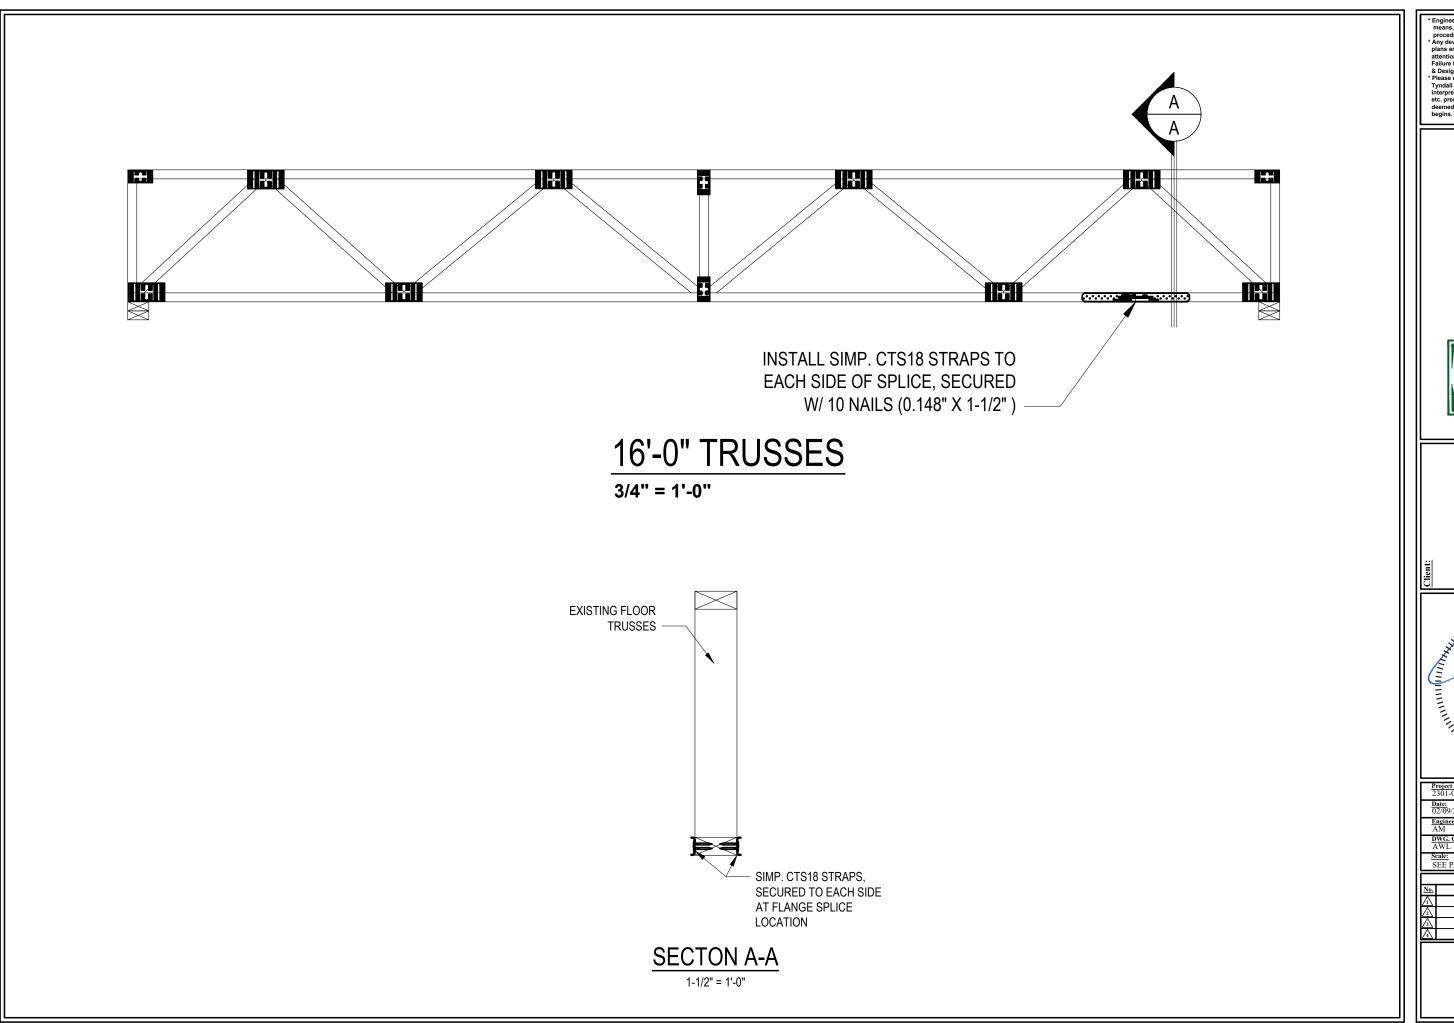

\* Engineers seal does not include construction means, methods, techniques, sequences,

uny deviations or discrepancies on lans are to be brought to the immediate ttention of Tyndall Engineering & Design, allure to do so will void Tyndall Engineerii

\* Please review these documents carefully Tyndall Engineering & Design, P.A. will interpret that all dimensions, recommend etc. presented in these documents were deemed acceptable once construction

> TYNDALL ENGINEERING & DESIGN, P.A.



Plan:



Project #:
2301-020116

Date:
02'09'23

Engineered By:
AM

DWG, Checked By:
AWL

Scale:
SEE PLAN

Sheet Number

S4.2

0 -c 0