


STRUCTURAL NOTES:

1. STRUCTURE IS DESIGNED FOR A MAXIMUM DESIGN FLOOR LOAD OF 40 POUNDS PER SQUARE FOOT (PSF) LIVE LOAD AND 10 POUNDS PER SQUARE FOOT (PSF) DEAD LOAD

2. ANCHOR STRAP MATERIAL SHALL BE 1 1/4" WIDE AND 0.035 INCHES THICK AND SHALL CONSIST OF TYPE 1, FINISH B, GRADE 1 STEEL CONFORMING TO ASTM D 3953-97.

3. THIS DESIGN MEETS INTERNATIONAL CODE COUNCIL REQUIREMENTS FOR 130 MPH WIND SPEED (MAXIMUM) AND SEISMIC ZONE D.

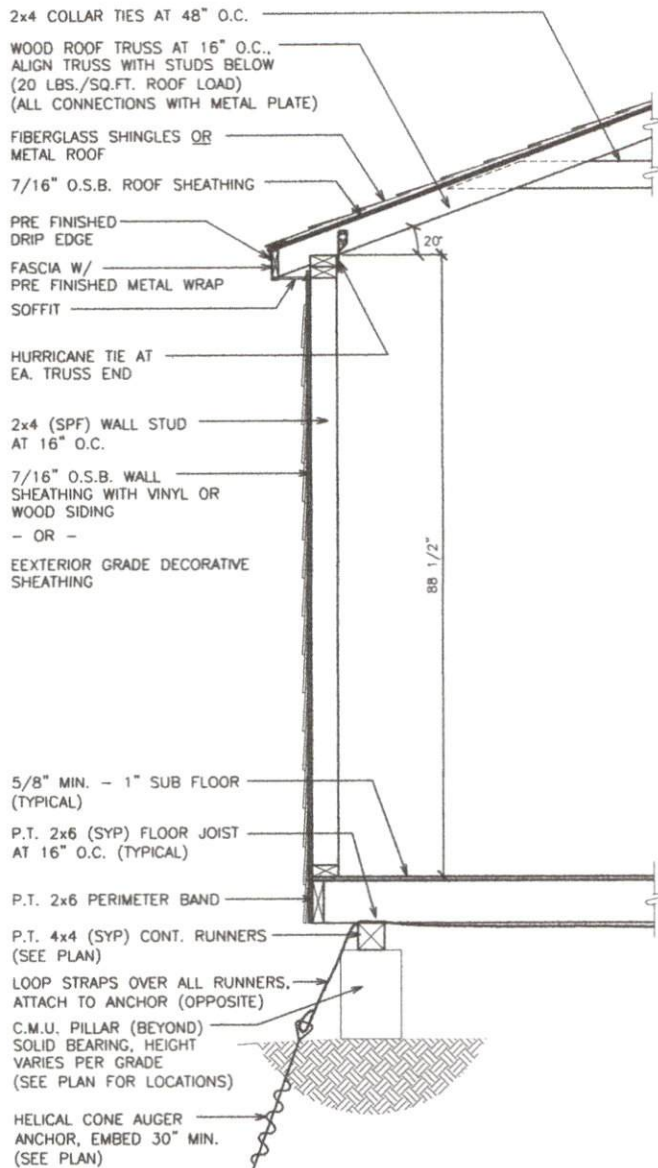

BUILDING SERIES: VINYL - DELUXE	SIZE: SEE PLAN
SHEET NAME: TYPICAL WALL SECTION	SCALE: 5/8" = 1'-0"
WELLS ENGINEERING, PLLC 3401 LONDONDERRY DRIVE GREENSBORO, NC 27410 PHONE: 336.545.0149	DRAWN BY: DOUG GAITHER
	DATE DRAWN: 11.17.14



