


Harnett 01/18/2023

FRONT ELEVATION

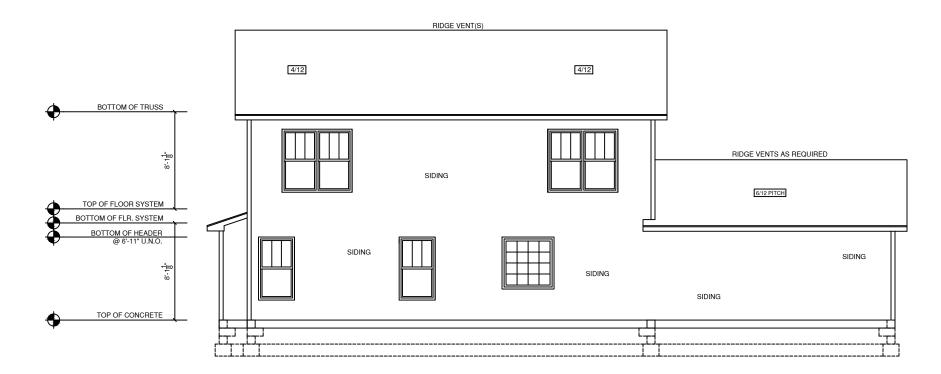

REAR ELEVATION SCALE: 1/8" = 1'-0" **BUYER** DATE

BUYER DATE

FINAL 106-22-144 ARAGON

GENERAL NOTES

1.) MAIN FLOOR PLATE HEIGHT TO BE 8'-0" UNLESS NOTED OTHERWISE. 2.) OPTIONAL BONUS PLATE HEIGHT TO BE 8'-0" UNLESS NOTED OTHERWISE.

3.) INTERIOR & EXTERIOR WALLS TO BE DRAWN @ 3 1/2" UNLESS NOTED OTHERWISE.

4.) ALL ANGLES TO BE DRAWN AT 45° OR 90° UNLESS NOTED OTHERWISE. OR 90° UNLESS NOTED OTHERWISE.

5.) WINDOW HEADER HEIGHT TO BE SET @
6'-11" UNLESS NOTED OTHERWISE. HEADER
SIZE AND MATERIAL TO BE DETERMINED &
VERIFIED BY FRAMER, BUILDER, TRUSS SHOP
OR BY A LICENSED ENGINEER.
6.) SIZE, LOCATION AND MATERIALS OF BEAMS
TRUSSES, GIRDERS AND HEADERS TO BE
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12.) BUILDER TO VERIFY ALL DIMENSIONS.

12.) BUILDER TO VERIFY ALL DIMENSIONS.

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SQUARE FOOTAGE CHART

FIRST FLOOR AREA TO FRAME:	1360
SECOND FLOOR AREA TO FRAME:	628
HEATED & COOLED TO FRAME:	1988
COVERED FRONT PORCH	204
GARAGE AREA TO FRAME	400
TOTAL UNDER BEAM AREA	2592

JOB NUMBER & CLIENT NAME: XXXXXXXXX

ELEVATION:

CABIN

TOWN/CITY:

XXXXXXXXX

COUNTY:


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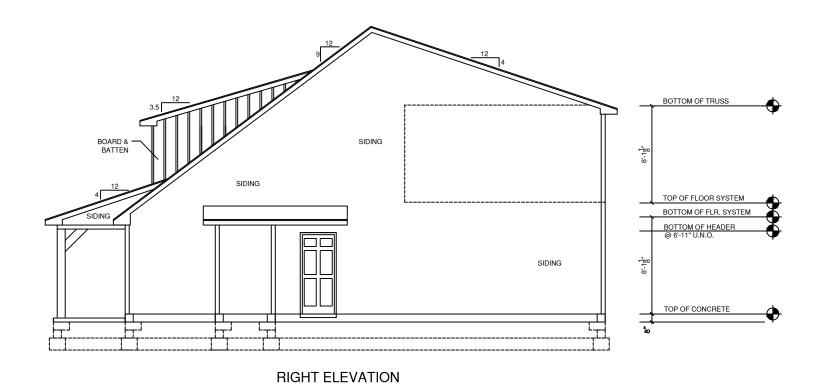
AUTHORED DATE: 2022

DRAFTING UPDATES:

PRELIMINARY: PERM: 09/28/2022 PJM FINAL: 12.15.22 GC

Front & Rear Elevation



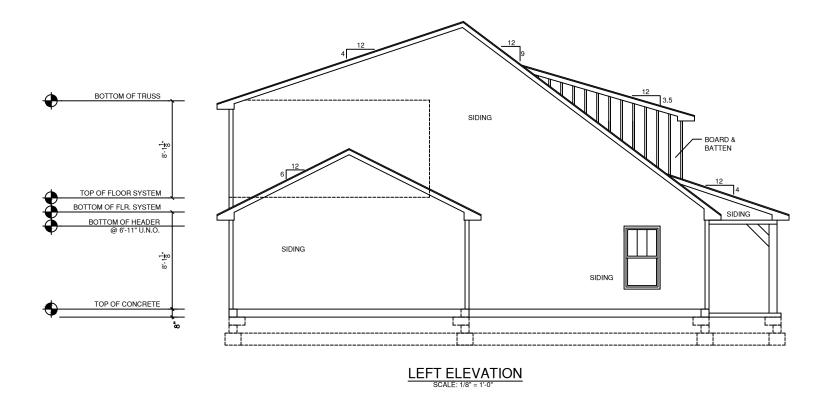

SCALE: 1/8" = 1'-0"

BUYER DATE **BUYER** DATE

FINAL 106-22-144 ARAGON

GENERAL NOTES

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SQUARE FOOTAGE CHART

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JOB NUMBER & CLIENT NAME:

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ELEVATION:

CABIN

TOWN/CITY: XXXXXXXXX

COUNTY:

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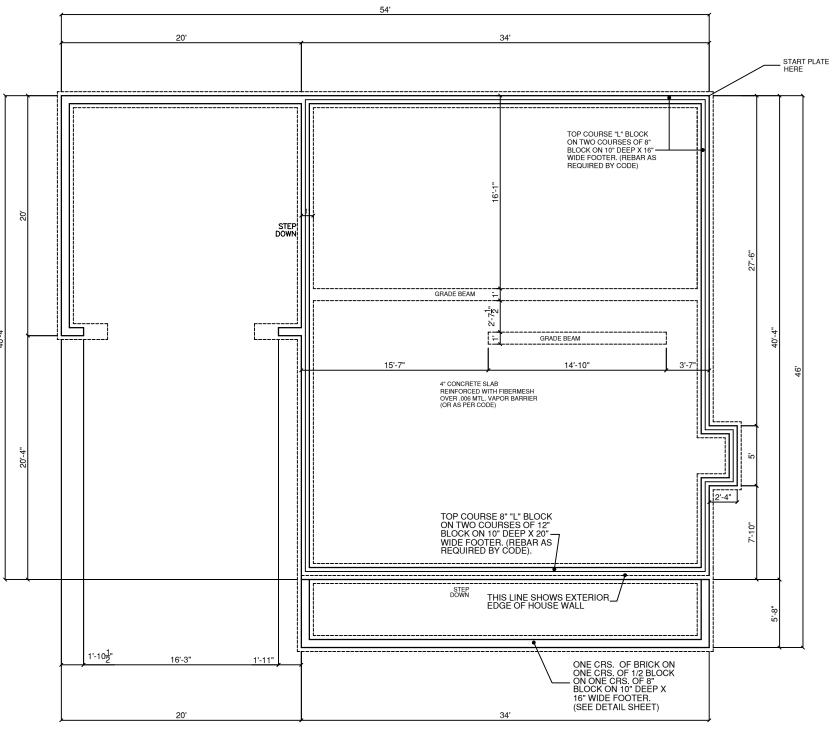
AUTHORED DATE:

2022

DRAFTING UPDATES:

PRELIMINARY: PERM: 09/28/2022 PJM FINAL: 12.15.22 GC

Right & Left Elevation



BLOCK & FILL FOUNDATION PLAN

BUYER DATE **BUYER** DATE

FINAL 106-22-144 ARAGON

GENERAL NOTES

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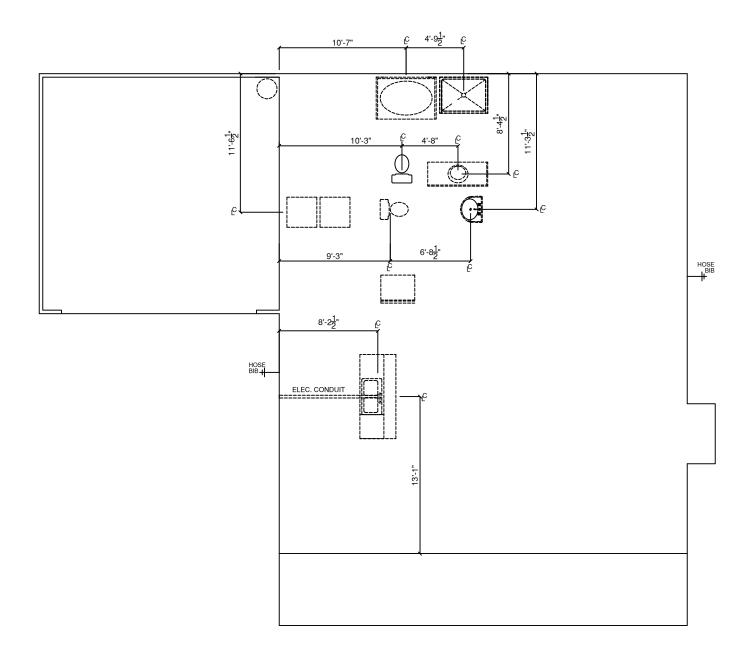
AUTHORED DATE: 2022

DRAFTING UPDATES:

PRELIMINARY: PERM: 09/28/2022 PJM FINAL: 12.15.22 GC

Block & Fill Foundation

NOTE: DIMENSIONS TO THE CENTER OF PLUMBING FIXTURES



PLUMBING PLAN SCALE 1/8" = 1'-0"

BUYER DATE **BUYER** DATE

FINAL 106-22-144 ARAGON

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COUNTY:


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AUTHORED DATE: 2022

DRAFTING UPDATES:

PRELIMINARY: PERM: 09/28/2022 PJM FINAL: 12.15.22 GC

Plumbing Plan

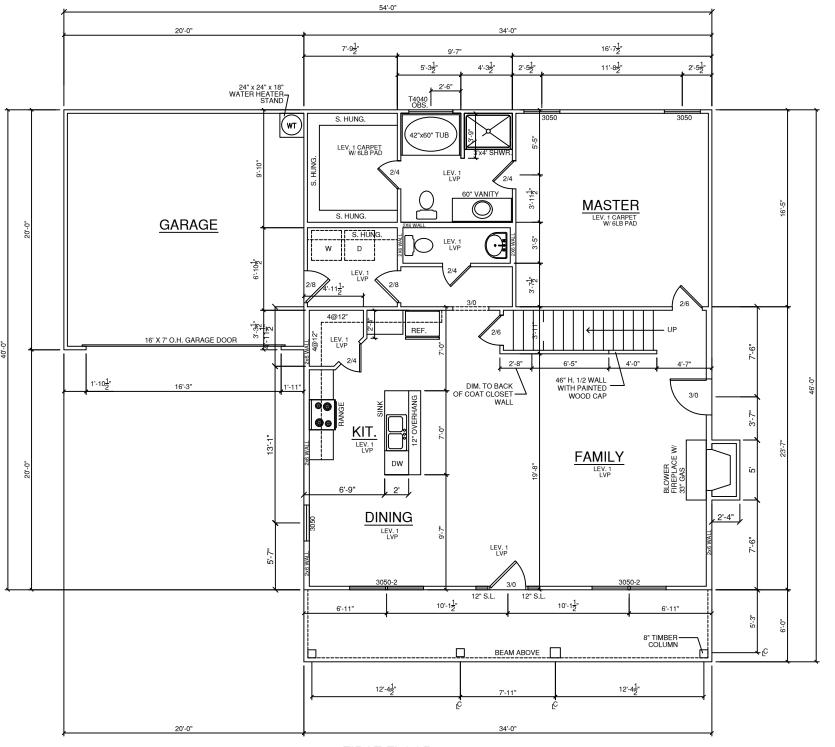

FIRST FLOOR SCALE 1/8" = 1'-0"

BUYER DATE **BUYER** DATE - SELECT SERIES 2 PANEL PLANK CHEYENNE **SMOOTH INTERIOR DOORS**

- LEV. 4 FRIGIDAIRE APPLIANCE PACKAGE S.S. W/ LEVEL 5 S.S. FRENCH DOOR REF.
- STAGGERED 30" & 36" UPPER CABINETS IN KITCHEN
- LEVEL 3 CABINETS IN KITCHEN
- LEVEL 2 CABINETS IN MASTER BATH
- LEVEL 2 CABINETS IN HALL BATH
- GARAGE DOOR OPENER W/ 2 REMOTES

GENERAL NOTES

1.) MAIN FLOOR PLATE HEIGHT TO BE 8'-0" UNLESS NOTED OTHERWISE. 2.) OPTIONAL BONUS PLATE HEIGHT TO BE 8'-0" UNLESS NOTED OTHERWISE.

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SQUARE FOOTAGE CHART

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JOB NUMBER & CLIENT NAME: XXXXXXXXX

ELEVATION:

CABIN

TOWN/CITY:

XXXXXXXXX

COUNTY: XXXXXXXXX

AUTHORED DATE:

2022


DRAFTING UPDATES:

PRELIMINARY: PERM: 09/28/2022 PJM FINAL: 12.15.22 GC

First Floor Plan

BEAUFORT "CABIN"

FINAL 106-22-144 ARAGON

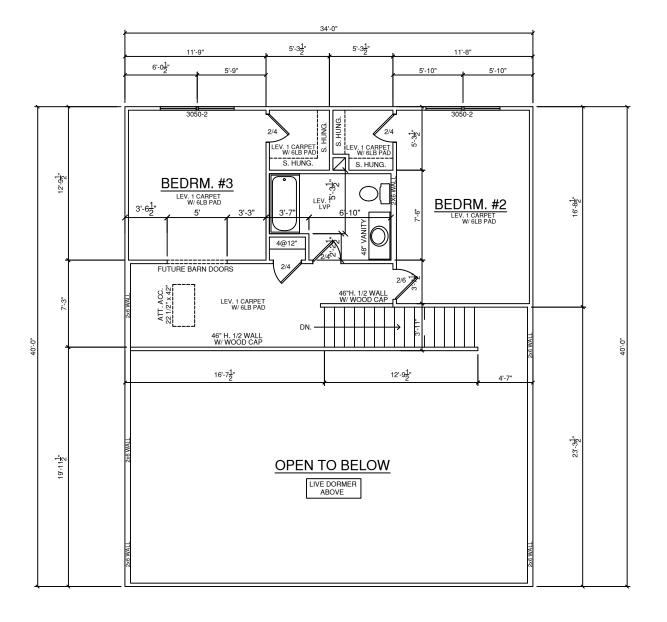

SECOND FLOOR PLAN SCALE 1/8" = 1'-0"

BUYER DATE **BUYER** DATE

FINAL 106-22-144 ARAGON

GENERAL NOTES

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SQUARE FOOTAGE CHART

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GARAGE AREA TO FRAME	400
TOTAL UNDER BEAM AREA	2592

JOB NUMBER & CLIENT NAME:

XXXXXXXXX

ELEVATION: CABIN

TOWN/CITY:

XXXXXXXXX


COUNTY: XXXXXXXXX

AUTHORED DATE: 2022

DRAFTING UPDATES:

PRELIMINARY: PERM: 09/28/2022 PJM FINAL: 12.15.22 GC

Second Floor Plan

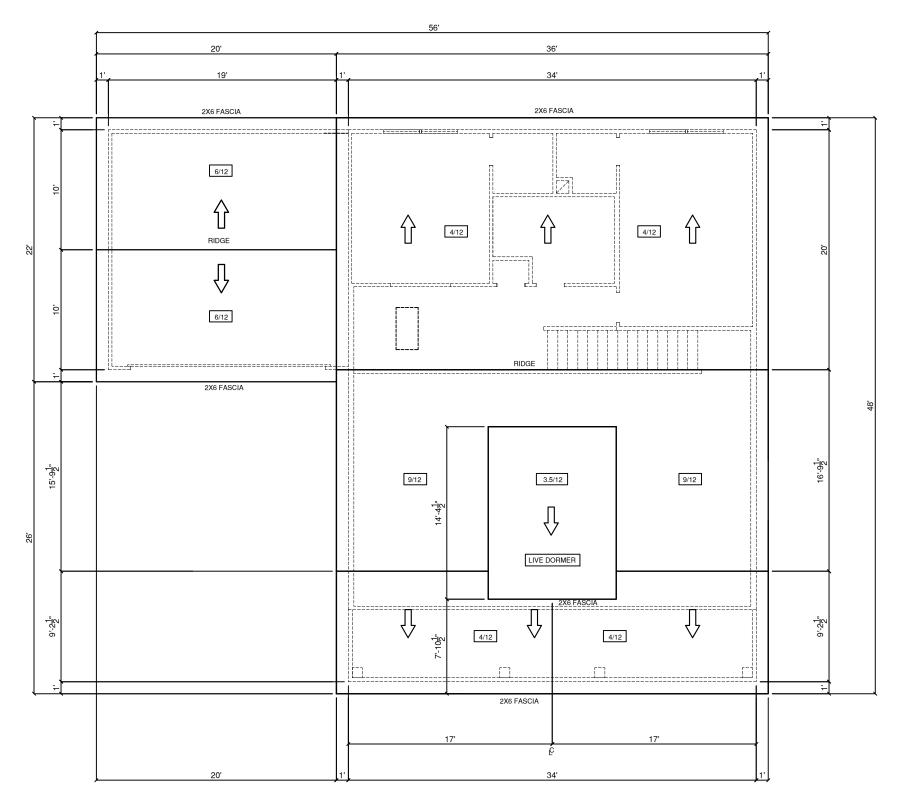

ROOF PLAN
SCALE: 1/8" = 1'-0"

BUYER DATE **BUYER** DATE

FINAL 106-22-144 ARAGON

GENERAL NOTES

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JOB NUMBER & CLIENT NAME: XXXXXXXXX

ELEVATION:

CABIN TOWN/CITY:

XXXXXXXXX

COUNTY:

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AUTHORED DATE: 2022

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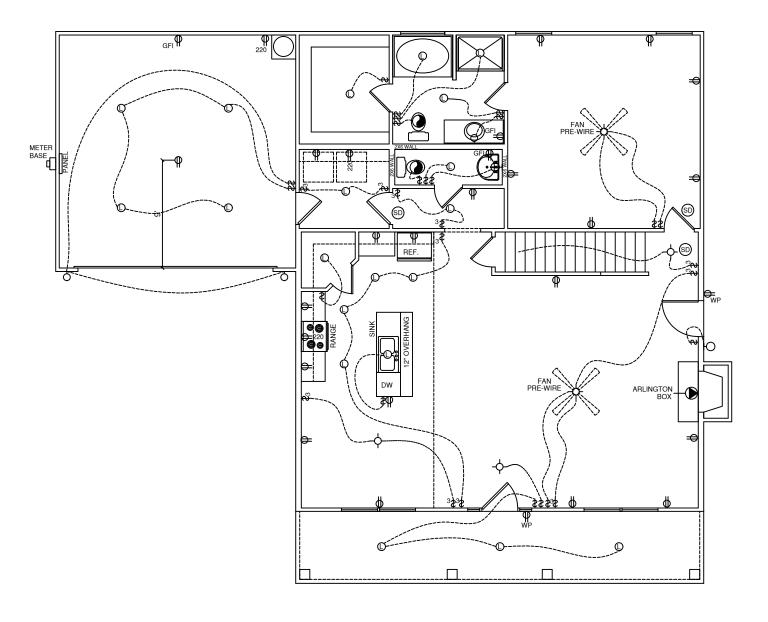
PRELIMINARY: PERM: 09/28/2022 PJM FINAL: 12.15.22 GC

Roof Plan

ELECTRICAL LEGEND			
Ф	DUPLEX OUTLET		
dGFI	GROUND FAULT INTERRUPTER OUTLET		
фwР	WATER PROOF OUTLET		
\$220	220 VOLT OUTLET		
\$	SINGLE POLE SWITCH		
\$ ₃	THREE-WAY SWITCH		
\$ ₄	FOUR-WAY SWITCH		
	LIGHT, SURFACE MOUNTED		
©	LIGHT, L.E.D. RECESSED MOUNTED		
®	LIGHT, PENDANT		
오	LIGHT, COACH / VANITY		
¤	LIGHT, UNDER WALL CABINET		
$\Diamond \Diamond$	LIGHT, OUTDOOR FLOOD		
•	EXHAUST FAN		
(SD)	SMOKE DETECTOR		
T-STAT	THERMOSTAT		
$\perp X$	CEILING FAN WITH LIGHT		
X	CEILING FAN PRE-WIRE AT LIGHT		
◀	RECEPTACLE, PHONE		
CAT	RECEPTACLE, CAT CABLE		
(A)	RECEPTACLE, T.V. CABLE		
	ELECTRICAL PANEL		
	METER BASE		
<u></u>	CHIME BELL, DOOR		
¤	EAVE LIGHT		
ELECTRICAL NOTES			
ALL ELECTRICAL TO MEET N.E.C. PROVIDE 200 AMP SINGLE PHASE SERVICE PROVIDE ALL COPPER WIRING CONTRACTOR TO CONNECT ALL FIXTURES AND APPLIANCES CONTRACTOR TO HAVE VALID LICENSE TO DO ELECTRICAL WORK PROVIDE #5 REBAR ELECTRICAL GROUND TO FOUNDATION STEEL			

- FOUNDATION STEEL
 PROVIDE AND INSTALL LOCALLY CERTIFIED
 SMOKE DETECTORS AS REQUIRED BY
 NATIONAL FIRE PROTECTION ASSOCIATION
 (NFPA) AND MEETING THE REQUIREMENTS OF
- (NFPA) AND MEETING THE REQUIREMENTS OF ALL GOVERNING CODES PROVIDE AND INSTALL GROUND FAULT CIRCUIT: INTERRUPTERS (GFI) AS REQUIRED BY NATIONAL ELECTRICAL CODE (NEC) AND MEETING THE REQUIREMENTS OF ALL
- MEETING THE REQUIREMENTS OF ALL
 GOVERNING CODES
 UNLESS OTHERWISE INDICATED, INSTALL
 SWITCHES & RECEPTACLES AT THE
 FOLLOWING HEIGHTS ABOVE THE FINISHED

SWITCHES 42" OUTLETS 14" TELEPHONE 14" TELEVISION 14" - GARAGE DOOR OPENER W/ 2 REMOTES



FIRST FLOOR ELECTRICAL PLAN

BUYER	DATE
BUYER	DATE

FINAL 106-22-144 ARAGON

GENERAL NOTES

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TOWN/CITY: XXXXXXXXX

COUNTY:

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AUTHORED DATE:

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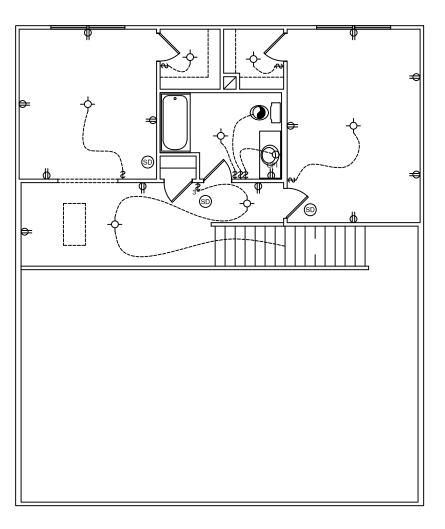
First Floor Electrical

ELECTRICAL LEGEND			
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₫ ^{WP}	WATER PROOF OUTLET		
₽220	220 VOLT OUTLET		
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\$ ₃	THREE-WAY SWITCH		
\$ ₄	FOUR-WAY SWITCH		
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0	LIGHT, L.E.D. RECESSED MOUNTED		
®	LIGHT, PENDANT		
오	LIGHT, COACH / VANITY		
¤	LIGHT, UNDER WALL CABINET		
\Diamond	LIGHT, OUTDOOR FLOOD		
	EXHAUST FAN		
(SD)	SMOKE DETECTOR		
T-STAT	THERMOSTAT		
X	CEILING FAN WITH LIGHT		
×	CEILING FAN PRE-WIRE AT LIGHT		
\blacksquare	RECEPTACLE, PHONE		
CAT	RECEPTACLE, CAT CABLE		
	RECEPTACLE, T.V. CABLE		
	ELECTRICAL PANEL		
D	METER BASE		
ŀ	CHIME BELL, DOOR		
¤	EAVE LIGHT		
ELECTRICAL NOTES			
ALL ELECTRICAL TO MEET N.E.C. PROVIDE 200 AMP SINGLE PHASE SERVICE PROVIDE ALL COPPER WIRING CONTRACTOR TO CONNECT ALL FIXTURES AND APPLIANCES CONTRACTOR TO HAVE VALID LICENSE TO DO ELECTRICAL WORK PROVIDE #5 REBAR ELECTRICAL GROUND TO FOUNDATION STEEL PROVIDE AND INSTALL LOCALLY CERTIFIED SMOKE DETECTORS AS REQUIRED BY			

- SMOKE DETECTORS AS REQUIRED BY NATIONAL FIRE PROTECTION ASSOCIATION (NFPA) AND MEETING THE REQUIREMENTS OF
- (NFPA) AND MEETING THE REQUIREMENTS OF ALL GOVERNING CODES PROVIDE AND INSTALL GROUND FAULT CIRCUIT- INTERRUPTERS (GFI) AS REQUIRED BY NATIONAL ELECTRICAL CODE (NEC) AND MEETING THE REQUIREMENTS OF ALL COVERNING CODES
- MEETING THE REQUIREMENTS OF ALL
 GOVERNING CODES
 UNLESS OTHERWISE INDICATED, INSTALL
 SWITCHES & RECEPTACLES AT THE
 FOLLOWING HEIGHTS ABOVE THE FINISHED

SWITCHES 42"

OUTLETS 14" TELEPHONE 14" TELEVISION 14"



SECOND FLOOR ELECTRICAL PLAN

BUYER DATE **BUYER** DATE

FINAL 106-22-144 ARAGON

GENERAL NOTES

1.) MAIN FLOOR PLATE HEIGHT TO BE 8'-0" UNLESS NOTED OTHERWISE. 2.) OPTIONAL BONUS PLATE HEIGHT TO BE 8'-0" UNLESS NOTED OTHERWISE. 3.) INTERIOR & EXTERIOR WALLS TO BE DRAWN @ 3 1/2" UNLESS NOTED OTHERWISE.

4.) ALL ANGLES TO BE DRAWN AT 45° OR 90° UNLESS NOTED OTHERWISE.

OR 90° UNLESS NOTED OTHERWISE.
5.) WINDOW HEADER HEIGHT TO BE SET @
6'-11" UNLESS NOTED OTHERWISE. HEADER
SIZE AND MATERIAL TO BE DETERMINED &
VERIFIED BY FRAMER, BUILDER, TRUSS SHOP
OR BY A LICENSED ENGINEER.
6.) SIZE, LOCATION AND MATERIALS OF BEAMS
TRUSSES, GIRDERS AND HEADERS TO BE
DETERMINED & VERIFIED BY BUILDER, FRAMER
TRUSS SHOP OR LICENSED ENGINEER.
7.) FOOTER SIZE, MATERIAL & LOCATIONS TO
BE VERIFIED AND DETERMINED BY BUILDER,
FOOTER CONTRACTOR OR LICENSED
ENGINEER.
8.) ROOF VENTILATION TO BE DETERMINED

8.) ROOF VENTILATION TO BE DETERMINED & VERIFIED BUILDER, ROOFING COTRACTOR OR LICENSED ENGINEER.

OR LICENSED ENGINEER.

9.) ALL MECHANICAL SYSTEMS DESIGNS, LOCATIONS AND SIZING TO BE DETERMINED & VERIFIED BY BUILDER, APPROPRIATE TRADE CONTRACTOR AND OR LICENSED ENGINEER.

10.) BUILDER RESPONSIBLE FOR VERIFYING AND COMPLYING WITH ALL LOCAL, STATE & NATIONAL CODES.

11.) LOCAL, STATE AND NATIONAL CODES TAKE PRECIDENCE OVER DRAWINGS.

12.) BUILDER TO VERIFY ALL DIMENSIONS.

12.) BUILDER TO VERIFY ALL DIMENSIONS.

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SQUARE FOOTAGE CHART

FIRST FLOOR AREA TO FRAME:	1360
SECOND FLOOR AREA TO FRAME:	628
HEATED & COOLED TO FRAME:	1988
COVERED FRONT PORCH	204
GARAGE AREA TO FRAME	400
TOTAL UNDER BEAM AREA	2592

JOB NUMBER & CLIENT NAME:

XXXXXXXXX

ELEVATION:

CABIN

TOWN/CITY: XXXXXXXXX

COUNTY:

XXXXXXXXX


AUTHORED DATE:

2022

DRAFTING UPDATES:


PRELIMINARY: PERM: 09/28/2022 PJM FINAL: 12.15.22 GC

Second Floor Electrical

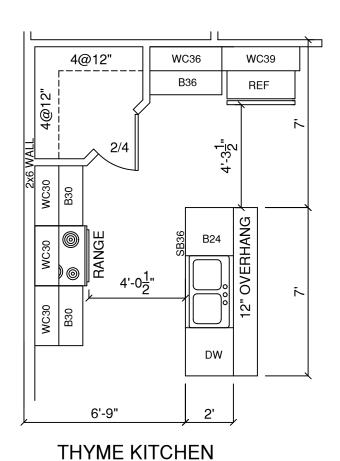

SCALE: = 1/4" = 1'-0"



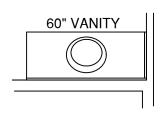



MASTER VANITY


SCALE: = 1/4" = 1'-0"

- LEV. 4 FRIGIDAIRE APPLIANCE PACKAGE S.S. W/ LEVEL 5 S.S. FRENCH DOOR REF.
- STAGGERED 30" & 36" UPPER CABINETS IN KITCHEN
- LEVEL 3 CABINETS IN KITCHEN
- LEVEL 2 CABINETS IN MASTER BATH
- LEVEL 2 CABINETS IN HALL BATH

BUYER	DATE
BUYER	DATE

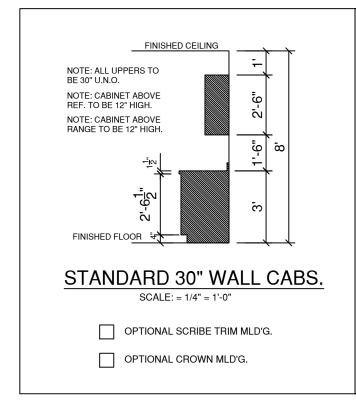

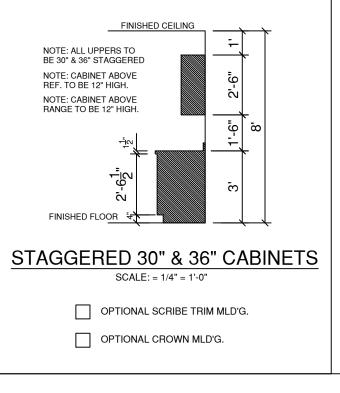

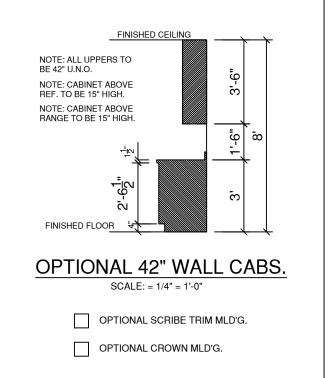

CABINET LEGEND

WC: WALL CABINET
WCC: WALL CORNER

CABINET

B: BASE CABINET SB: SINK BASE

CB: CORNER BASE

FINAL 106-22-144 ARAGON

GENERAL NOTES

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OR BY A LICENSED ENGINEER.
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7.) FOOTER SIZE, MATERIAL & LOCATIONS TO BE VERIFIED AND DETERMINED BY BUILDER, FOOTER CONTRACTOR OR LICENSED ENGINEER.

8.) ROOF VENTILATION TO BE DETERMINED & VERIFIED BUILDER, ROOFING COTRACTOR OR LICENSED ENGINEER.

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& NATIONAL CODES.

11.) LOCAL, STATE AND NATIONAL CODES

11.) LOCAL, STATE AND NATIONAL CODES TAKE PRECIDENCE OVER DRAWINGS. 12.) BUILDER TO VERIFY ALL DIMENSIONS

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SQUARE FOOTAGE CHART

oder in E 1 od 17 ide of 17	
FIRST FLOOR AREA TO FRAME:	1360
SECOND FLOOR AREA TO FRAME:	628
HEATED & COOLED TO FRAME:	1988
COVERED FRONT PORCH	204
TOTAL UNDER BEAM AREA	2192

JOB NUMBER & CLIENT NAME: XXXXXXXXXX

ELEVATION:

CABIN

TOWN/CITY:

XXXXXXXXX


COUNTY: XXXXXXXXXX

AUTHORED DATE: 2022

DRAFTING UPDATES:

PRELIMINARY: PERM: 09/28/2022 PJM FINAL: 12.15.22 GC

Cabinet Layout

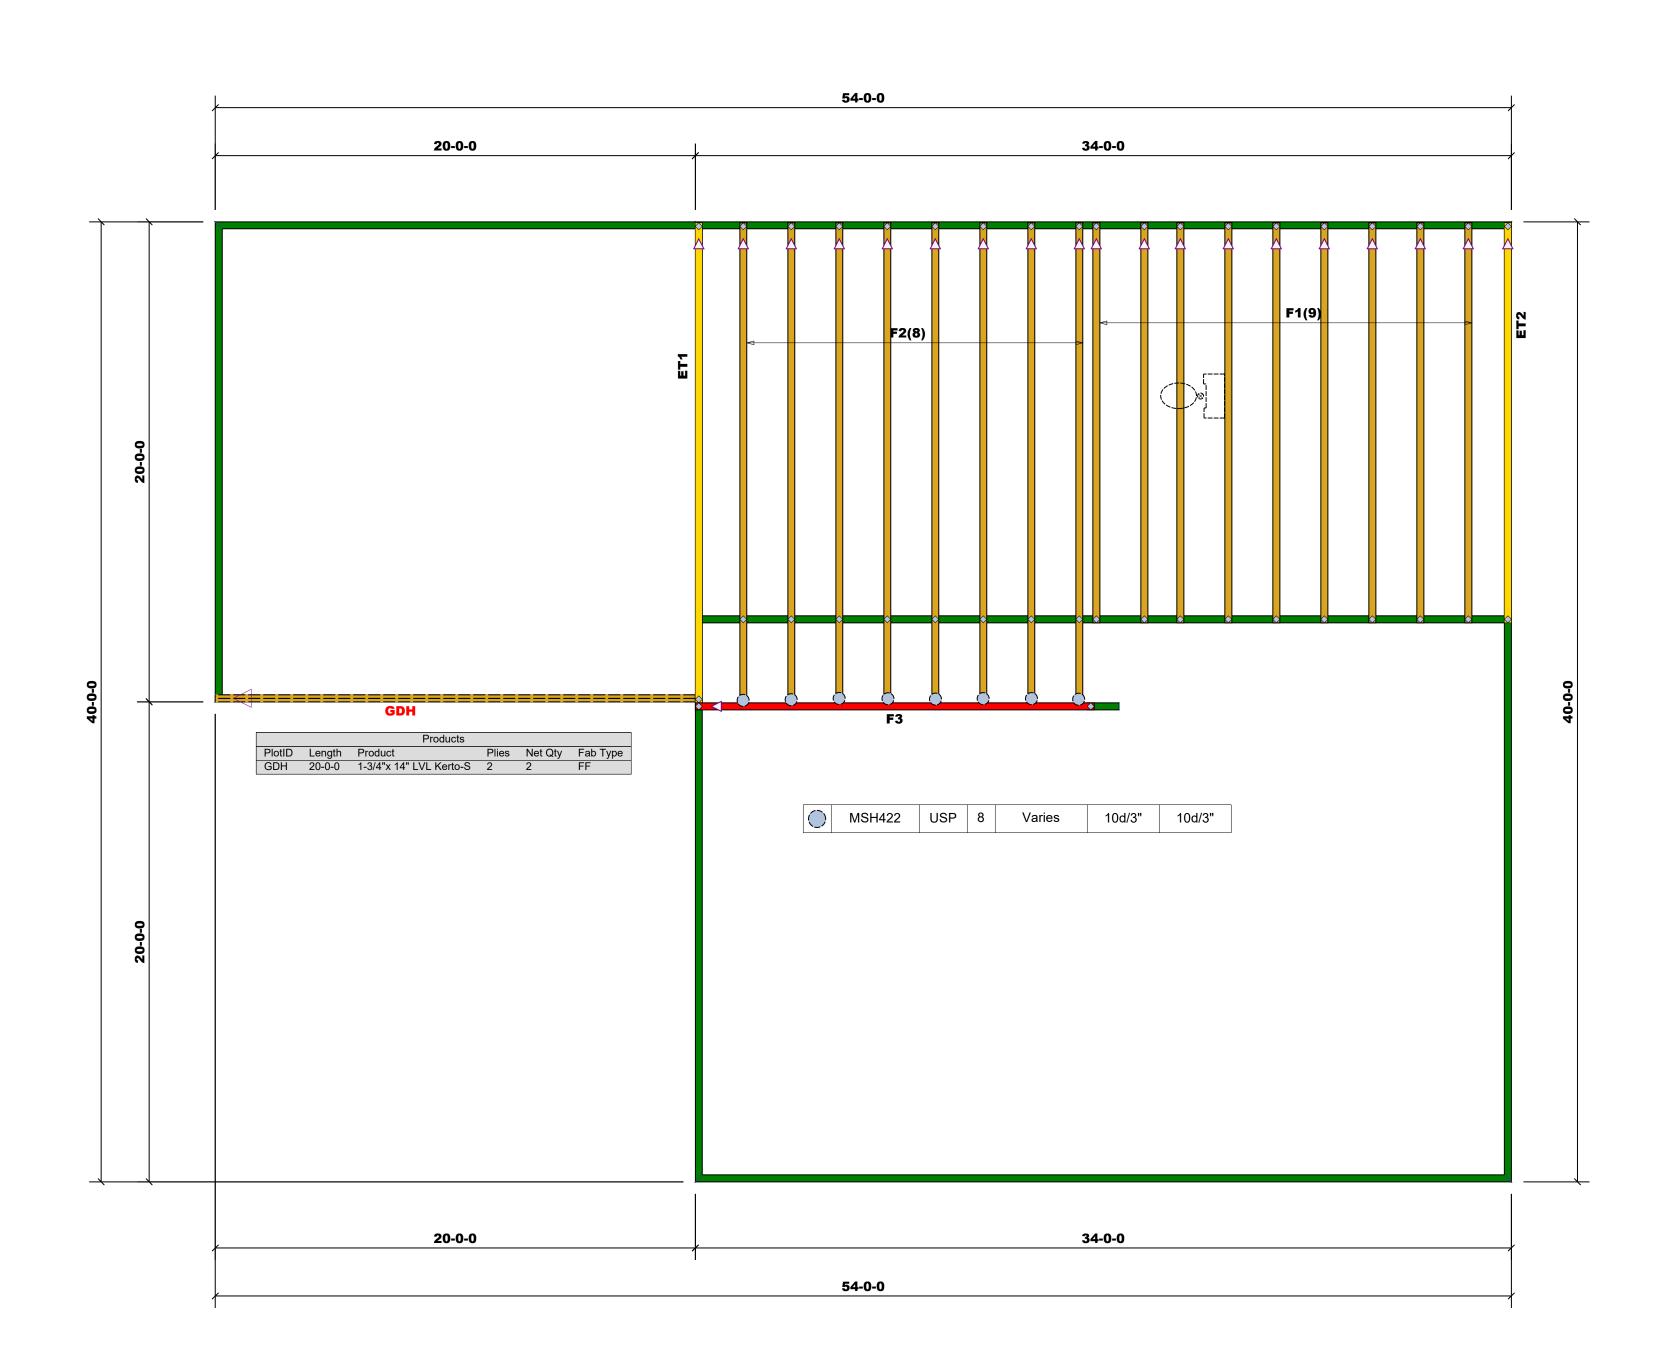



Reilly Road Industrial Park Fayetteville, N.C. 28309 Phone: (910) 864-8787 Fax: (910) 864-4444

Bearing reactions less than or equal to 3000# are deemed to comply with the prescriptive Code requirements. The contractor shall refer to the attached Tables (derived from the prescriptive Code requirements) to determine the minimum foundation size and number of wood studs required to support reactions greater than 3000# but not greater than 15000#. A registered design professional shall be retained to design the support system for any reaction that exceeds those specified in the attached Tables. A registered design professional shall be retained to design the support system for all reactions that exceed 15000#.

gnature Marshall Naylor

Marshall Naylor

LOAD CHART FOR JACK STUDS

(BASED ON TABLES R502.5(1) & (b)) NUMBER OF JACK STUDS REQUIRED @ EA END OF

, , ,		, ,,,,	HEADER/	GIRDER	}		
END REACTION (UP TO)	REQ'D STUDS FOR (2) PLY HEADER		END REACTION (UP TO)	REQ'D STUDS FOR (3) PLY HEADER		END REACTION (UP TO)	REQ'D STUDS FOR
1700	1		2550	1		3400	1
3400	2		5100	2		6800	2
5100	3		7650	3		10200	3
6800	4		10200	4		13600	4
8500	5		12750	5		17000	5
10200	6		15300	6			
11900	7						
13600	8						
15300	9						

Red Door Homes	CITY / CO.	CITY / CO. Linden / Harnett
106-22-144 Aragon	ADDRESS	745 Creek View Lane
Beaufort	WODEL	106-22-144 Aragon Floor
N/A	DATE REV.	10/05/22
Quote #	DRAWN BY	DRAWN BY Marshall Naylor
J1022-5039	SALES REP.	SALES REP. Marshall Naylor


THIS IS A TRUSS PLACEMENT DIAGRAM ONLY.
These trusses are designed as individual building components to be incorporated into the building design at the specification of the building designer. See individual design sheets for each truss design identified on the placement drawing. The building designer is responsible for temporary and permanent bracing of the roof and floor system and for the overall structure. The design of the truss support structure including headers, beams, walls, and columns is the responsibility of the building designer. For general guidance regarding bracing, consult BCSI-B1 and BCSI-B3 provided with the truss delivery package or online @ sbcindustry.com

SEAL DATE

JOB NAME

BUILDER

QUOTE #

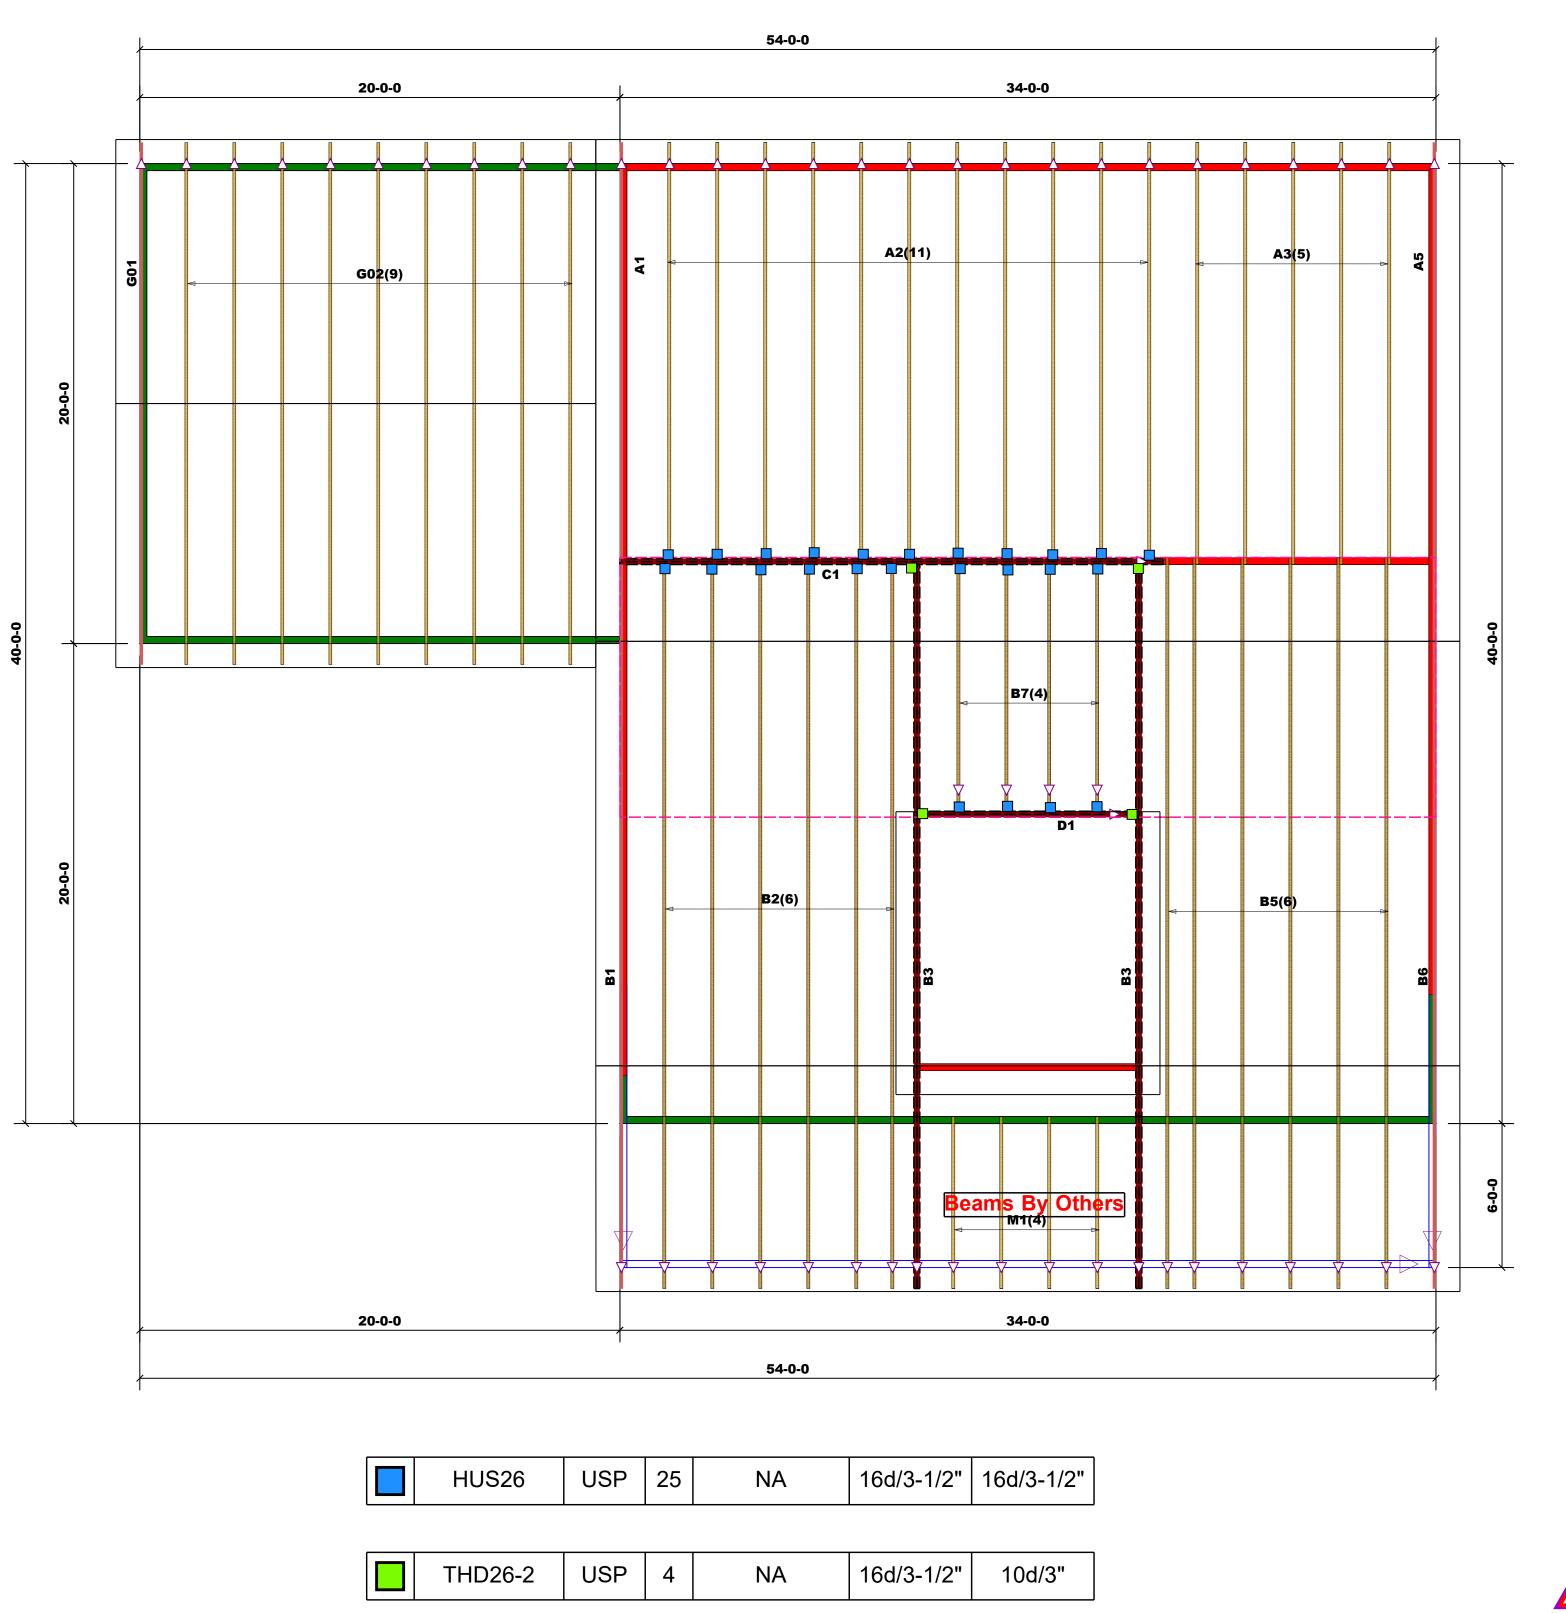

Truss Placement Plan SCALE: 1/4"=1'

COMTECH **ROOF & FLOOR TRUSSES & BEAMS**

Reilly Road Industrial Park

Fayetteville, N.C. 28309 Phone: (910) 864-8787 Fax: (910) 864-4444

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Marshall Naylor

Marshall Naylor

LOAD CHART FOR JACK STUDS

(BASED ON TABLES R502.5(1) & (b)) NUMBER OF JACK STUDS REQUIRED @ EA END OF HEADER/GIRDER

retteville	CITY / CO.	CITY / CO. Linden / Harnett
	ADDRESS	745 Creek View Lane
	MODEL	106-22-144 Aragon Roof
	DATE REV.	10/05/22
	DRAWN BY	DRAWN BY Marshall Naylor

JOB NAME SEAL DATE QUOTE# PLAN THIS IS A TRUSS PLACEMENT DIAGRAM ONLY.
These trusses are designed as individual building components to be incorporated into the building design at the specification of the building designer. See individual design sheets for each truss design identified on the placement drawing. The building designer is responsible for temporary and permanent bracing of the roof and floor system and for the overall structure. The design of the truss support structure including headers, beams, walls, and columns is the responsibility of the building designer. For general guidance regarding bracing, consult BCSI-B1 and BCSI-B3 provided with the truss delivery package or online @ sbcindustry.com

N/A

Quote#

Red Door Homes of Fay

BUILDER

106-22-144 Aragon

Beaufort

= Indicates Left End of Truss (Reference Engineered Truss Drawing) Do NOT Erect Truss Backwards