CLADDING VALUES

THIS PROJECT HAS A MEAN ROOF OF LESS THAN 30 FEET. WALL CLADDING IS DESIGNED FOR A 24.1 LB. PER SQ.FT. OR GREATER POSITIVE OR NEGATIVE PRESSURE FOR HOUSES WITH A MEAN ROOF HEIGHT OF 30 FEET OR LESS. ROOF VALUES, BOTH POSITIVE AND NEGATIVE, SHALL BE DESIGNED AS FOLLOWS:

45.4 LBS. PER SQ. FT. FOR ROOF PITCHES OF 0/12 TO < 2.25/1234.8 LBS. PER SQ. FT. FOR ROOF PITCHES OF 2.25/12 TO < 7/12 21 LBS. PER SQ. FT. FOR ROOF PITCHES OF 7/12 TO 12/12


VALUES STATED ARE FOR ROOFS WITH A MEAN HEIGHT OF 30 FEET OR LESS. ROOFS WITH MEAN ROOF HEIGHTS GREATER THAN 30 FEET MUST SHOW SPECIFIC INFORMATION FOR CLADDING.

THIS PLAN HAS BEEN DRAWN TO CONFORM TO THE NORTH CAROLINA RESIDENTIAL CODE (2012 INTERNATIONAL RESIDENTIAL CODE FOR ONE AND TWO FAMILY DWELLINGS), CURRENT EDITION WITH AMENDMENTS UNLESS OTHERWISE NOTED.

CONTRACTOR SHALL VERIFY ALL DIMENSIONS AND CONDITIONS PRIOR TO BEGGINING WORK. CONTRACTOR IS RESPONSIBLE FOR COMPLIANCE WITH ALL STATE AND LOCAL BUILDING CODES AND ORDINANCES. KADS CUSTOM HOME DESIGNS, LLC ASSUMES NO LIABILITY FOR SITE CONDITIONS, CONSTRUCTION METHODS OR ANY DEVIATION OF THESE PLANS.


NOTE:
ALL WINDOWS TO BE INSTALLED MUST MEET A MINIMUM OF .35 U VALUE OR BETTER, UNLESS ENERGY CALCULATIONS ARE SUBMITTED WITH PLANS PROVIDED BY BUILDER AT TIME OF PLAN REVIEW.



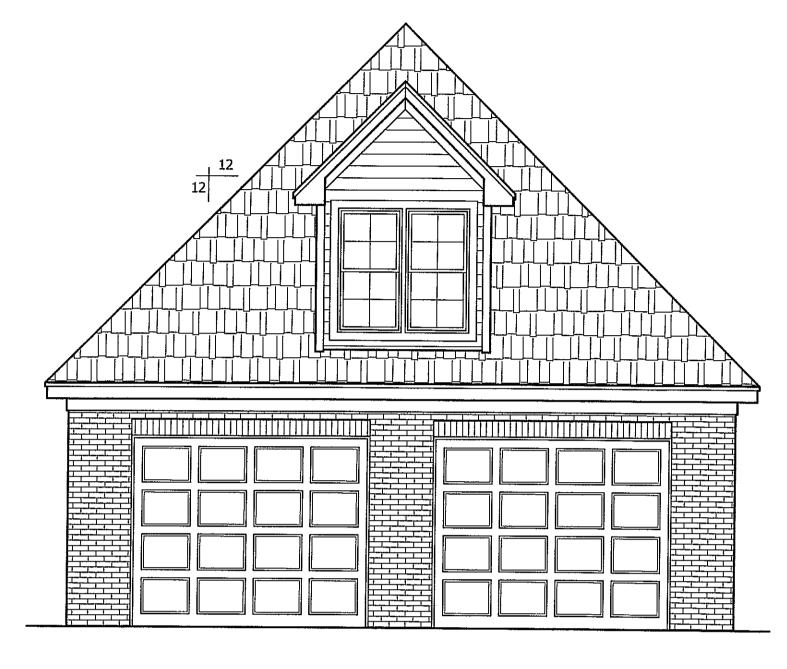


FRONT ELEVATION

SCALE: 1/4"=1'-0"

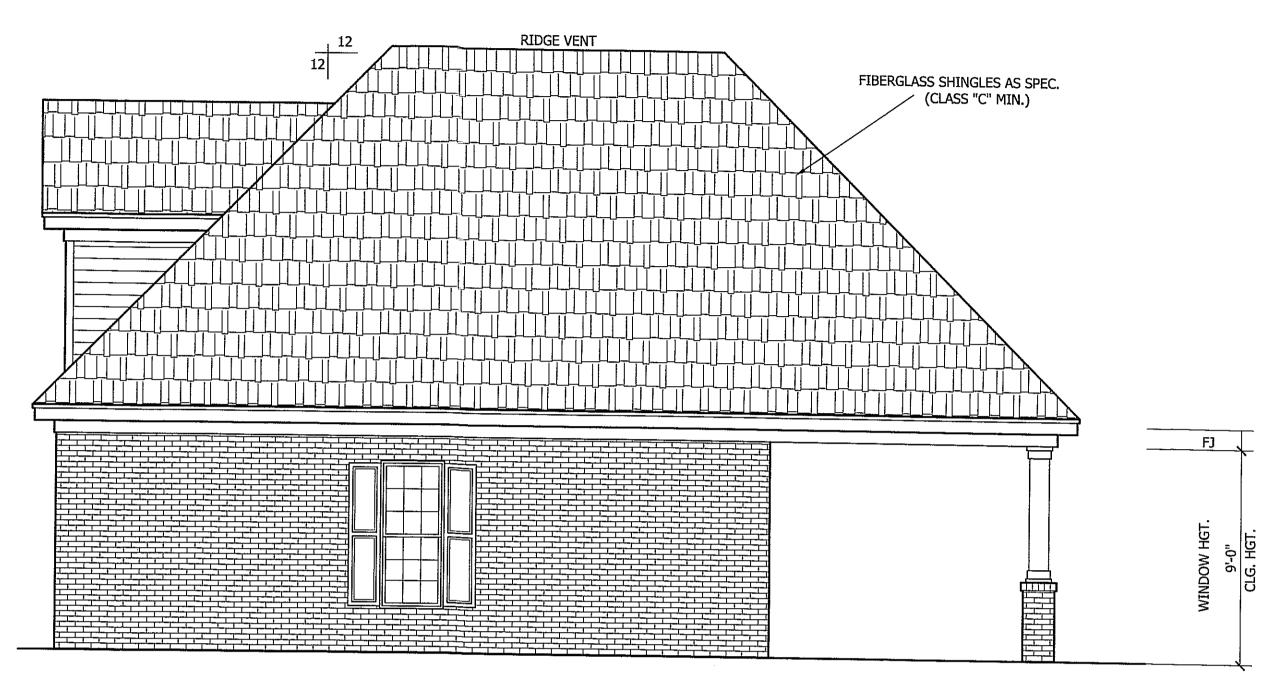

RIGHT ELEVATION SCALE: 1/4"=1'-0"

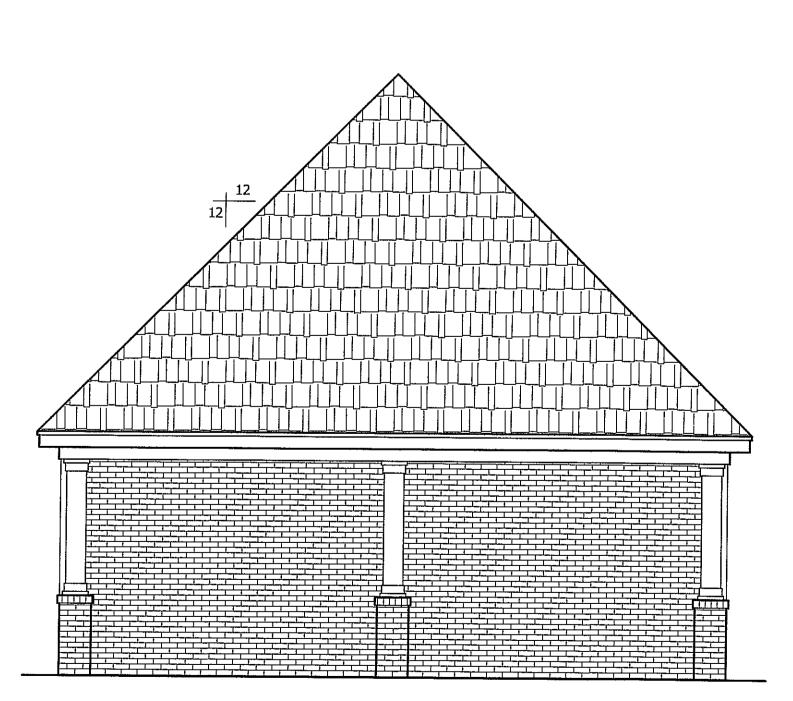


REAR ELEVATION

SCALE: 1/4"=1'-0"

FIBERGLASS SHINGLES AS SPEC. (CLASS "C" MIN.) RIDGE VENT

LEFT ELEVATION SCALE: 1/4"=1'-0"

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ANGIER, NC 919-369-7181

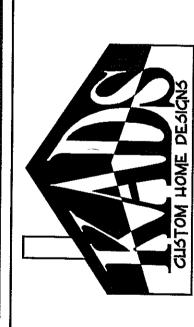DRAWN BY: **D.W.O.**

DATE: 9/29/17

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DRAWN BY: D.W.O.

DATE: <u>9/29/17</u>

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2

of 2

PLAN NO. 28X42


ROOF VENTILATING REQUIREMENTS

1176
150 = 7.84 SQ. FT. REQ'D


ROOF VENTILATING REQUIREMENTS
(POWER ROOF VENTILATOR REQUIRED)


= <u>3.92</u> SQ. FT. REQ'D

BUILDER TO PROVIDE APPROPRIATE VENTILATING AS REQUIRED.

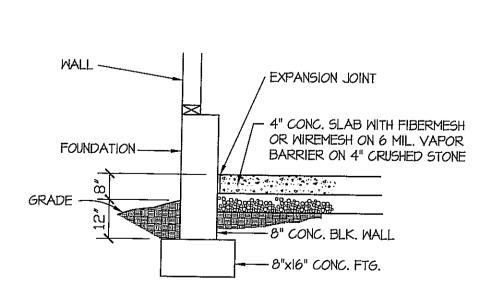

GARAGE SLAB SCALE: NTS

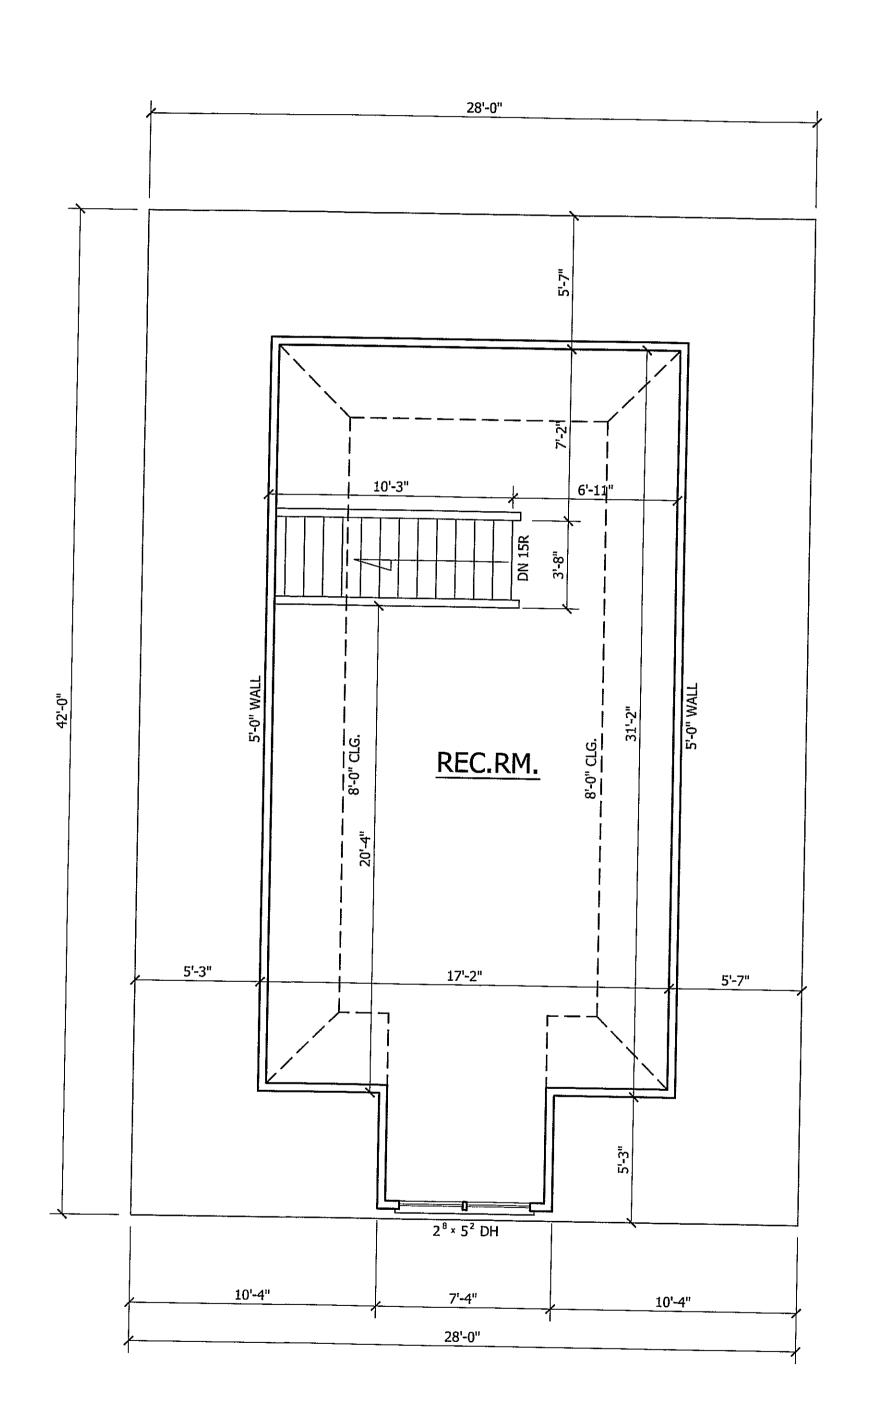

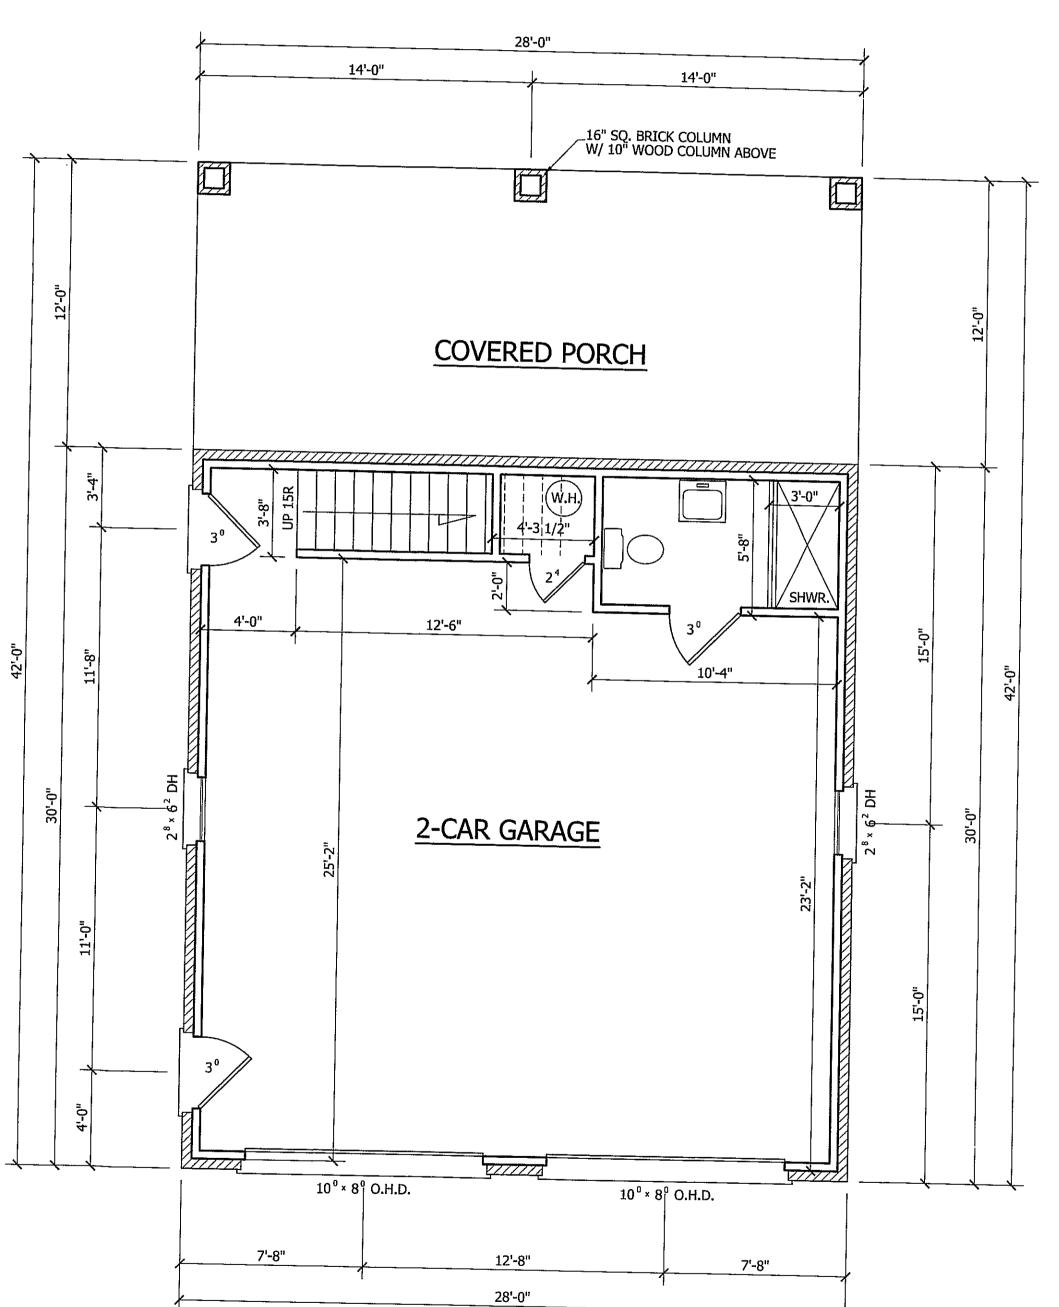

SECOND FLOOR PLAN

SCALE: 1/4"=1'-0" 8'-0" CLG. HGT. SET WINDOWS AT 6'-8" A.F.F. GARAGE SQ. FT. = 840 PORCH SQ. FT. = 336 REC. ROOM SQ. FT. = 587 FIRST FLOOR PLAN

SCALE: 1/4"=1'-0" 9'-0" CLG. HGT. SET WINDOWS AT 7'-10" A.F.F.

ANGIER, NC 919-369-7181 DRAWN BY:

<u>D.W.O.</u> DATE:

9/29/17

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OF

PLAN NO.

FIRST FLOOR PLAN SCALE: 1/4"=1'-0"

30"x30"x10" FTG.

2'-6"

4" CONC. SLAB OVER COMPACTED FILL or FIRM RESIDUAL


4" CONC. SLAB W/ 6x6 WI.4xWI.4 WWF or FIBER REINFORCEMENT OVER 6 MIL VAPOR BARRIER OVER COMPACTED FILL or FIRM RESIDUAL

30"x30"x10" FTG.

8" MAS.)4" VENEER WALL ON 20"x8" CONT. CONC. FTG.

10'-4"

12:12 PITCH 12:12 PITCH 12:12 PITCH 2x8 @ 16" O.C. 2x8 @ 16" O.C. 12:12 PITCH

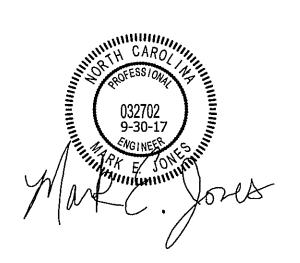





*Engineers seal applies only to structural components on this document. Seal does not include construction means, methods, techniques, sequences, procures or safety precautions. *Any deviations or discrepancies on plans are to be brought to the immediate attention of Mark E. Jones, PE. Failure to do so will void Mark E. Jones, PE liability.


Structural analysis based on NCResidential Building Code 2012.

ROOF PLAN
SCALE: 1/4"=1'-0"

Project No. 17-212

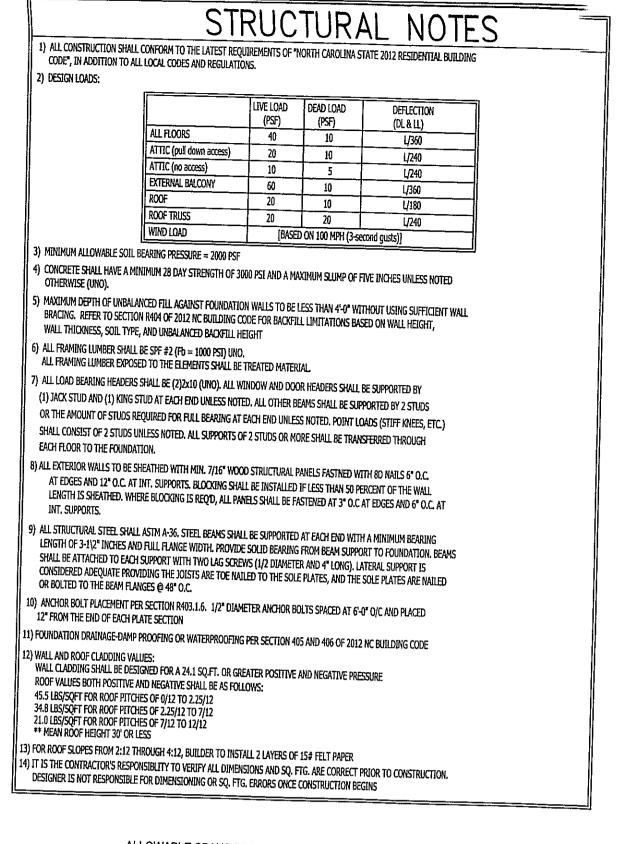

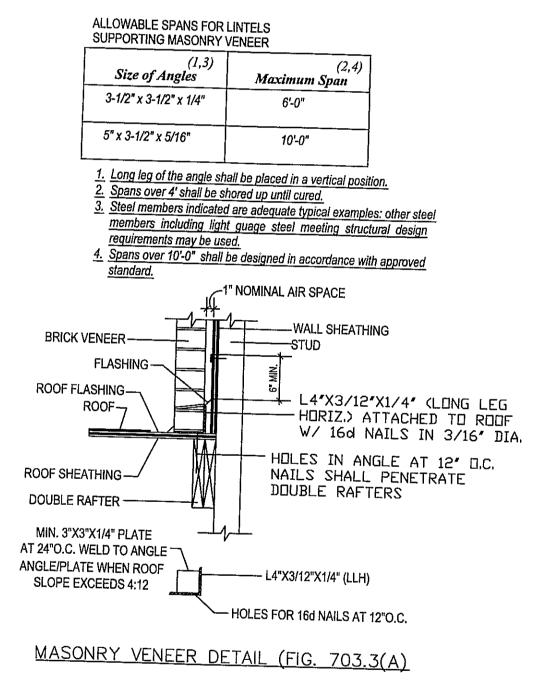

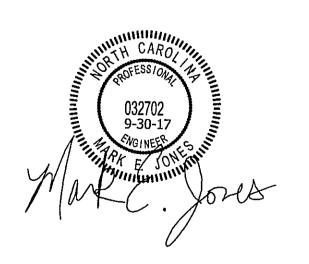


Structural Engineering by:

Mark E. Jones, PE
6425 Glen Dean Court
Raleigh, NC 27603
Phone: (919) 395-5618

*Engineers seal applies only to structural components on this document. Seal does not include construction means, methods, techniques, sequences, procures or safety precautions.
*Any deviations or discrepancies on plans are to be brought to the immediate attention of Mark E. Jones, PE. Fallure to do so will vold Mark E. Jones, PE liability.
Structural analysis based on NCResidential Building Code 2012.

Project No. 17-212

FIRST FLOOR PLAN
SCALE: 1/4"=1'-0"

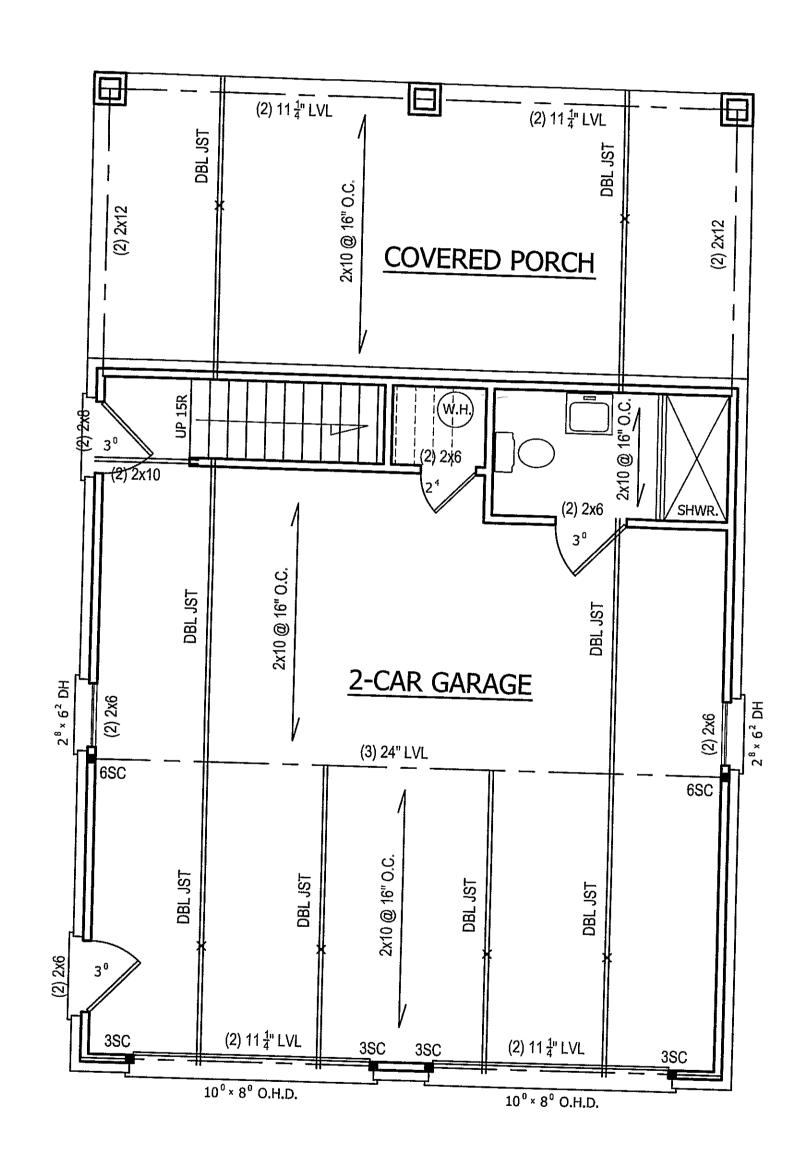

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ANGIER, NC

<u>D.W.O.</u>

DATE:

9/29/17

PAGE NO

PLAN NO.

919-369-7181

DRAWN BY:

SECOND FLOOR PLAN

REC.RM.

2x6 @ 16" O.C.

2x6 @ 16" O.C.

(2) 2x6 HDR

28 × 52 DH

SCALE: 1/4"=1'-0"


ANGIER, NO 919-369-7181


DRAWN BY: <u>D.W.O.</u>

DATE: 9/29/17

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PLAN NO. 28X42



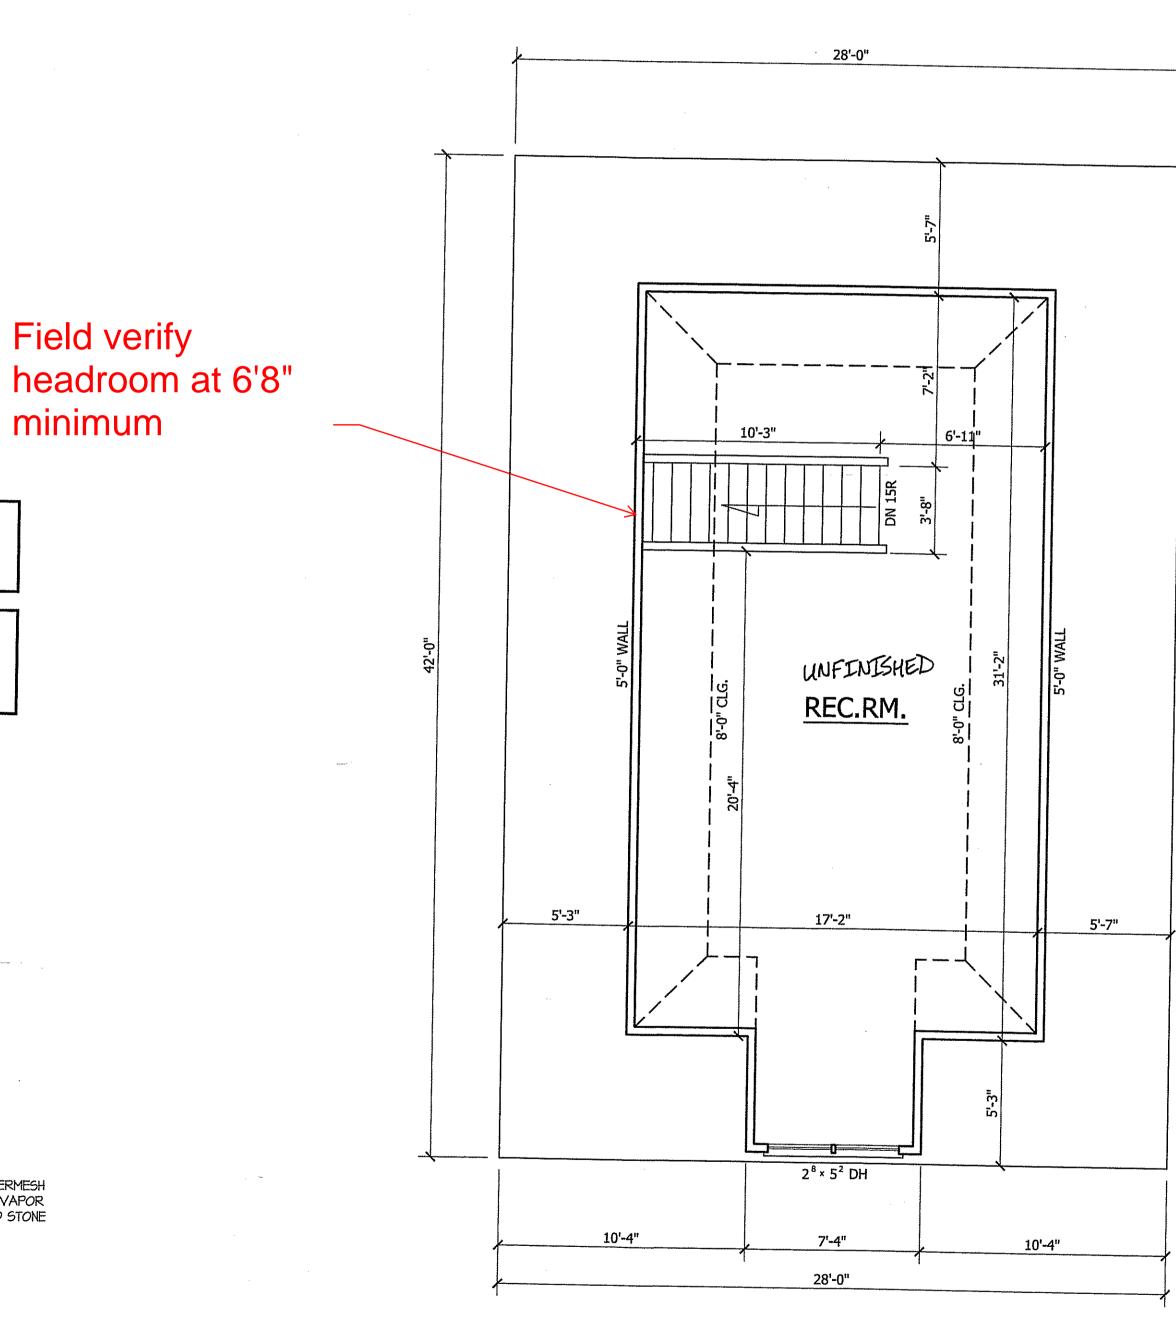

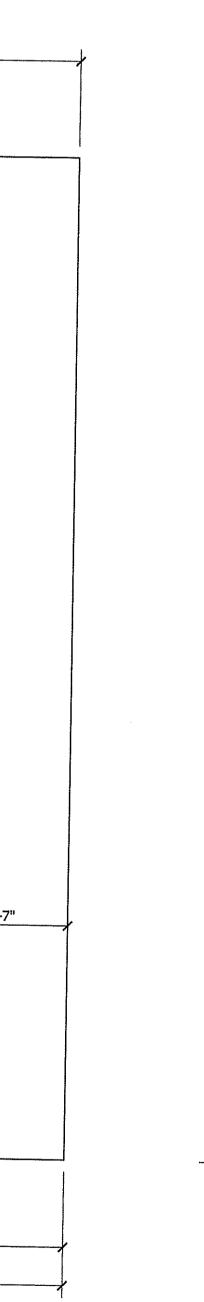/ EXPANSION JOINT 4" CONC, SLAB WITH FIBERMESH OR WIREMESH ON 6 MIL. VAPOR BARRIER ON 4" CRUSHED STONE FOUNDATION -GRADE -8" CONC. BLK. WALL — 8"x16" CONC. FTG.

ROOF VENTILATING REQUIREMENTS

ROOF VENTILATING REQUIREMENTS
(POWER ROOF VENTILATOR REQUIRED)

BUILDER TO PROVIDE APPROPRIATE VENTILATING AS REQUIRED.

= <u>3.92</u> SQ. FT. REQ'D


Field verify

minimum

GARAGE SLAB SCALE: NTS

SECOND FLOOR PLAN

SCALE: 1/4"=1'-0" 8'-0" CLG. HGT. SET WINDOWS AT 6'-8" A.F.F.

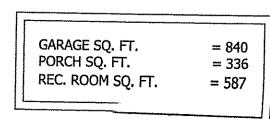

FIRST FLOOR PLAN

12'-8"

28'-0"

10° × 8° O.H.D.

7'-8"

SCALE: 1/4"=1'-0" 9'-0" CLG. HGT. SET WINDOWS AT 7'-10" A.F.F.

14'-0"

4'-0"

14'-0"

__16" SQ. BRICK COLUMN W/ 10" WOOD COLUMN ABOVE

COVERED PORCH

12'-6"

10° × 8° O.H.D.

7'-8"

2-CAR GARAGE