


NOTICE TO CONTRACTOR  
 All construction must comply with current NC Building Codes and be subject to field inspection and verification.  
 APPROVED  
 Limited building only review  
 Review holder responsible for  
 full compliance with the code  
 09/10/2021




**STRUCTURAL DESIGN NOTES:**

1. STRUCTURE IS DESIGNED FOR A MAXIMUM DESIGN OF:  
 a) FLOOR LOAD = 50 (PSF) LIVE LOAD & 10 (PSF) DEAD LOAD  
 b) ROOF LOAD = 20 (PSF) LIVE LOAD & 10 (PSF) DEAD LOAD
2. THIS STRUCTURAL DESIGN MEETS INTERNATIONAL CODE COUNCIL REQUIREMENTS FOR 115 MPH WIND SPEED (MAX.) AND SEISMIC ZONE D.

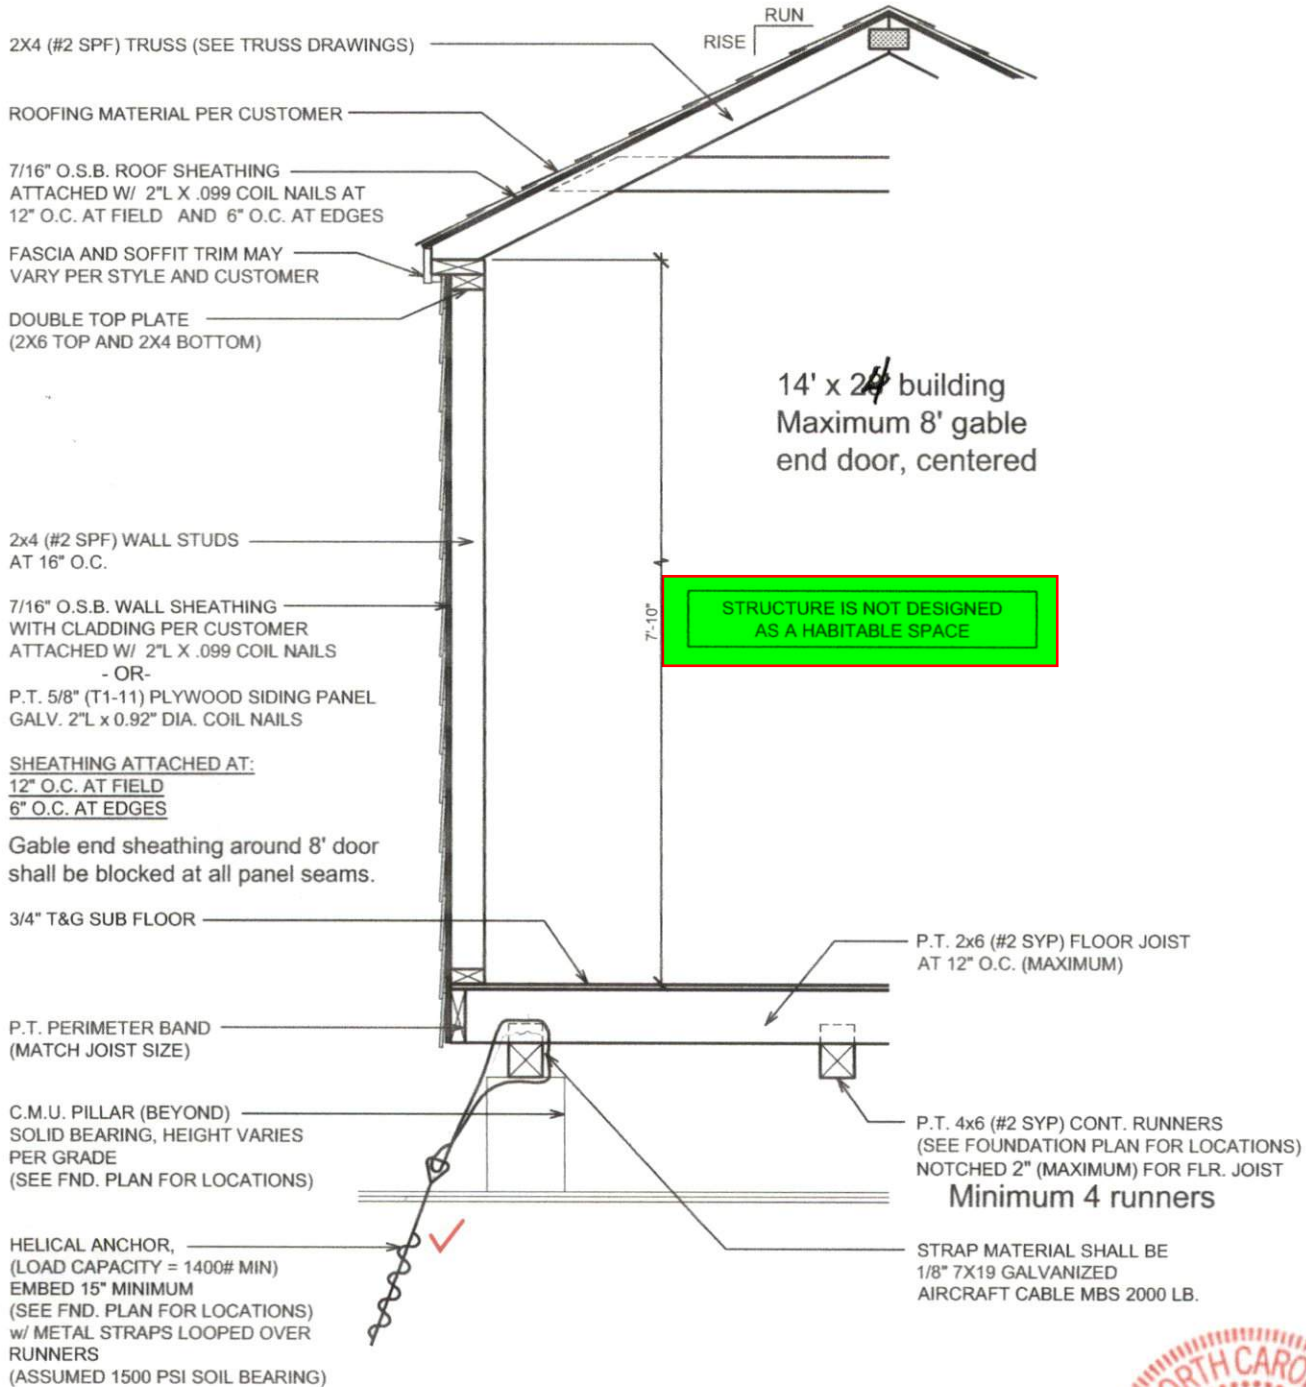


SHED STYLE: PREMIER - 12" o.c.		STRUCTURAL ENGINEER:  P.E. ROBBINS, P.E. 1777 STATE ROUTE 167 VICTORIA, IL 61485
SHED SIZE: SEE PLAN	SCALE: 5/8" = 1'-0"	
DATE: 03.15.21	DRAWN BY: DOUG GAITHER	
SHEET NAME: TYPICAL WALL SECTION		

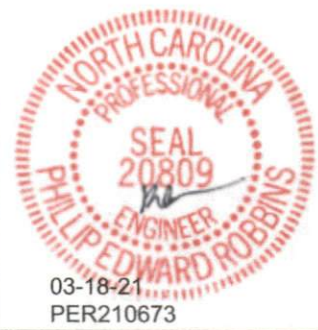



PLAN VIEW

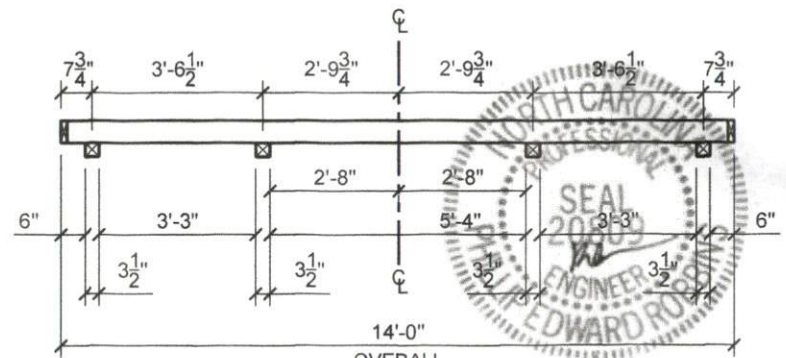


SECTION VIEW

NOTES:

THIS DESIGN MEETS INTERNATIONAL CODE COUNCIL REQUIREMENTS FOR 115 MPH WIND SPEED (MAXIMUM) AND SEISMIC ZONE D.



SHED STYLE: SEE TYPICAL WALL SECTION		STRUCTURAL ENGINEER:  P.E. ROBBINS, P.E. 1777 STATE ROUTE 167 VICTORIA, IL 61485 PHONE: (309) 879-3258
SHED SIZE: 14x24	SCALE: 1/4" = 1'-0"	
DATE: 07.08.19	DRAWN BY: DOUG GAITHER	
SHEET NAME: FOUNDATION AND ANCHORING LAYOUT		

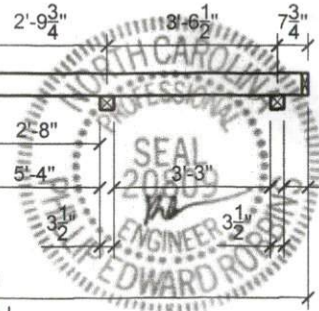

08/13/2019  
PER191842