

IT IS THE SOLE RESPONSIBILITY OF THE CONTRACTOR AND/OR BUILDER TO CONFORM TO ALL STANDARDS, PROVISIONS, REQUIREMENTS, METHODS OF CONSTRUCTION AND USES OF MATERIALS, IN BUILDING CODES AND IN ACCORDANCE WITH GOOD ENGINEERING AND CONSTRUCTION PRACTICES.

I CERTIFY THAT THE CONSTRUCTION EXHIBITS FOR (IDENTIFICATION OF THE PROPERTY BY HOUSE TYPE, LOT, BLOCK, SUBDIVISION NAME, AND SO ON) MEET ALL LOCAL CODE REQUIREMENTS AND ARE IN SUBSTANTIAL CONFORMITY WITH BOTH SAH AND VA MINIMUM PROPERTY REQUIREMENTS. ALL BUILDING STANDARDS AS SET FORTH BY THE INTERNATIONAL CODE COUNCIL (ICC) AND FEDERAL SAFE DRINKING WATER PLUMBING STANDARD.

DESIGNED BY:
TIMOTHY PEPPERS JR.
RESIDENTIAL DESIGN
CONSULTANT
**CAMERON
NORTH CAROLINA
(910) 644-4587**

Square Footage	
Heated	
Existing Residence	1800 Sq Ft
Second Floor	1200 Sq Ft
Total	3000 Sq Ft
Unheated	
Garage	1220 Sq Ft
Total	1220 Sq Ft



1 3D View - Front

General Notes:

- Design Loads: Local
- Materials
 - Brick Face Brick Standard: ASTM C216-84, Grade SW. Brick type and color to be chosen by owner.
 - Mortar ASTM C270, Type S. Mortar style and color consult owner. Do not use calcium chloride in mortar.
 - Brick Ties ASTM A82 steel wire, hot dip galvanized after fabrication to ASTM A 153/A 153M, Class B
 - Insulation ASTM C665; pre-formed glass fiber batt (R-19)
 - Wood Framing No. 2 Southern Pine
 - Waterproofing #15 asphalt felt
 - Roof Shingles Match existing
- Masonry
 - Install mortar in accordance with premix mortar instructions or in accordance with ASTM C780.
 - Clean mortar off exposed finished surfaces immediately following placement.
 - Conform to the applicable code requirements for masonry construction and guidelines outlined by the Brick Institute of America.
 - Provide brick ties.
 - Cut masonry units with motor-driven saws to provide clean, sharp, unchipped edges.
 - Prepare masonry surfaces so they are smooth and free from projections that could puncture flashing. Place through-wall flashing on sloping bed of mortar and cover with mortar. Seal penetrations in flashing with adhesive/sealant/tape as recommended by flashing manufacturer before covering with mortar.
 - Install weep holes in the head joints in exterior wythes of the first course of masonry immediately above embedded flashings as follows:
 - Keep head joints free and clear of mortar.
 - Space weep holes 24 inches o/c.
 - Weep Holes:
 - After wall construction is complete, clean brick with a non-acidic solution recommended by masonry unit manufacturer.
- Insulation
 - Verify that adjacent materials and insulation materials are dry.
 - Install insulation per manufacturer's instructions.
 - Tape seal tears or cuts in vapor retarder.

- Wood Framing
 - All field nailing will comply with the North Carolina State Building Code Fastening Schedule Table 2304.9.1 unless noted otherwise. All nails are to be common nails.
 - Miscellaneous framing not shown on the structural drawings may be required in some areas. Contractor will provide all framing required to complete the project.
 - Exterior Wall Sheathing:
 - Sheathing will be 1/2" plywood APA rated sheathing with an exterior exposure 1 durability rating.
 - Place long dimension of sheathing perpendicular to studs in a staggered arrangement. Fasten to studs with 10d common nails 6" o/c at all panel edges and 12" o/c at intermediate supports. Block all unsupported edges.
 - Leave 1/4" space at all panel edge joints and 1/8" space at all panel end joints unless otherwise recommended by manufacturer.
 - Plywood Roof Sheathing
 - Roof sheathing is to be APA rated with an exterior exposure 1 rating and a panel span rating of 32/16. Thickness of sheathing is to match existing roof sheathing thickness.
 - Place long dimension of sheathing perpendicular to outriggers. Remove sections of existing sheathing and stagger every other new plywood sheet back to the 2nd interior roof truss. Fasten to trusses and outriggers with 10d common nails, 6" o/c at all panel edges and 12" o/c at intermediate supports. Block all unsupported edges.
 - Leave 1/4" space at all panel edge joints and 1/8" space at all panel end joints unless otherwise recommended by the manufacturer.
- Miscellaneous
 - The contractor will be responsible for properly guying and bracing the structure to resist live, dead, wind and construction loads during construction.
 - Verify all existing building dimensions, elevations and details with the field conditions.

Climate Zone	Zone 3	Zone 4	Zone 5
Fenstration U-Factor	0.35	0.35	0.35
Skylight U-Factor	0.65	0.60	0.60
Glazed Fenstration SHGC	0.30	0.30	0.30
Ceiling R-Value	30	38	38
Wall R-Value	15	15	19
Floor R-Value	19	19	30
*Basement Wall R-Value	10/13	10/13	10/13
**Slab R-Value	0	10	10
**Crawl Space Wall R-Value	5/13	10/13	10/13

*10/13 means R-10 sheathing insulation or R-13 cavity insulation
** Insulation depth with monolithic slab 18" or from inspection gap to bottom of footing; Insulation depth with stem wall slab 24" or to bottom of foundation wall.

Design Pressure for Doors and Window Positive and Negative in PSF			
Velocity (MPH)	Mean Roof Height (FT)		
		15	25
90	15	17	19
100	20	23	25
110	25	29	32
Assumed Mean Roof Height 25'-9"			

Designed for windspeed of 110 MPH,
3 Second Gust (95 Fastest Mile) Exposure "B"

Symbols Legend:	
	STONE CLADDING
	CONCRETE BLOCK
	CONCRETE
	ARCHITECTURAL PRECAST CONCRETE
	POROUS FILL
	EARTH
	METAL
	GYPSUM WALLBOARD
	GWB SOFFIT OR CEILING
	WOOD
	PLYWOOD
	WOOD ROUGH FRAMING
	SHM
	BATT INSULATION
	RIGID INSULATION
	FIRE SAFFING
	IMPREGNATED FOAM SEALANT
	SEALANT AND BACKER ROD

Air Leakage Section N1102.4
N1102.4.1 Building Thermal Envelop. The building thermal envelope shall be durably sealed with an air barrier system to limit infiltration. The sealing methods between dissimilar materials shall allow for differential expansion and contraction. For all homes, where present, the following shall be caulked, gsketed, weaher stripped or otherwise sealed with an air barrier material or solid material consistent with Appendix E-2.4 of this code:
1. Blocking and sealing floor/ceiling systems and under knee walls open to unconditioned or exterior space.
2. Capping and sealing shafts or chases, including flue shafts.
3. Capping and sealing soffit or dropped ceiling areas.

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Prepared For Jesse Martin
144 Carolina Way
Sanford NC
Cover Sheet

SCALE:

DATE: 2/26/2021

Project number 022620210001

Drawn by TP
Checked by TP

C

Dwelling/Garage Separation

REFER TO SECTIONS R302.5, R302.6, AND R302.7

Walls. A minimum 1/2" gypsum board must be installed on all walls supporting floor/ceiling assemblies used for separation required by this section.

Stairs. A minimum of 1/2" gypsum must be installed on the underside and exposed sides of all stairways.

Ceilings. A minimum of 1/2" gypsum must be installed on the garage ceiling if there is no habitable room above. If a habitable room is above, a minimum of 5/8" Type X gypsum board must be installed on the garage ceiling.

Opening Penetrations. Openings between the garage and the residence shall be equipped with solid wood doors not less than 1 3/8 inches in thickness, solid or honeycomb core steel doors not less than 1 3/8 inches thick, or 20-minute fire-rated doors.

Duct Penetrations. Ducts in the garage and ducts penetrating the walls or ceilings separation the dwelling from the garage shall be constructed of a minimum No. 26 gage sheet steel or other approved material and shall have no openings into the garage.

Other Penetrations. Penetrations through the separation required in Section R302.6 shall be protected as required by Section R302.11, Item 4.

General Notes:

1. All dimensions are given from the exterior face of the stud to the centerline of interior studs unless otherwise noted.
2. All work shall be performed in conformance with the 2018 NC Building Code for One and Two Family Dwellings and all referenced standards.
3. All finishes, appliances, equipment and fixtures shall be coordinated by Owner and G.C.
4. G.C. to field verify all existing dimensions and conditions prior to commencing work.
5. Drawings are an instrument to communicate intent of construction. Do not scale drawings.
6. All doors and windows to be selected by Owner and provided and installed by G.C.
7. All casework to be selected by Owner and provided and installed by G.C.

Door Schedule				
Mark	Count	Door Size	Description	Comments
1	5	36" x 80"	Entry Door	
2	2	36" x 80"	Interior Door	
4	2	32" x 80"	Room Door	
5	3	30" x 80"	Room Door	
6	1	30" x 80"	Bi-fold Door	
7	1	Garage	2-Car Garage Door	
8	1	Exist. 36" x 80"	Entry Door	Existing Door
9	1	72" x 80"	French Door	Existing Door
Grand total: 16				

Window Schedule				
Mark	Count	Rough Opening		Comments
		Width	Height	
	3			Existing Window
A	7	6' - 0"	5' - 0"	

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Prepared For Jesse Martin
144 Carolina Way
Sanford NC
First Floor Plan


SCALE:
1/4" = 1'-0"

DATE:
2/26/2021

Project number
022620210001

Drawn by TP
Checked by TP

1

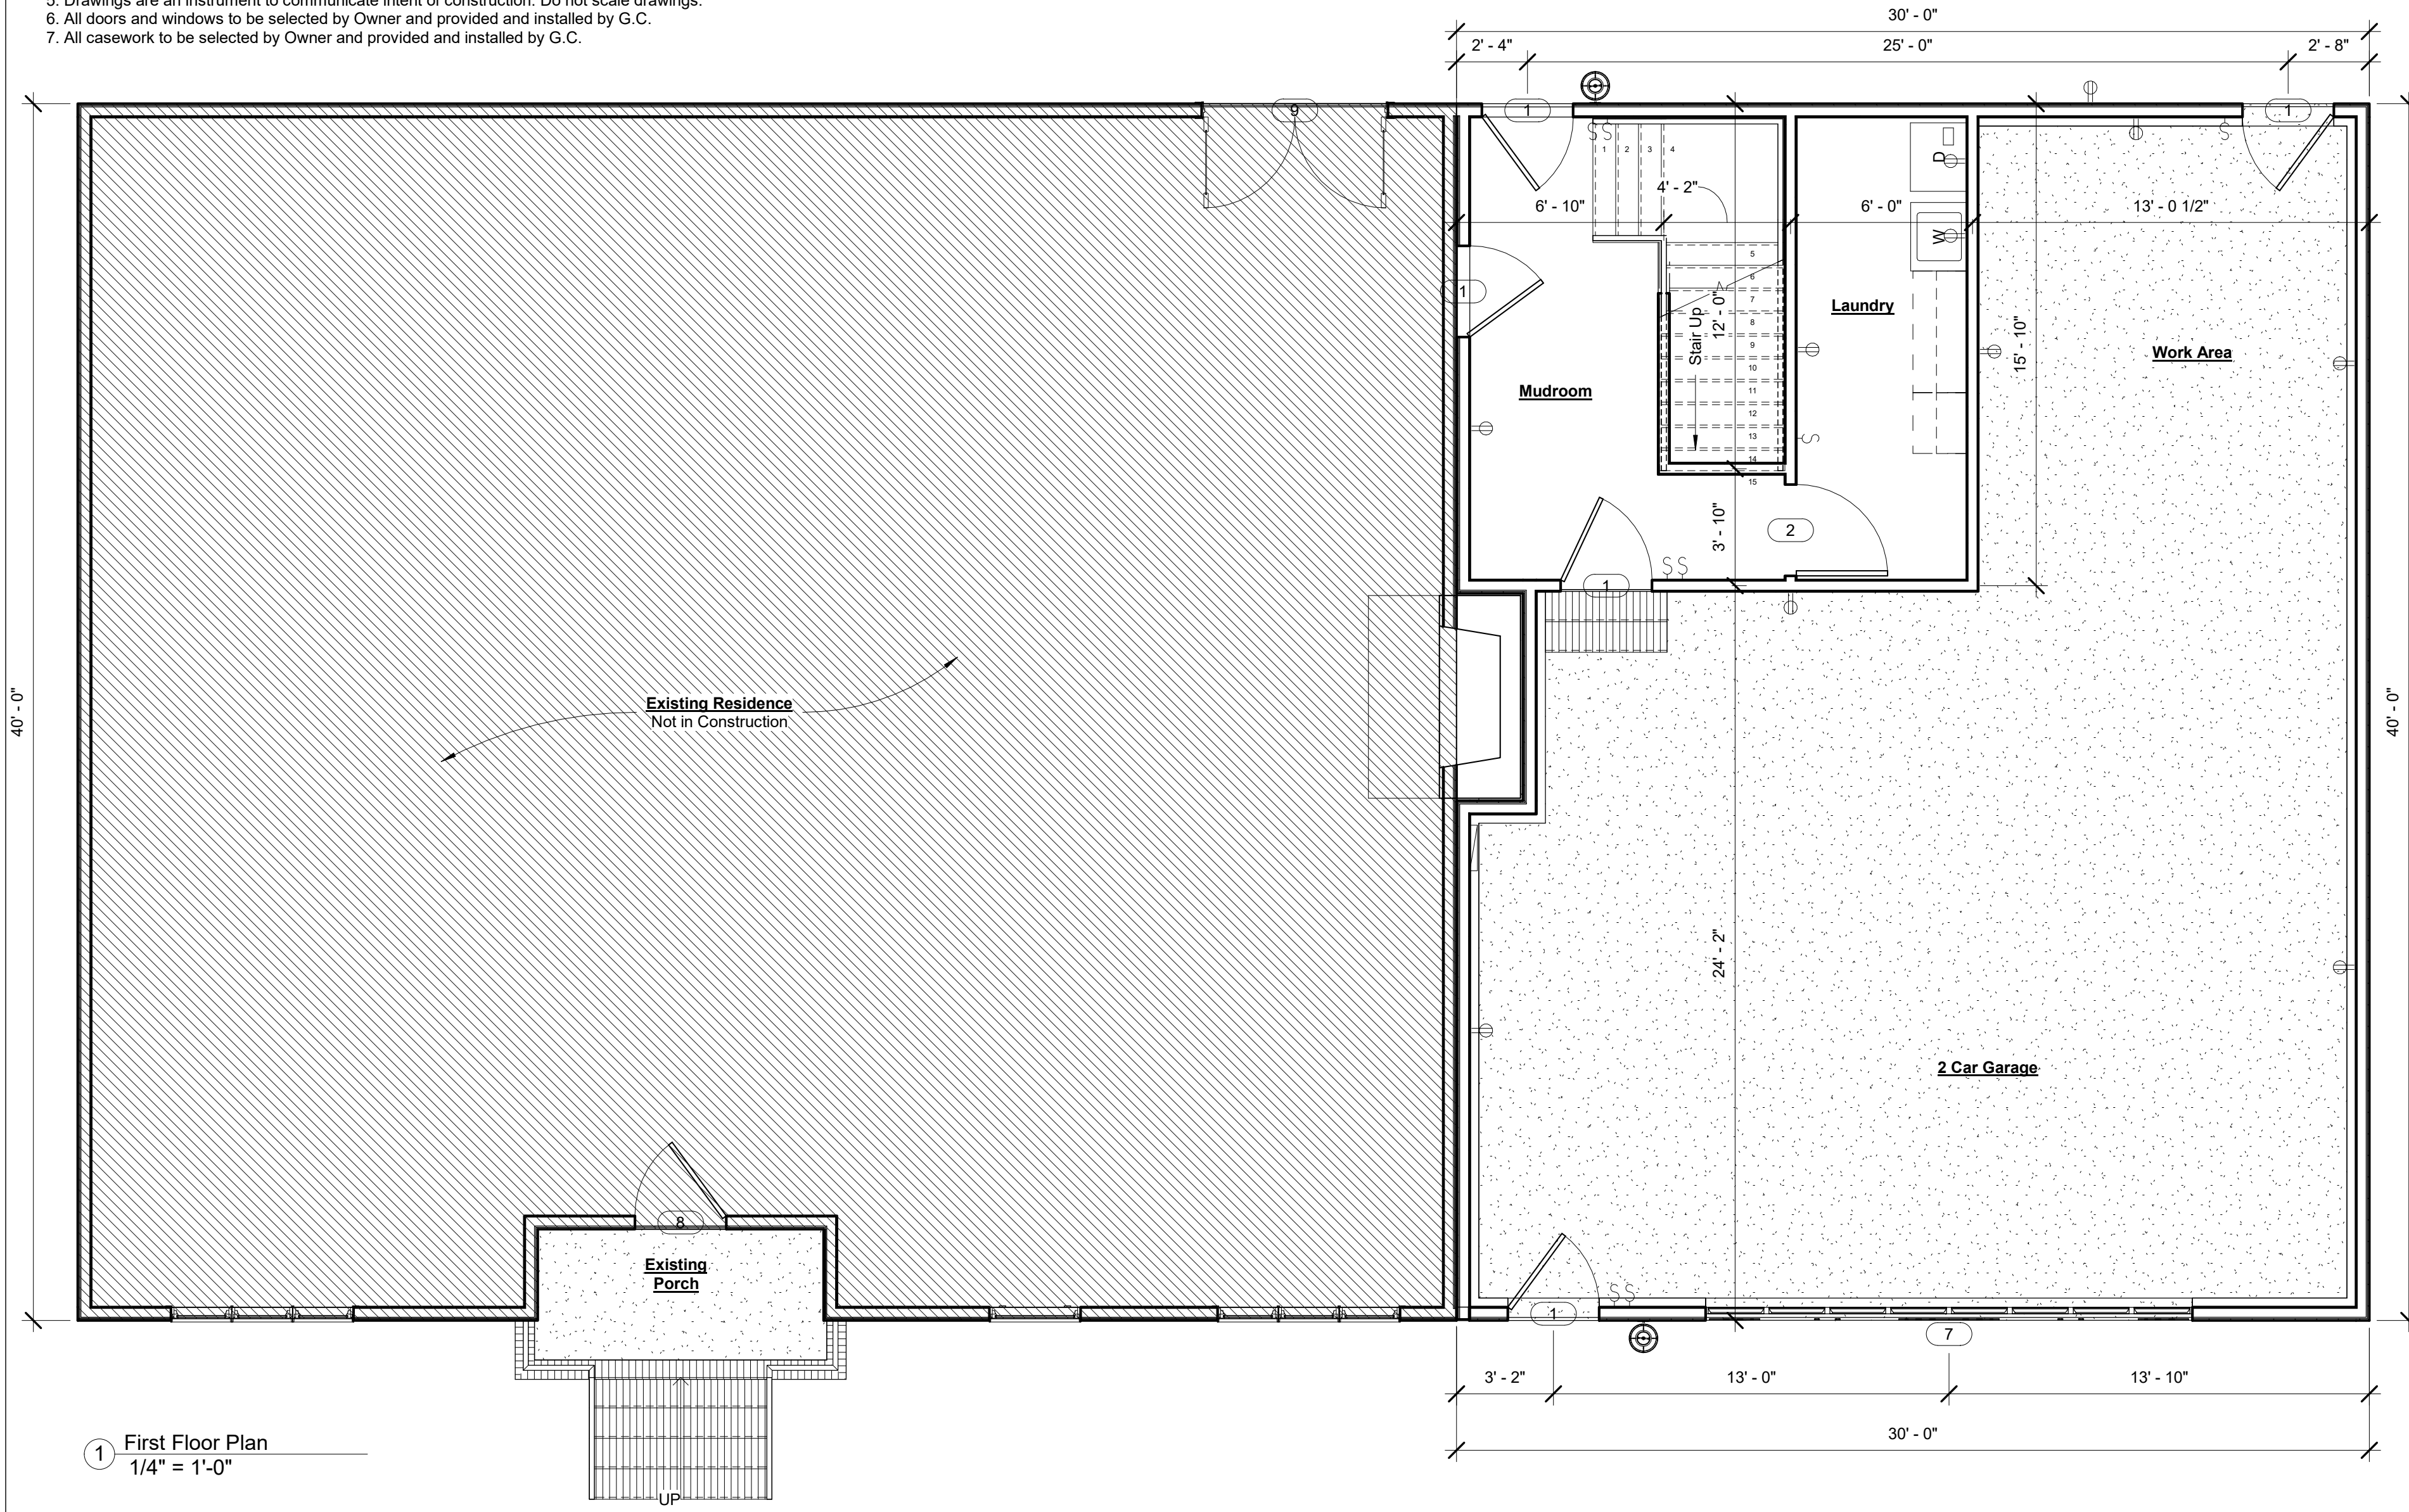

1 First Floor Plan
1/4" = 1'-0"

Floor Plan Notes:

1. All structural information shown is for reference purposes only. Contractor shall have licensed structural engineer review and design all structural elements such as all framing walls, beams, connections, headers, joists and rafters.
2. All dimensions are from center line of stud to face of exterior stud unless noted otherwise.
3. Window sizes indicated on plans are noted by approximate rough opening size. Refer to plans and exterior elevations for window types.
4. Coordinate location of utility meters with site plan and locate away from public view visual impact shall be minimized, i.e. mount as low as possible.
5. Prefabricated fireplace construction shall meet or exceed all applicable codes regarding use of fire separations, clearances, etc. It is all items and contractor's responsibility to ensure that all items and construction meet or exceed the applicable code. Overall flue height shall be coordinated to match height shown on plans and shall not exceed the top of chimney chase as constructed.
6. Contractor shall coordinate all closet shelving requirements.
7. Do not scale drawings. Follow dimensions only.
8. Contractor shall field verify all cabinet dimensions before fabrication.
9. Bedroom windows shall have a minimum net clear opening of 5.7 sq. ft. A minimum net clear openable width of 20". A minimum net clear openable height of 24" and have a maximum finish sill height of 43" from finish floor.
10. All glass located within 18" of floor, 12" of a door of located within 60" of floor at bathtubs, whirlpools, showers, saunas, steam rooms or hot tubs shall be tempered.
11. All exposed insulation shall have a flame spread rating of less than 25 and a smoke density rating of less than 450.
12. Provide combustion air vents, with screen and back damper, for fireplaces, wood stoves and any appliance with an open flame.
13. Bathrooms and utility rooms shall be vented to the outside with a minimum of a 90 cfm fan. Range hoods shall also be vented to outside.
14. Attic HVAC units shall be located within 20'-0" of its service opening. Return air grilles shall not be located within 10'-0" of a gas fired appliance.
15. All walls and ceilings in garage and garage storage areas to have 5/8" Type-X gyp. brd. with 1-Hour fire rating. All exterior doors in garage to be metal or solid core doors including doors entering heat/cooled portion of residence.
16. All fireplace chase walls shall be insulated inside and outside. Provide horizontal "Draft Stops" at each floor level by packing 6" (R-19) insulation between 2X4 joists.
17. All interior walls shall be covered with 1/2" gyp. brd., with metal corner reinforcing, tape float and sand. (3 coats) use 5/8" gyp. brd. on ceilings when supporting members are 24" O.C. or greater. Use 1/2" gyp. brd. on ceiling members less than 24" O.C.
18. All bath and toilet area walls and ceiling shall have water resistant gyp. brd.

Smoke Alarms

Section R314

R314.1 Smoke Detection and Notification. All smoke alarms shall be listed in accordance with UL 217 and installed in accordance with provisions of this code and the household fire warning equipment provisions of NFPA 72.

R314.2 Smoke Detection Systems. Household fire alarm systems installed in accordance with NFPA 72 that include smoke alarms, or a combination of smoke detector and audible notification device installed as required by this section for smoke alarms, shall be permitted. The household fire alarm system shall provide the same level of smoke detection and alarm as required by this section for smoke alarms. Where a household fire warning system is installed using a combination of smoke detector and audible notification device(s), it shall become a permanent fixture of the occupancy and owned by the homeowner. The system shall be monitored by and approved supervising station and be maintained in accordance with NFPA72.

Exception:

Where smoke alarms are provided meeting the requirements of Section R314.4.

R314.3 Location. Smoke alarms shall be installed in the following locations.

1. In each sleeping room.
2. Outside each separate sleeping area in the immediate vicinity of the bedrooms.
3. On each additional story of the dwelling, including basements and habitable attics (finished) but not including crawl spaces, uninhabitable (unfinished) attics and unianhabitable (unfinished) attic-stories. In dwellings or dwelling units with split levels and without an intervening door between the adjacent levels, a smoke alarm installed on the upper level shall suffice for the adjacent lower level provided that the lower level is less than one full story below the upper level.

When more than one smoke alarm is required to be installed within an individual dwelling unit the alarm devices shall be interconnected in such a manner that the actuation of one alarm will activate all of the alarms in the individual unit.

R314.4 Power Source. Smoke alarms shall receive their primary power from the building wiring when such wiring is served from a commercial source, and when primary power is interrupted, shall receive power from a battery. Wiring shall be permanent and without a disconnection switch other than those required for overcurrent protection. Smoke alarms shall be interconnected.

Carbon Monoxide Alarms

Section R315

R315.1 Carbon Monoxide Alarms. In new construction, dwelling units shall be provided with an approved carbon monoxide alarm installed outside of each separate sleeping area in the immediate vicinity of the bedroom(s) as directed by the alarm manufacturer.

R315.2 Where Required In Existing Dwellings. In existing dwellings, where interior alterations, repairs, fuel-fired appliance replacements, or additions requiring a permit occurs, or where one or more sleeping rooms are added or created, carbon monoxide alarms shall be provided in accordance with Section R315.1.

R315.3 Alarm Requirements. The required carbon monoxide alarms shall be audible in all bedrooms over background noise levels with all intervening doors closed. Single station carbon monoxide alarms shall be listed as complying with UL2034 and shall be installed in accordance with this code and the manufacturer's installation instructions.

Attic Access

Section R807

R807.1 Attic Access. An attic access opening shall be provided to attic areas that exceed 400 square feet and have a vertical height of 60 inches or greater. The net clear opening shall not be less than 20 inches by 30 inches and shall be located in the hallway or other unobstructed area. Headroom in the attic space shall be provided at some point above the access opening. See Section M1305.1.3 for access requirements where mechanical equipment is located above attics.

Exceptions:

1. Concealed areas not located over the main structure including porches, areas behind knee walls, dormers, bay windows, etc. are not required to have access.
2. Pull down stair treads, stringers, handrails, and hardware may protrude into the net clear area

FINISHES

- SEAL AROUND WINDOW AND DOOR OPENINGS WITH PAINT GRADE SEALANT. WHERE COUNTERTOPS AND BACK SPLASHES BUTT WALLS, PROVIDE A BEAD OF CLEAR SILICONE CAULK. AT PLUMBING FIXTURES, PROVIDE ANTI-FUNGAL CAULK.
- ALL GYPSUM BOARD TO BE 1/2" TYPE X
- CEILINGS THROUGHOUT TO BE GYPSUM BOARD. PATCH CEILING WHERE AFFECTED BY DEMOLITION AND MATCH FINISH, TEXTURE, AND PAINT OF ADJOINING CEILING.
- PRIOR TO ORDERING FINISHES, VERIFY/CONSULT WITH OWNER, CONFIRM COLOR & STYLE.
- ALL METAL TO RECEIVE BASE COAT AND 2 COATS SEMI-GLOSS LATEX PAINT. GWB TO RECEIVE ONE COAT PRIMER & TWO COATS PAINT. WOOD DOORS TO BE FACTORY STAINED.
- ALL CABINETS TO BE PLASTIC LAMINATE FACED, FLUSH OVERLAY DESIGN. ALL HARDWARE TO BE INTERMEDIATE DUT. FIELD VERIFY ROOM DIMENSIONS AND APPLIANCE SIZES PRIOR TO FABRICATION. GC TO PROVIDE BLOCKING IN WALLS.

Walls & Thicknesses

All walls are 3 1/2" thick 2x4 nominal studs SYP or SPF #2 @ 16" O.C. unless otherwise noted.

Exterior walls are drawn to actual dimensions to include both interior and exterior finishes. Measurements to exterior walls are to the exterior face of wall stud.

Garage walls are drawn to actual dimensions. Measurements to exterior walls are to the exterior face of wall stud. Measurements to walls between the residence and the garage are to the face of the stud on the garage side.

Interior walls are drawn to actual dimension. Measurements to interior walls are to the center line of the wall.

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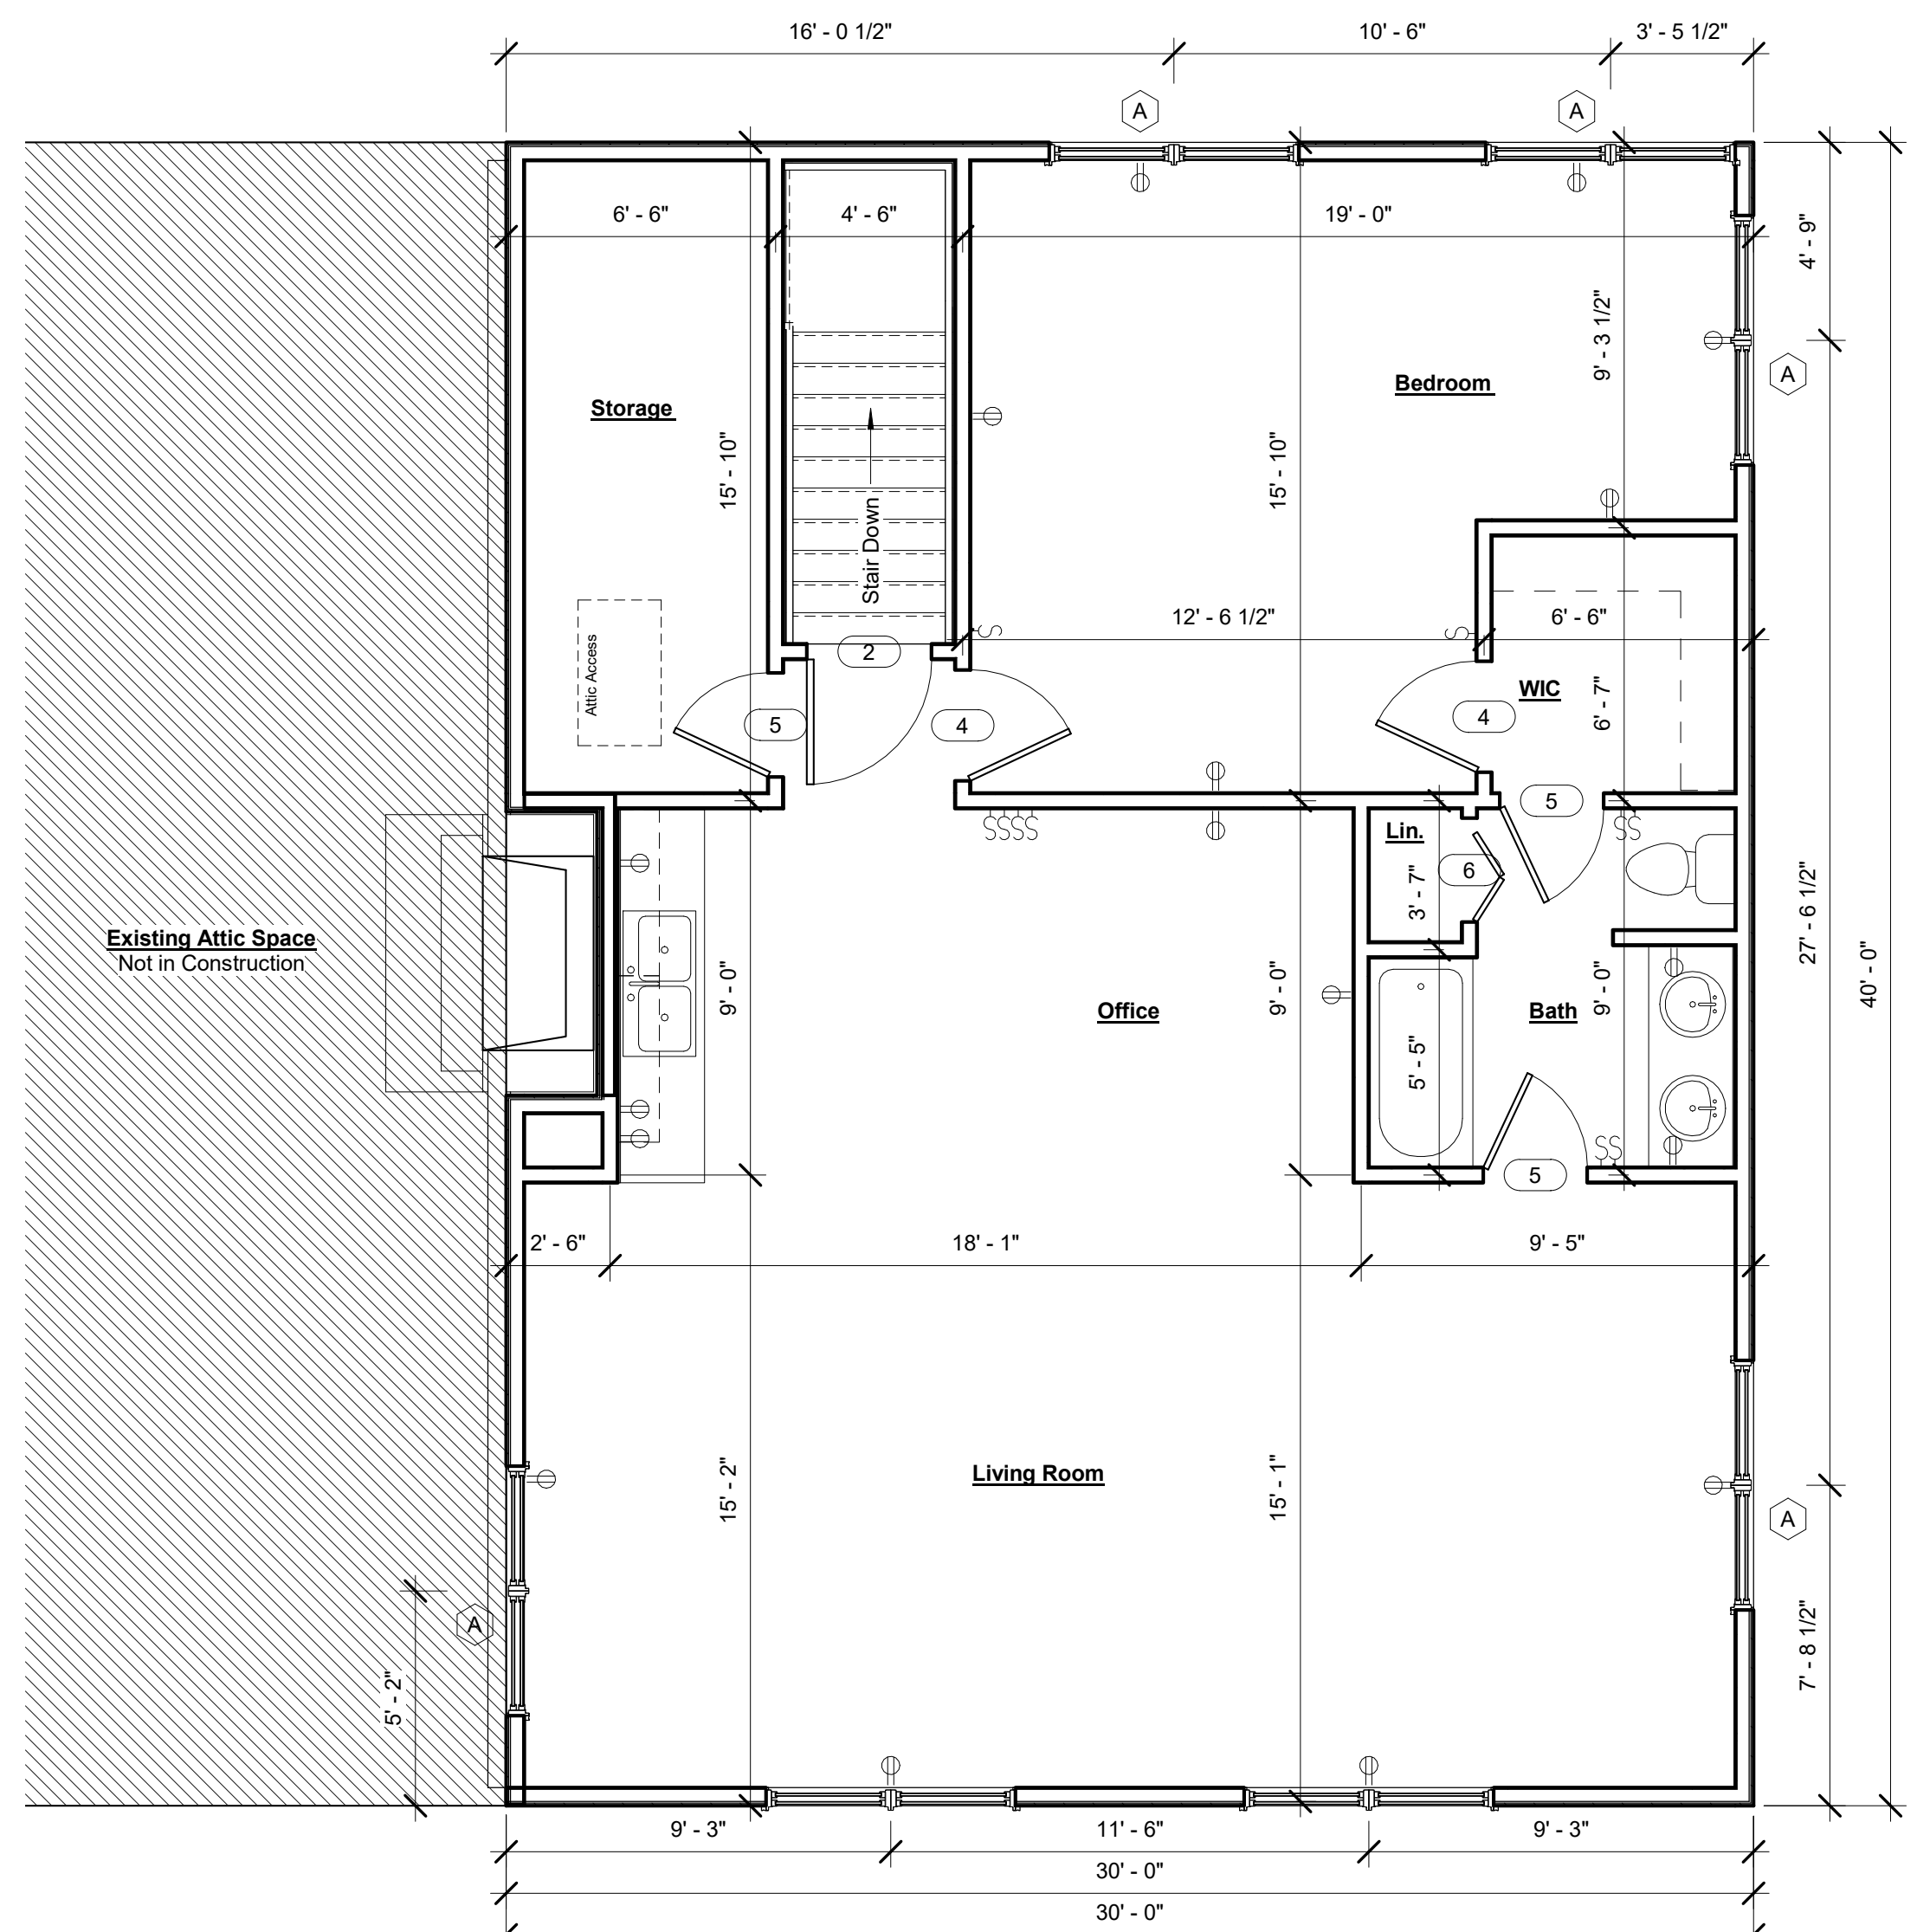
Prepared For Jesse Martin
144 Carolina Way
Sanford NC
Second Floor Plan

SCALE: 1/4" = 1'-0"

DATE: 2/26/2021

Project number 022620210001

Drawn by Author
Checked by Checker



1 Second Floor Plan
1/4" = 1'-0"


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① Front
1/4" = 1'-0"

Prepared For Jesse Martin
144 Carolina Way
Sanford NC
Elevations

Elevation Notes:

- Gutters and downspouts are not shown for clarity, downspouts shall be located towards the front and rear of the house. Locate downspouts in non-visually offensive locations. General contractor shall verify existing grades and coordinate any necessary drainage requirements with owner.
- Plumbing and HVAC vents shall be grouped in attic to limit roof penetrations and to be located away from public view and shall be primed and painted to match roof color where necessary.
- Provide attic ventilation per local code requirements.
- Exterior flashing shall be correctly installed at all connections between roofs, walls, chimneys, projections and penetrations as required by approved construction practices.
- Contractor shall provide adequate attic ventilations/roof vents per local governing code. Install continuous ridge ventilation and match to roof. Provide appropriate soffit ventilation at overhangs.

Exterior Windows And Doors

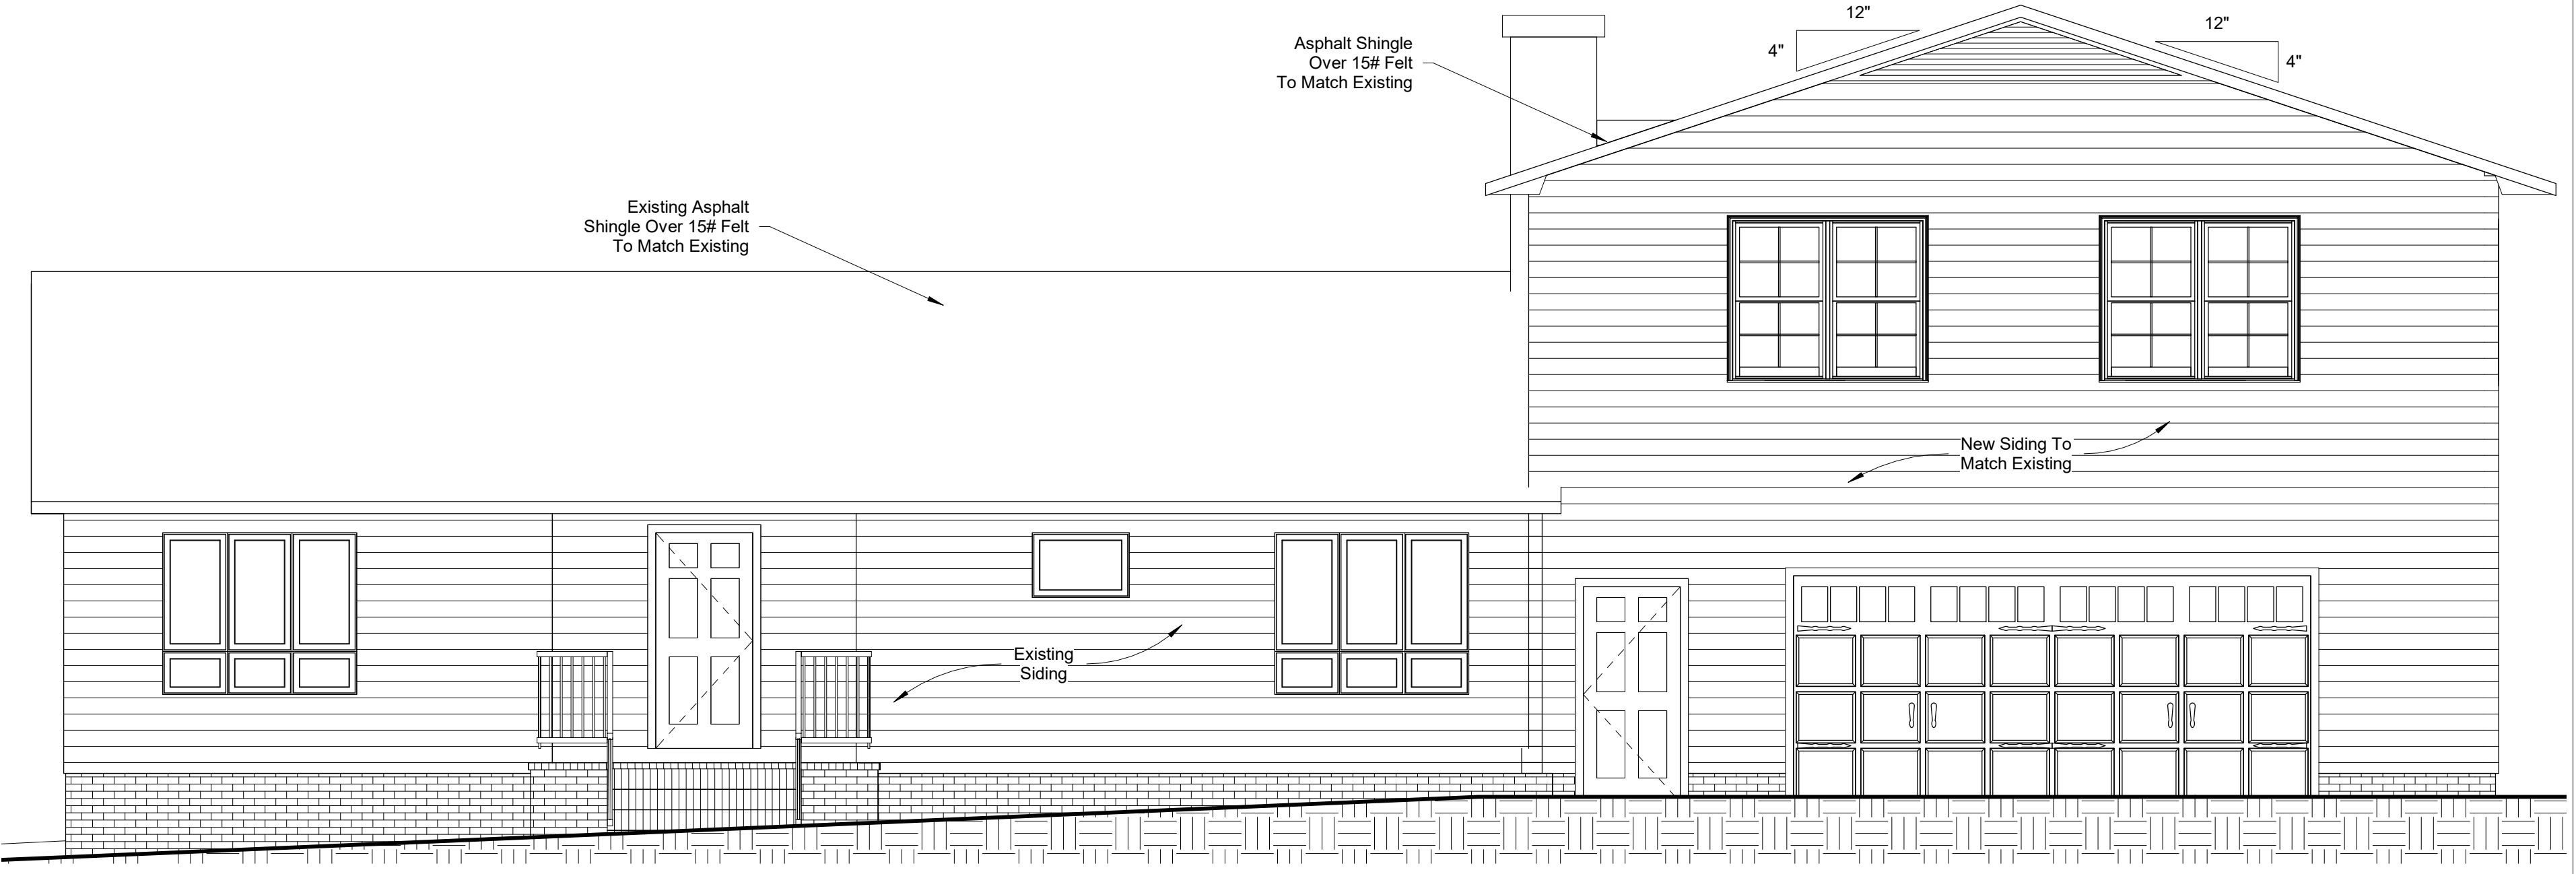Section R612
R612.1 General. This section prescribes performance and construction requirements for exterior windows and doors installed in exterior walls. Windows and doors shall be installed and flashed according with the manufacturer's installation requirements for fenestration protection. Window and door openings shall be flashed in accordance with Section R703.8. Written installation instructions shall be provided by the fenestration manufacturer for each new window and door installed.

R612.2 Window Sills. In dwelling units, where the opening of an operable window is located more than 72 inches above the finished grade or surface below, the lowest part of the clear opening of the window shall be a minimum of 24 inches above the finished floor of the room in which the window is located. Operable sections of windows shall not permit openings that allow the passage of a 4 inch diameter sphere where such openings are located within 24 inches of the finished floor.

Exceptions:


- Windows whose openings will not allow a 4 inch diameter sphere to pass through the opening when the opening is in its largest opened position.
 - Openings that are provided with window fall prevention devices that comply with R612.3.
 - Openings that are provided with window fall prevention devices that comply with ASTM F 2090.
 - Opening that are provided with opening limiting devices that comply with section R612.4.
- R612.3 Window Fall Prevention Devices.** Window fall prevention devices and window guards, where provided, shall comply with the requirements of ASTM F 2090.

SCALE:
As indicated


DATE:
2/26/2021

Project number
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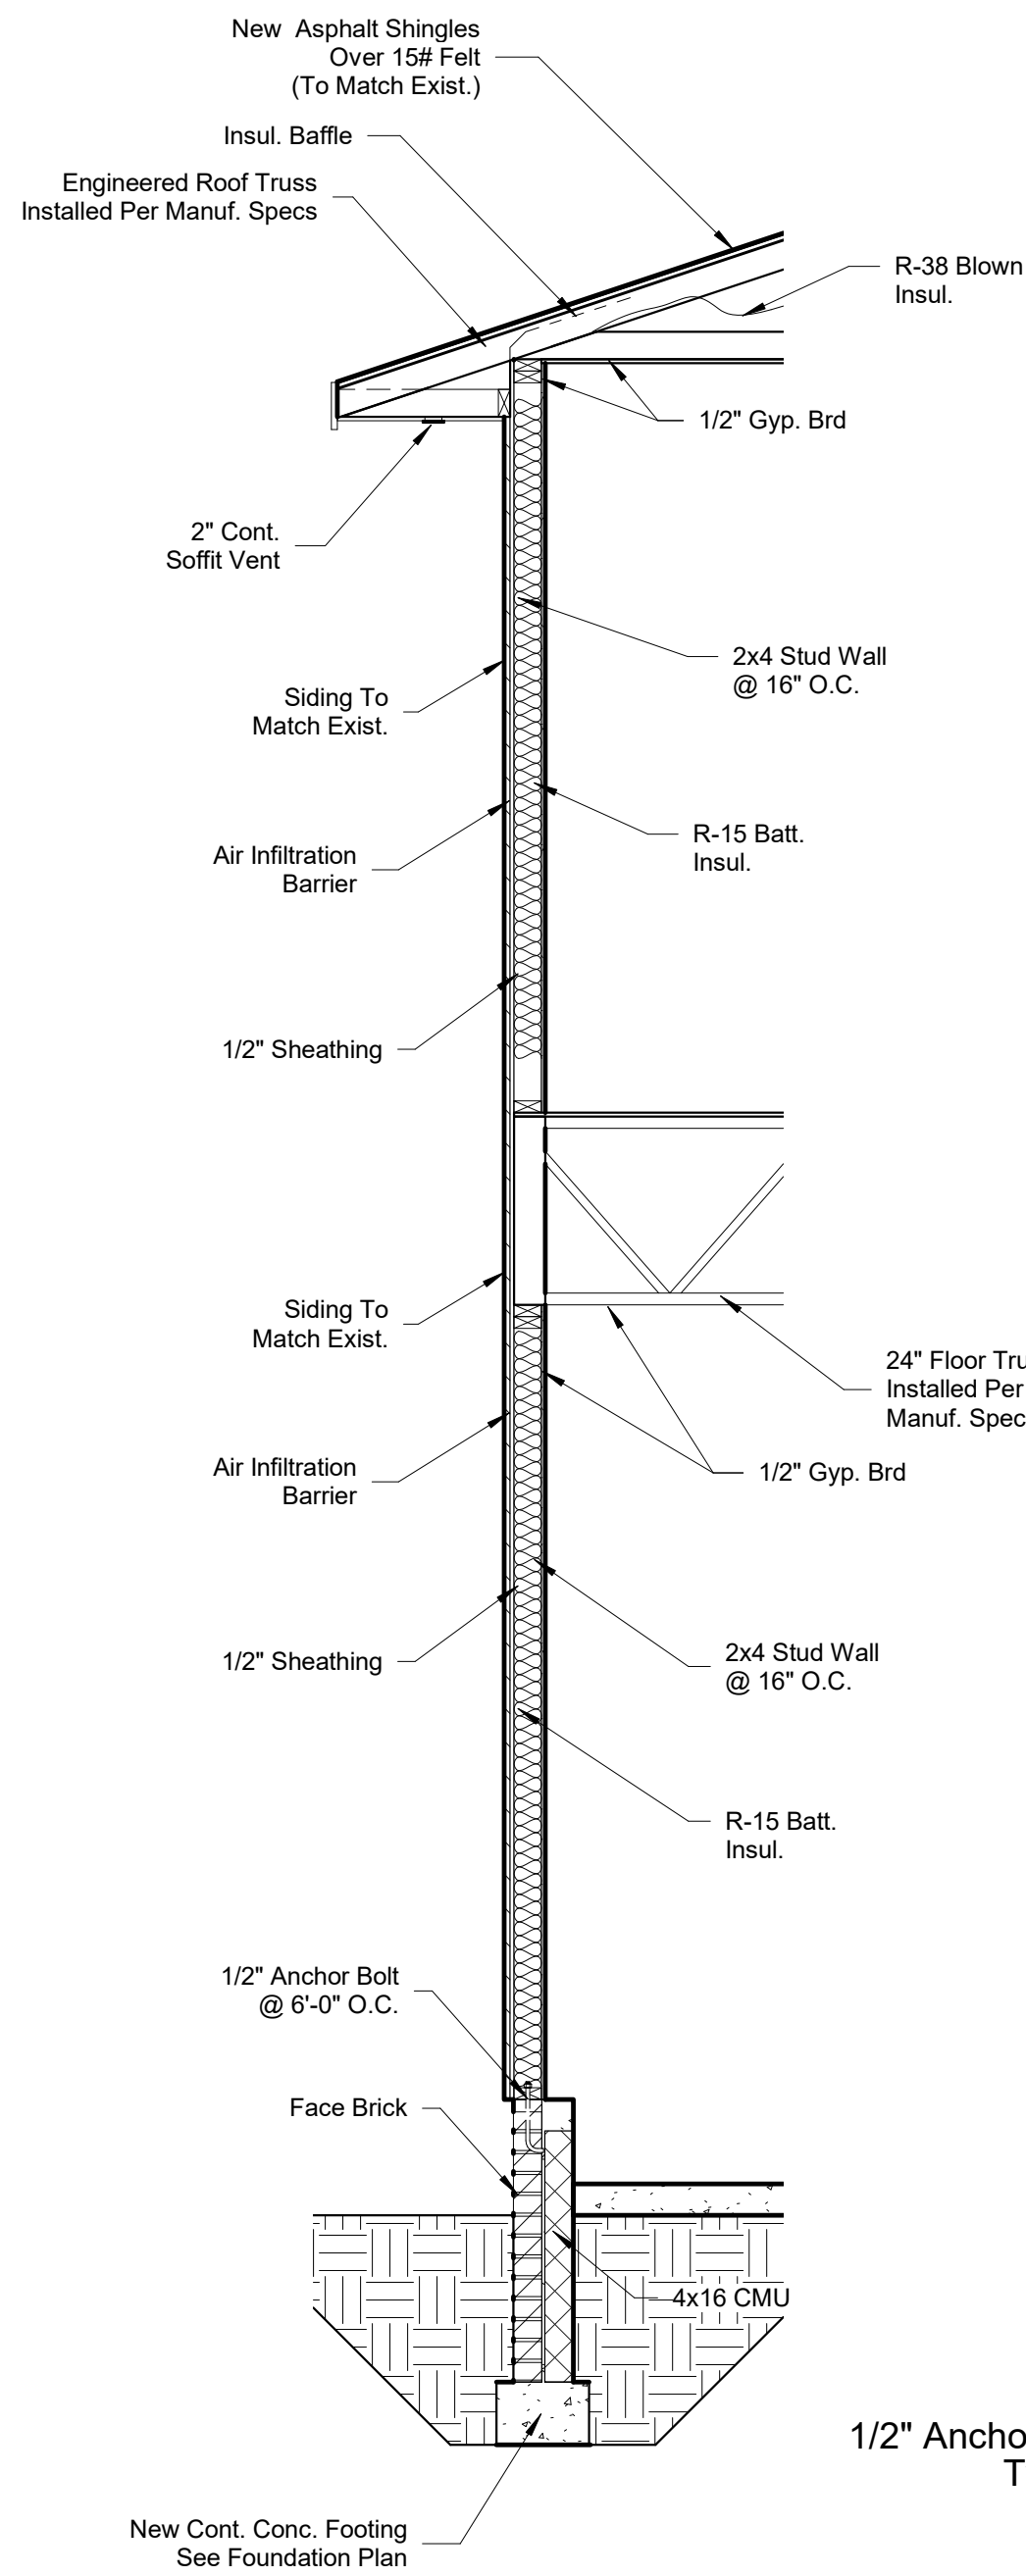
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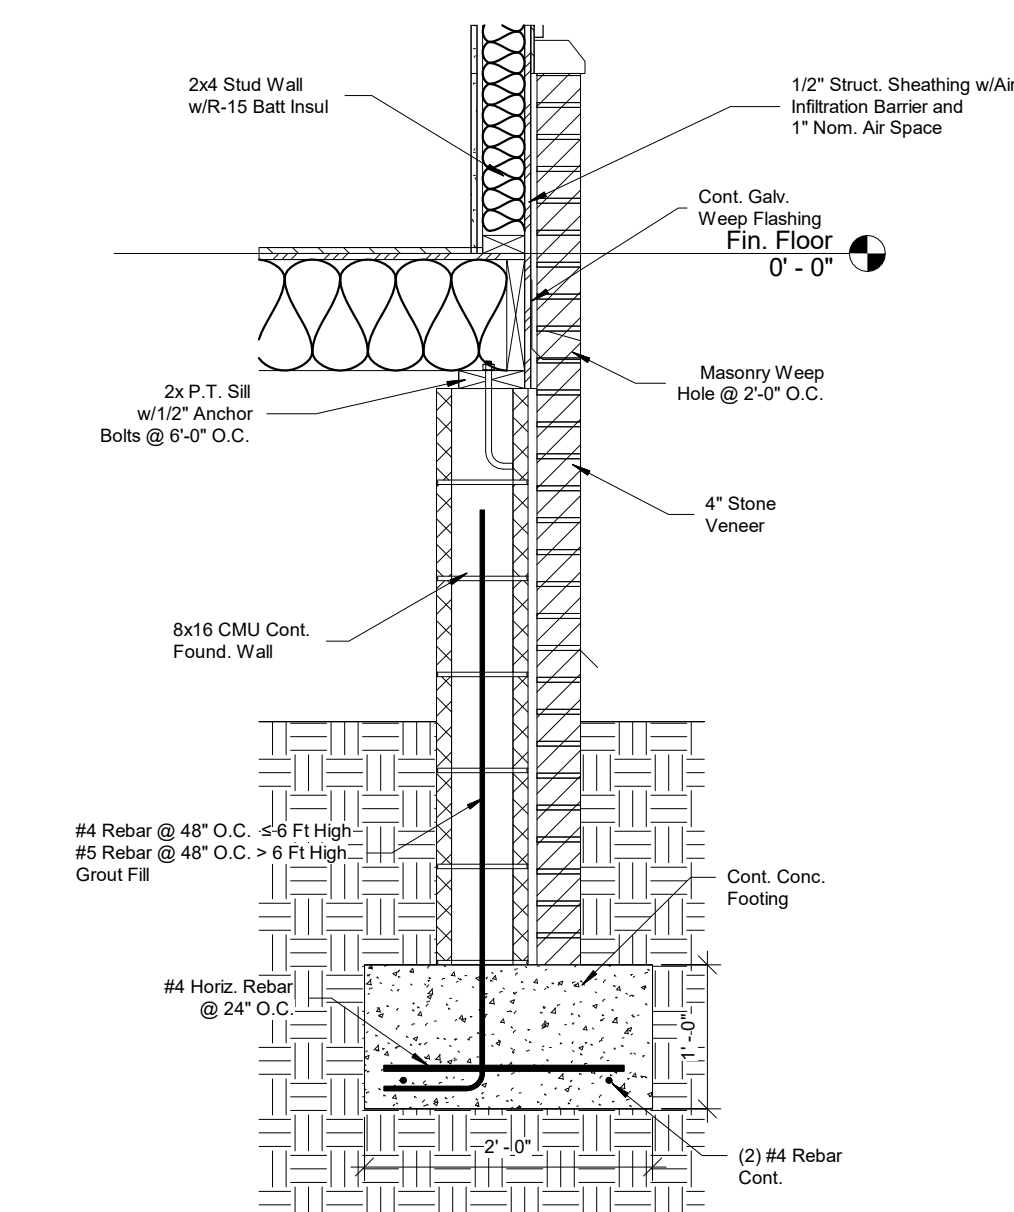
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1/8" = 1'-0"

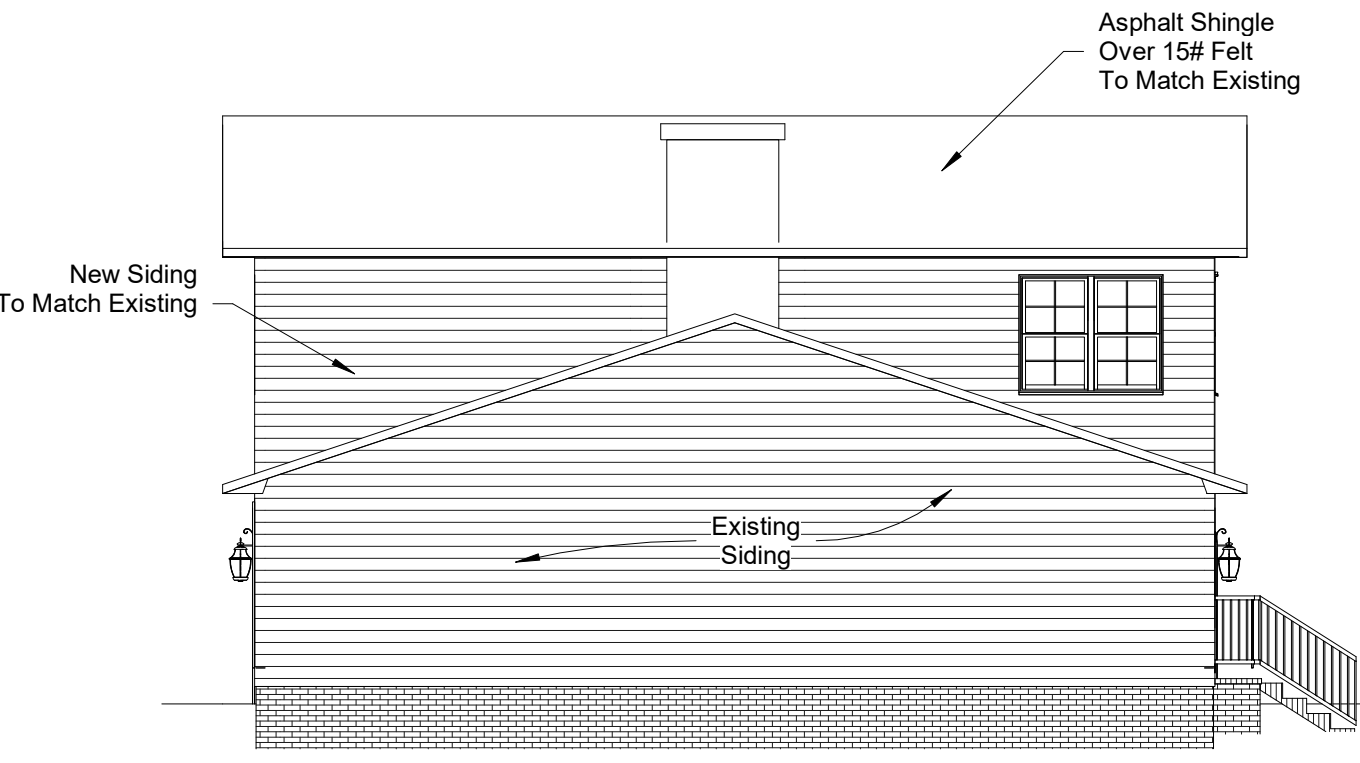


④ Right
1/8" = 1'-0"

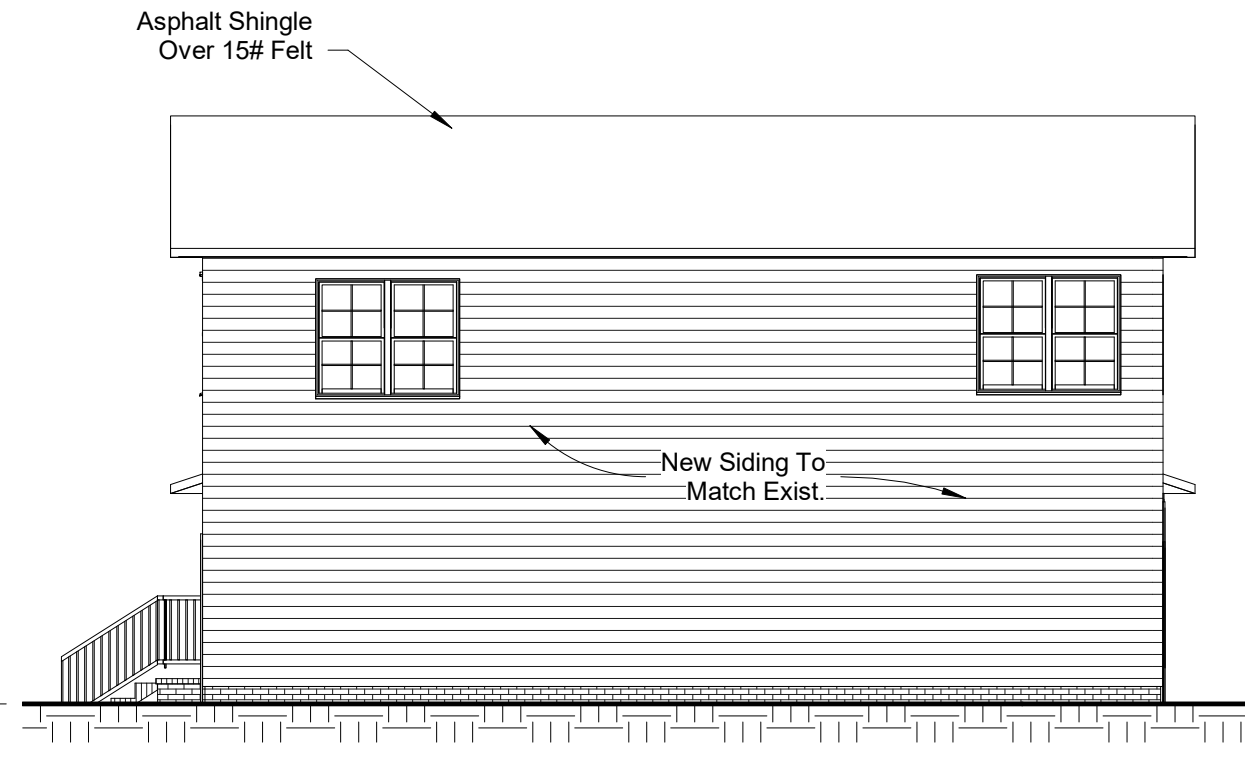


1 Typical Wall Section
1/2" = 1'-0"



3 Detail - Foundation Wall
3/4" = 1'-0"

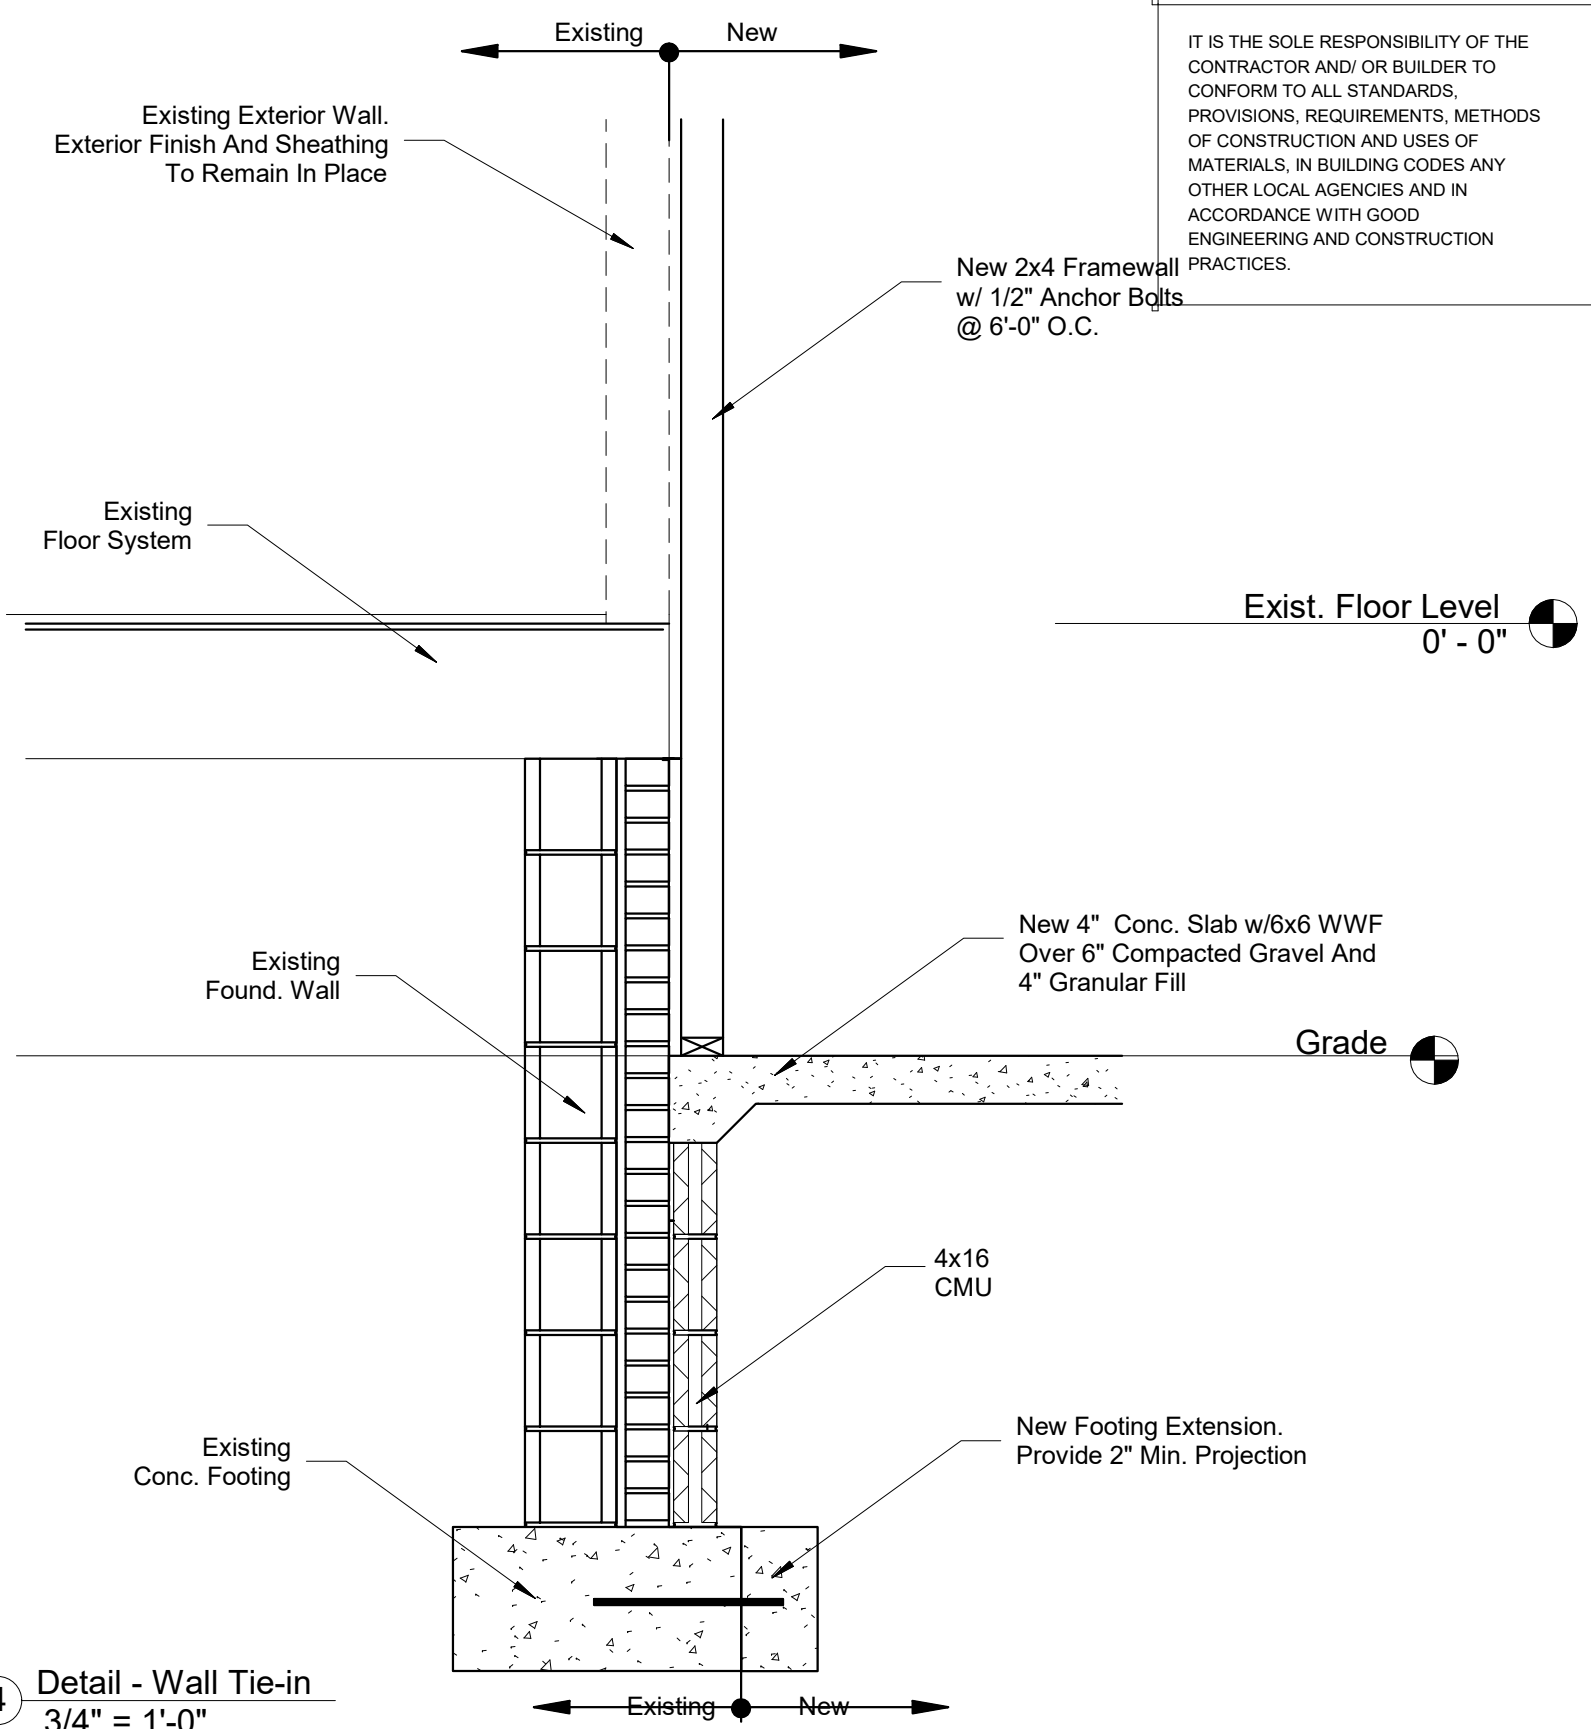

4 Detail - Wall Tie-in
3/4" = 1'-0"

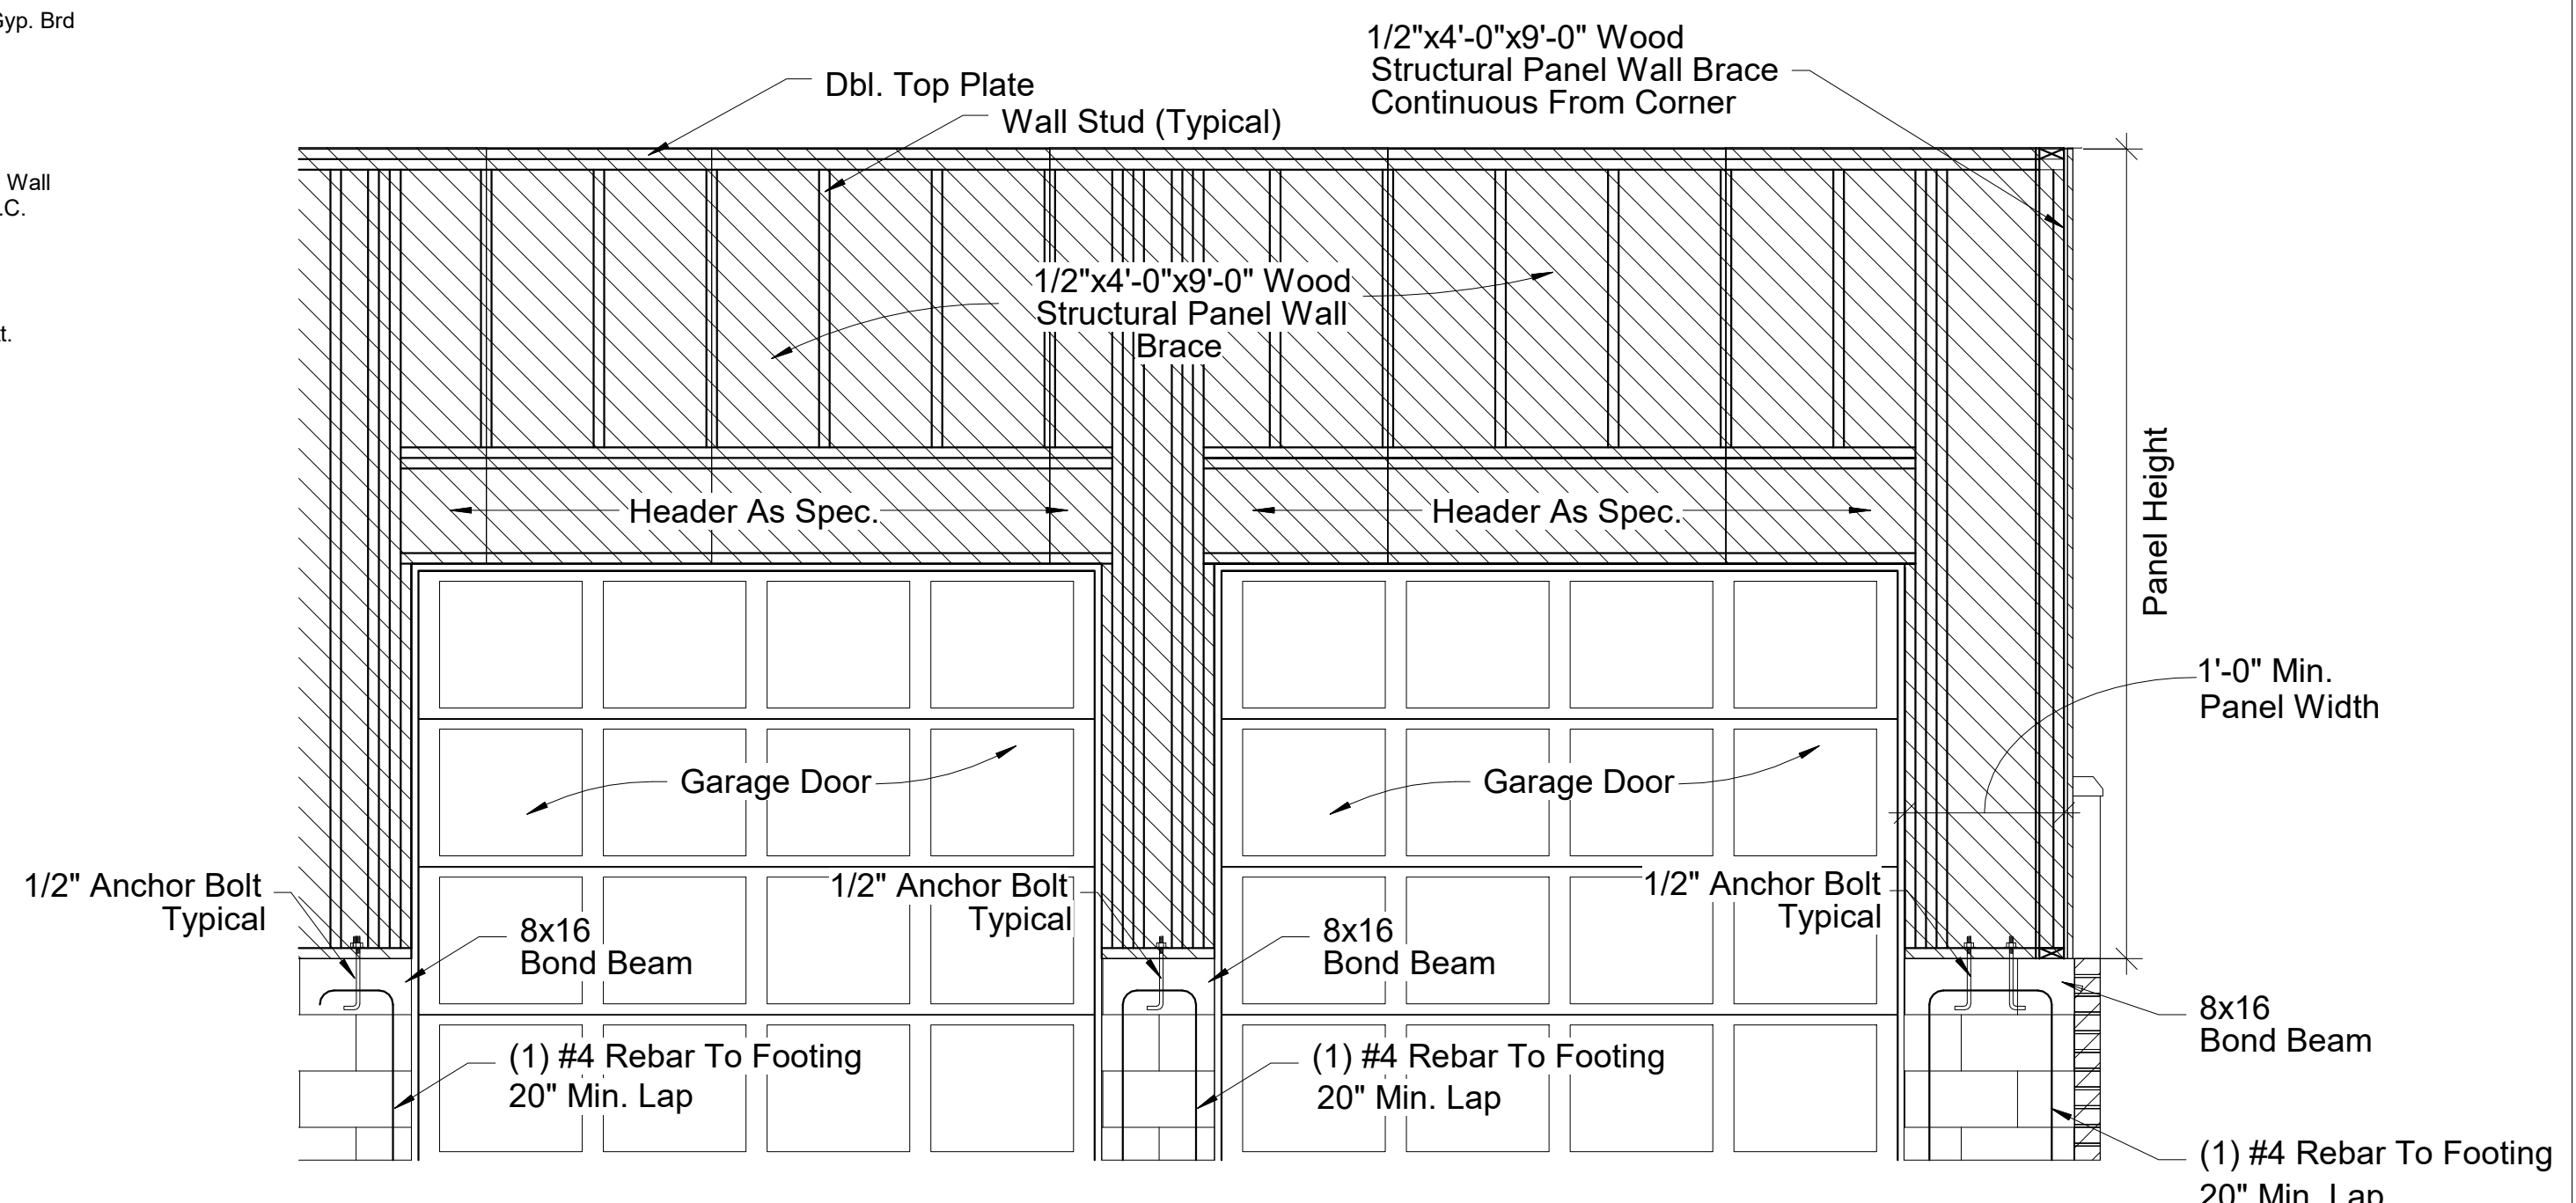

2 Detail - Portal Frame Typical
1/2" = 1'-0"

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Sanford NC
Sections & Details

SCALE:
As indicated

DATE:
2/26/2021

Project number
022620210001

Drawn by TP
Checked by TP

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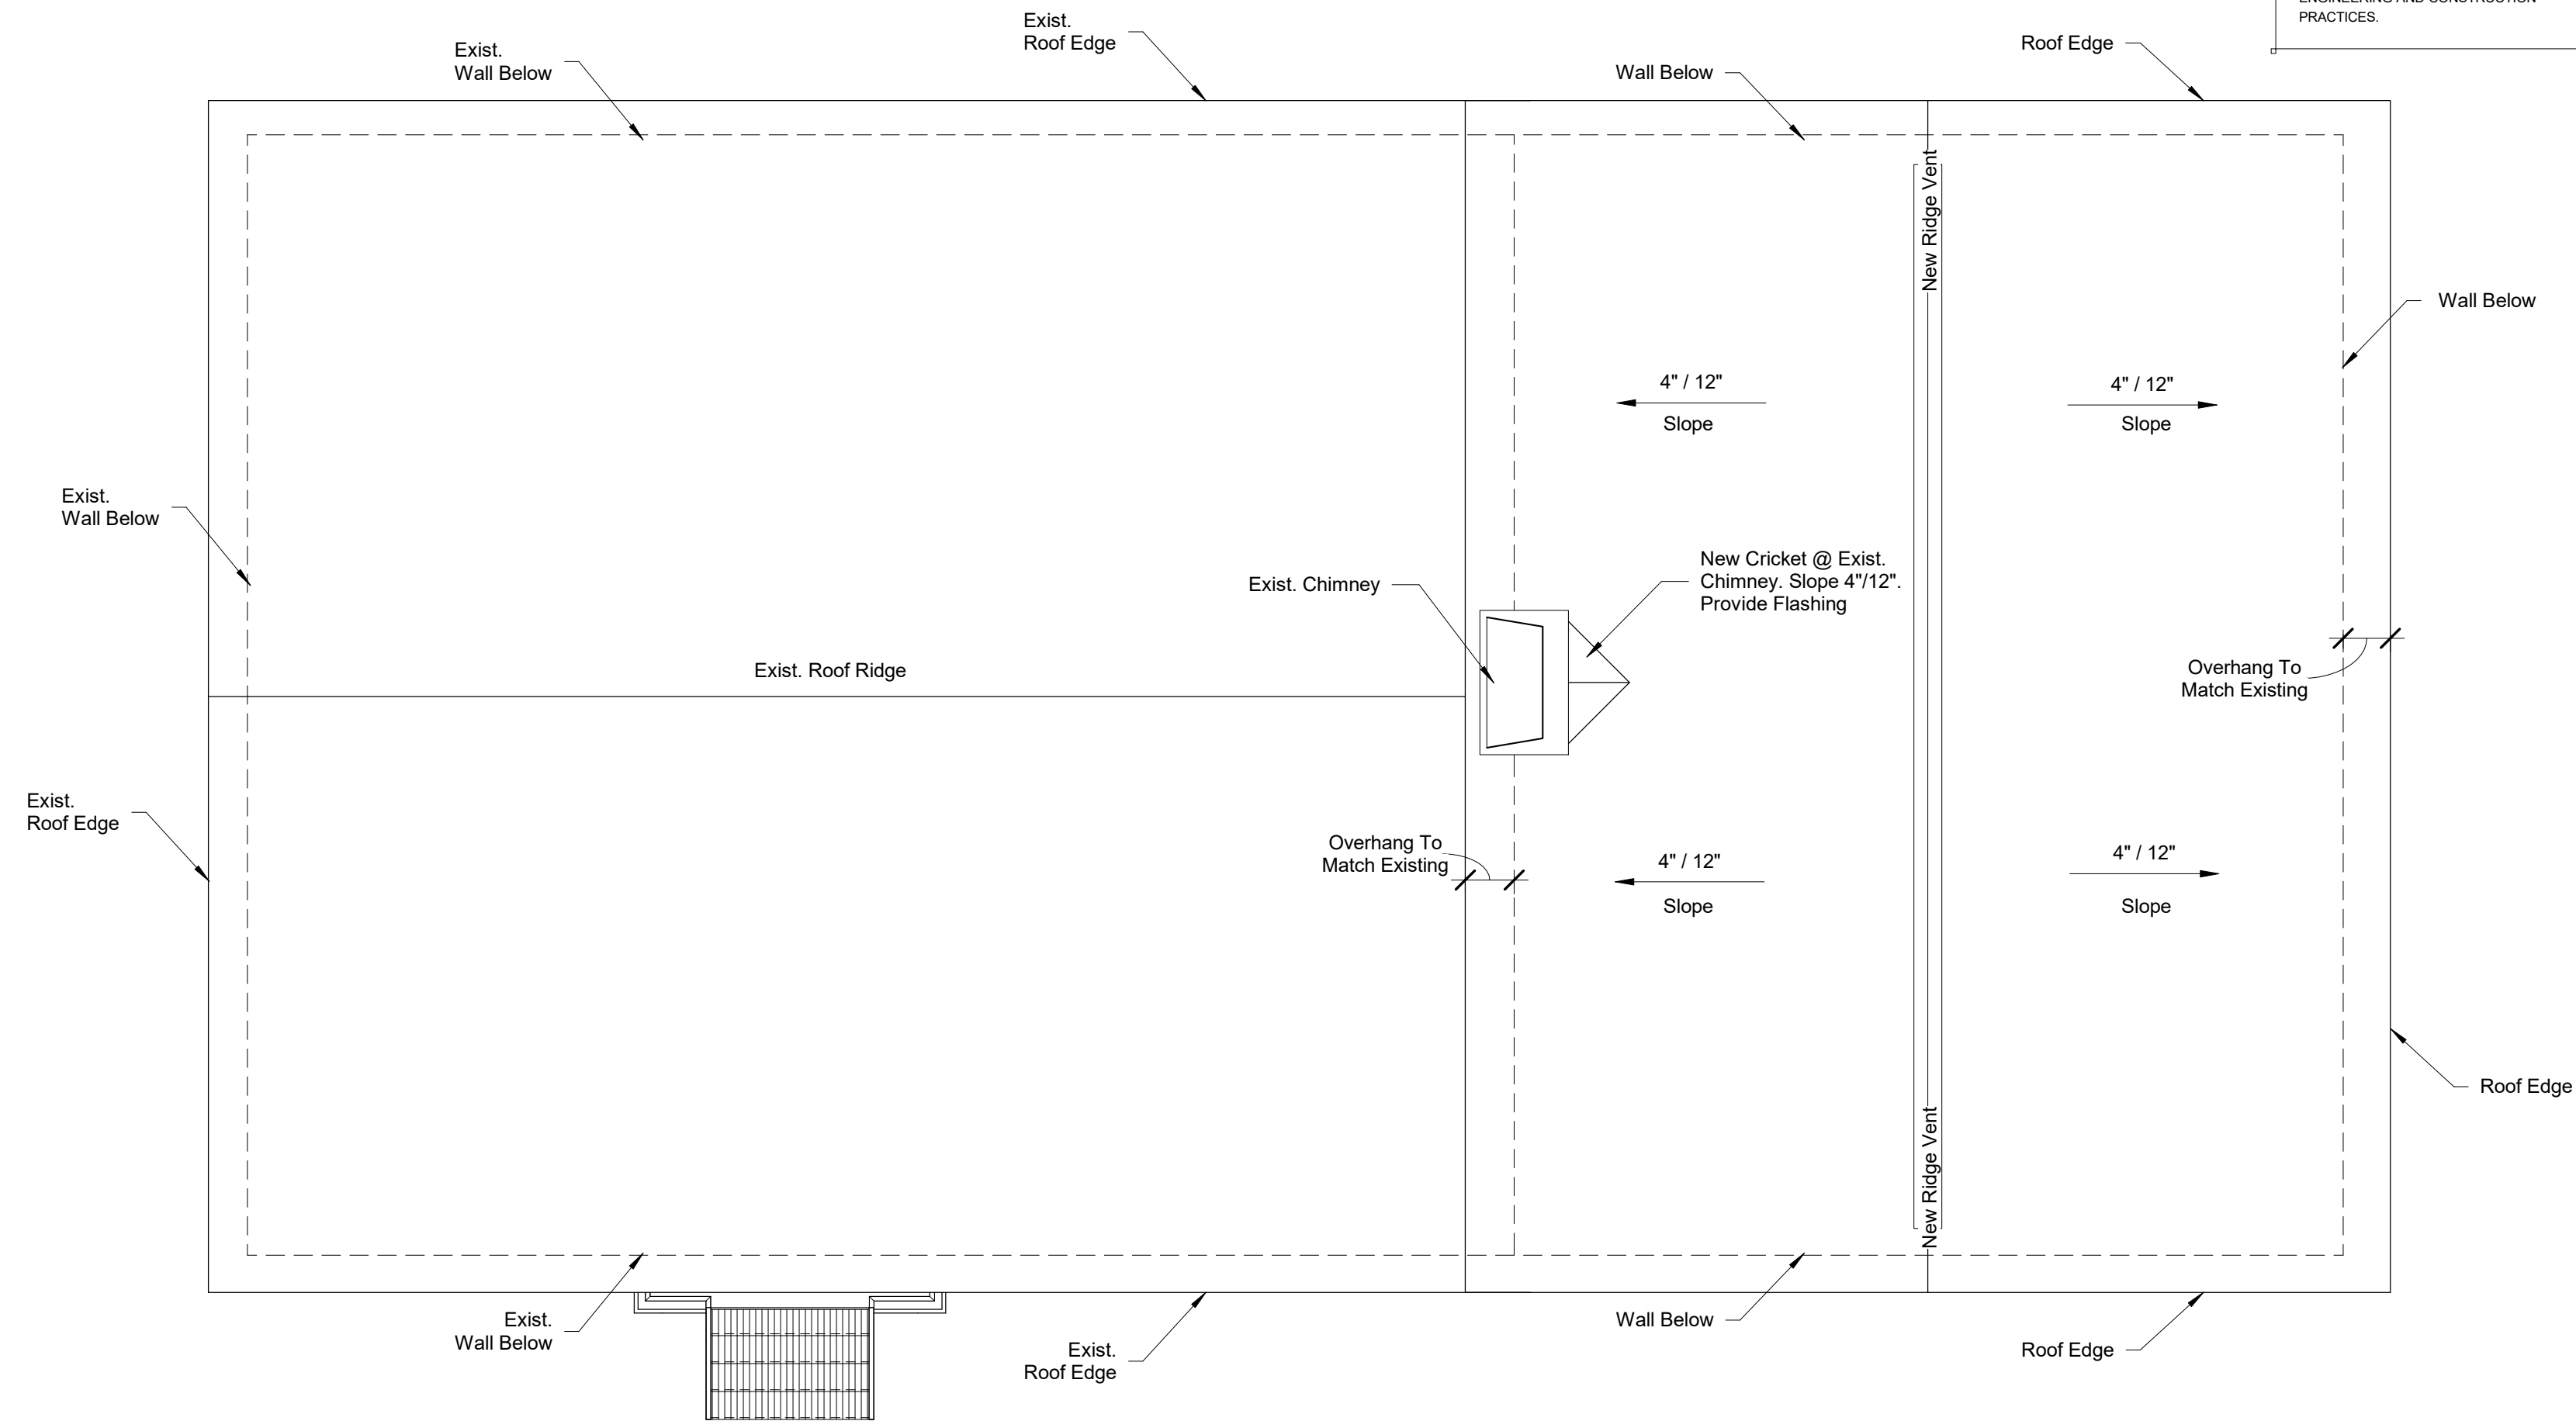
DESIGNED BY:
TIMOTHY PEPPERS JR.
RESIDENTIAL DESIGN
CONSULTANT

CAMERON
NORTH CAROLINA
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Prepared For Jesse Martin
144 Carolina Way
Sanford NC

Roof Plan



① Roof Plan
3/16" = 1'-0"

Roofing Ventilation

Section R806

R806.1 Ventilation Required. Enclosed attics and enclosed rafter spaces formed where ceilings are applied directly to the underside of the roof rafters shall have cross ventilation for each separate space by ventilating openings protected against the entrance of rain or snow. Ventilation openings shall have a least dimension of 1/16 inch minimum and 1/4 inch maximum. Ventilation opening having a least dimension larger than 1/4 inch shall be provided with corrosion-resistant wire cloth screening, hardware cloth, or similar material with openings having a least dimension of 1/16 inch minimum and 1/4 inch maximum. Openings in roof framing members shall conform to the requirements of Section 802.7.

R806.2 Minimum Area. The total net free ventilating area shall not be less than 1/150 of the area of the space ventilated except that reduction of the total area to 1/300 is permitted provided that at least 50 percent and not more than 80 percent of the required ventilating area is provided by ventilators located in the upper portion of the space to be ventilated at least 3 feet above the eave or cornice vents with the balance of the required ventilation provided by eave or cornice vents. As an alternative, the net free cross-ventilation area may be reduced to 1/300 when Class I or Class II vapor retarder is installed on the warm-in-winter side of the ceiling.


Exceptions:

1. Enclosed attic/rafter spaces requiring less than 1 square foot of ventilation may be vented with continuous soffit ventilation only.
2. Enclosed attic/rafter spaces over unconditioned space may be vented with continuous soffit ventilation only.

Square Footage Being Ventilated: 1,200 Sq. Ft.

Net Free Cross Ventilation Needed:

• Without 50% to 80% of venting 3'-0" Above Eave:	8.0 Sq. Ft.
• With 50% to 80% of venting 3'-0" above eave or Class I or Class II Vapor Retarder :	4.0 Sq. Ft

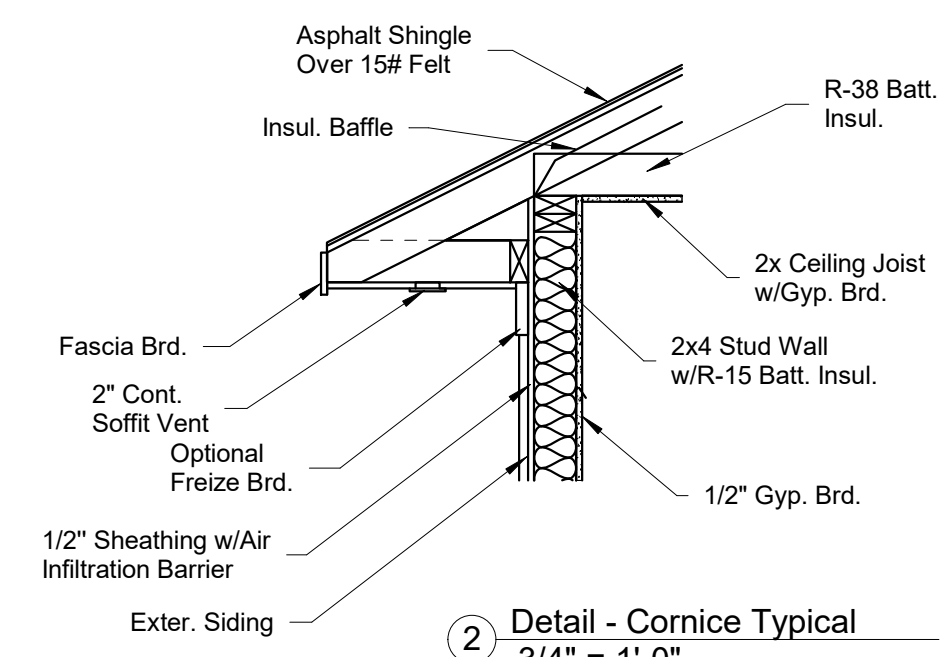

② Detail - Cornice Typical
3/4" = 1'-0"











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




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Drawn by TP
Checked by TP

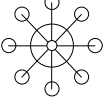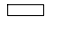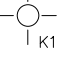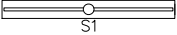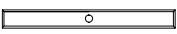LEGEND

-  CHANDELIER, CHAIN HUNG; VERIFY LAMPS AND CHAIN LENGTH
-  WALL MOUNTED CLOSET LIGHT FIXTURE 1 LAMP 120 V
-  INCANDESCENT LIGHT FIXTURE TO DETERMINED BY OWNER, 2 LAMP 120 V
-  8' STRIP FLUORESCENT FIXTURE
-  4' WET LOCATION STRIP FLUORESCENT FIXTURE W/ POLYESTER HOUSING & HIGH-IMPACT CLEAR DIFFUSER.
-  EXIT SIGN
-  EXIT SIGN WALL MOUNTED
-  6 VOLT, DUAL HEAD, EXTERIOR, WET LOCATION, WITH BACK-UP BATTERY (2) 5.5W, 6V, MR-16 STYLE HALOGEN LAMPS, MINIMUM 90 MIN. STAND-BY POWER
-  12 VOLT DUAL HEAD MAINTENANCE FREE CALCIUM STAND-BY BATTERY W/ TEST SWITCH. (2) 5.4W SEALED BEAM, SURFACE MOUNTED MINIMUM 90 MIN. STAND-BY POWER
-  6" RECESSED DIRECT/INDIRECT HORIZONTAL LAMP FLUORESCENT MULTIFUNCTION DOWNLIGHT W/ OPAL RING (WHITE FINISH U.N.O.)

-  WALL SCONCE 1 LAMP 120 V
-  CONDUCTOR
-  UNSWITCHED CONDUCTOR
- LIGHT SWITCHES**
-  WALL MOUNTED SINGLE POLE SWITCH (120/277V 20 AMP) @ 46" AFF & 2" FROM STRIKE SIDE OF DOOR JAMB TO EDGE OF BOX.
-  WALL MOUNTED 3-WAY POLE SWITCH (120/277V 20 AMP) @ 46" AFF & 2" FROM STRIKE SIDE OF DOOR JAMB TO EDGE OF BOX.

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Prepared For **Jesse Martin**
144 Carolina Way
Sanford NC
Electrical Plan

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Drawn by Author
Checked by Checker

