PINE VIEW BUILDINGS LLC.

BARN TIMBER SHED INTERMEDIATE WIND DESIGN 933 TOMLIN MILL RD. STATESVILLE, NC. 28625 M & A PROJECT NO. 19212S/20146S



DESIGN CRITERIA

1. APPLICABLE DESIGN CODES:

A. 2018 NORTH CAROLINA STATE BUILDING CODE
B. 2018 INTERNATIONAL BUILDING CODE (IBC)
C. 2015 AND 2012 IBC

2. WIND VELOCITY (3-SEC GUST) 105-145 MPH 3. RISK CATEGORY C 4. WIND EXPOSURE ±0.18 5. INTERNAL PRESSURE COEFFICIENT 6. ENCLOSURE CLASSIFICATION ENCLUSED 7. BASED ON EAVE HEIGHT 8 FEET 8. DVERHANG 9. FLOOR DESIGN LIVE LOAD (UNIFORM) 50 PSF 10. FLOOR DESIGN LIVE LOAD (CONCENTRATED) 200 LB 11. FLOUR DESIGN DEAD LOAD 10 PSF

 11. FLOGR DESIGN DEAD LOAD
 10 PSF

 12. ROOF DESIGN LIVE LOAD
 20 PSF

 13. ROOF DESIGN DEAD LOAD
 SELF WEIGHT

 14. LOFT DESIGN LIVE LOAD
 10 PSF

 15. LOFT DESIGN DEAD LOAD
 10 PSF

 16. GROUND SNOW LOAD
 35 PSF

B. RISK CATEGORY I C. R = 6.5 D. S_{DS} = 2.039 G E. S_{DI} = 1.258 G F. I_E = 1.0 G. V = C_CW

A. SDIL SITE CLASS D

17. SEISMIC LOAD:

SHEET LIST TABLE					
SHEET NUMBER SHEET TITLE					
G-1	COVER SHEET				
G-2	PE SEAL COVER SHEET				
S-1	GENERAL NOTES				
2-5	FASTENING SCHEDULE				
2-3	FASTENING SCHEDULE				
S-4	TYPICAL FRONT AND SIDE ELEVATION				
5-5	TYPICAL FRONT AND SIDE ELEVATION				
S-6	14'-0" TYPICAL ENDWALL OPENING, SIDEWALL, INTERMEDIATE AND LOFTED FRAMING SECTION				
S-7	12'-0" TYPICAL ENDWALL OPENING, SIDEWALL, INTERMEDIATE AND LOFTED FRAMING SECTION				
2-8	10'-0" TYPICAL ENDWALL OPENING, SIDEWALL, INTERMEDIATE AND LOFTED FRAMING SECTION				
S-9	8'-0" TYPICAL ENDWALL OPENING, SIDEWALL, INTERMEDIATE AND LOFTED FRAMING SECTION				
S-10	TYPICAL SIDEWALL OPENING AND SIDEWALL FRAMING SECTION				
S-11	FLOOR FRAMING PLAN				
S-12	WALL STUD/FLOOR DECK PLAN AND ROOF FRAMING PLAN				
S-13	RDGF DECK PLAN				
S-14	DETAILS AND SECTIONS				
S-15	DETAILS AND SECTIONS				
S-16	DOOR DETAILS (DOOR ANALYSIS PERFORMED BY OTHERS)				

PDH HOA S. LT AT CONSTRUCTION F ISSUED North Au (803) 279-10-7-19 DATE DATE: 5-18-20 G-1

WAYNE S. MOORE Lic. No. 051637 6/15/720	MOORE AND ASSOCIATES, INC. CO2968	65 ER S 18604 MM 1860	Moore and Association Engineering and Z Corsulting, inc.	SEAL 26784 26784 26784 26784 26784 26784
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PINE VIEW BUILDINGS LLC.

BARN TIMBER SHED 933 TOMLIN MILL RD. STATESVILLE, NC 28625

REV. 1	SCALE) AS NOTED	M&A JOB NO. 20146S
DATE: 5-18-20	DRAWN BY: AT	CHECKED BY: PDH



MOORE AND ASSOCIATES

ENGINEERING AND CONSULTING, INC.

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North Augusta, South Carolina 29841
(803) 279-7799 / FAX (803) 279-3848
www.MandA-inc.com

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0	10-7-19	ISSUED FOR CONSTRUCTION	LT	PDH	WSM
1	6-15-20	ISSUED FOR CONSTRUCTION	AT	PDH	WSM

GENERAL NOTES

- 1. THIS STRUCTURE WAS DESIGNED IN ACCORDING WITH THE 2018 INTERNATIONAL BUILDING CODE (IBC), 2015 IBC, 2018 IBC AND THE 2018 NORTH CAROLINA STATE BUILDING CODE.
- 2. ALL MATERIALS AND LABOR SHALL BE IN ACCORDANCE WITH THE ABOVE CODE AND ALL DTHER APPLICABLE LOCAL CODES AT THE TIME OF MANUFACTURE.
- 3. WRITTEN DIMENSIONS SHALL TAKE PRECEDENCE OVER SCALED DIMENSIONS.
- 4. MEMBER SPACING SHALL NOT EXCEED LIMITS AS INDICATED.
- 5. ALL LUMBER SHALL CONSIST OF MINIMUM NO. 2 SPRUCE PINE FIR (SPF).
- 6. ROOF RAFTERS SHALL CONSIST OF NOMINAL 2x4 SPF SPACED AT 24" D.C.
- 7. WALL STUDS SHALL CONSIST OF NOMINAL 2x4 SPF SPACED AT 16' D.C.
- 8. FLOOR JOISTS SHALL CONSIST OF PRESSURE TREATED NOMINAL 2x6 OR (2) 2x4 ND. 2 SPF SPACED AT 16" D.C. MAXIMUM.
- 9. RIM JUISTS SHALL CONSIST OF PRESSURE TREATED NOMINAL 2x6 NO. 2 SPF.
- 10. BOTTOM PLATES SHALL CONSIST OF NOMINAL 2x4 SPF.
- 11. PULLING BOARDS SHALL CONSIST OF (2) PRESSURE TREATED NOMINAL 2x6 NO. 2 SPF.
- 12. SKIDS SHALL CONSIST OF PRESSURE TREATED NOMINAL 4x6 SPF.
- 13. ALL THE FOLLOWING LUMBER SHALL BE PRESSURE TREATED IN ACCORDANCE WITH AWPA USE CATEGORY UC48 (GROUND CONTACT, HEAVY DUTY): SKIDS.
- 14 ALL THE FOLLOWING LUMBER SHALL BE PRESSURE TREATED IN ACCORDANCE WITH AWPA USE CATEGORY UC3B (EXTERIOR ABOVE GROUND, UNCOATED OR POOR WATER RUNDER): FLOOR JOISTS, RIM JOIST, PULLING BOARDS, PLYWOODD FLOOR DECKING, AND EXTERIOR RATED WOOD STRUCTURAL PANEL SIDING, ANY STRUCTURAL WOOD ABOVE 8' FROM GROUND ELEVATION NEED NOT BE REQUIRED TO BE PRESSURE TREATED.
- 15. ALL FASTENERS AND CONNECTORS IN CONTACT WITH PRESSURE TREATED WOOD SHALL BE HOT DIPPED GALVANIZED (G185) OR STAINLESS STEEL.
- 16. ALL WINDOWS WITHIN 24° OF DOORS AND ALL GLASS IN DOORS SHALL BE SAFETY, TEMPERED, OR ACTYLIC PLASTIC SHEET.
- 17. UNDERLAYMENT SHALL CONFORM WITH SECTION 1507.2.3.
- 18. ASPHALT SHINGLES SHALL CONFORM WITH SECTION 1507.2.5. ATTACHMENT OF ASPHALT SHINGLES SHALL CONFORM WITH 1507.2.7.
- 19. FASTENERS FOR ASPHALT SHINGLES CONFORM TO SECTION 1507.2.6.
- 20. TIE-DOWNS SHALL MEET THE REQUIREMENTS OF ALL APPLICABLE CODES.
- 21. THE CONTRACTOR SHALL BE RESPONSIBLE FOR VERIFYING ALL EXISTING CONDITIONS.
- 22. THE CONTRACTOR SHALL BE RESPONSIBLE FOR DELIVERY AND PLACEMENT OF UNIT TO ENSURE THE INTEGRITY OF THE BUILDING AND ITS COMPONENT PARTS.
- 23. NO FIELD REVISIONS TO ANY STRUCTURAL COMPONENTS OR DEVIATIONS FROM THESE DRAWINGS SHALL BE MADE.
- 24. THE OWNER AND THE CONTRACTOR SHALL HOLD HARMLESS THE ENGINEER FROM AND AGAINST ALL LIABILITY CLAIMS, DAMAGES, LOSSES AND EXPENSES, INCLUDING LEGAL FEES, ARISING OUT OF OR RESULTING FROM ERRORS OR OMISSIONS IN THE PERFORMANCE OF THE WORK BY THE CONTRACTOR.
- 25 SECTIONS AND DETAILS ON THE DRAWINGS ARE INTENDED TO BE TYPICAL AND SHALL APPLY AT ALL SIMILAR LOCATIONS, UNLESS DITHER SECTIONS AND DETAILS ARE SPECIFICALLY REFERENCED.
- 26. REFER TO SUPPLIED FASTENING SCHEDULE FOR FASTENING BASED ON CONNECTION AND LOCATION OF MEMBERS.
- 27. WALL PANELS SHALL CONSIST OF MINIMUM 3/8" LP SMARTSIDE SHEATHING PANELS.
- 28. FASTENERS IN SHEATHING PANEL SIDING MUST NOT BE INSTALLED IN PANEL SIDING GROOVES IN THE FIELD OF THE PANEL SIDING OR WHEN THE PANEL SIDING GROOVES OCCUR AT CUT EDGES OF THE PANEL SIDING.
- 29. MAXIMUM OPENINGS WIDTHS MUST COMPLY WITH DESIGN RATIOS AS PER ANS/AF & PA SDPWS-2008.
- 30. FLOOR DECKING SHALL CONSIST OF MINIMUM 5/8' DSB BY HUBER-PERFORMAX.
- 31 ROOF DECKING SHALL CONSIST OF 7/16' DSB
- 32. PROVIDE EDGE SUPPORT TO ALL STRUCTURAL PANELS ON THE ROOF, FLOOR AND WALLS.
- 33. UNLESS NOTED OTHERWISE, ATTACH ALL MANUFACTURED PRODUCTS IN ACCORDANCE WITH MANUFACTURERS SPECIFICATIONS

SHEET NO.	PINE VIEW BARN 933 TI STATES	PINE VIEW BUILDINGS LLC. BARN TIMBER SHED 933 TOMLIN MILL RD. STATESVILLE, NC 28625	MOORE AND ASSOCIATES ENGINEERING AND CONSULTING		ENGI	MOORE AND ASSOCIATES ENGINEERING AND CONSULTING, INC. 1008 East Avenue North Augusta, South Caroline 29841 (803) 279–7799 / FX (803) 279–3848 www.MondA-inc.com	CIATES CULTING, IN	j.		
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	FASTENING SCHEDULE	
DESCRIPTION OF BUILDING ELEMENTS	NUMBER AND TYPE OF FASTENER	SPACING AND LOCATION
	ROOF	
BLOCKING BETWEEN CEILING JOISTS, RAFTERS OR TRUSSES TO TOP PLATE OR OTHER FRAMING BELOW	3-8d COMMON (2 1/2"x0.131") 3-10d BOX (3"x0.128"); DR 3-3"x0.131" NAILS 3-3"-14 GAUGE STAPLES, 7/16" CROWN	EACH END, TOENAIL
BLOCKING BETWEEN RAFTERS OR TRUSS NOT AT THE WALL TOP PLATE, TO RAFTER OR TRUSS	2-8d COMMON (2 1/2*x0.131*) 2-3*x0.131* NAILS 2-3*-14 GAUGE STAPLES	EACH END, TOENAIL
	2-16d CDMMDN (3 1/2"x0.135") 3-3"x0.131" NAILS 3-3"-14 GAUGE STAPLES	END NAIL
FLAT BLOCKING TO TRUSS AND WEB FILLER	16d CDMMON (3 1/2"x0.162") AT 6" D.C. 3"x0.131" NAILS AT 6" D.C. 3"-14 GAUGE STAPLES AT 6" D.C.	FACE NAIL
RAFTER OR ROOF TRUSS TO TOP PLATE	3-10d COMMON (3*x0.148*); DR 3-16d BOX (3 1/2*x0.135*); DR. 4-10d BOX (3*x0.128*); DR 4-3*x0.131* NAILS; DR 4-3*-14 GAUGE STAPLES, 7/16* CROWN	TOENAIL ^b
	WALL	
STUD TO STUD (NOT AT BRACED	16d COMMON (3 1/2"x0.162");	24" D.C. FACE NAIL
WALL PANELS)	10d BDX (3*x0.128*); DR 3*x0.131* NAILS; DR 3-3*-14 GAUGE STAPLES, 7/16* CROWN	16" D.C. FACE NAIL
STUD TO STUD AND ABUTTING STUDS AT INTERSECTING WALL CORNERS (AT	16d COMMON (3 1/2"x0.162") DR	16" D.C. FACE NAIL
	16d BOX (3 1/2"x0.135"); OR	12" U.C. FACE NAIL
BRACED WALL PANELS)	3"x0.131" NAILS; DR. 3-3"-14 GAUGE STAPLES, 7/16" CROWN	12" D.C. FACE NAIL
BUILT-UP HEADER (2" TO 2" HEADER)	16d COMMON (3 1/2*x0.162*); DR	16° D.C. EACH EDGE, FACE NAIL
	16d BOX (3 1/2*x0.135*)	12° D.C. EACH EDGE, FACE NAIL
. TOP PLATE TO TOP PLATE	16d CDMMDN (3 1/2*x0.162*) DR	16" D.C. FACE NAIL
	10d BDX (3*x0.128*); DR 3*x 0.131* NAILS; DR 3*-14 GAUGE STAPLES, 7/16* CROWN	12" D.C. FACE NAIL
7. TOP PLATE TO TOP PLATE, AT END JOINTS	8-16d COMMON (3 1/2'x0.162'); DR 12-10d BDX (3'x0.128'); DR 12-3'x0.131' NAILS; DR 12-3'-14 GAUGE STAPLES, 7/16' CROWN	EACH SIDE OF END JOINT, FACE NAIL (MINIMUM 24° LAP SPLICE LENGTH EACH SIDE OF END JOINT)
B BOTTOM PLATE TO JOIST, RIM JOIST, BAND JOIST OR BLOCKING (NOT AT BRACED WALL PANELS)	16d CDMMDN (3 1/2"x0.162"); DR 16d BDX (3 1/2"x0.135"); DR 3"x0.131" NAILS; DR 3" 14 GAUGE STAPLES; 7/16" CRDWN	16" D.C. FACE NAIL 12" D.C. FACE NAIL
D. BOTTOM PLATE TO JOIST, RIM JOIST, BAND JOIST OR BLOCKING AT BRACED WALL PANELS	2-16d CDMMON (3 1/2*x0.162*); DR 3-16d BDX (3 1/2*x0.135*); DR 4 3*x0.131* NAIL S; DR 4-3*14 GAUGE STAPLES, //16* CROWN	16" D.C. FACE NAIL
D. STUD TO TOP OR BOTTOM PLATE	4-8d COMMON (2 1/2*x0.131*); IIR 4-10d BOX (3*x0.128*); OR 4-3*x0.131* NAILS; OR 4-3* 14 GAUGE STAPLES, 7/16* CROWN	TOENAIL
	2-16d CDMMDN (3 1/2'x0.162'); UR 3-10d BDX (3'x0.128'); DR 3-3'x0.131' NAILS; DR 3-3' 14 GAUGE STAPLES, 7/16' CROWN	END NAIL

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BY CK. APVD. LT PDH VSM AT PDH VSM

> ISSUED FOR CONSTRUCTION ISSUED FOR CONSTRUCTION

> > 6-15-20

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PINE VIEW BUILDINGS LLC. MEA JUB NO. 20146S CHECKED BY: PDH BARN TIMBER SHED 933 TOMLIN MILL RD. STATESVILLE, NC 28625 DRAVN BY: AT SCALE AS NOTED

DATE 5-18-20

REV. 1

SHEET NO. **S-2**


	FASTENING SCHEDULE		
DESCRIPTION OF BUILDING ELEMENTS	NUMBER AND TYPE I FASTENER	DF	SPACING AND LOCATION
11. TOP PLATES, LAPS AT CORNERS AND INTERSECTIONS	2-16d CDMMON (3 1/2*x0.162*); 3-10d BOX (3*x0.128*); DR 3-3*x0.131* NAILS; DR 3-3* 14 GAUGE STAPLES, 7/16*		FACE NAIL
	FLOOR		
12. RIM JOIST, BAND JOIST, OR BLOCKING TO TOP PLATE, SILL OR OTHER FRAMING BELOW	8d COMMON (2 1/2"x0.131"); DR 10d BOX (3" 0.128") DR 3"x0.131" NAILS; DR 3" 14 GAUGE STAPLES, 7/16" CR	ROWN	6° D.C. TOENAIL
13. JOIST TO BAND JOIST RIM JOIST	3-16d CDMMDN (3 1/2*x0.162*); 4-10d BDX (3*x0.128*); DR 4-3*x0.131* NAILS; DR 4-3* 14 GAUGE STAPLES, 7/16*		END NAIL
14. BRIDGING OR BLOCKING TO JOIST, RATE OR TRUSS	R 2-8d CDMMON (2 1/2"x0.131"); D 2-10d BDX (3"x0.128"); DR 2-3"x0.131" NAILS; DR 2-3" 14 GAUGE STAPLES, 7/16"		EACH END, TOENAIL
	NELS (WSP), SUBFLOOR, ROOF AND AND PARTICLEBOARD WALL SHEAT		
		EDGES (INCHES)	INTERMEDIATE SUPPORTS (INCHES)
15. 3/8" 8d BDX DR DE	FURMED (2 1/2"×0.113") (ROOF)	6	12

- A. NAILS SPACED AT 6 INCHES AT INTERMEDIATE SUPPORTS WHERE SPANS ARE 48 INCHES OR MORE. FOR NAILING OF WOOD STRUCTURAL PANEL AND PARTICLEBOARD DIAPHRAGMS AND SHEAR WALL, REFER TO SECTION 2305 NAILS FOR WALL SHEATHING ARE PERMITTED TO BE COMMON, BOX OR CASING.
- B. WHERE A RAFTER IS FASTENED TO AN ADJACENT PARALLEL CELLING JOIST IN ACCORDANCE WITH THIS SCHEDULE AND THE CEILING JOIST IS FASTENED TO THE TOP PLATE IN ACCORDANCE WITH THIS SCHEDULE, THE NUMBER OF TOENALLS IN THE RAFTER SHALL BE PERMITTED TO BE REDUCED BY ONE NAIL.

FLOOR	LOAD CAPACITY TA	BLE		
FLOOR JOIST	(2) 2×4-12" D.C.	(2) 2x4-16" D.C.	2x6-12" D.C.	2×6-16" D.C.
MAX. PIER SPACING (SKID BLOCKING)	5'-0" D.C	5'-0" D.C	5'-0" D.C	5'-0' D.C
	5/8" DECKING			
TOTAL FLOOR LOAD (PSF) *	50	50	60	60
POINT LIVE LOAD (LB)	200	200	200	200
	3/4' DECKING			
TOTAL FLOOR LOAD (PSF) *	50	50	60	60
POINT LIVE LOAD (LB)	200	200	200	200
	LOFTS			
TOTAL FLOOR LOAD (PSF) *	20			
POINT LIVE LOAD (LB)	200			

* TL= LL+DL; DL=10 PSF

S	PINE VIEW	PINE VIEW BUILDINGS LLC.	2		22	MOORE AND	MOORE AND ASSOCIATES	1		
6-3	BARI 933 T STATES	BARN TIMBER SHED 933 TOMLIN MIL RD. STATESVILLE, NC 28625	MOORE AND ASSOCIATES ENGINEERING AND CONSULTING			1009 East Avenue North Augusto, South Caroline 29841 (803) 279–7799 / FAX (803) 279–38 www.MandA-inc.com	1009 East Averue usto, South Carolina 29841 7799 / FAX (803) 279–3848 ww.MandA-inc.com			
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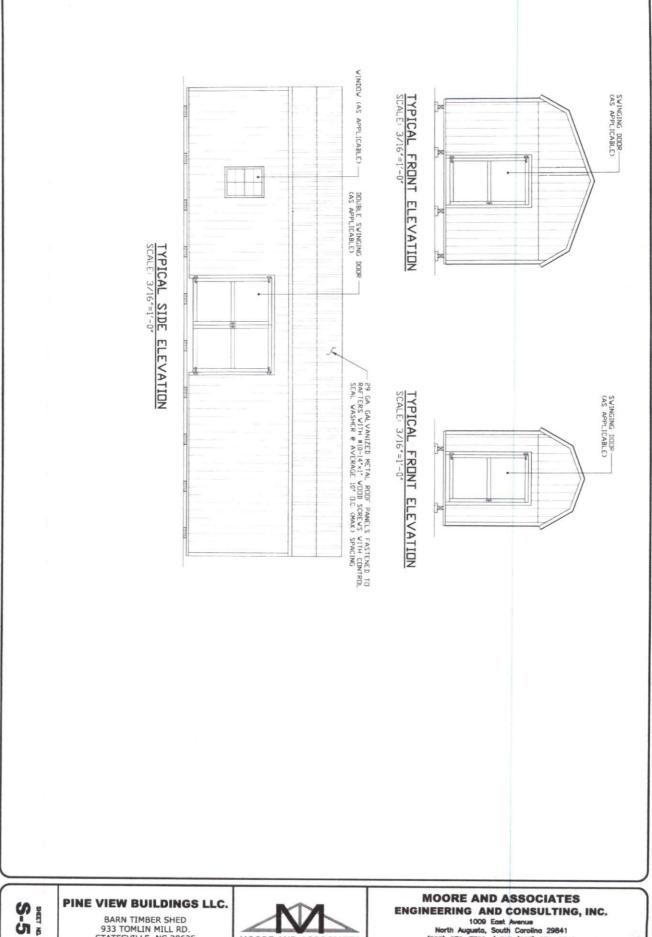


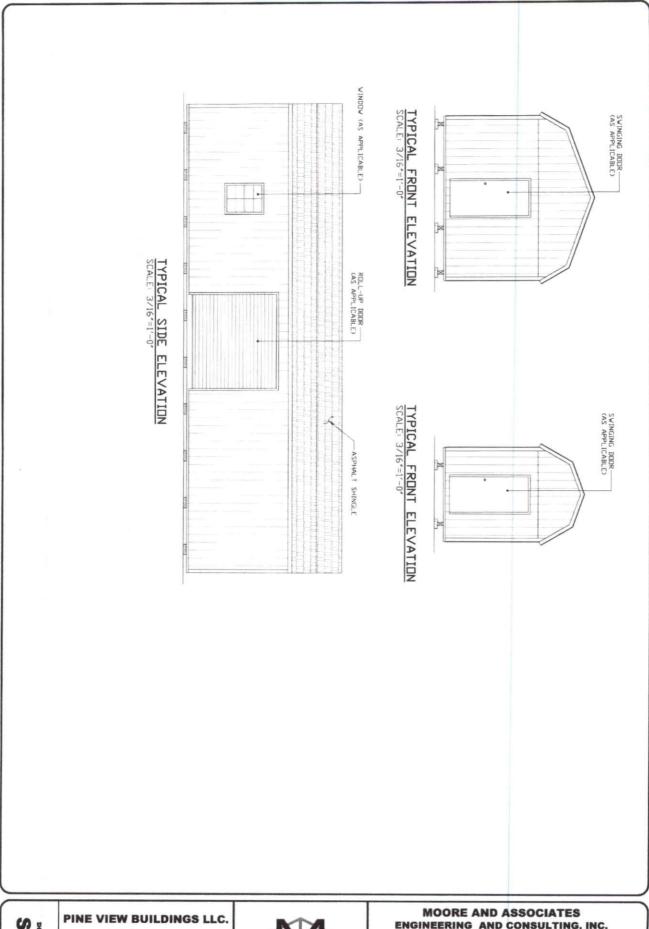S-4 BARN TIMBER SHED 933 TOMLIN MILL RD. STATESVILLE, NC 28625 SCALE: REV. 1 M&A JOB NO. 20146S DATE: 5-18-20 DRAWN BY AT CHECKED BY: PDH



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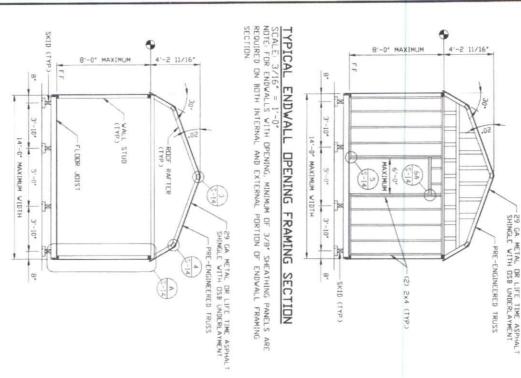
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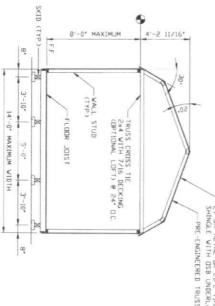
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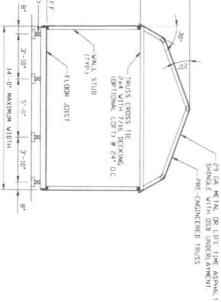
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TYPICAL ENDWALL FRAMING SECTION

SCALE: 3/16" = 1'-0"





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REV. 1	SCALE: AS NUTED	MLA JUB NO. 20146S
DATE: 5-18-20	DRAWN BY AT	CHECKED BY: PDH

SCALE: 3/16*

TYPICAL INTERMEDIATE FRAMING SECTION

SCALE: 3/16*

TYPICAL LOFTED BARN FRAMING SECTION



4'-2 11/16"

29 GA METAL DR LIFE TIME ASPHALT SHINGLE WITH DSB UNDERLAYMENT.

PRE-ENGINEERED TRUSS

WALL STUD CTYPS

8'-0" MAXIMUM

1.4

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3'-10"

3'-10"


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-SKID (TYP.)

14'-0" MAXIMUM WIDTH

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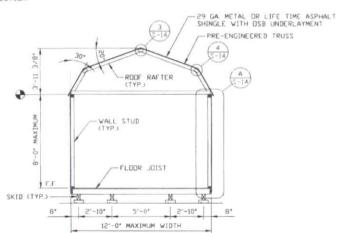
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TYPICAL ENDWALL OPENING FRAMING SECTION


SCALE: 3/16" = 1'-0"

NOTE: FOR ENDWALLS WITH OPENING, MINIMUM OF 3/8' SHEATHING PANELS ARE REQUIRED ON BOTH INTERNAL AND EXTERNAL PORTION OF ENDWALL FRAMING SECTION

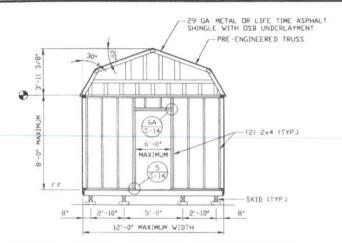


TYPICAL INTERMEDIATE FRAMING SECTION

SCALE: 3/16" = 1'-0"

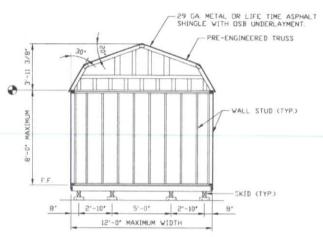

TYPICAL ENDWALL FRAMING SECTION


SCALE: 3/16" = 1'-0"

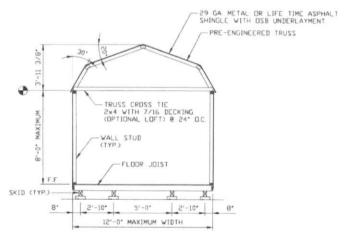

TYPICAL LOFTED BARN FRAMING SECTION

SCALE: 3/16" = 1'-0"


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TYPICAL ENDWALL OPENING FRAMING SECTION

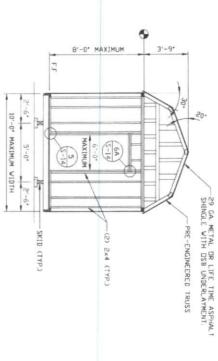
SCALE; 3/16" = 1'-0" NOTE: FOR ENDWALLS WITH OPENING, MINIMUM OF 3/8" SHEATHING PANELS ARE REQUIRED ON BOTH INTERNAL AND EXTERNAL PORTION OF ENDWALL FRAMING SECTION.





29 GA. METAL DR LIFE TIME ASPHALT SHINGLE WITH DSB UNDERLAYMENT.

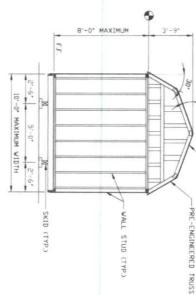TYPICAL ENDWALL FRAMING SECTION SCALE: 3/16" = 1'-0"

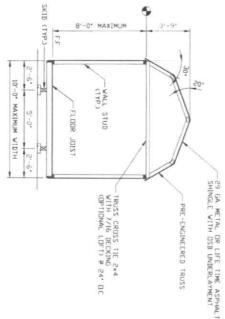

SCALE: 3/16" TYPICAL LOFTED BARN FRAMING SECTION

TYPICAL INTERMEDIATE FRAMING SECTION SCALE: 3/16' - 1'-0'

10'-0" MAXIMUM WIDTH

5--0"

ry -6:

SKID (TYP.) -

4.4

FLOOR JOIST

8'-0' MAXIMUM

CTYPO CTYPO

(TYP)


to »	PINE VIEW	BUILDINGS LLC.
6	933 TC	TIMBER SHED DMLIN MILL RD. VILLE, NC 28625
REV. 1	SCALE: AS NOTED	N&A JUB ND. 20146S
DATE: 5-18-20	DRAWN BY: AT	CHECKED BY: PDH




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NO.	DATE	REV	ISION	BY	CK.	APVD.
0	10-7-19	ISSUED FOR	CONSTRUCTION	LT	PDH	WSM
1	6-15-20	ISSUED FOR	CONSTRUCTION	AT	PDH	WSM





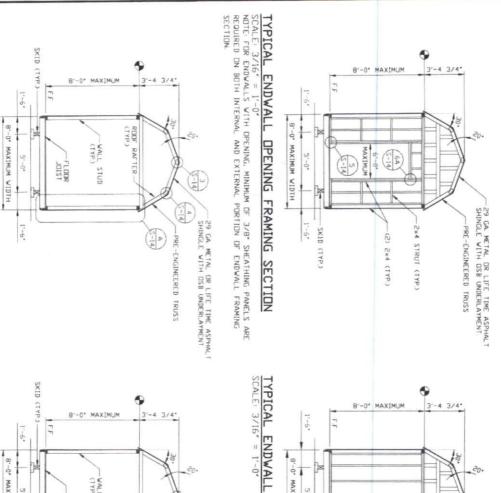

TYPICAL INTERMEDIATE FRAMING SECTION SCALE 3/16' = 1'-0'

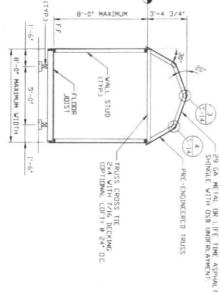SCALE: 3/16"

TYPICAL LOFTED BARN FRAMING SECTION

1	CO E	PINE VIEW	BUILDINGS LLC.
	9	933 TC	TIMBER SHED MILIN MILL RD. VILLE, NC 28625
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8'-0' MAXIMUM

WALL STUD CTYP.)

29 GA METAL DR LIFE TIME ASPHALT SHINGLE WITH DSB UNDERLAYMENT.

PRE-ENGINEERED TRUSS

1.-6.

HTGIN MUMIXAM .0-,8


FRAMING SECTION

5'-0"

1'-6"

SKID CIYPS


	ND.	DATE	REVISION	BY	ск.	APVD.
1	0	10-7-19	ISSUED FOR CONSTRUCTION	LT	PDH	WSM
	1	6-15-20	ISSUED FOR CONSTRUCTION	AT	PDH	WSM

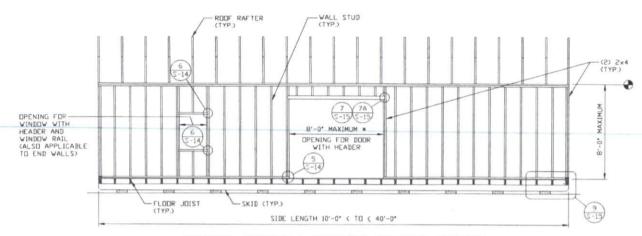

TYPICAL SIDEWALL OPENING FRAMING SECTION

SCALE: 3/16" = 1'-0"

■ 6'-0' DOOR FOR 16'-0' LENGTH

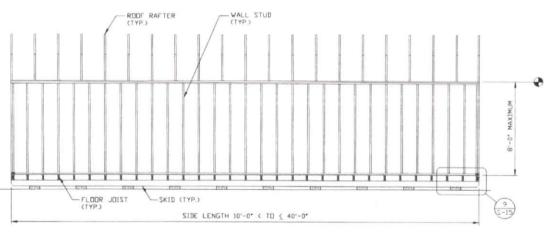

TYPICAL SIDEWALL FRAMING SECTION

SCALE: 3/16" = 1'-0"

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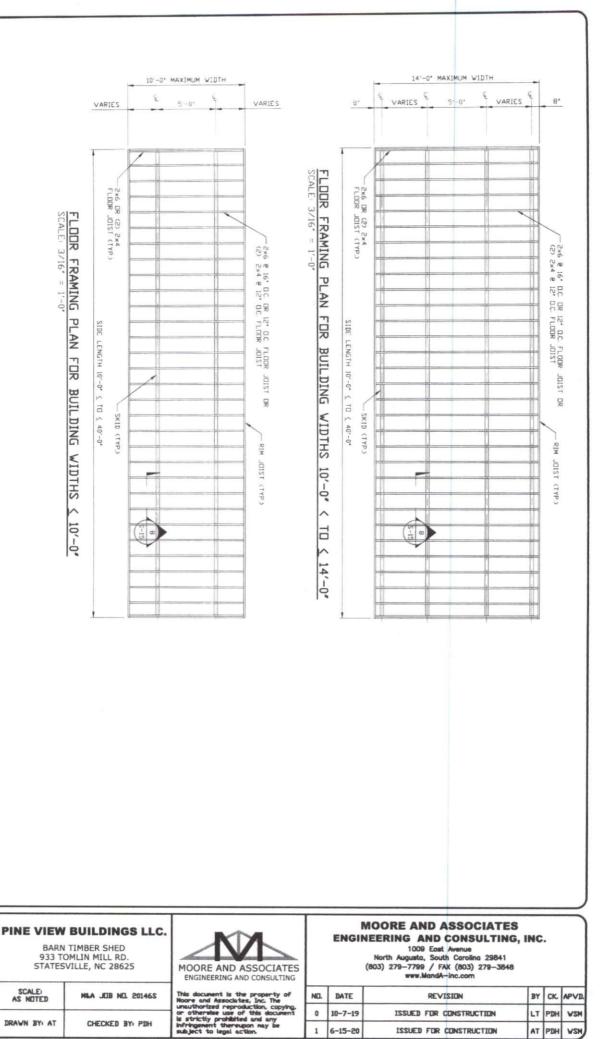
ISSUED FOR CONSTRUCTION
ISSUED FOR CONSTRUCTION

DATE 10-7-19

BARN TIMBER SHED
933 TOMLIN MILL RD.
STATESVILLE, NC 28625
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AS NOTED
OHECKED BY: PDH
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VIEW BUILDINGS

PINE PEV. 1 SCAL S-18-20 DRAVN B



6-15-20

ISSUED FOR CONSTRUCTION

AT PDH


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VARIES VARIES RIDGE SLOPE SLOPE ROOF DECK PLAN LENGTH 10'-0" ≤ TO ≤ 40'-0" DECKING (TYP.)

S-13

PINE VIEW BUILDINGS LLC.

BARN TIMBER SHED 933 TOMLIN MILL RD. STATESVILLE, NC 28625

REV. 1	SCALE) AS NOTED	M&A JOB NO. 20146S
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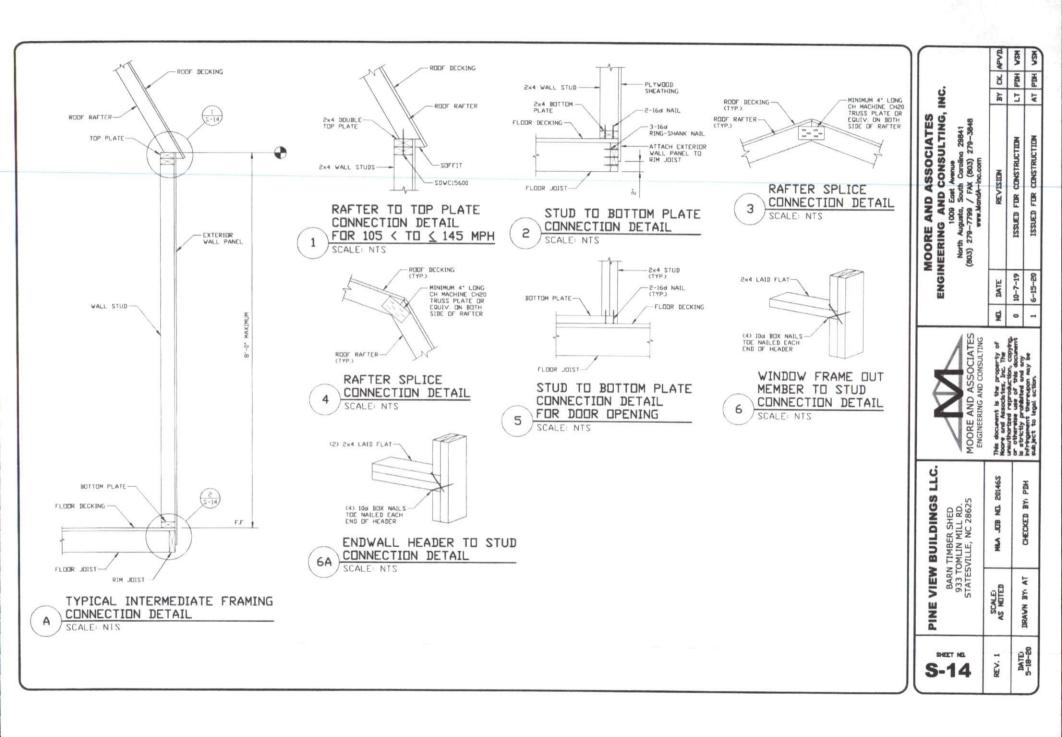


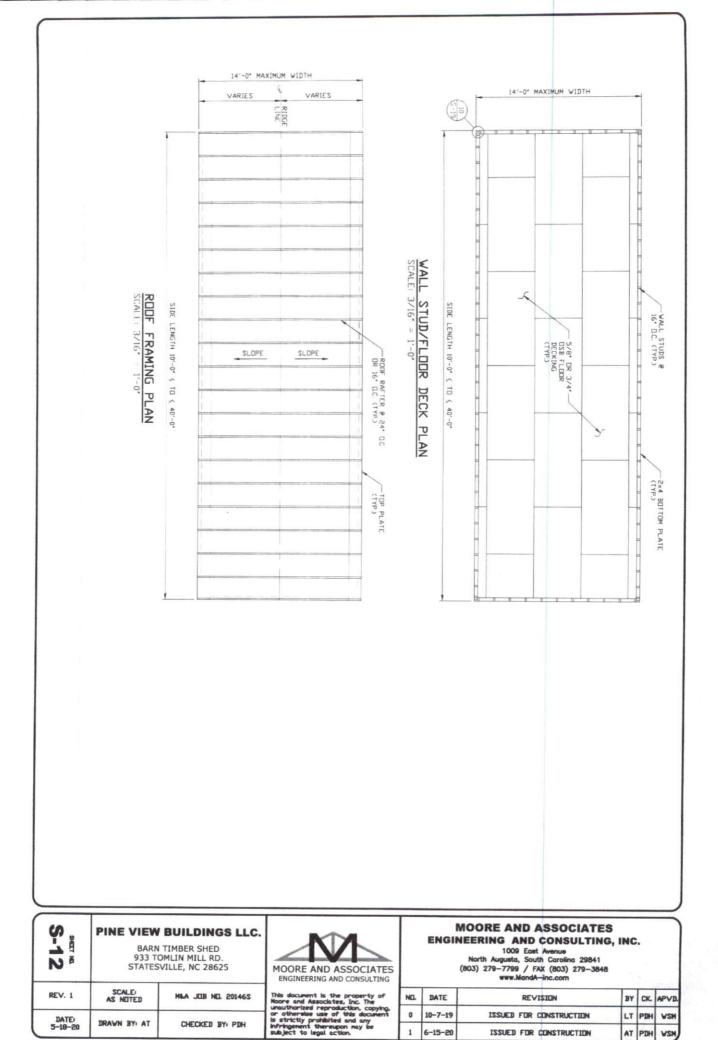
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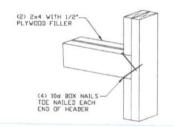
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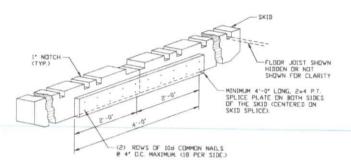





HEADER TO STUD CONNECTION DETAIL FOR SPAN 5'-0" < TO & 8'-0" SCALE: NTS




HEADER TO STUD CONNECTION DETAIL FOR SPAN ≤ 5'-0" SCALE: NTS

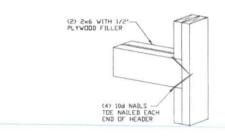

SKID SPLICE CONNECTION DETAIL

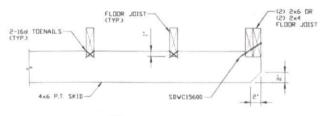

SKID DETAIL SCALE: NTS

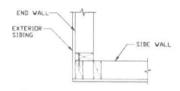

CORNER STUD DETAIL

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BY

REVISION

10-7-19

DATE

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AT 5


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SHEET NO. REV. 1


SCALE AS NOTED DATE 5-18-20

PINE VIEW BUILDINGS LLC. BARN TIMBER SHED 933 TOMLIN MILL RD. STATESVILLE, NC 28625




DOOR ELEVATION FOR 4 FEET SIDE LOFTED

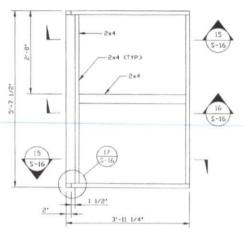SCALE: NTS
NOTE: 3 HIASB-NW HINGES PER DOOR
* DOOR DESIGNED BY OTHERS

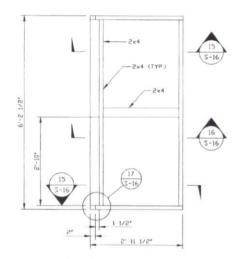


DOOR ELEVATION FOR 3 FEET END LOFTED

SCALE: NTS
NOTE: 3 HIASB-NW HINGES PER DOOR
* DOOR DESIGNED BY OTHERS

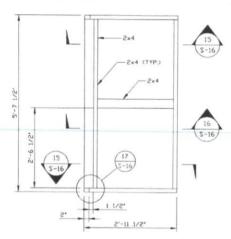


DOOR ELEVATION FOR 3 FEET SIDE LOFTED


SCALE: NTS NDTE: 3 HIASB-NW HINGES PER DOOR * DOOR DESIGNED BY OTHERS

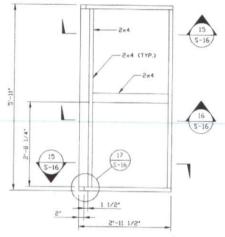


DOOR ELEVATION FOR 3 FEET END LOFTED

SCALE: NTS NOTE: 3 HIASB-NW HINGES PER DOOR * DOOR DESIGNED BY OTHERS

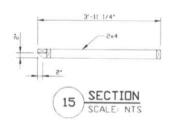


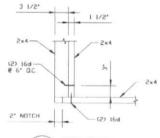



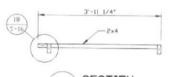

16 SECTION

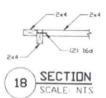

PINE VIEW BUILDINGS LLC BARN TIMBER SHED 933 TOMLIN MILL RD. STATESVILLE, NC 28625
PINE

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BARN 933 TC STATES	SCALE, AS NOTED	DRAWN BY: AT
-16	REV. 1	DATE 5-18-20

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DATE 10-7-19

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