


- PLAN SYMBOLS**
- ⬠ WINDOW TAG
  - Ⓛ DOOR TAG
  - ⬠ WALL TAG
  - ▭ EX. WALLS
  - ▬ NEW WALLS

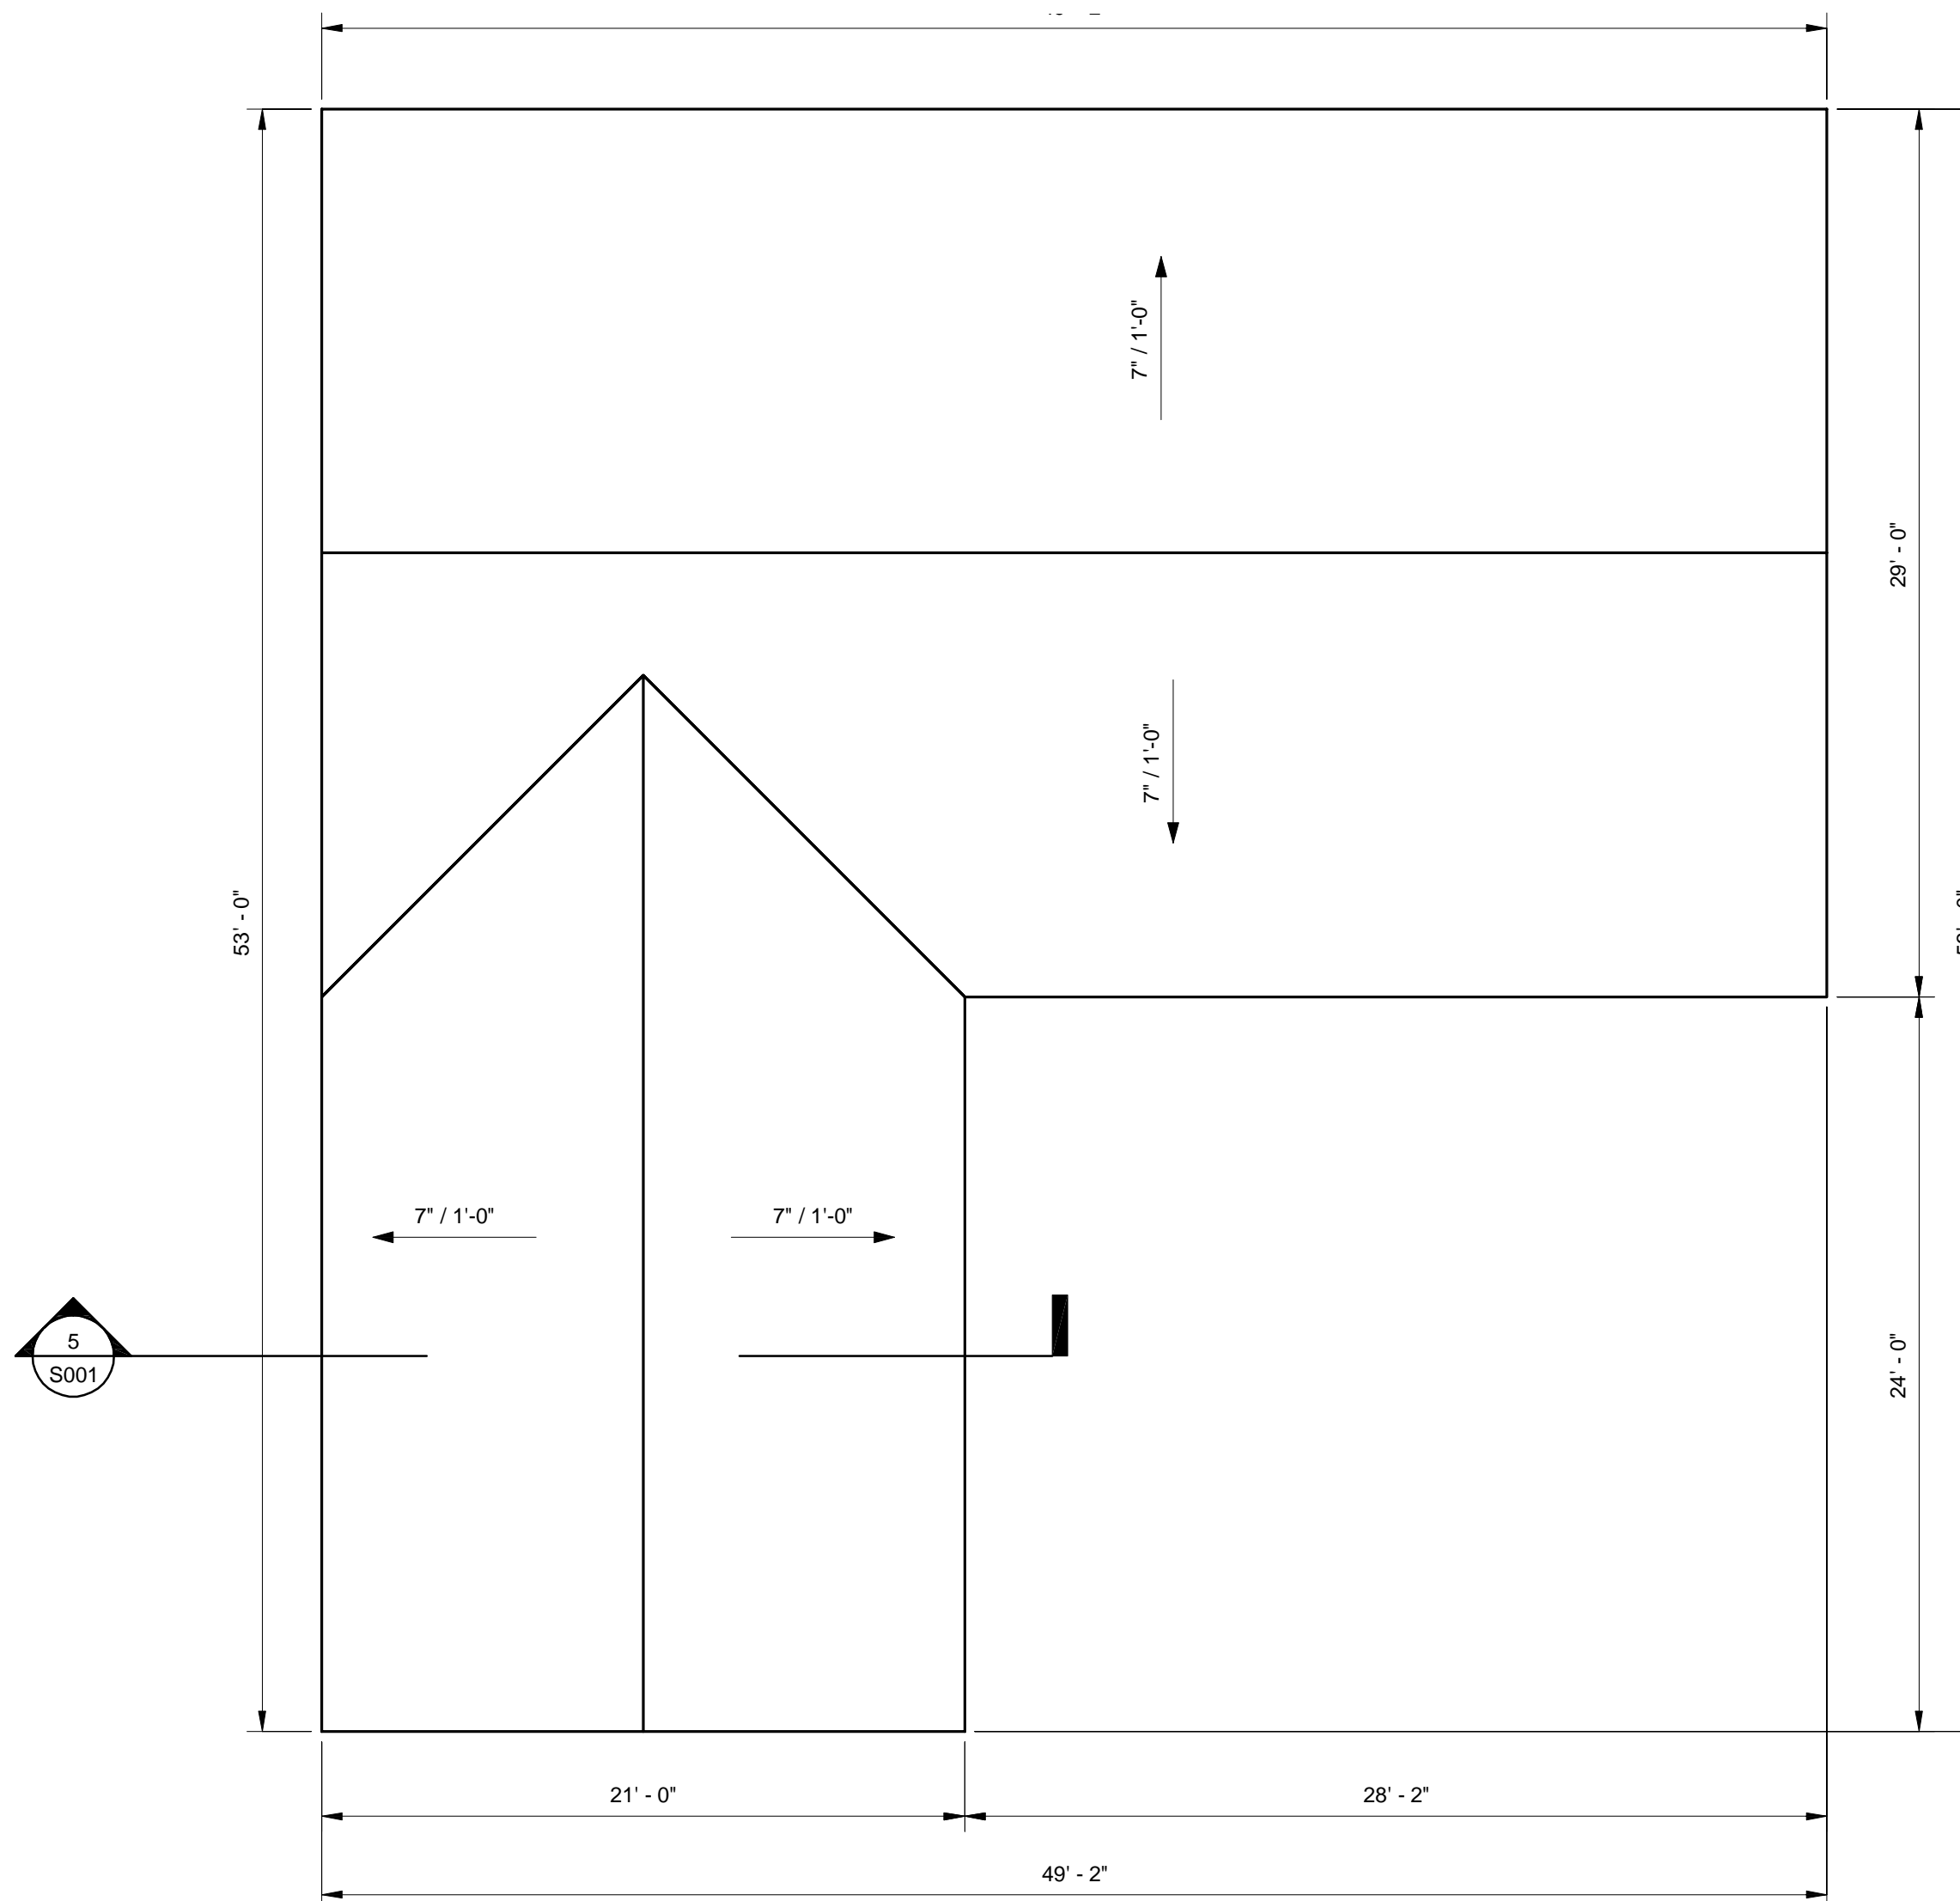


**FIRST FLOOR PLAN**  
 3/16" = 1'-0"

**ROOF PLAN**  
 3/16" = 1'-0"

ROOM SCHEDULE		
Number	Name	Net Area
18D	PROPOSED BEDROOM	480 SF
1ST FLOOR (HEATED AREA TO BE ADDED)		480 SF

WINDOW SCHEDULE									
MARK	TYPE	HEIGHT	WIDTH	AREA	U VALUE	SHGC	COUNT	REMARKS	
1	SINGLE HUNG	4'-0"	3'-0"	12 SF	0.35	0.25	4	NEW	

DOOR SCHEDULE										
MARK	TYPE	WIDTH	HEIGHT	THICKNESS	AREA	U-VALUE	SHGC	COUNT	HARDWARE	REMARKS
1	EXTERIOR SINGLE DOOR	3'-0"	7'-0"	0'-2"	21 SF	0.35	0.25	1	LOCKED	NEW
2	EXTERIOR SLIDING 2 PANEL DOOR	5'-0"	7'-0"		35 SF	0.35	0.25	1	LOCKED	NEW
3	SINGLE DOOR	3'-0"	7'-0"	0'-2"	21 SF			1	LOCKED	NEW

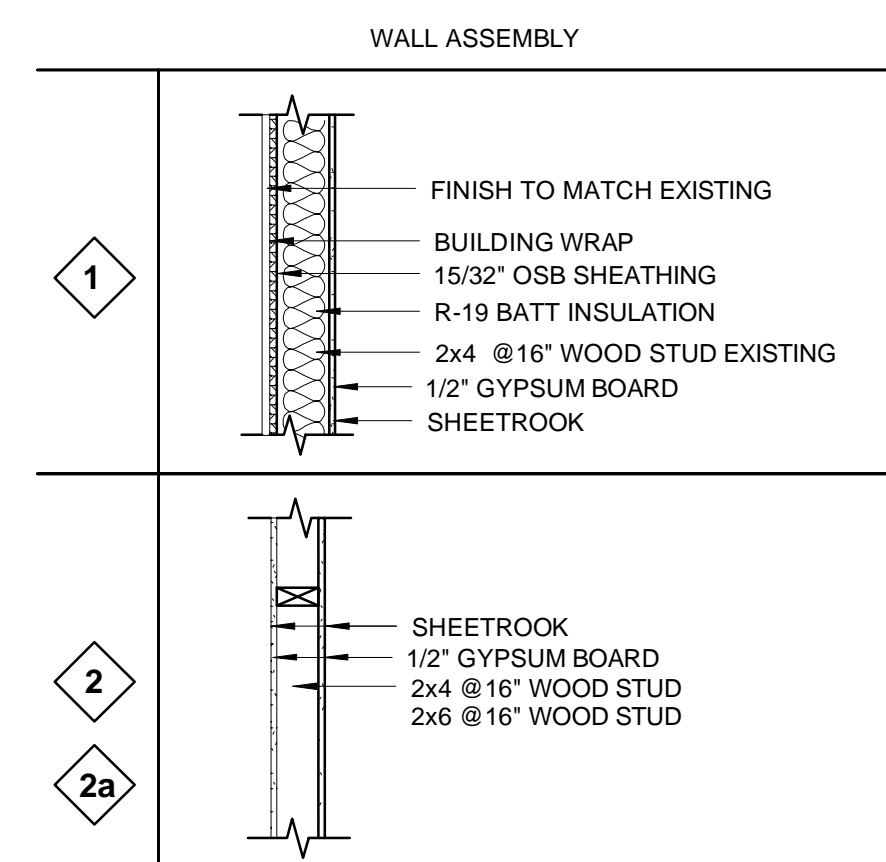

\\272MadisonLn,Cameron,NCRev2-egreeswindows1-3355828.jpg

\\272MadisonLn,Cameron,NCRev2-egreeswindows2-3355830.jpg

NO.	DATE	DESCRIPTIONS
000	01/24/2021	Permit Submittal


**PLANS FLOOR & ROOF**  
**SINGLE FAMILY HOUSE**  
 272 Madison Ln  
 Cameron, NC, 28326




**EQUAGEN® ENGINEERS**  
 FIRM LIC. # 1869  
 121 EDINBURGH SOUTH DR., STE 103  
 CARY, NC 27511  
 PHONE: 919.444.5442  
 EMAIL: MOTI.KC@EQUAGEN.COM

DRAWN BY:	DK
CHECKED BY:	MKC
DATE:	01/24/2021
SCALE:	AS SHOWN


A002 21-2005

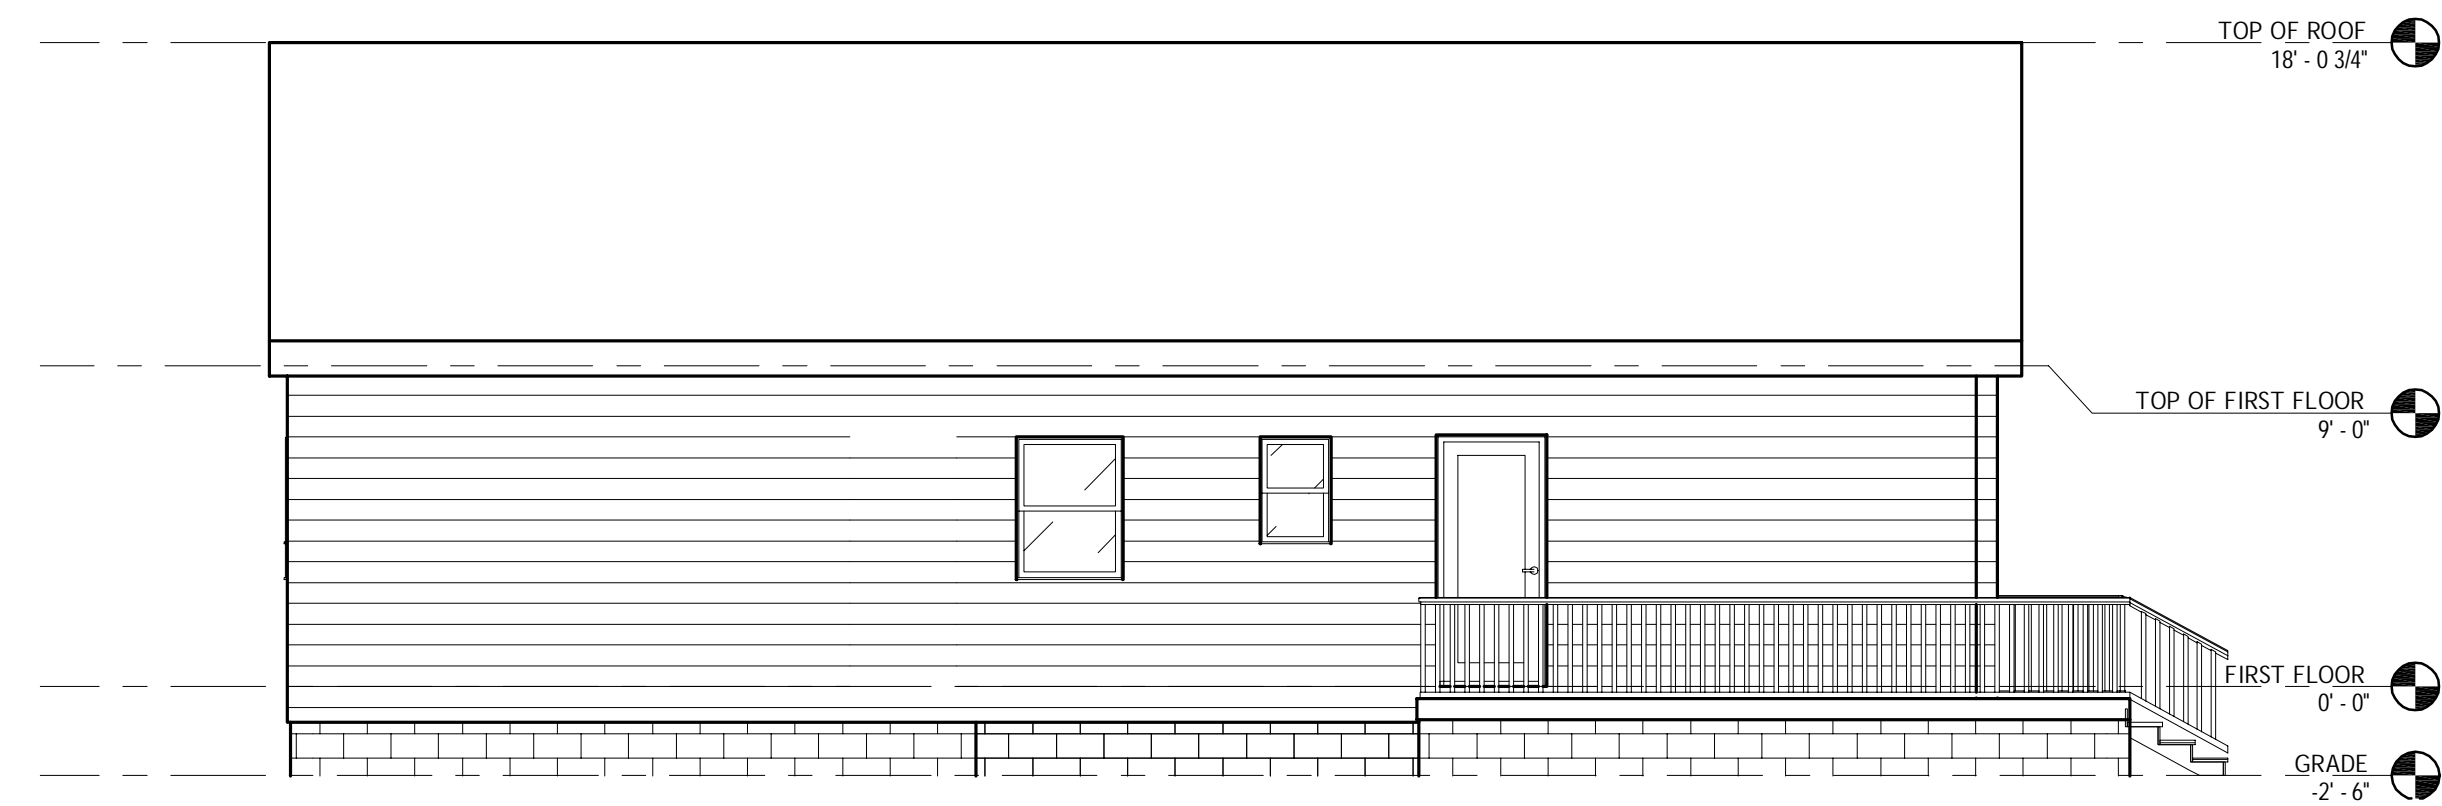


EXISTING SOUTH ELEVATION  
3/16" = 1'-0"

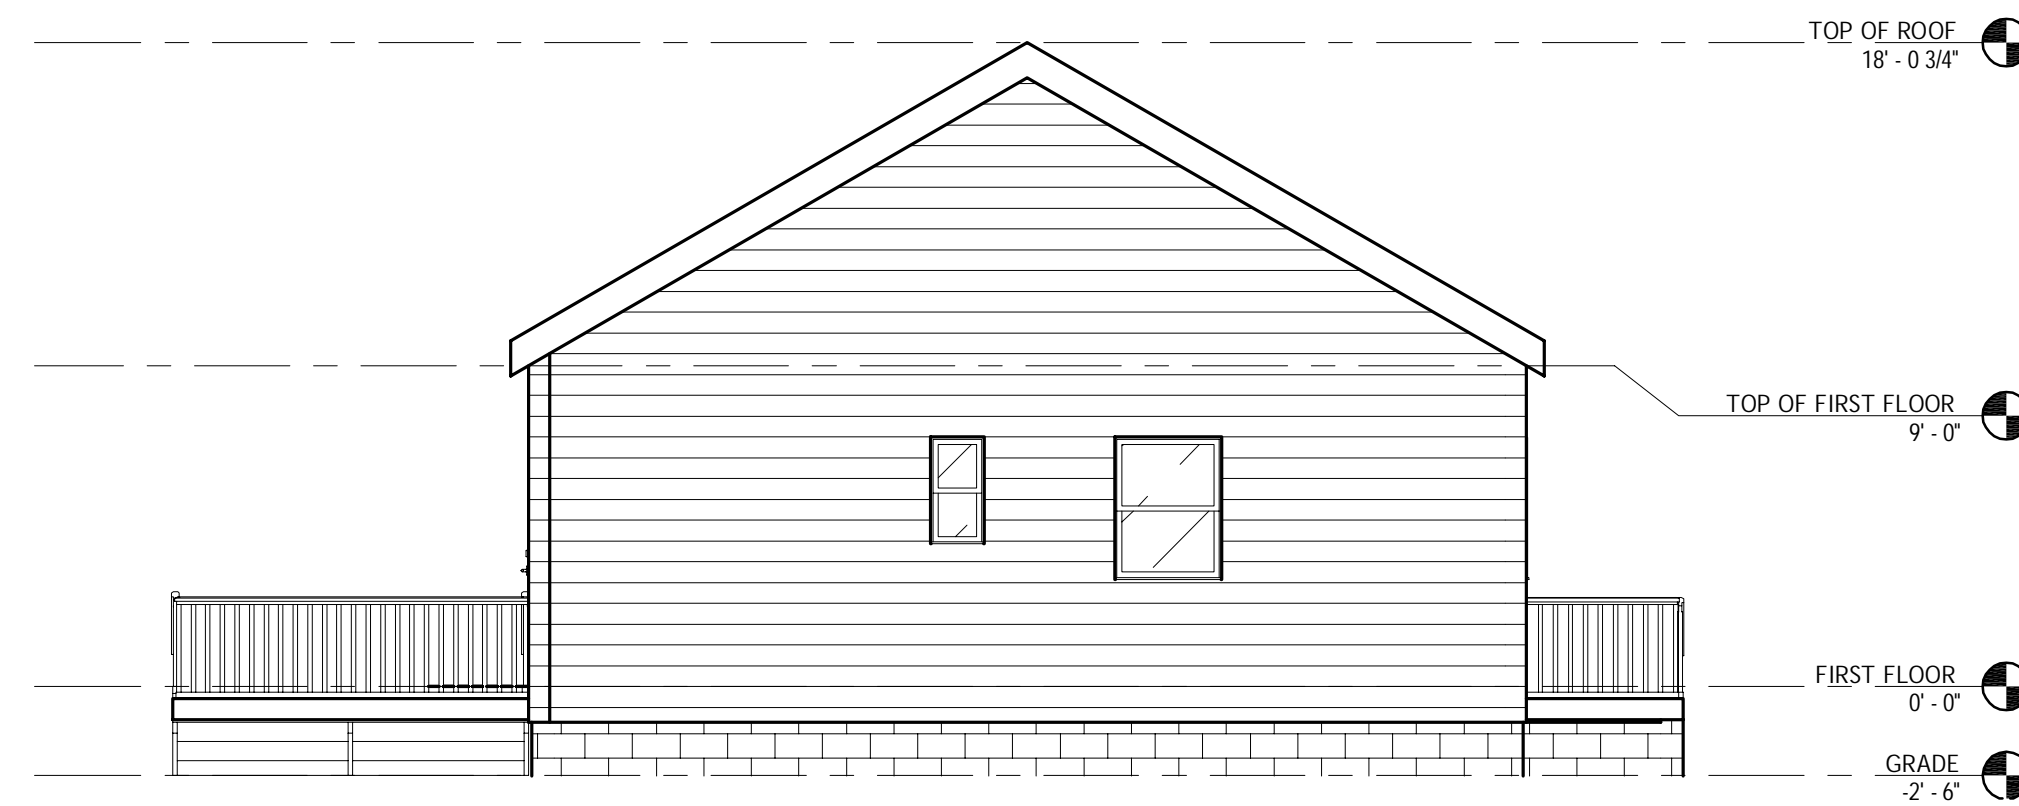


EXISTING WEST ELEVATION  
3/16" = 1'-0"

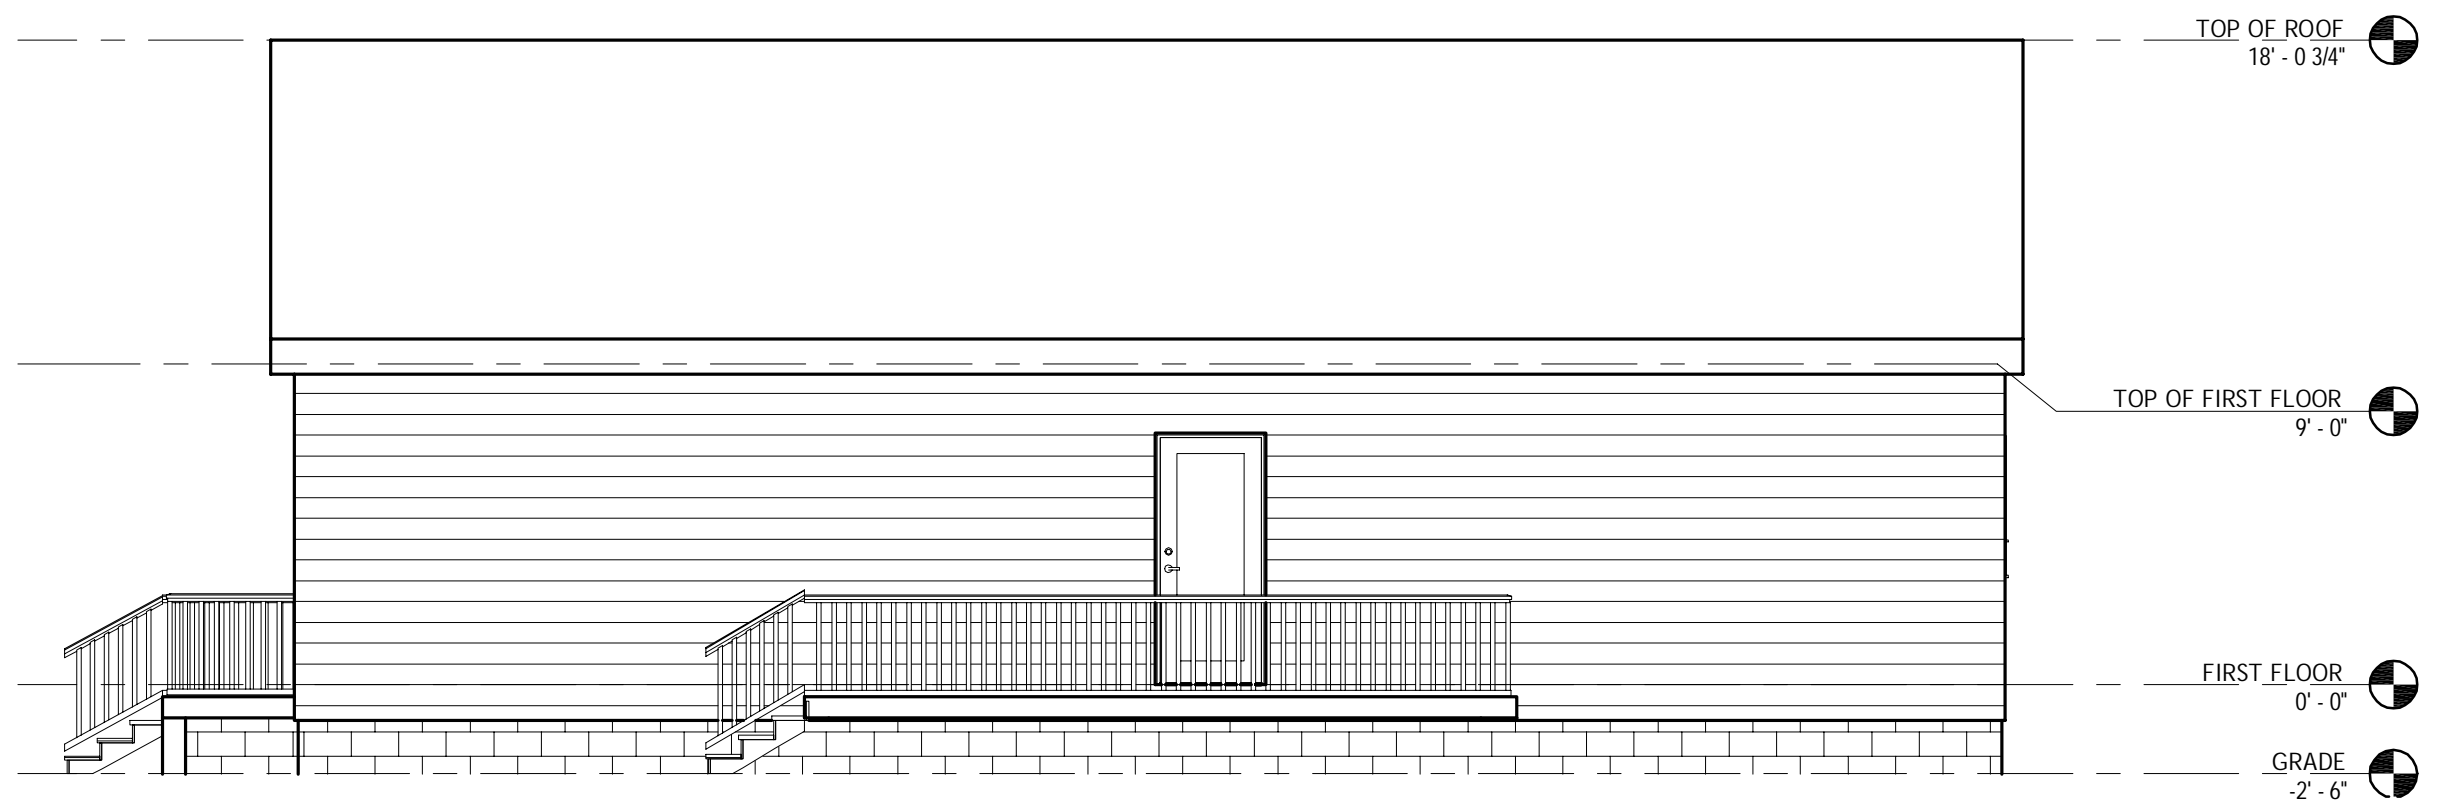


EXISTING NORTH ELEVATION  
3/16" = 1'-0"

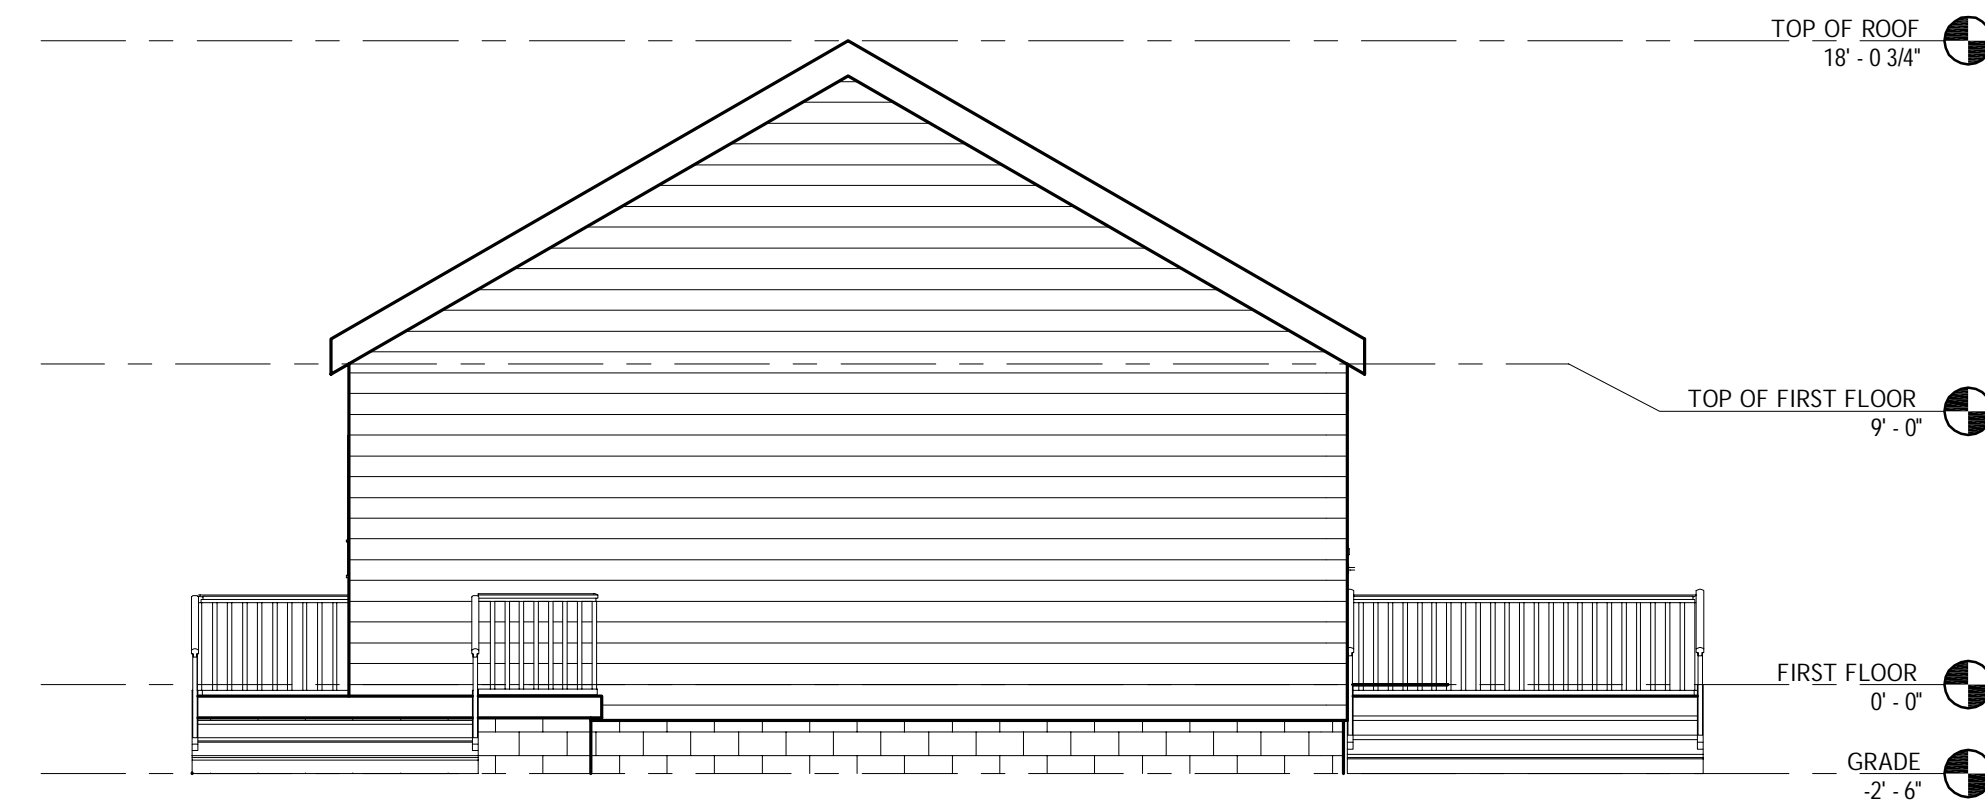


EXISTING EAST ELEVATION  
3/16" = 1'-0"

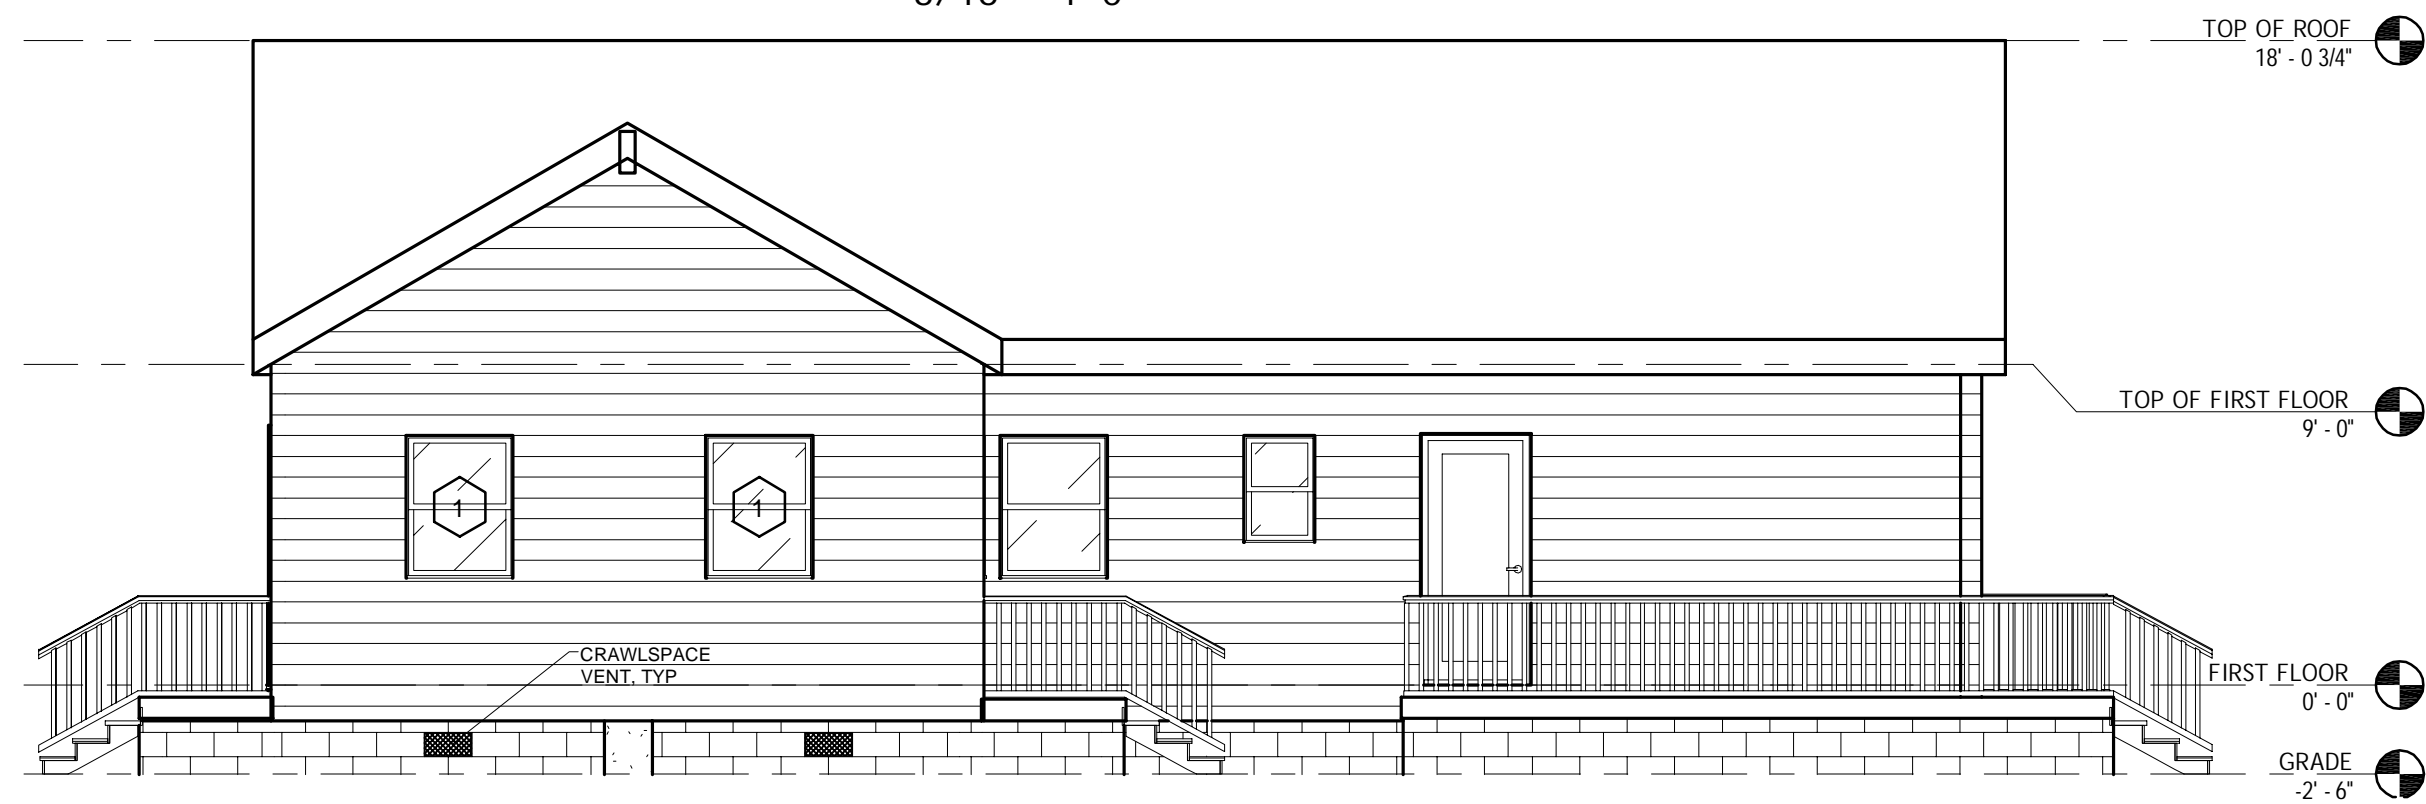


PROPOSED SOUTH ELEVATION  
3/16" = 1'-0"

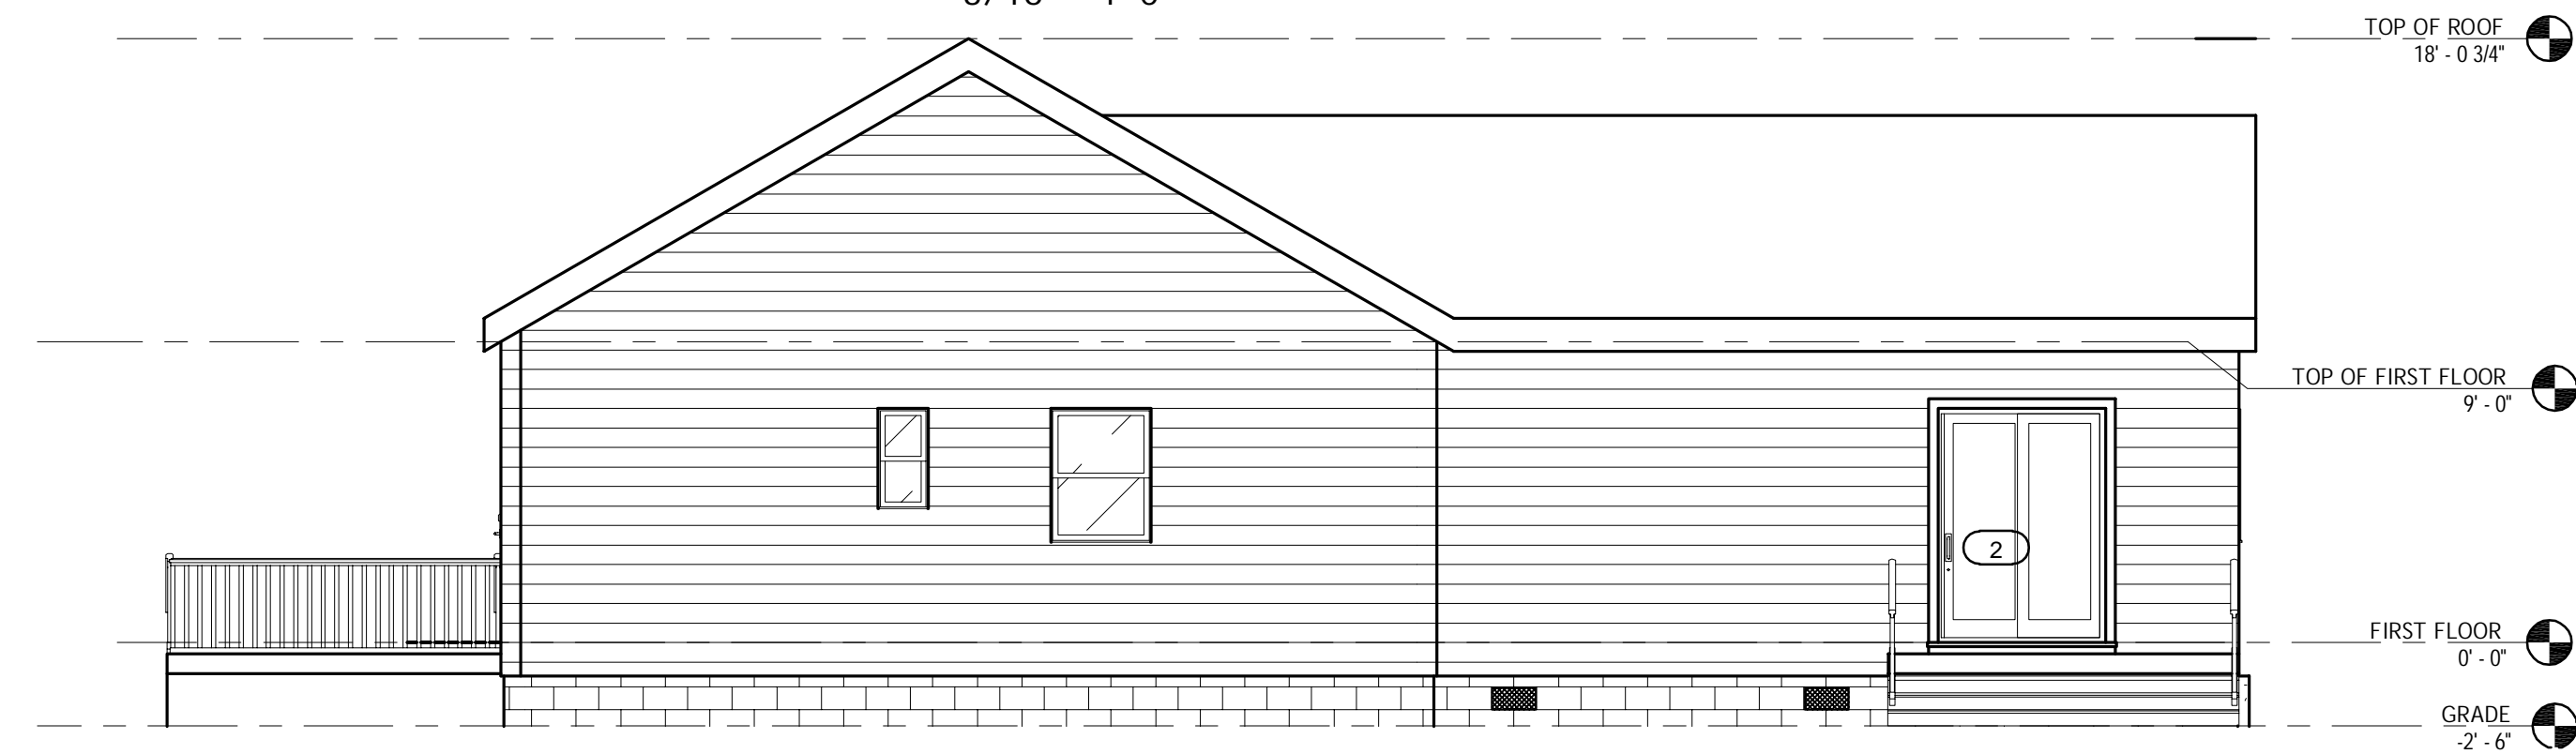

PROPOSED WEST ELEVATION  
3/16" = 1'-0"

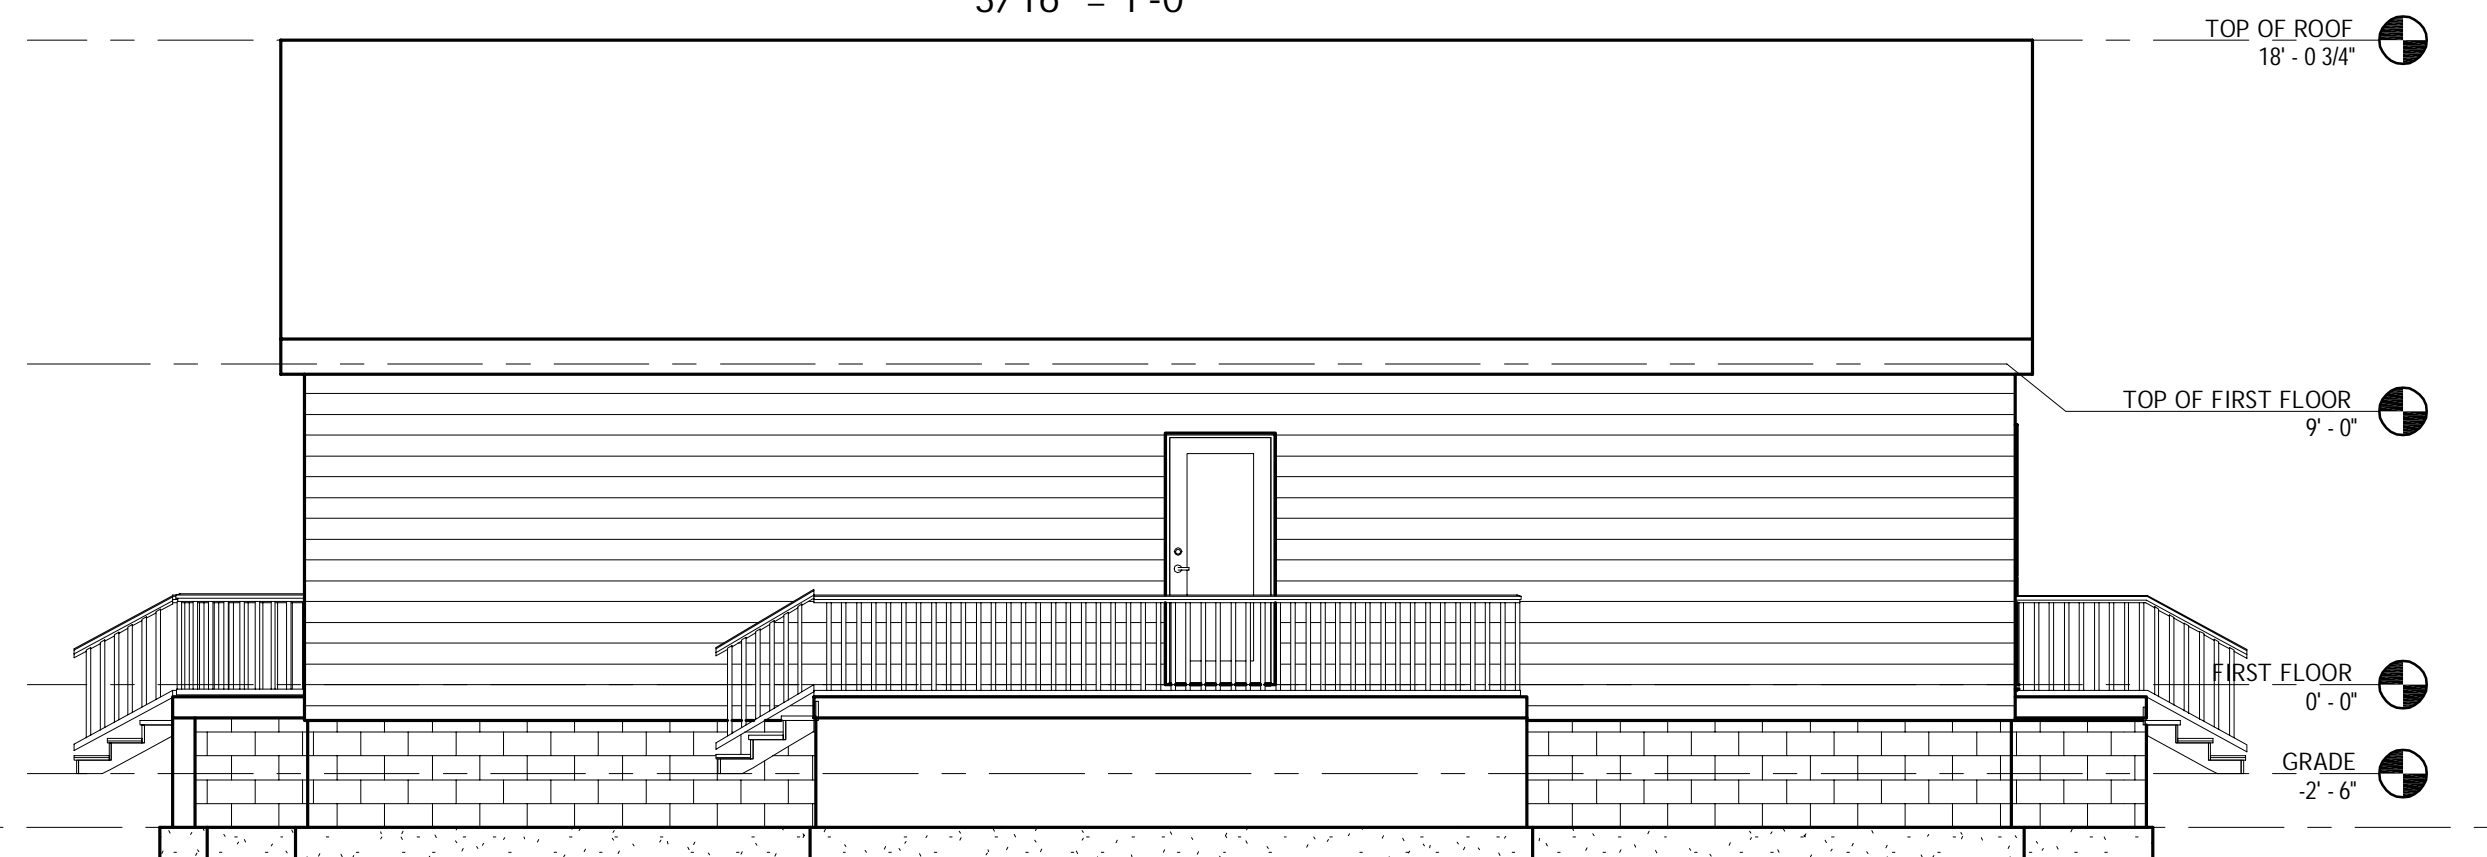

PROPOSED NORTH ELEVATION  
3/16" = 1'-0"

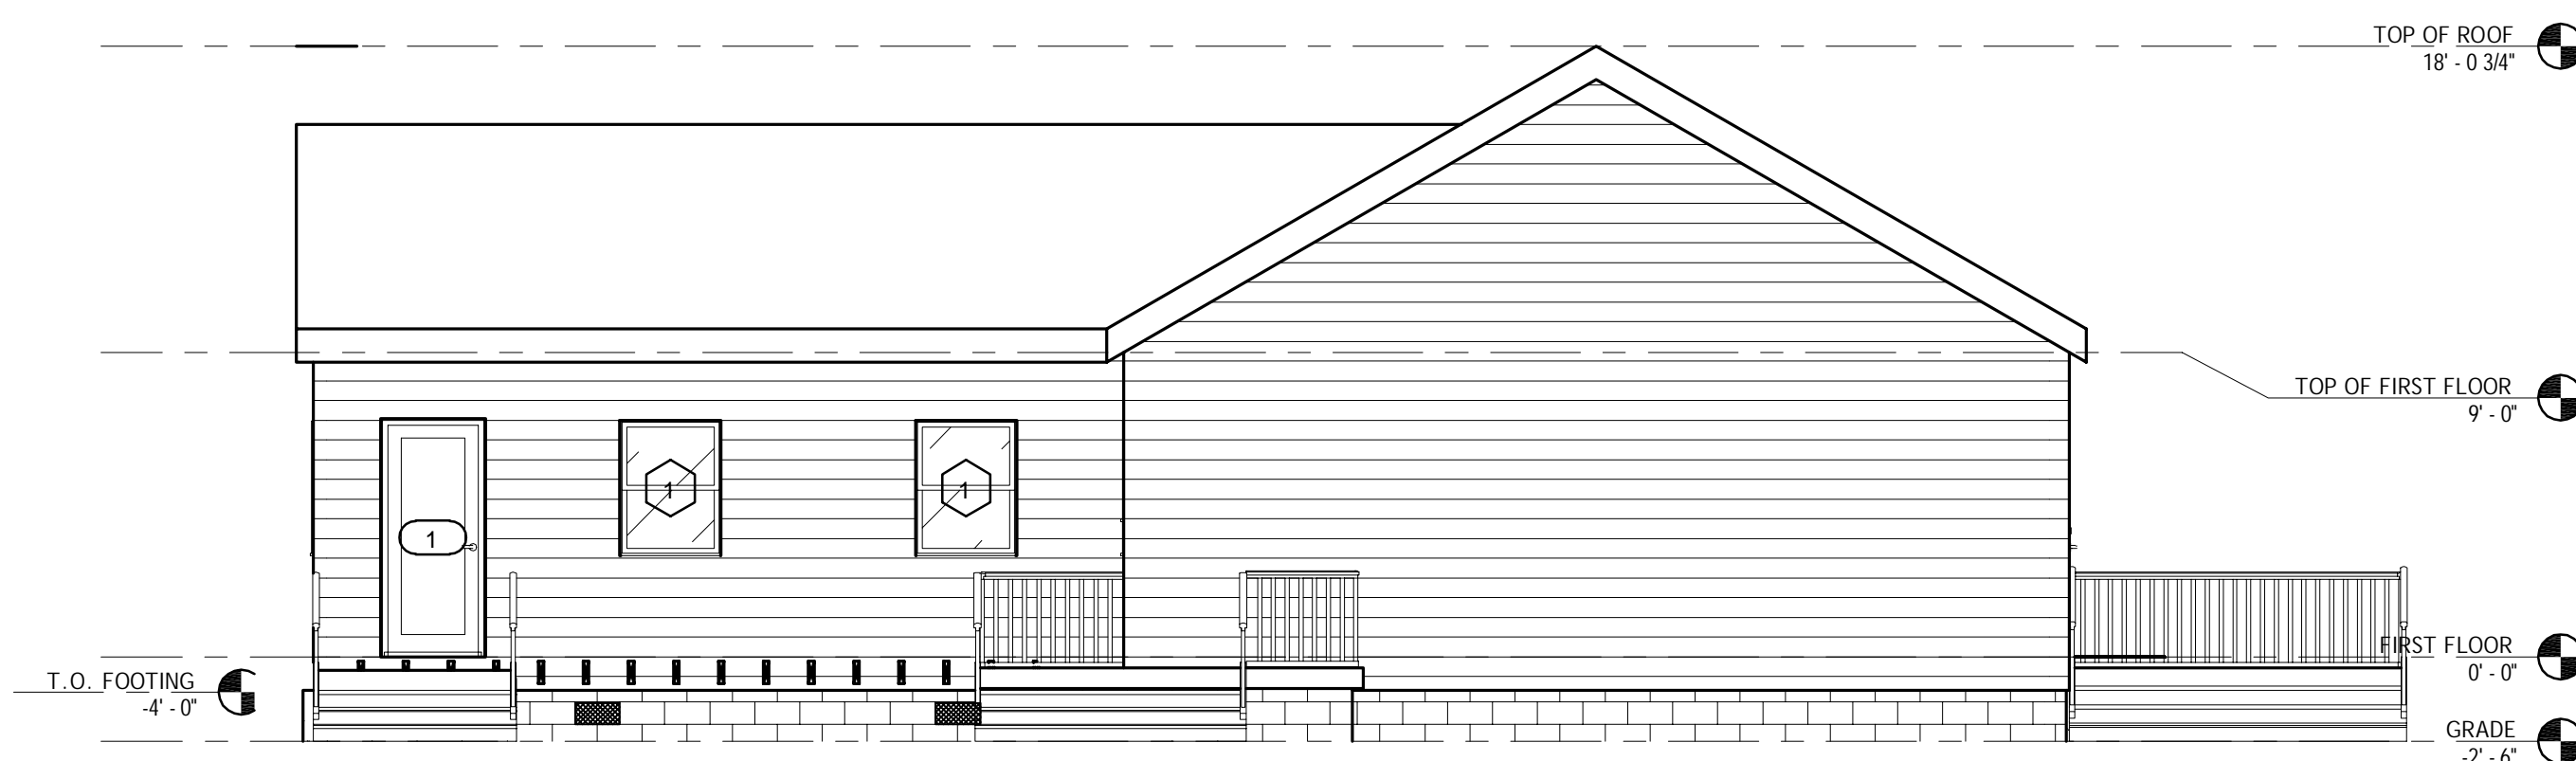

PROPOSED EAST ELEVATION  
3/16" = 1'-0"

ELEVATIONS

SINGLE FAMILY HOUSE  
272 Madison Ln  
Cameron, NC, 28326








**EQUAGEN®**  
ENGINEERS  
FIRM LIC. # 1869  
121 EDINBURGH SOUTH DR., STE 103  
CARY, NC 27511  
PHONE: 919.444.5442  
EMAIL: MOTI.KC@EQUAGEN.COM

DRAWN BY:	DK
CHECKED BY:	MKC
DATE:	01/24/2021
SCALE:	AS SHOWN

A003 21-2005

NO.	DATE	DESCRIPTION	REVISIONS
000	01/24/2021	Permit Submittal	

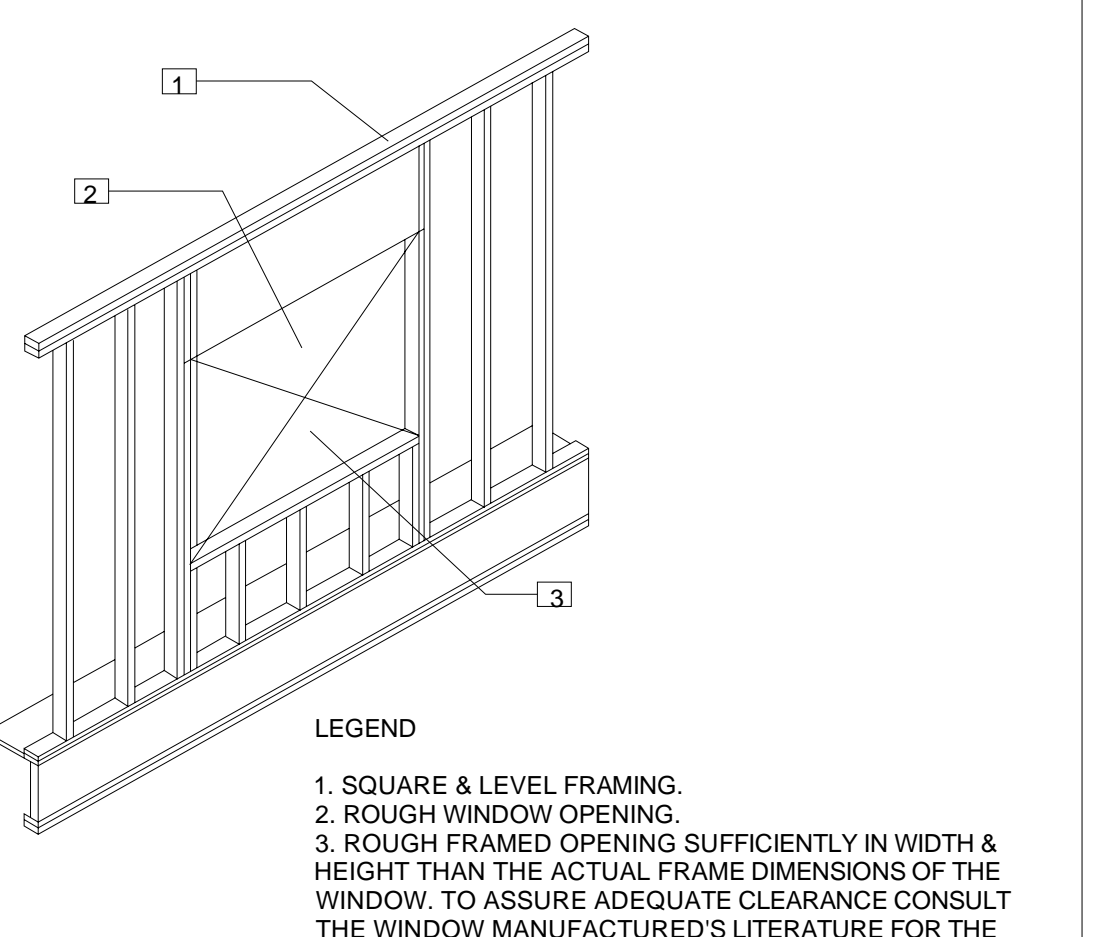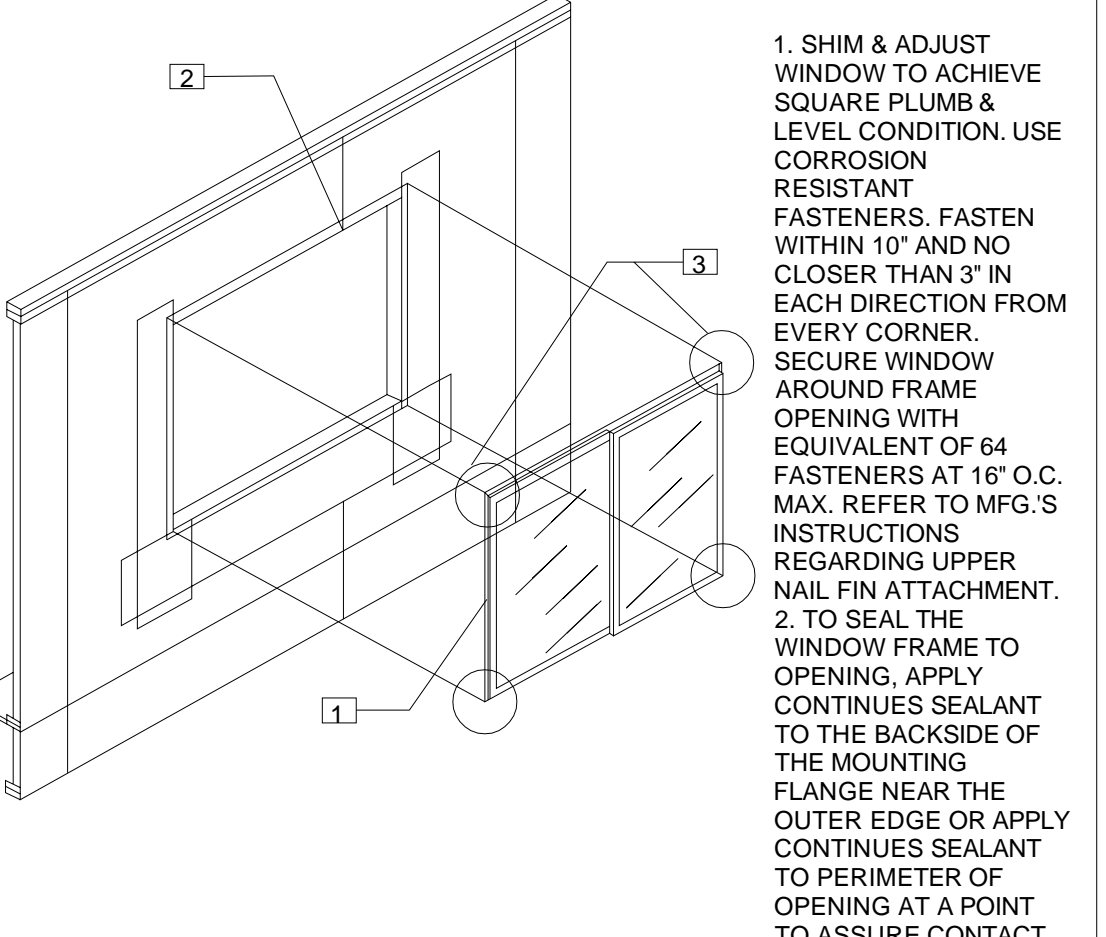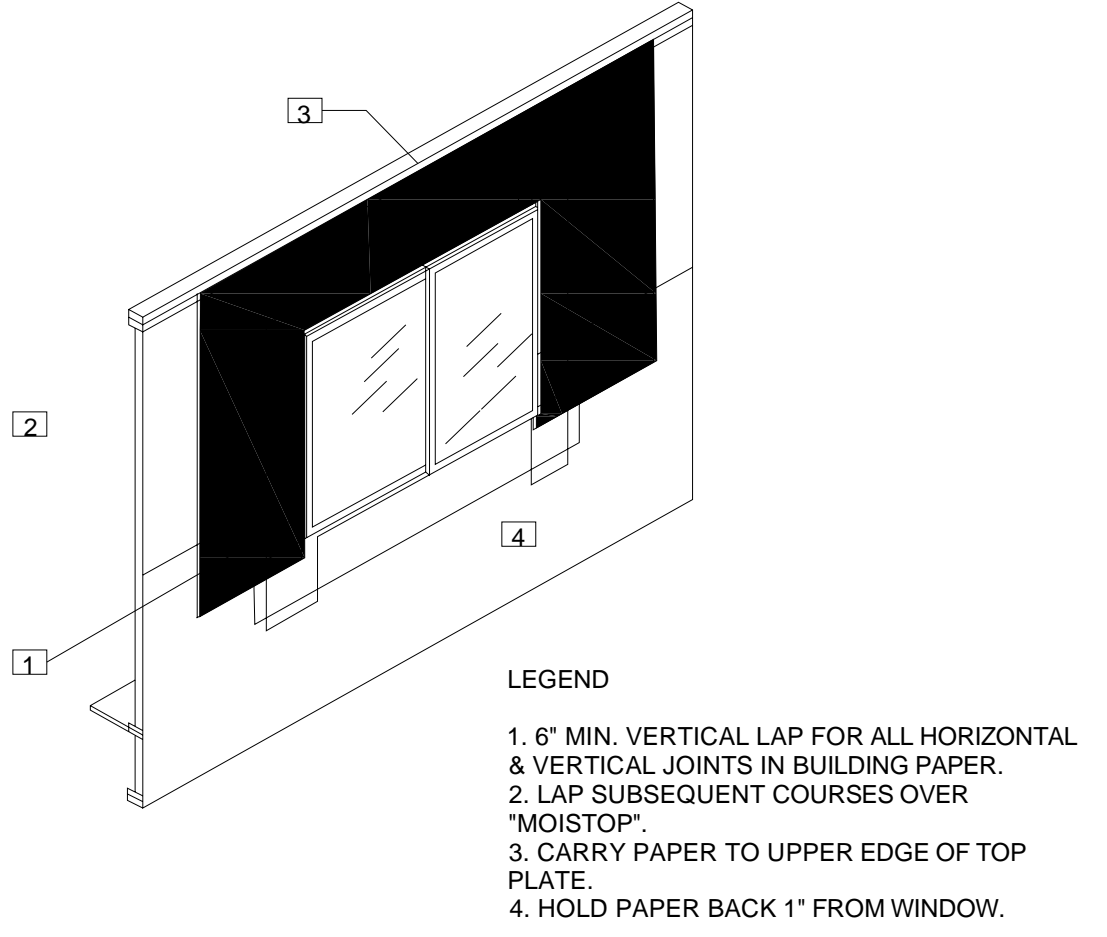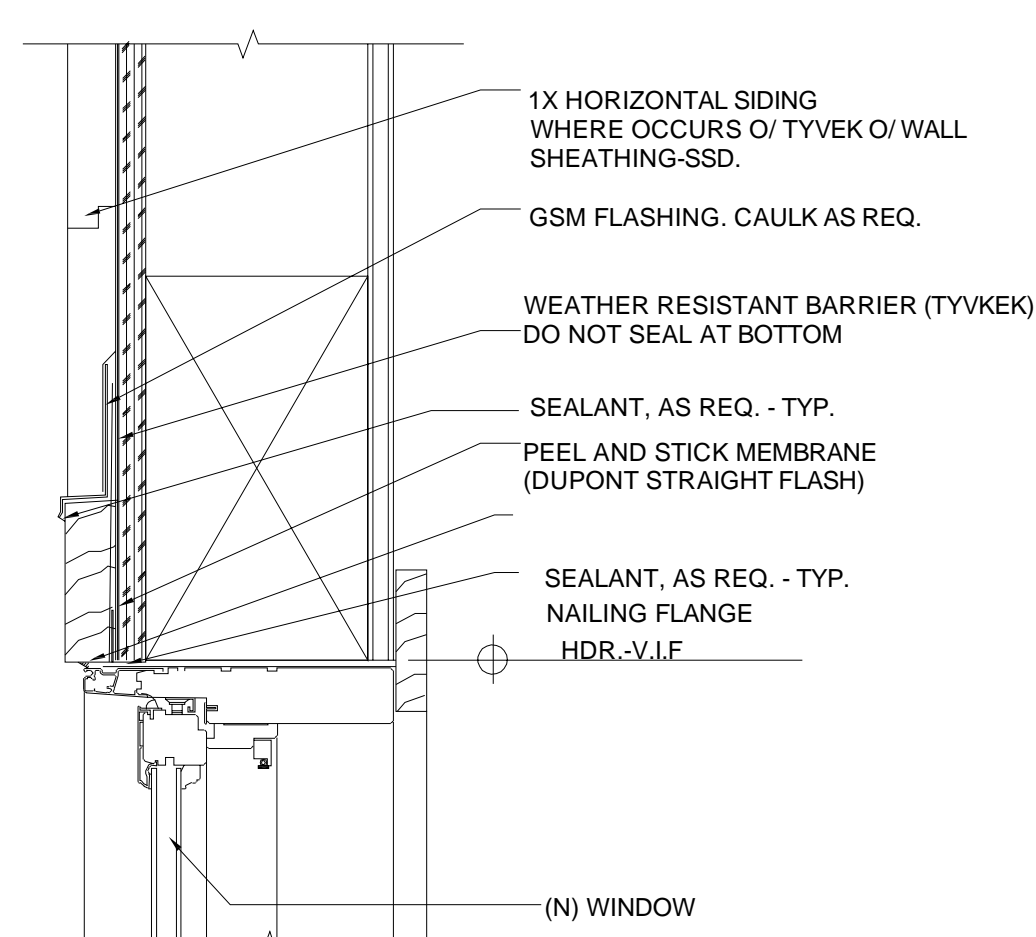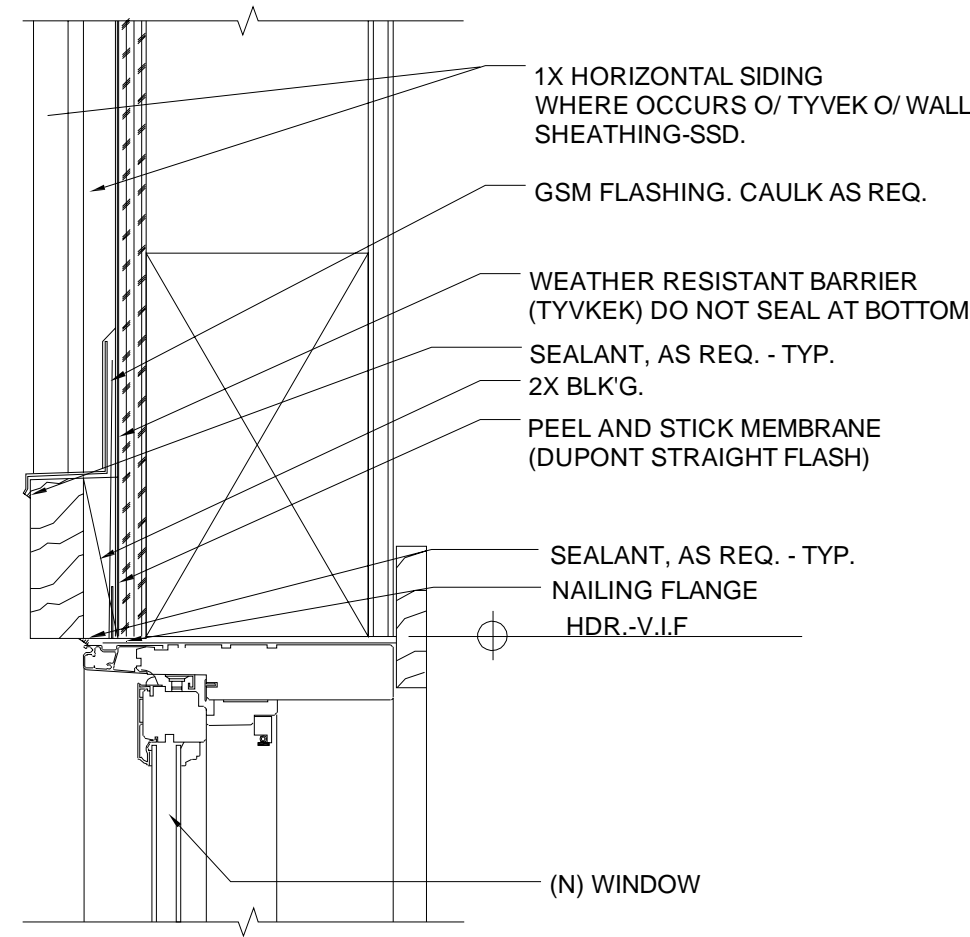






WINDOW HEAD @ WD. BOARD & BATTEN SIDING 12

WINDOW HEAD @ HORIZONTAL SIDING 9

BUILDING PAPER-SECOND COURSE 7

WINDOW INSTALLATION 4

ROUGH WINDOW OPENING 1

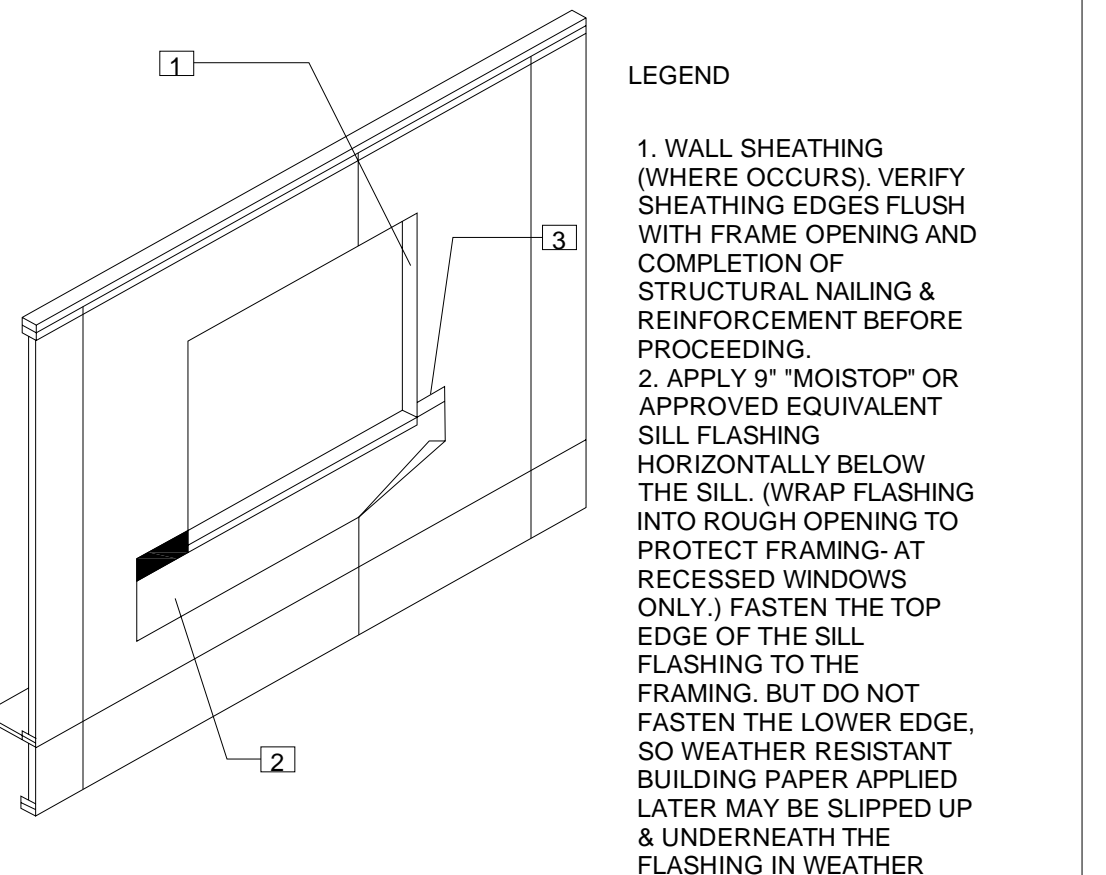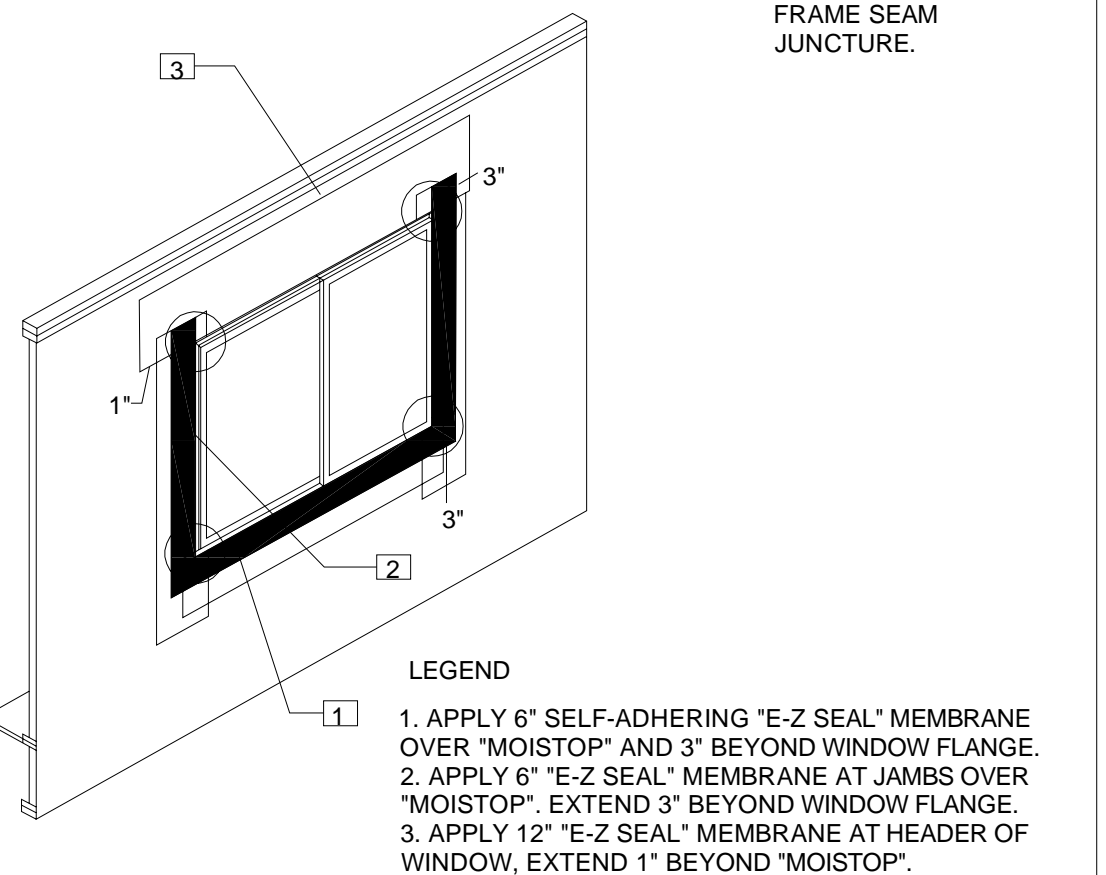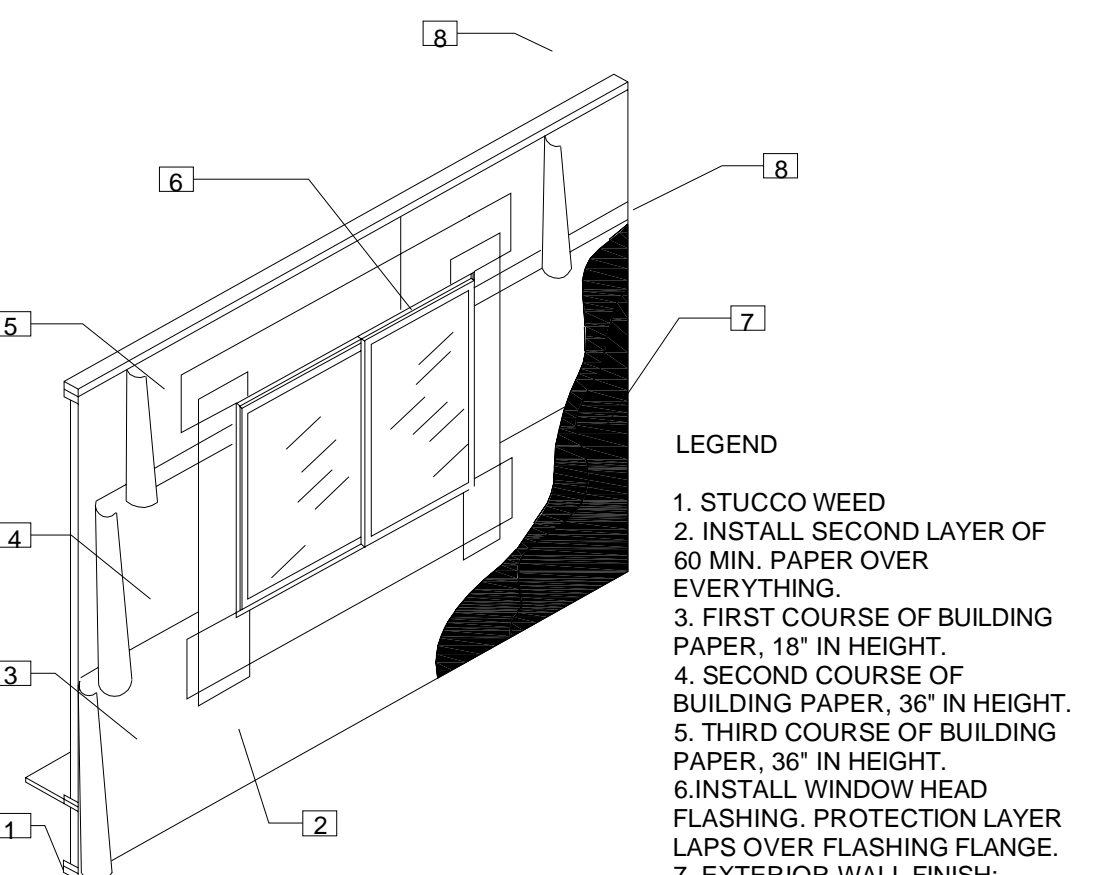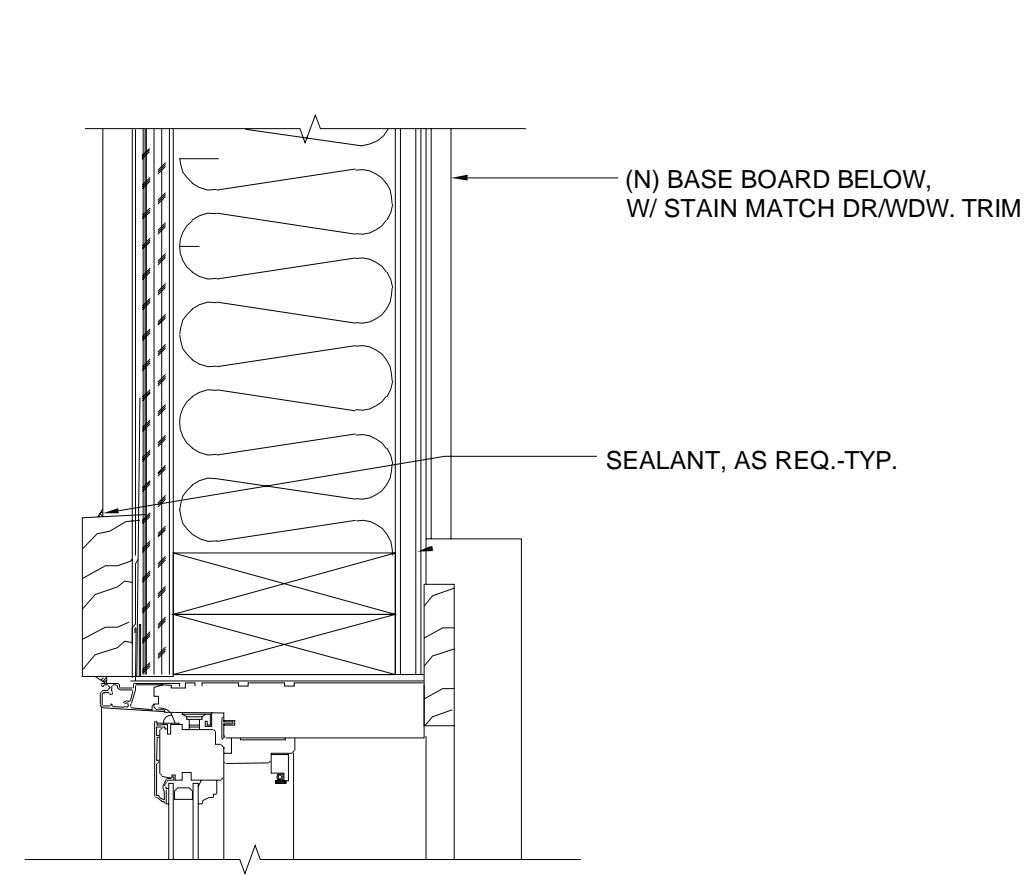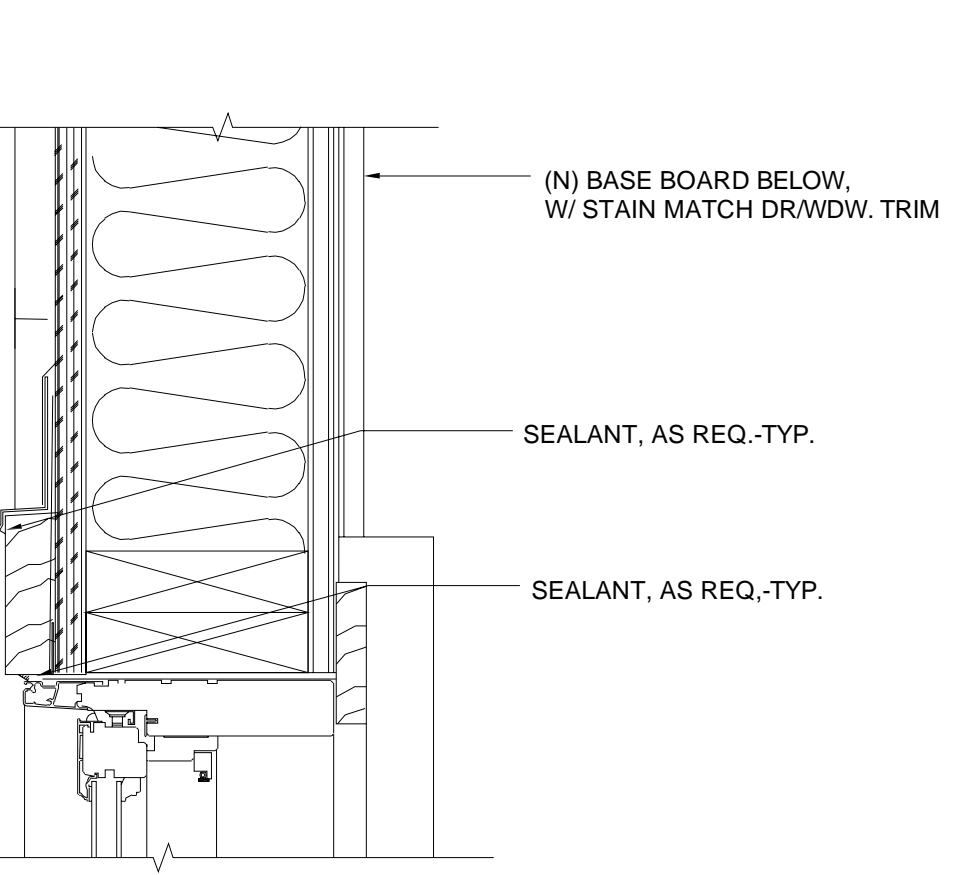






WINDOW JAMB @ WD. BOARD & BATTEN SIDING 13

WINDOW JAMB @ HORIZONTAL SIDING 10

TRIM-FLASHING-PROTECTION COURSE 8

SELF-ADHESIVE MEMBRANE 5

SILL FLASHING 2

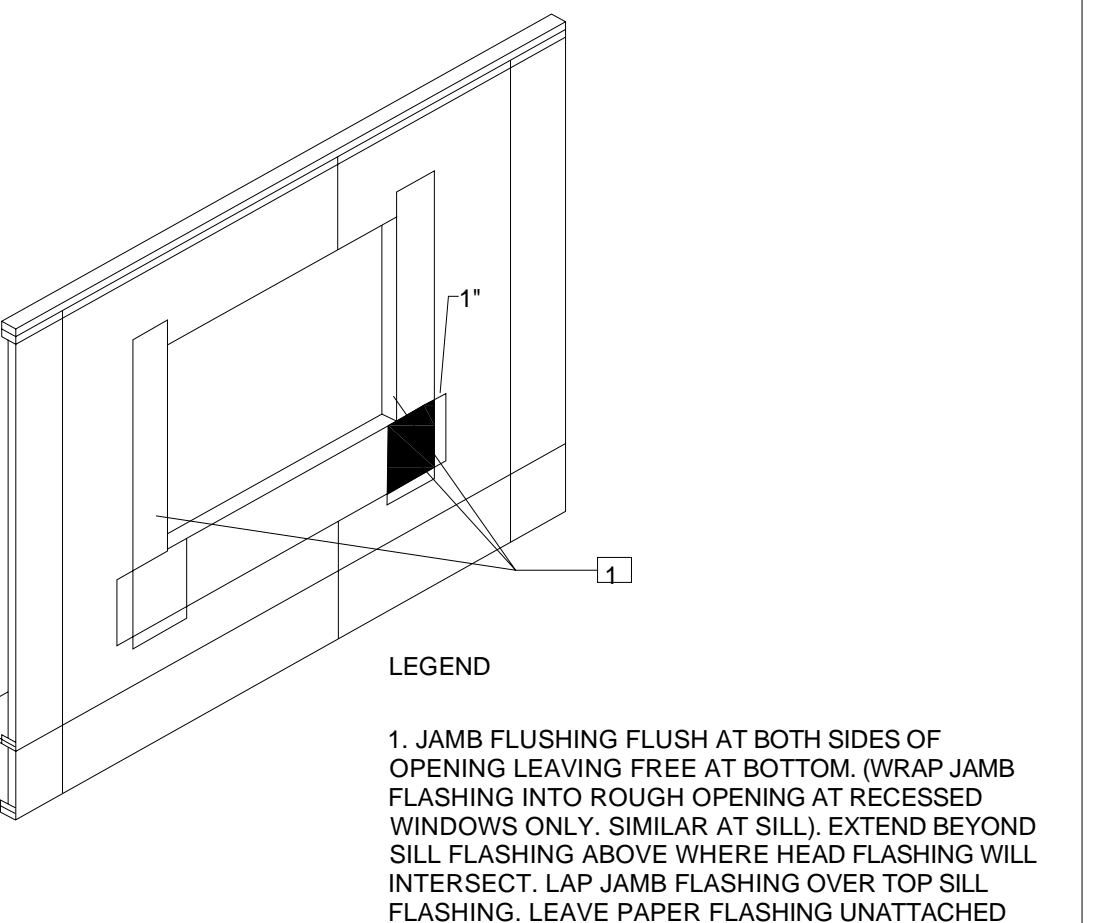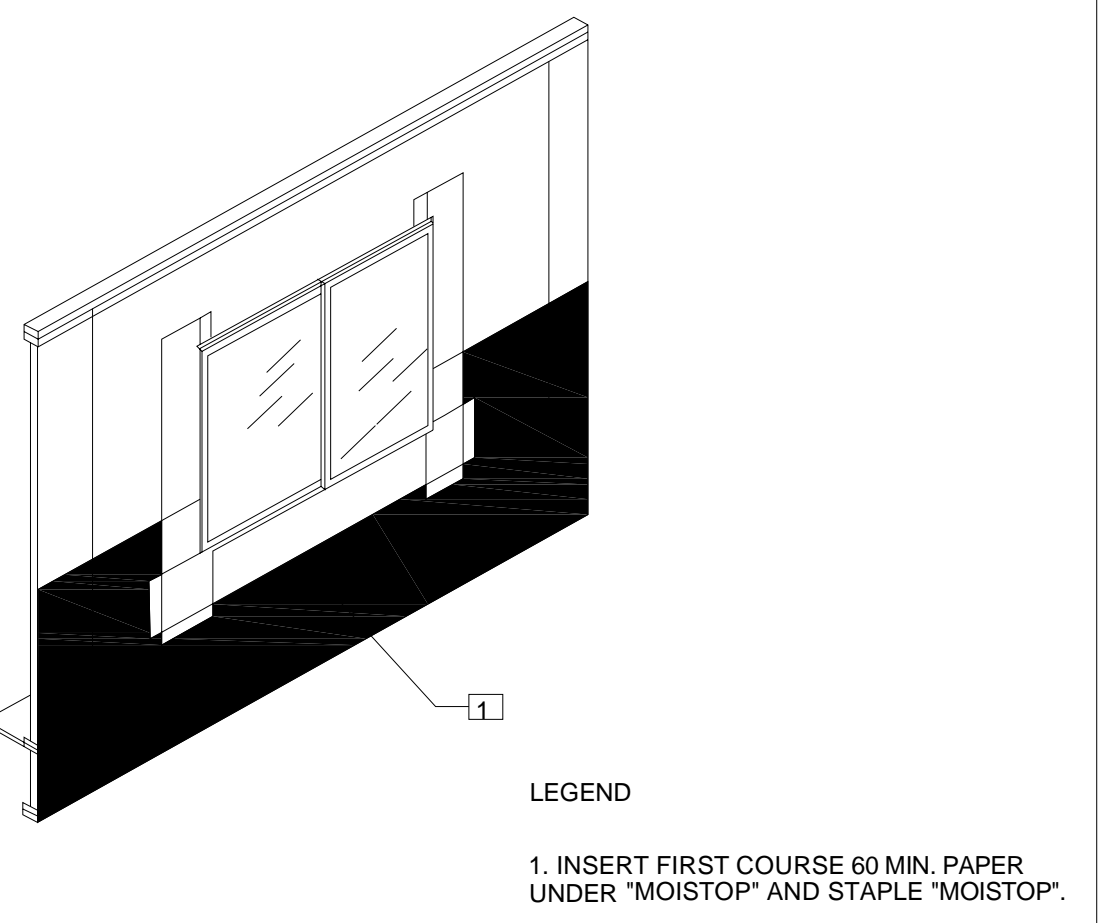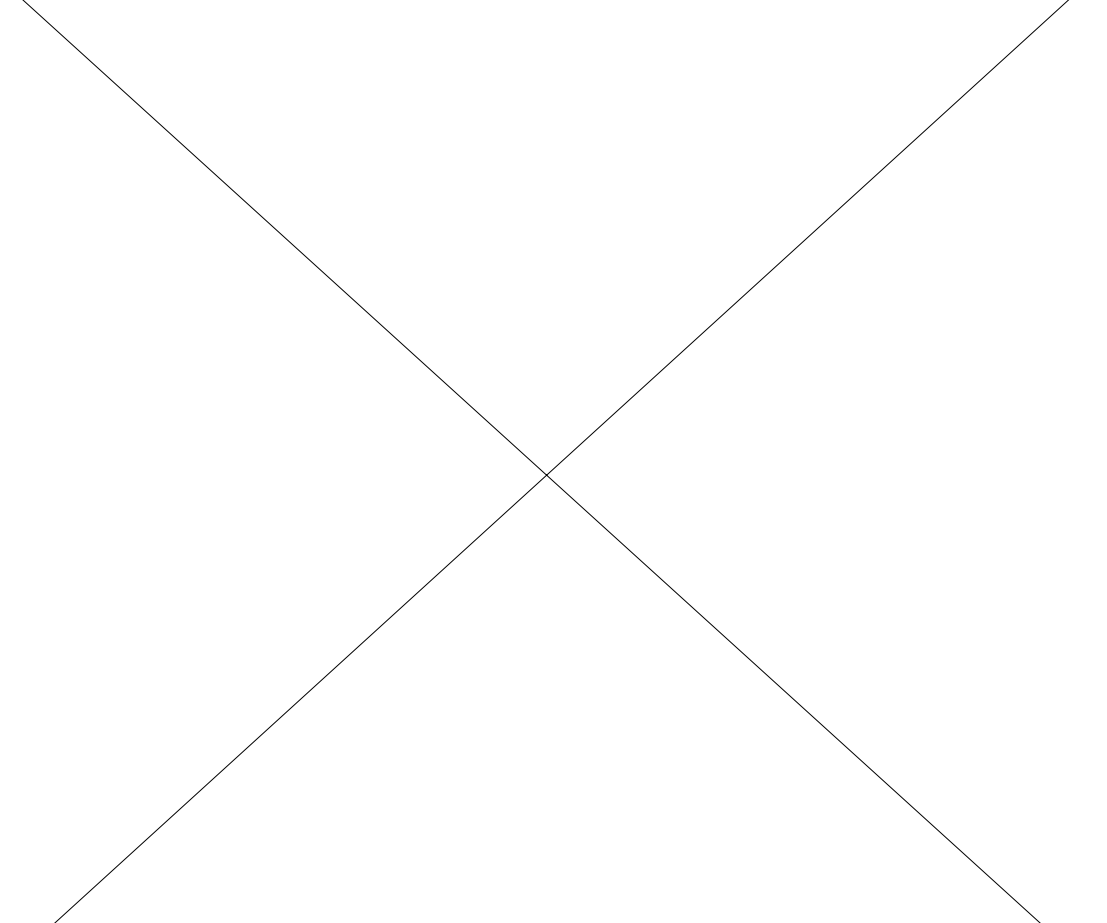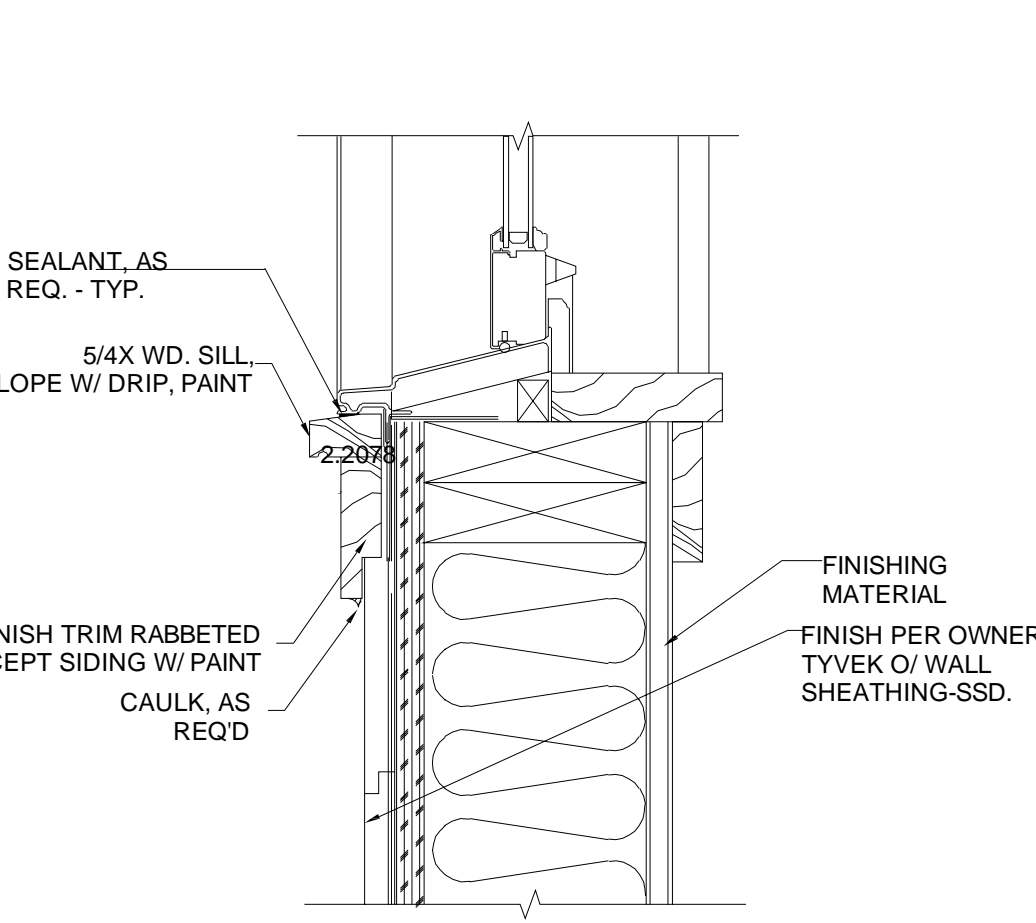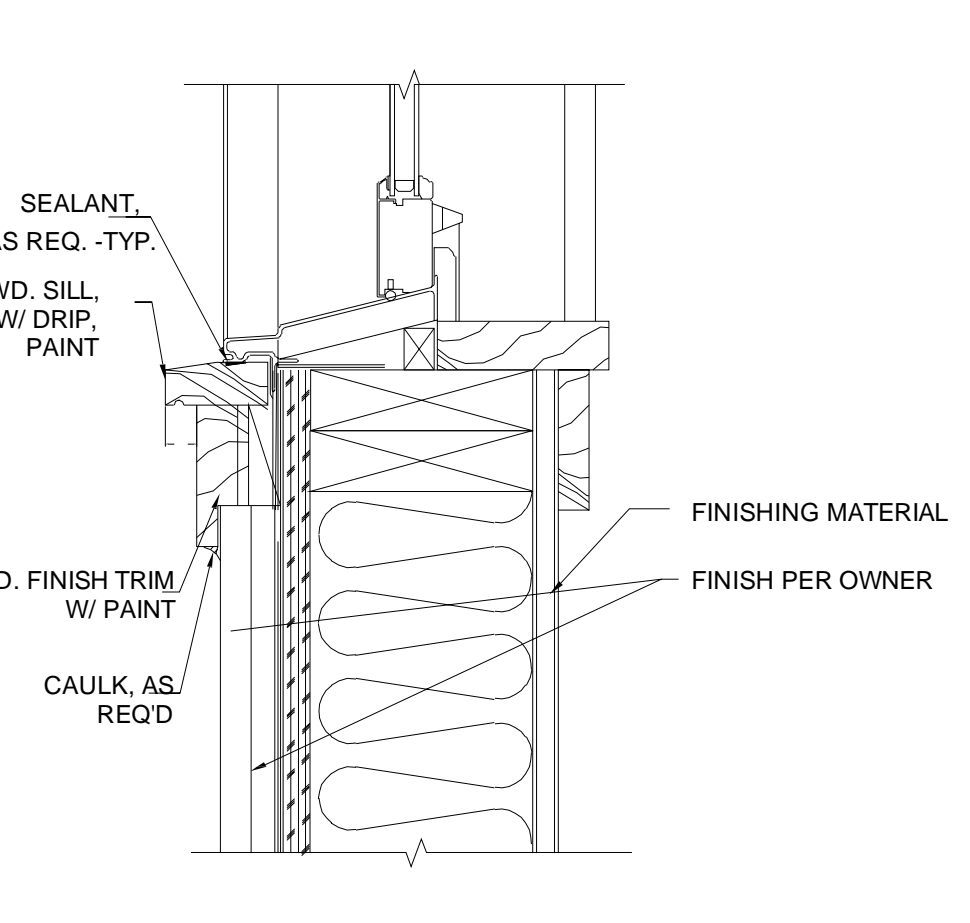

WINDOW SILL @ WD. BOARD & BATTEN SIDING 14


WINDOW SILL @ HORIZONTAL SIDING 11

BUILDING PAPER - FIRST COURSE 6

JAMB FLASHING 3

NO.	DATE	PERMIT SUBMITTAL DESCRIPTIONS	REVISIONS
000	01/24/2021		


DETAILS  
SINGLE FAMILY HOUSE  
272 Madison Ln  
Cameron, NC, 28326

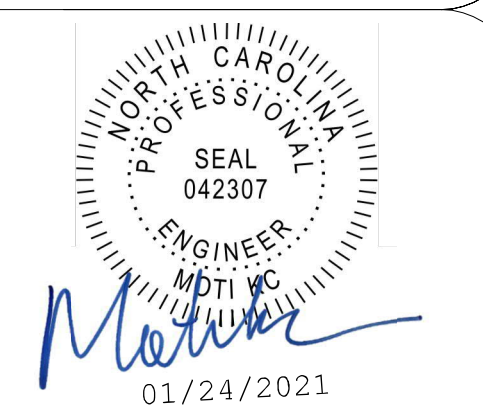

**EQUAGEN® ENGINEERS**  
FIRM LIC. # 1869  
121 EDINBURGH SOUTH DR., STE 103  
CARY, NC 27511  
PHONE: 919.444.5442  
EMAIL: MOTI.KC@EQUAGEN.COM

DRAWN BY:	DK
CHECKED BY:	MKC
DATE:	01/24/2021
SCALE:	AS SHOWN

A006 21-2005

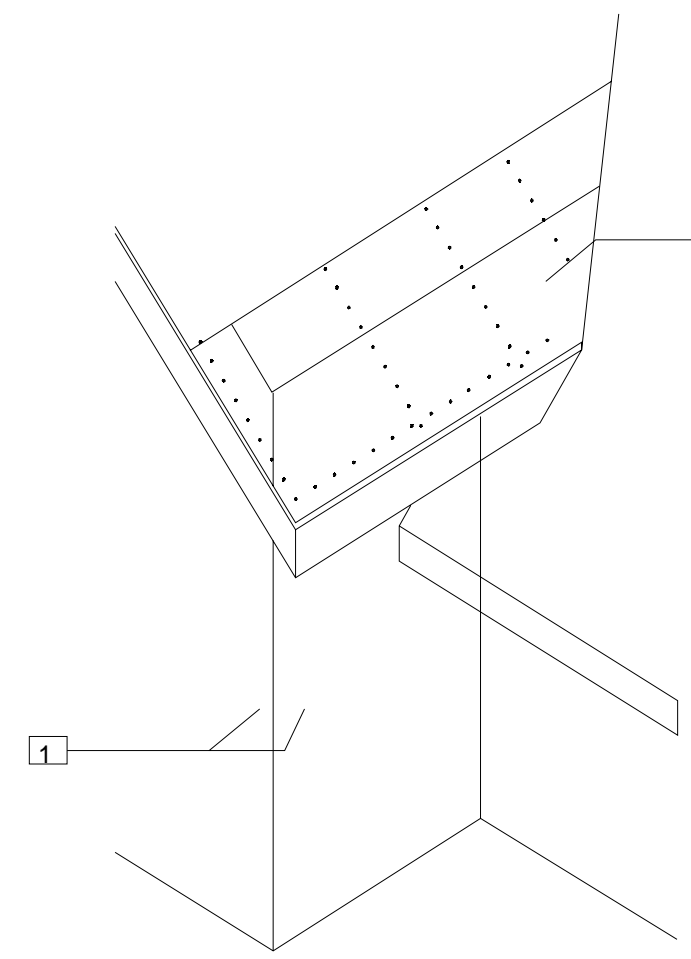


LEGEND

FINAL ROOF SHEATHING

7

BUILDING PAPER TO WALL

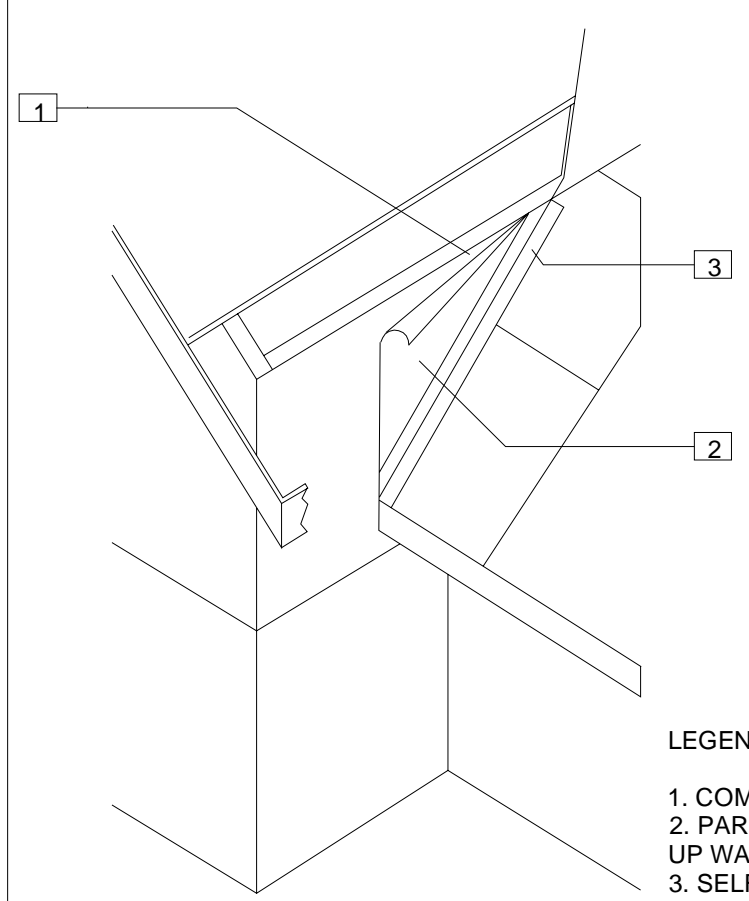


LEGEND

1. COMPLETE PAPERING OF WALL.
2. PARTIAL INSTALL 30# ROOF FELT 18" UP WALL AND 24" ON ROOF TOP.
3. SELF-ADHERING MEMBRANE 3" ON WALL TO ROOF.

ROOF TO WALL

4

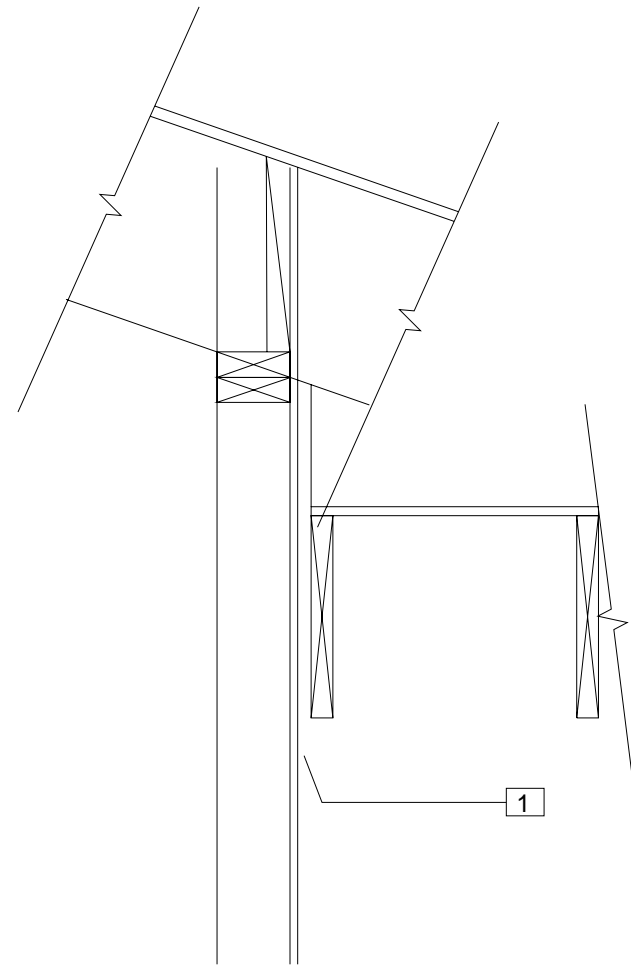


LEGEND

1. 1/2" CLEARANCE BETWEEN WALL AND ROOF SHEATHING.

SLIDING GLASS DOOR HEAD/JAMB



1

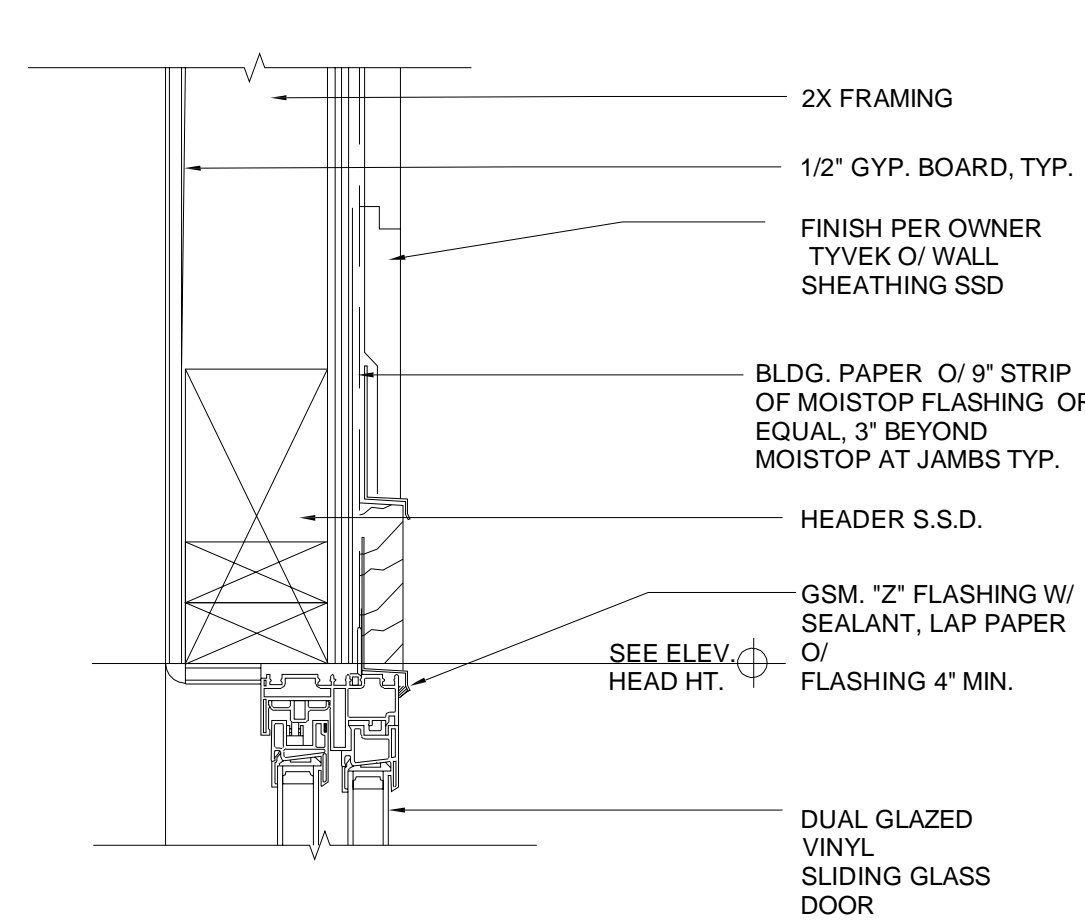

18

TYP. DOOR HEAD @ HORIZONTAL WD. SIDING

15

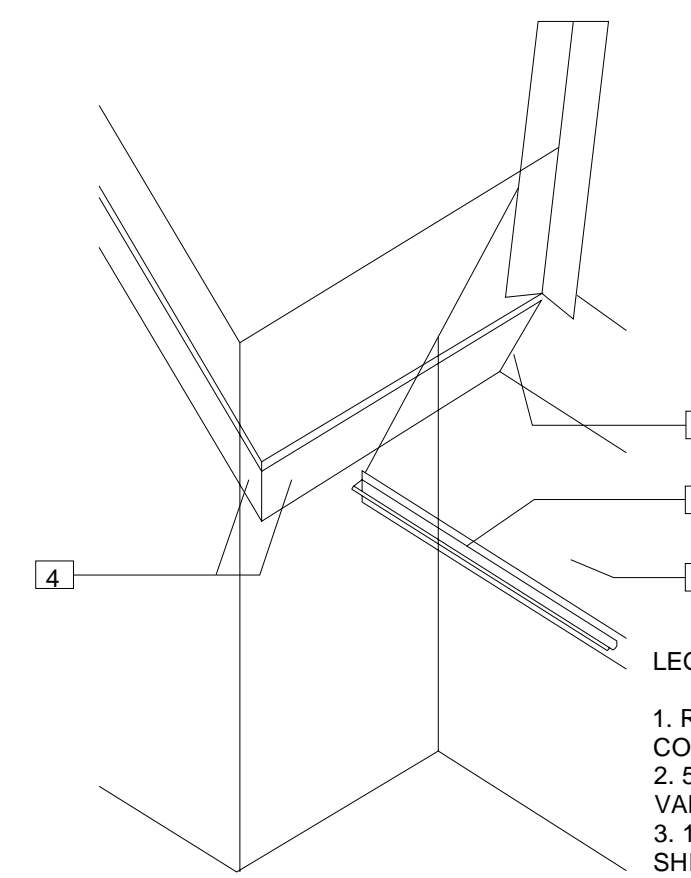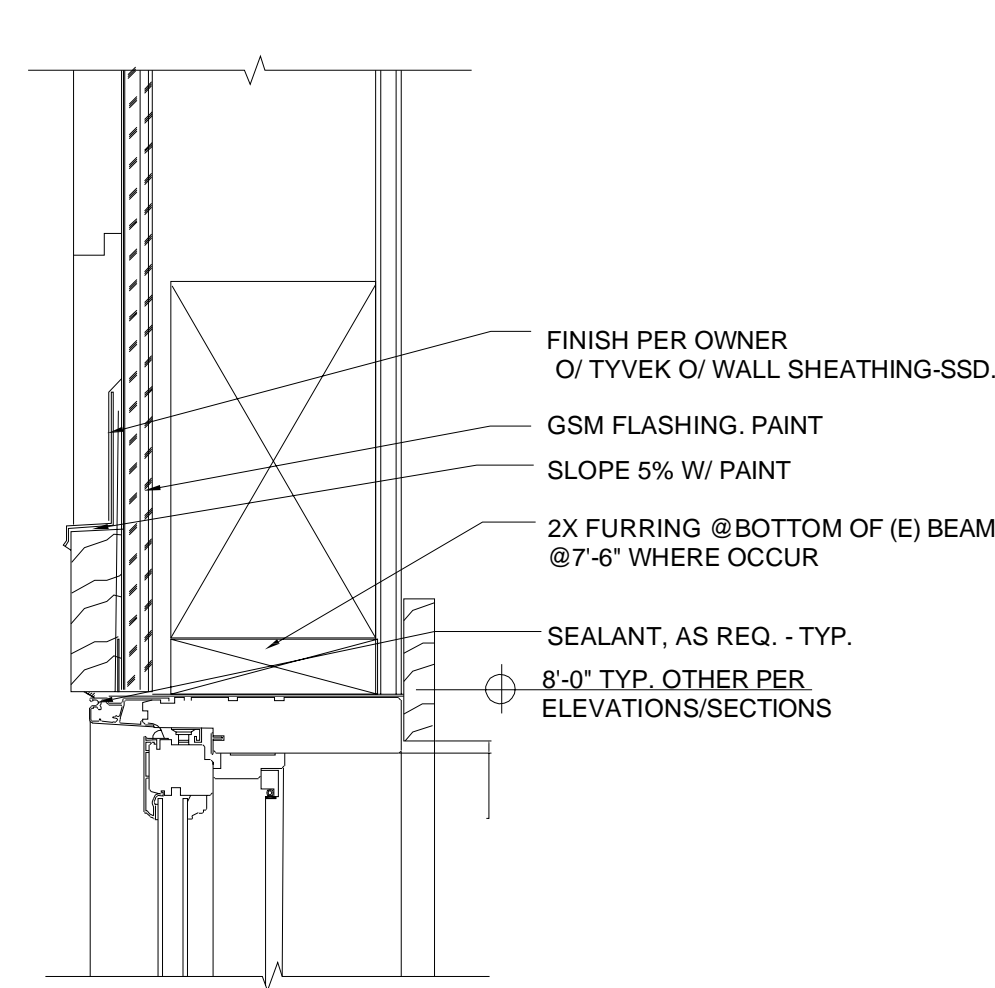


LEGEND

1. REMOVE PROTECTION BOARD & COMPLETE ROOFING FELT.
2. 50# FELT OVER WOVEN 30# VALLEY.
3. 1/2" CLEARANCE BETWEEN ROOF SHINGLES AND FASCIA.
4. INSTALL FINISH FASCIAS.
5. INSTALL GUTTERS.

FINISH APPLICATION

8

STEP FLASHING

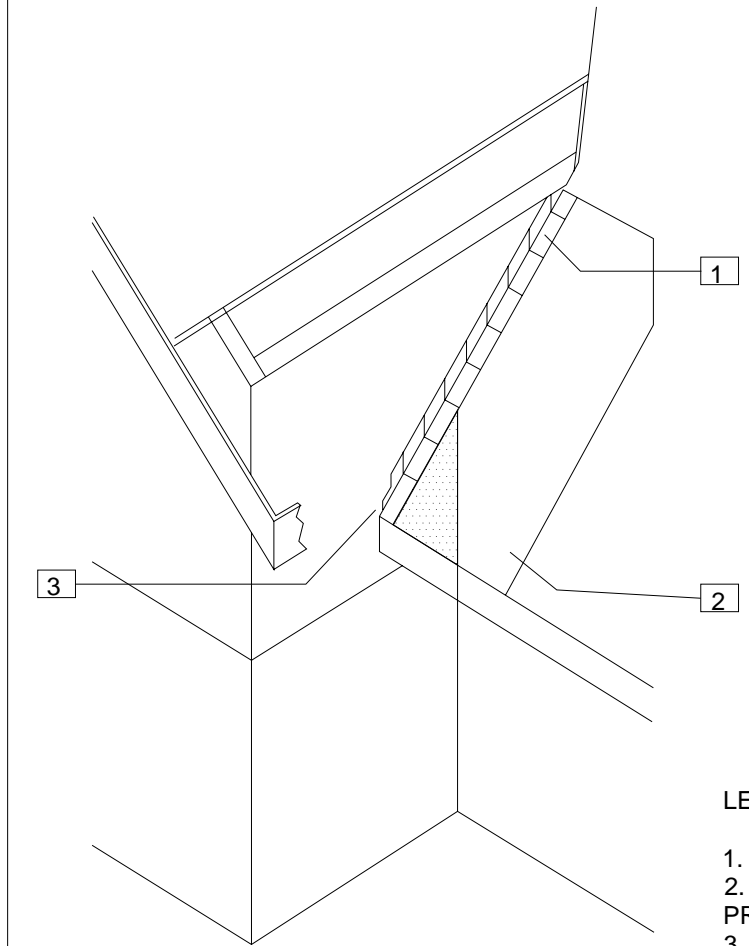


LEGEND

1. NAIL G.I. FLASHING TO WALL.
2. COVER ROOF FELT WITH PROTECTION BOARD.
3. DIVERTER STEP FLASHING.

ROUGH FRAMING

5

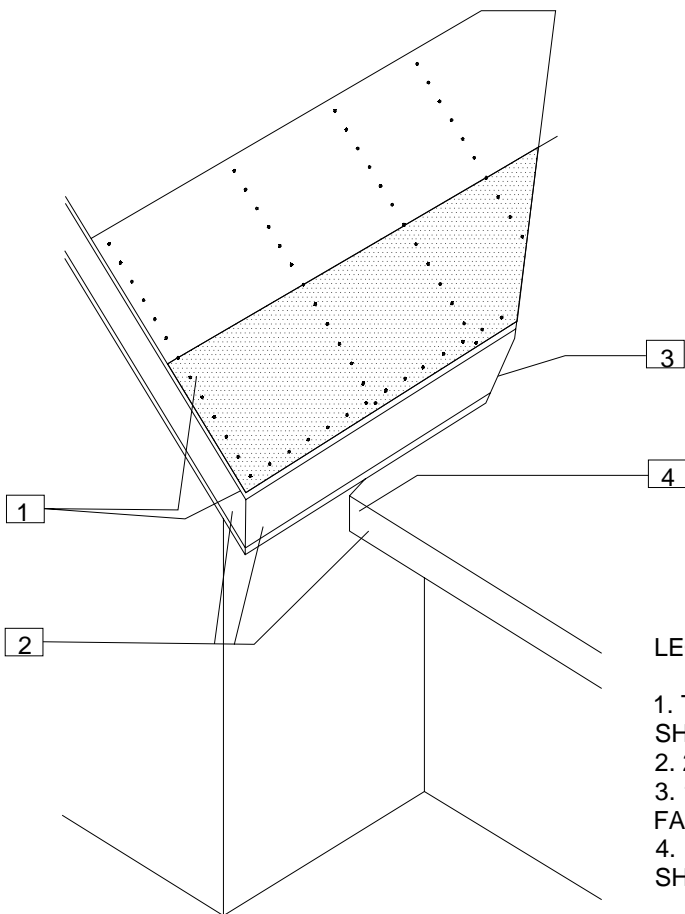



LEGEND

1. TACK NAIL LOWER EDGE OF ROOF SHEATHING.
2. 2X ROUGH FASCIA.
3. 1 1/2" CLEARANCE BETWEEN FASCIA AND SHEATHING.
4. 1 1/2" CLEARANCE BETWEEN WALL SHEATHING & ROOF RAFTER.

2

TYP. DOOR JAMB @ HORIZONTAL WD. SIDING

16

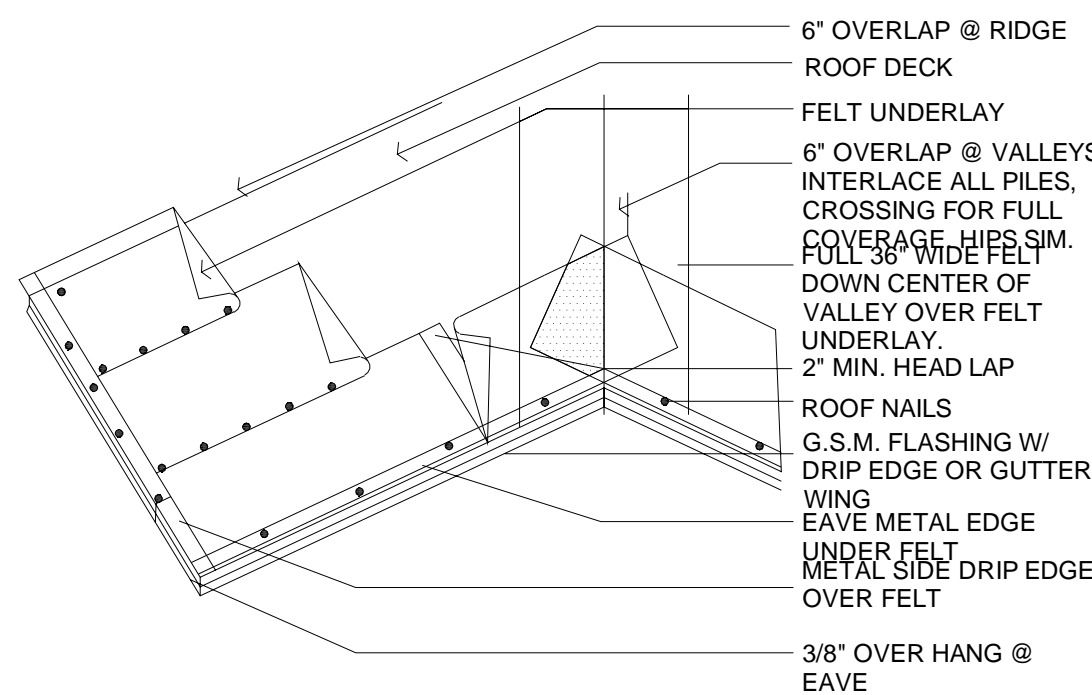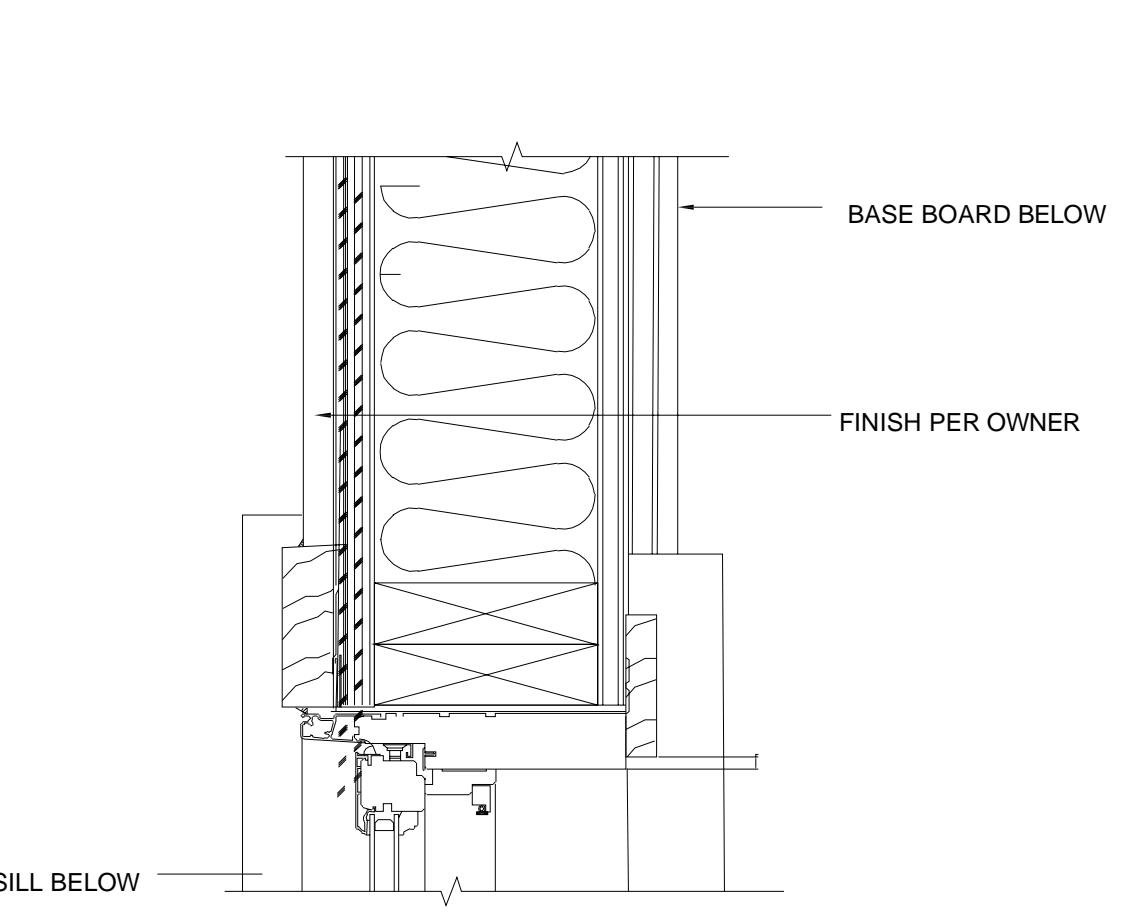


- APPLICATION NOTES FOR LOW SLOPE, 2:12 TO LESS THAN 4:12:
1. START W/ 1-19" WIDE SHEET OF FELT ALONG EAVE W/ 3/8" OVERHANG.
  2. TROWEL A CONTINUOUS LAYER OF ROOFING CEM. (@ A RATE OF 2 GAL. PER 100 SQ. FT.) ON TO THE FELT.
  3. PRESS 1-36" WIDE SHEET OF FELT FIRMLY ONTO THE CEM. & NAIL DOWN W/ GALV. ROOFING NAILS @ 12" O.C. ALONG A LINE 18" ABOUT THE BTM. EDGE OF THE FELT.
  4. APPLY ROOFING CEM. TO THE UPPER 19" OF THE EXPOSED FELT.
  5. COVER THE CEMENTED PORTION W/ THE NEXT SHEET OF FELT & NAILS.
  6. REPEAT PROCESS UNTIL 24" INSIDE THE INTERIOR WALL LINE.
  7. COVER THE REMAINING ROOF W/ DBL. LAYERS OF FELT, W/O CEM., UP TO THE RIDGE.

FELT UNDERLAYMENT

9

CORNER FLASHING

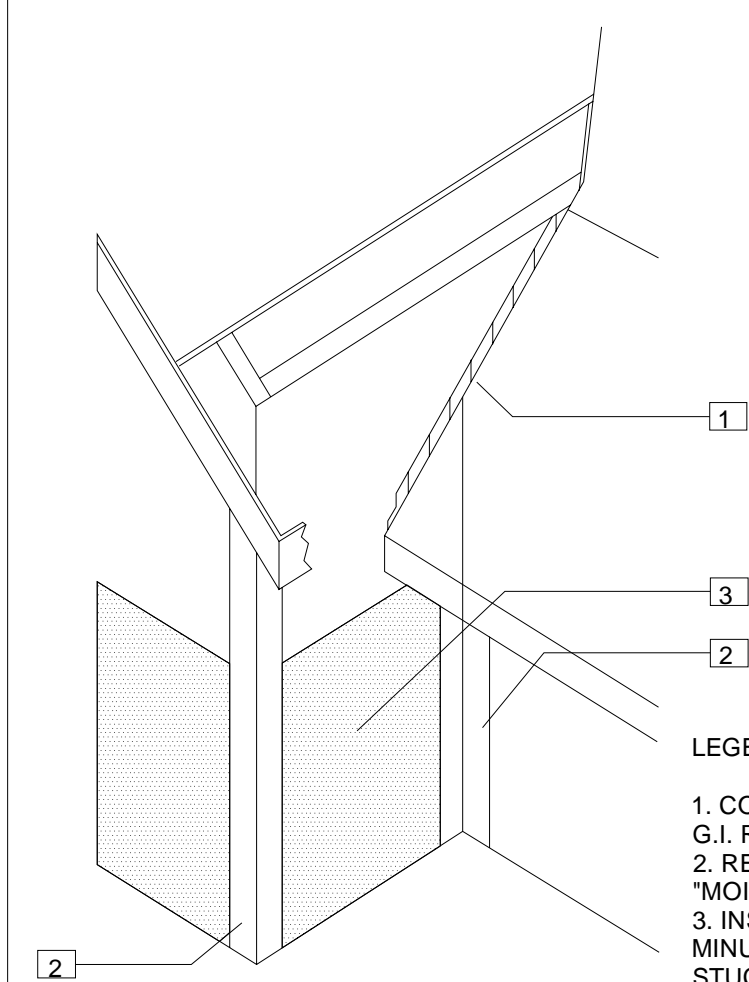


LEGEND

1. CORNER FLASH FLASHING WITH G.I. REGLET.
2. REINFORCE CORNERS WITH 12" "MOISTOP".
3. INSTALL SECOND COURSE OF 60 MINUTE FELT OVER REGLET AND STUCCO WEEP SCREED.

FELT APPLICATION


6

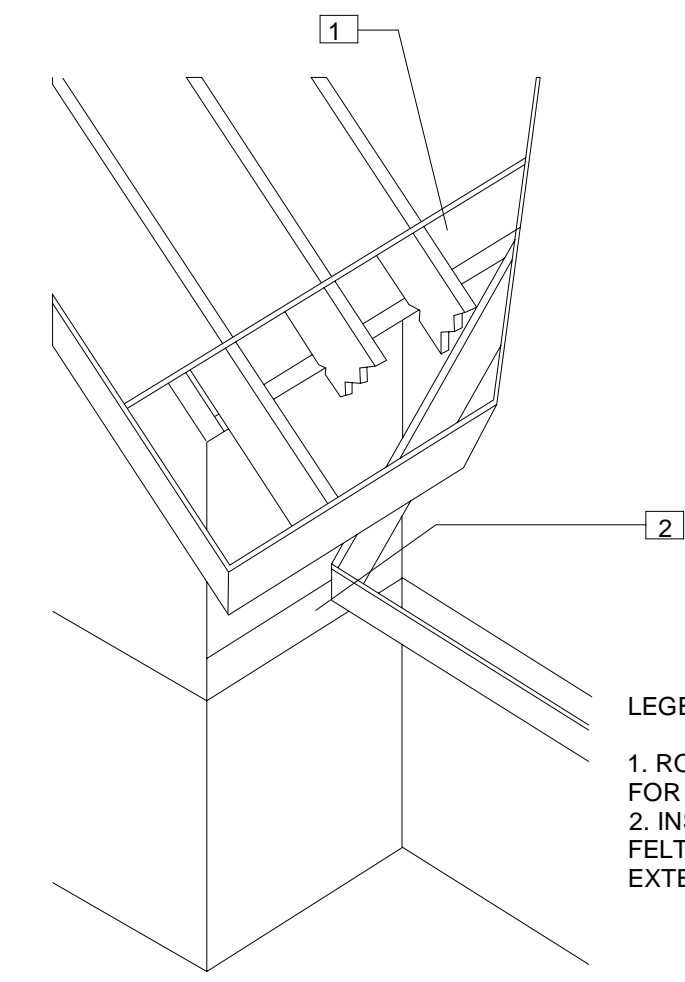

LEGEND

1. ROOF PLY TEMPORARILY MOVED FOR ACCESS.
2. INSTALL CONTINUOUS PIECE OF FELT FROM CORNER TO CORNER EXTENDING UP TO TOP PLATE.

3

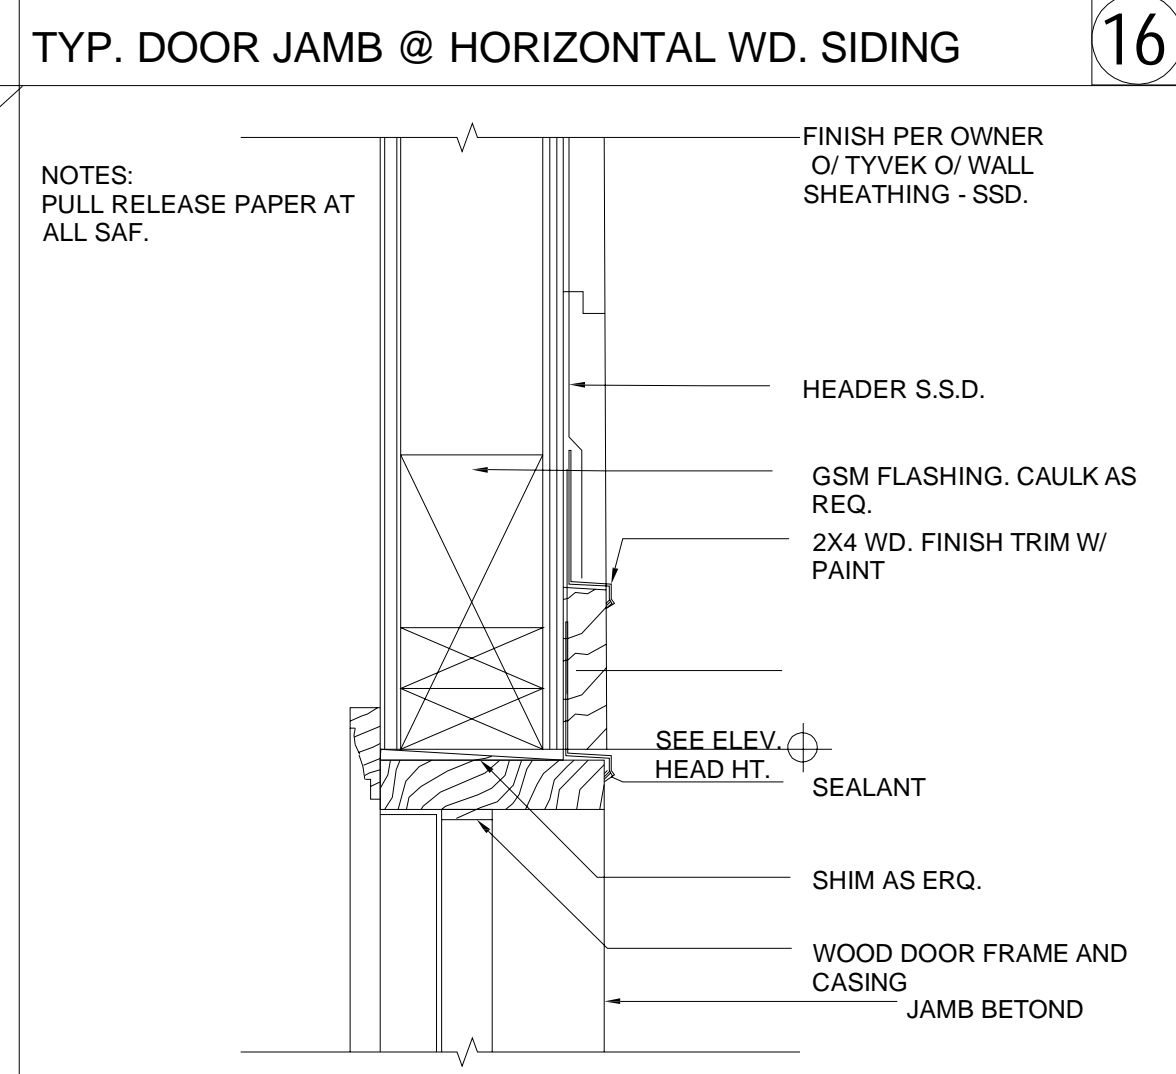

DOOR HEAD/JAMB

17

NO.	DATE	PERMIT SUBMITTAL	DESCRIPTIONS	REVISIONS
000	01/24/2021			


DETAILS  
SINGLE FAMILY HOUSE  
272 Madison Ln  
Cameron, NC, 28326



**EQUAGEN ENGINEERS**  
FIRM LIC. # 1869  
121 EDINBURGH SOUTH DR., STE 103  
CARY, NC 27511  
PHONE: 919.444.5442  
EMAIL: M.MOTI.KC@EQUAGEN.COM


DRAWN BY:	DK
CHECKED BY:	MKC
DATE:	01/24/2021
SCALE:	AS SHOWN

A007 21-2005

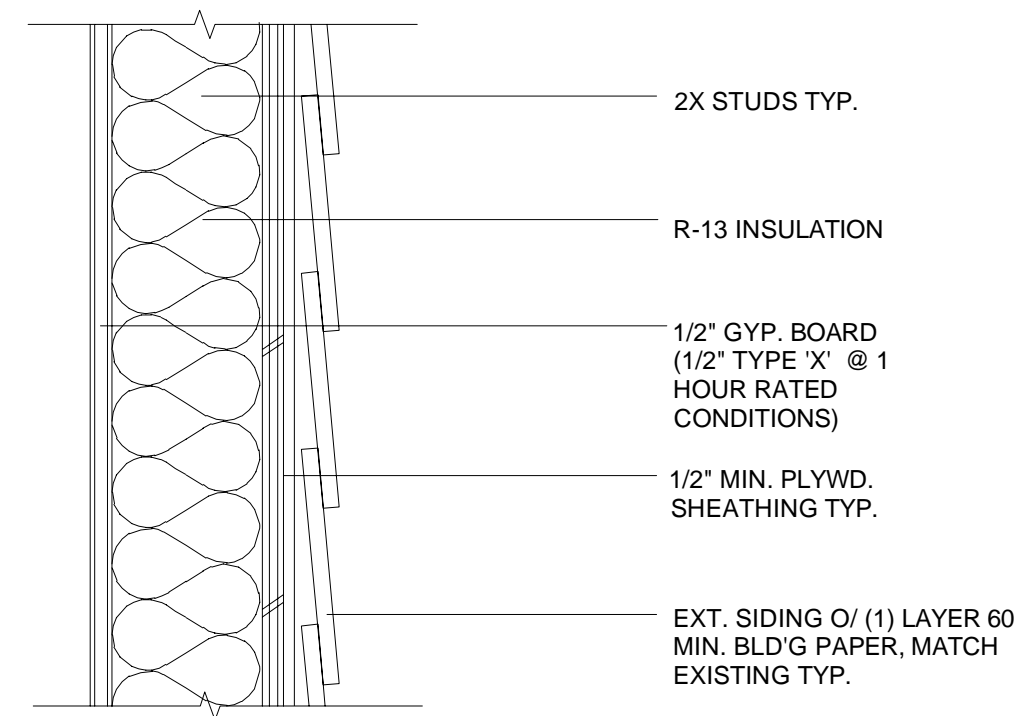


WARNING:  
DO NOT CUT OR DAMAGE HEATIZON  
"TUFF CABLE" OR IT'S INSULATOR IN ANY  
WAY.

22 HORIZONTAL LAP SIDING

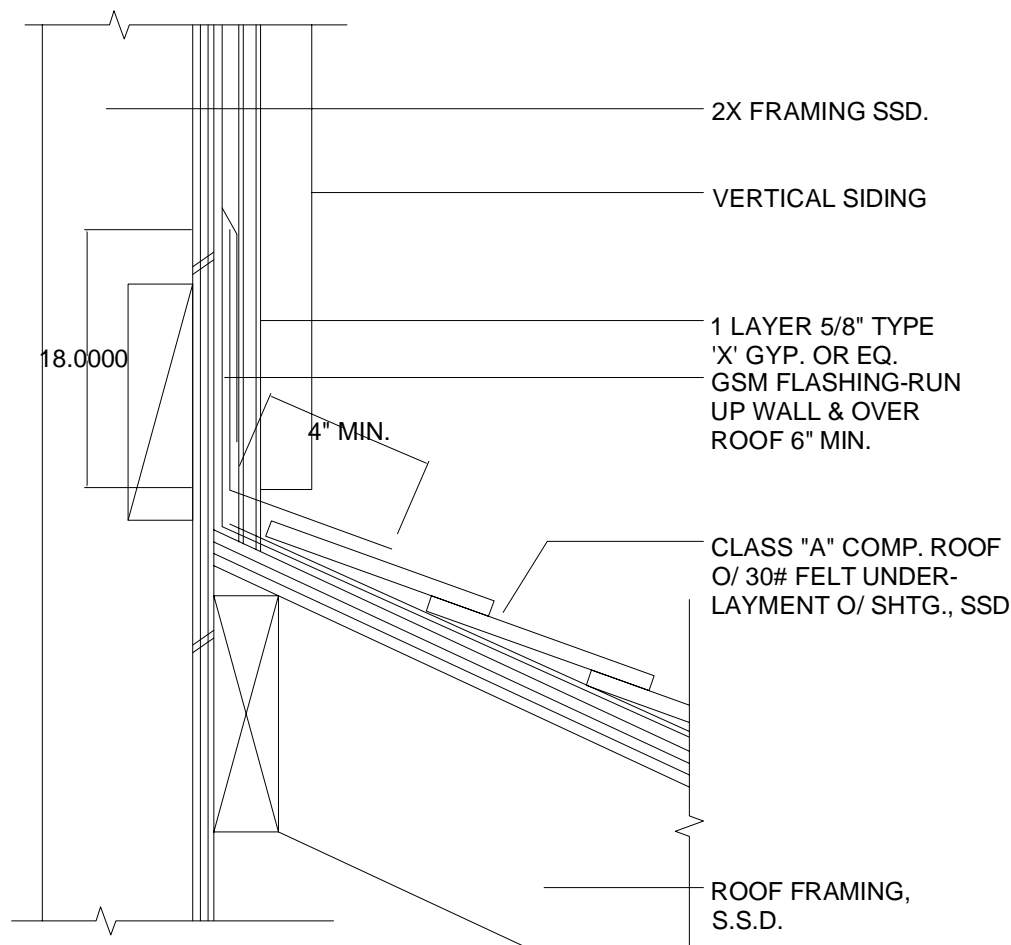


19 ROOF TO WALL PERP.

16

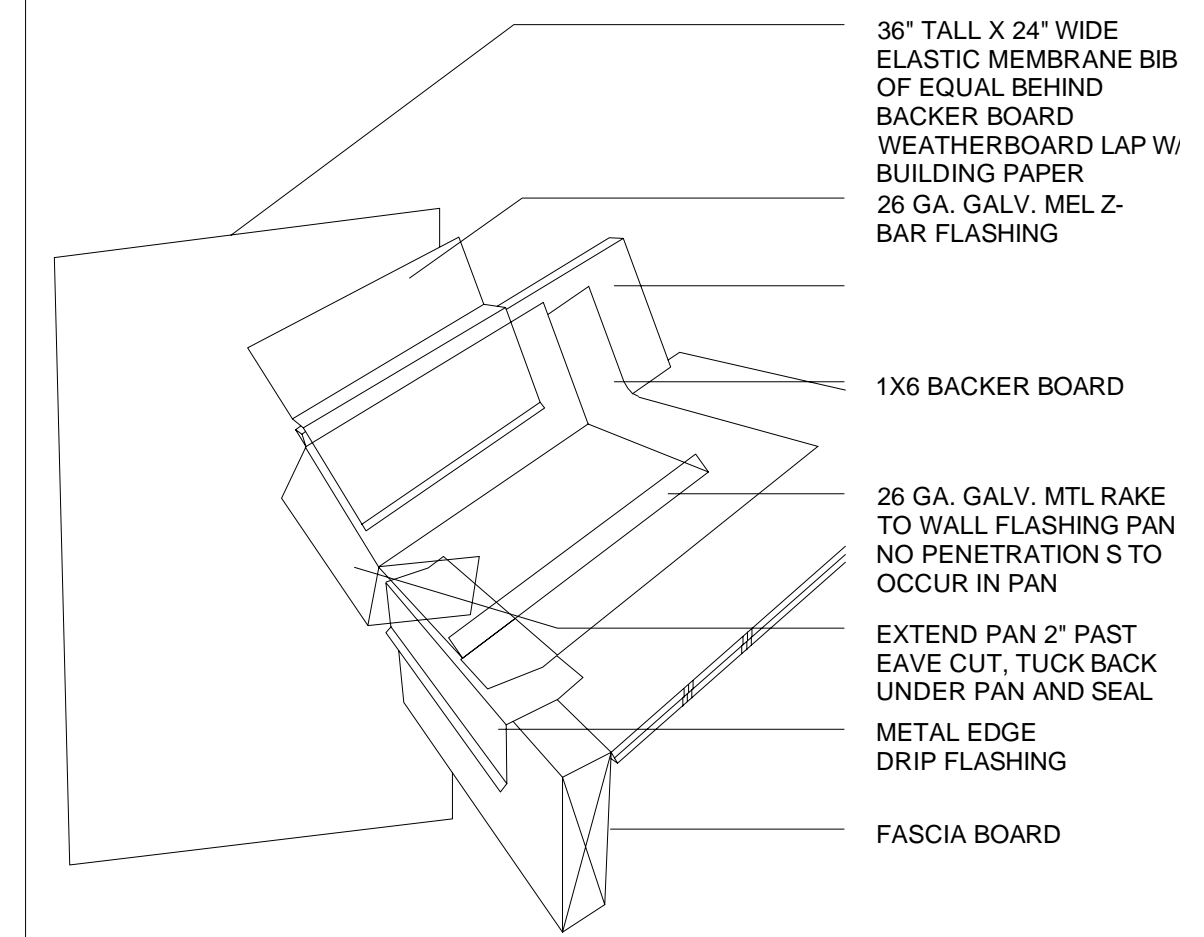

13 RAKE TO WALL DIVERTER


10

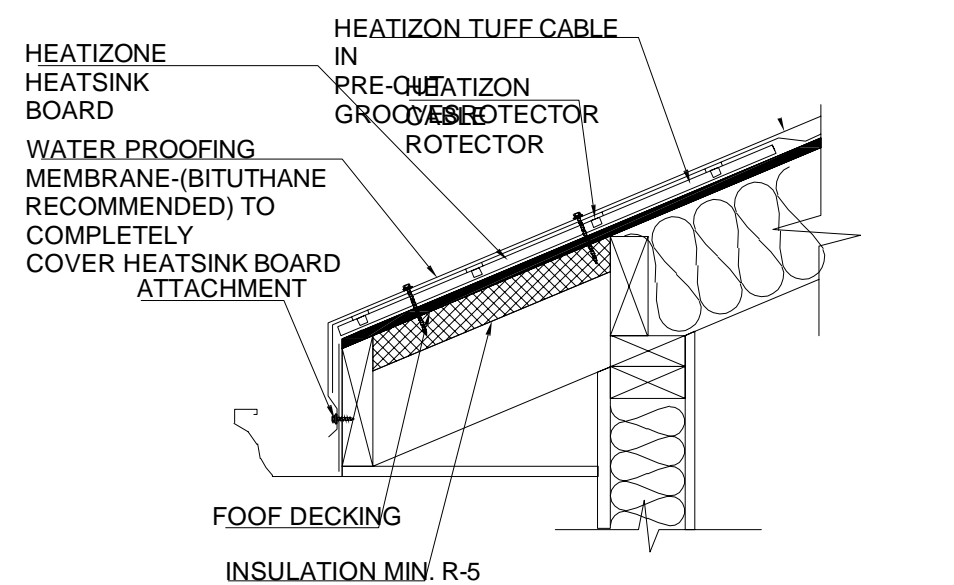

NOTE:  
ALL ATTACHMENTS FOR ROOFING  
SYSTEM OR OTHER COMPONENTS  
SHOULD BE MADE PRIOR TO  
INSTALLATION OF WATER-PROOFING  
COVERING.

23 EAVE DETAIL-TUFF CABLE IN HEATSINK UNDER METAL ROOF


20 EAVE

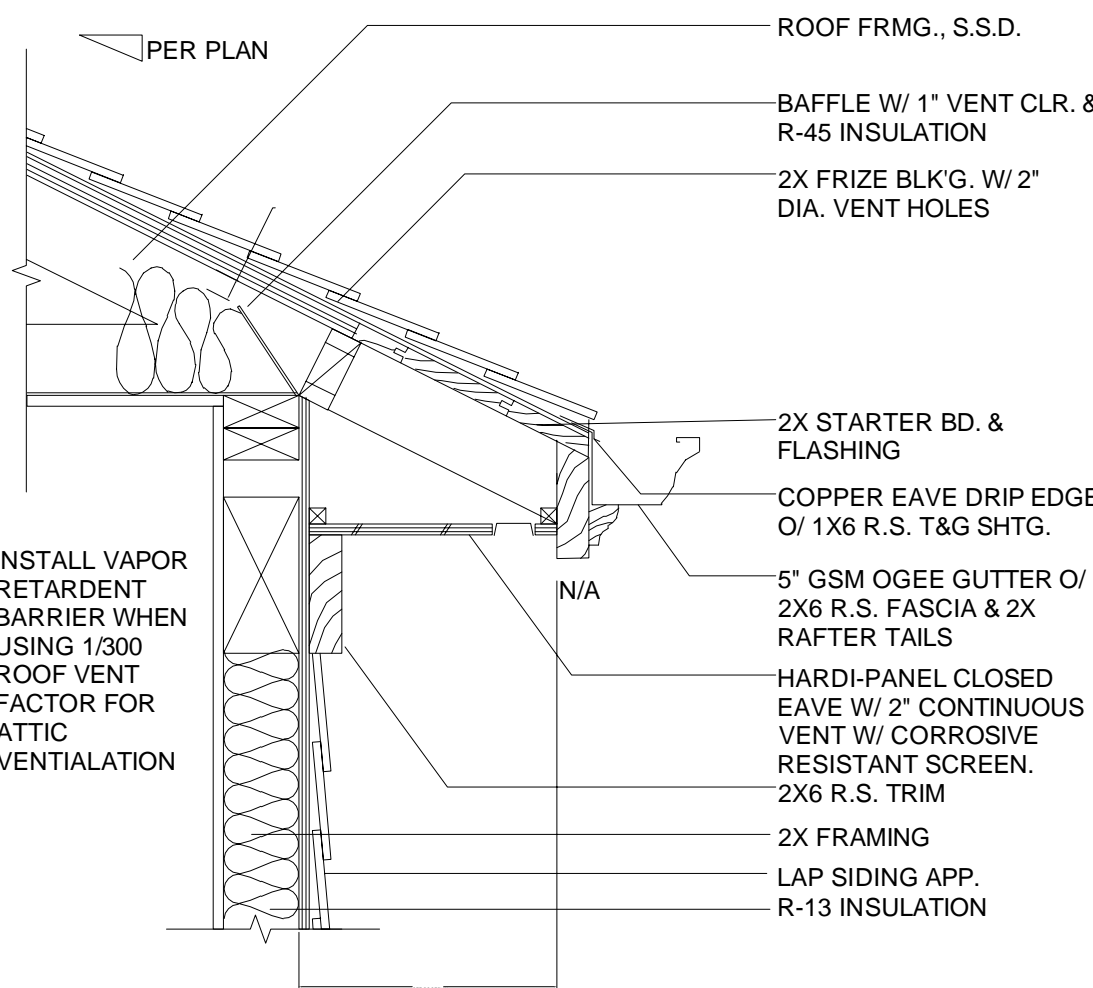

17 VALLEY


14 RAKE TO EAVE TRANSITION

11

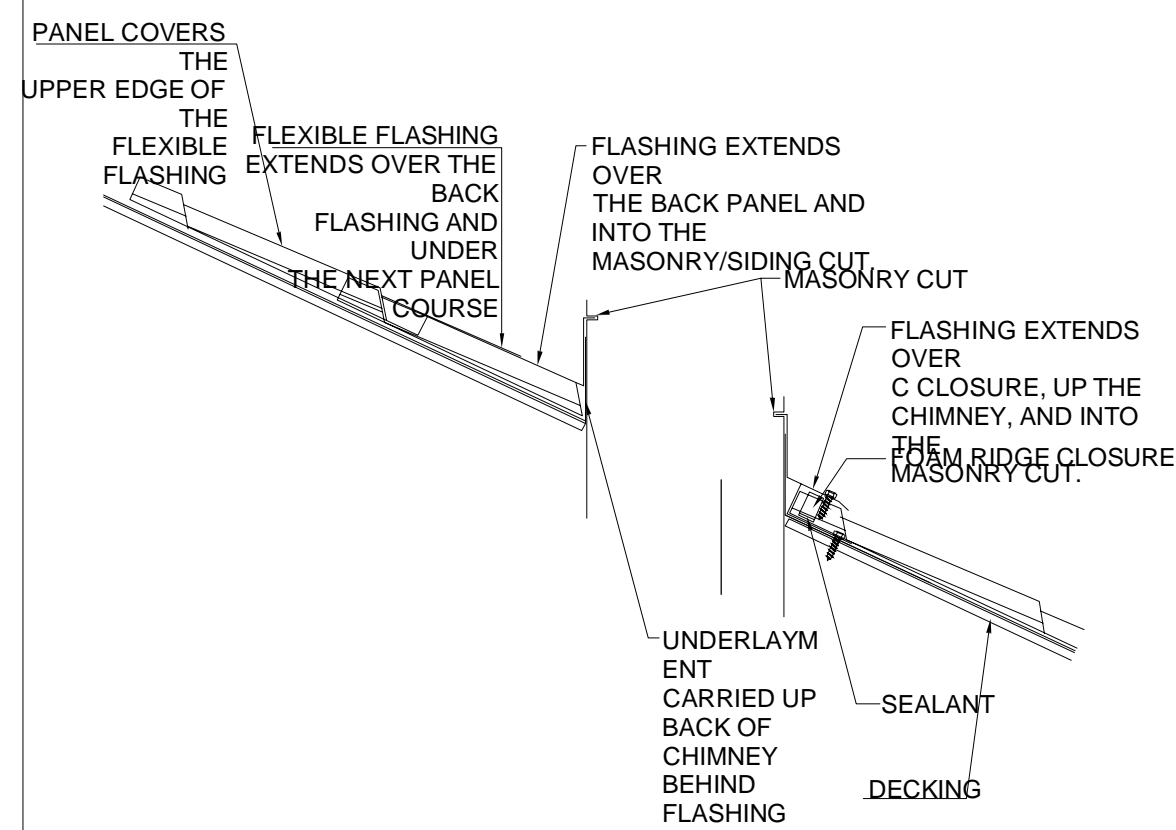


METAL ROOF CHIMNEY FLASHING DETAILS


24 METAL ROOF VALLEY DETAIL

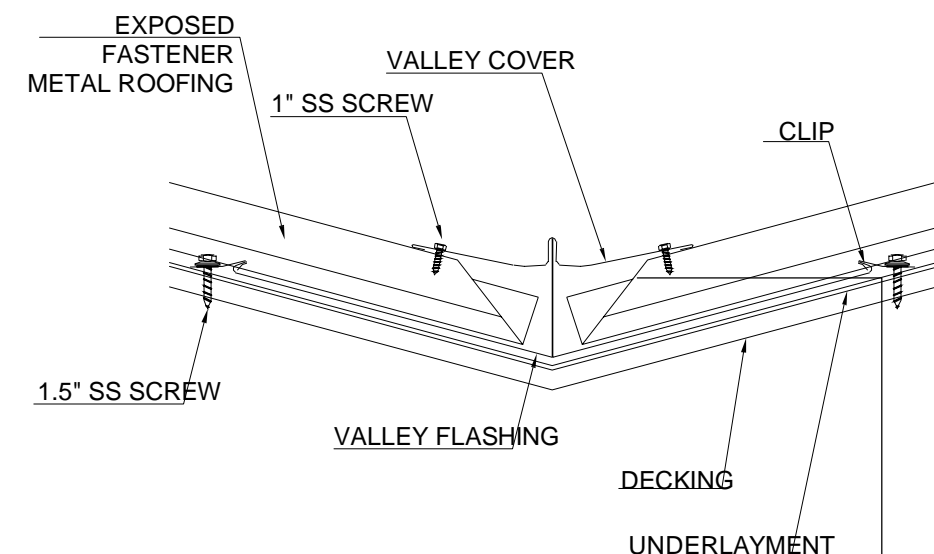

21 RAKE

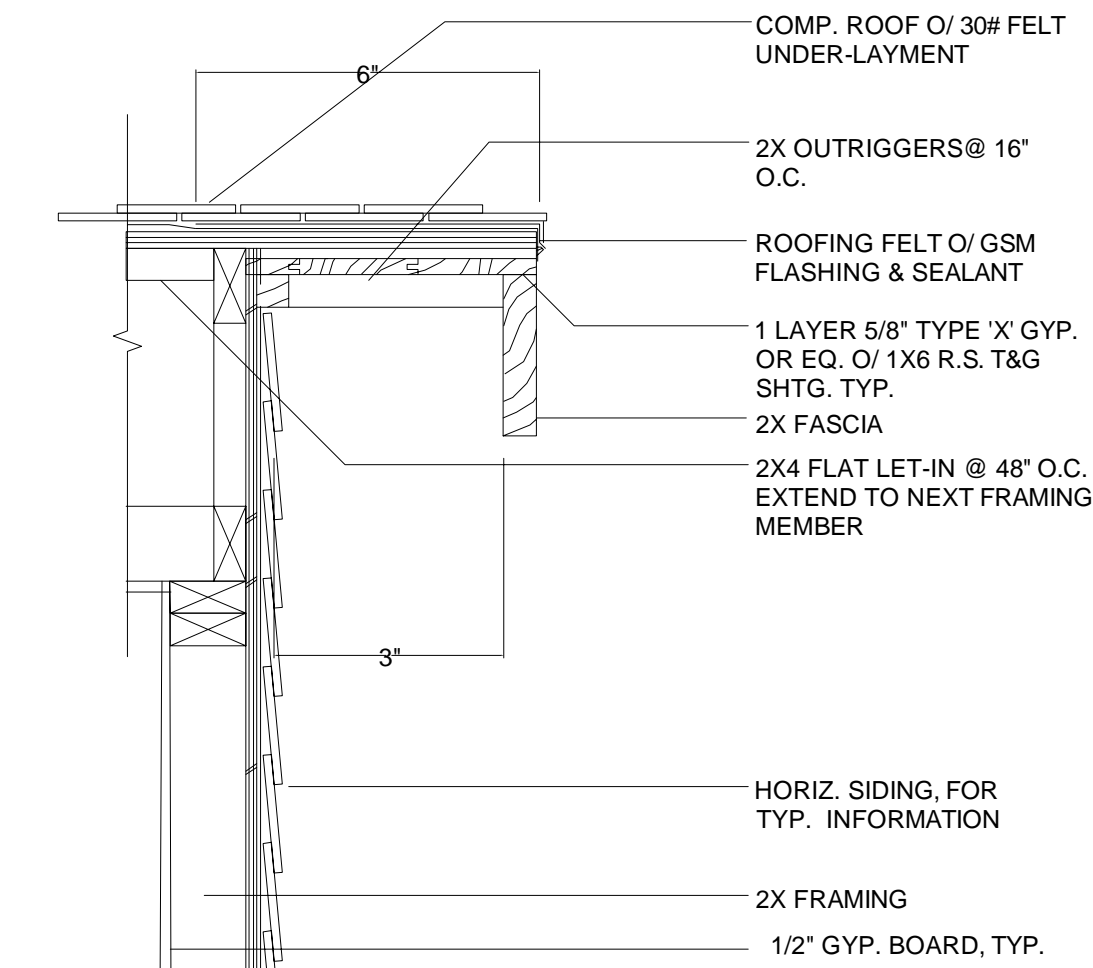


18 ROOF TO WALL PARALLEL

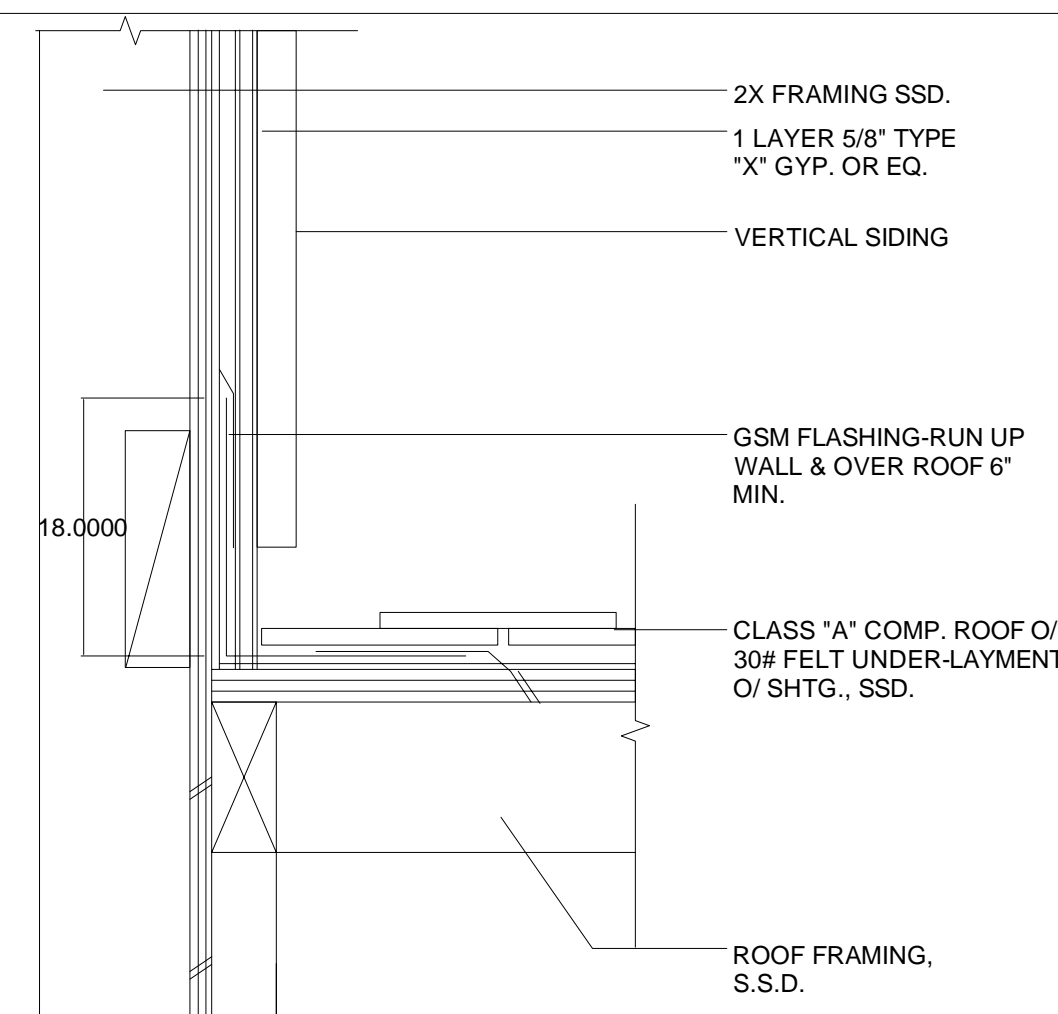


15 ISOMETRIC EAVE PERP. TO WALL @ COMP.

12

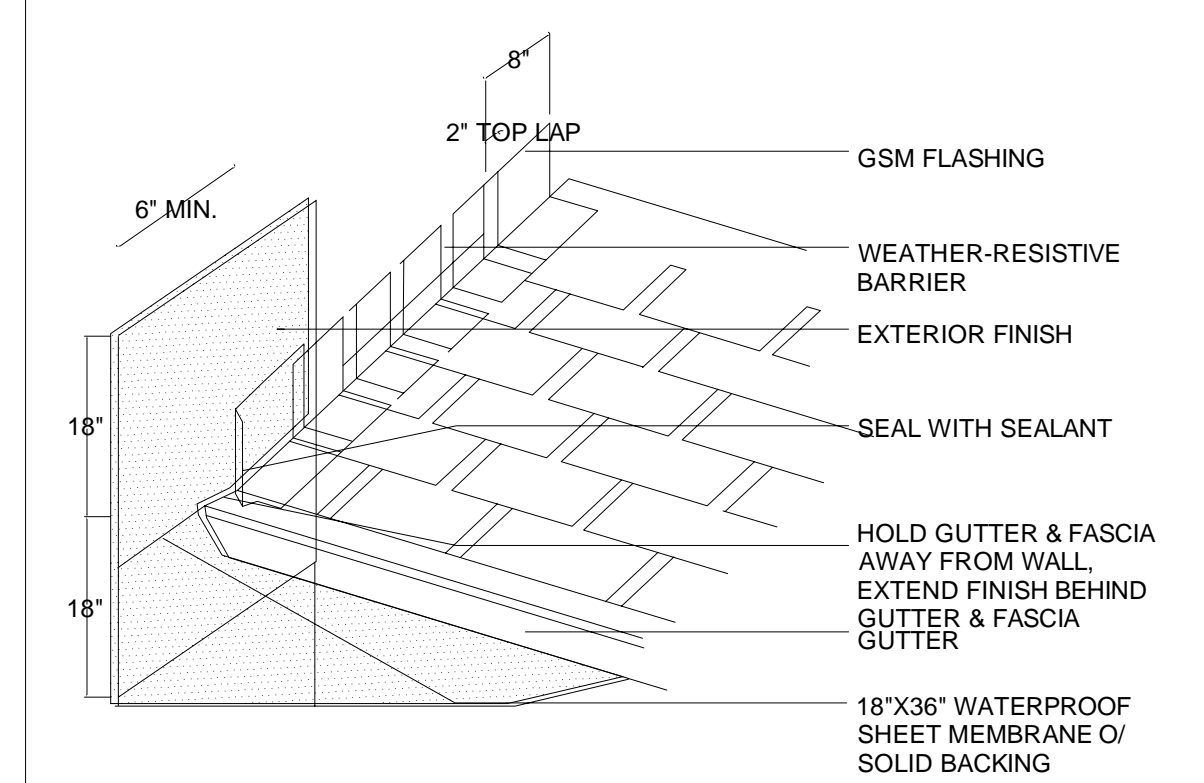

DETAILS

SINGLE FAMILY HOUSE  
272 Madison Ln  
Cameron, NC, 28326

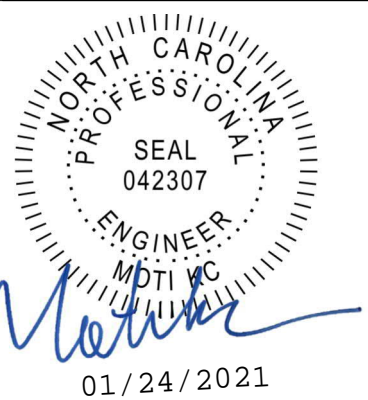

**EQUAGEN®**  
ENGINEERS  
FIRM LIC. # 1869  
121 EDINBURGH SOUTH DRI., STE 103  
CARY, NC 27511  
PHONE: 919.444.5442  
EMAIL: MOTI.KC@EQUAGEN.COM




DRAWN BY:	DK
CHECKED BY:	MKC
DATE:	01/24/2021
SCALE:	AS SHOWN

A008 21-2005

NO.	DATE	DESCRIPTIONS
000	01/24/2021	Permit Submittal

REVISIONS



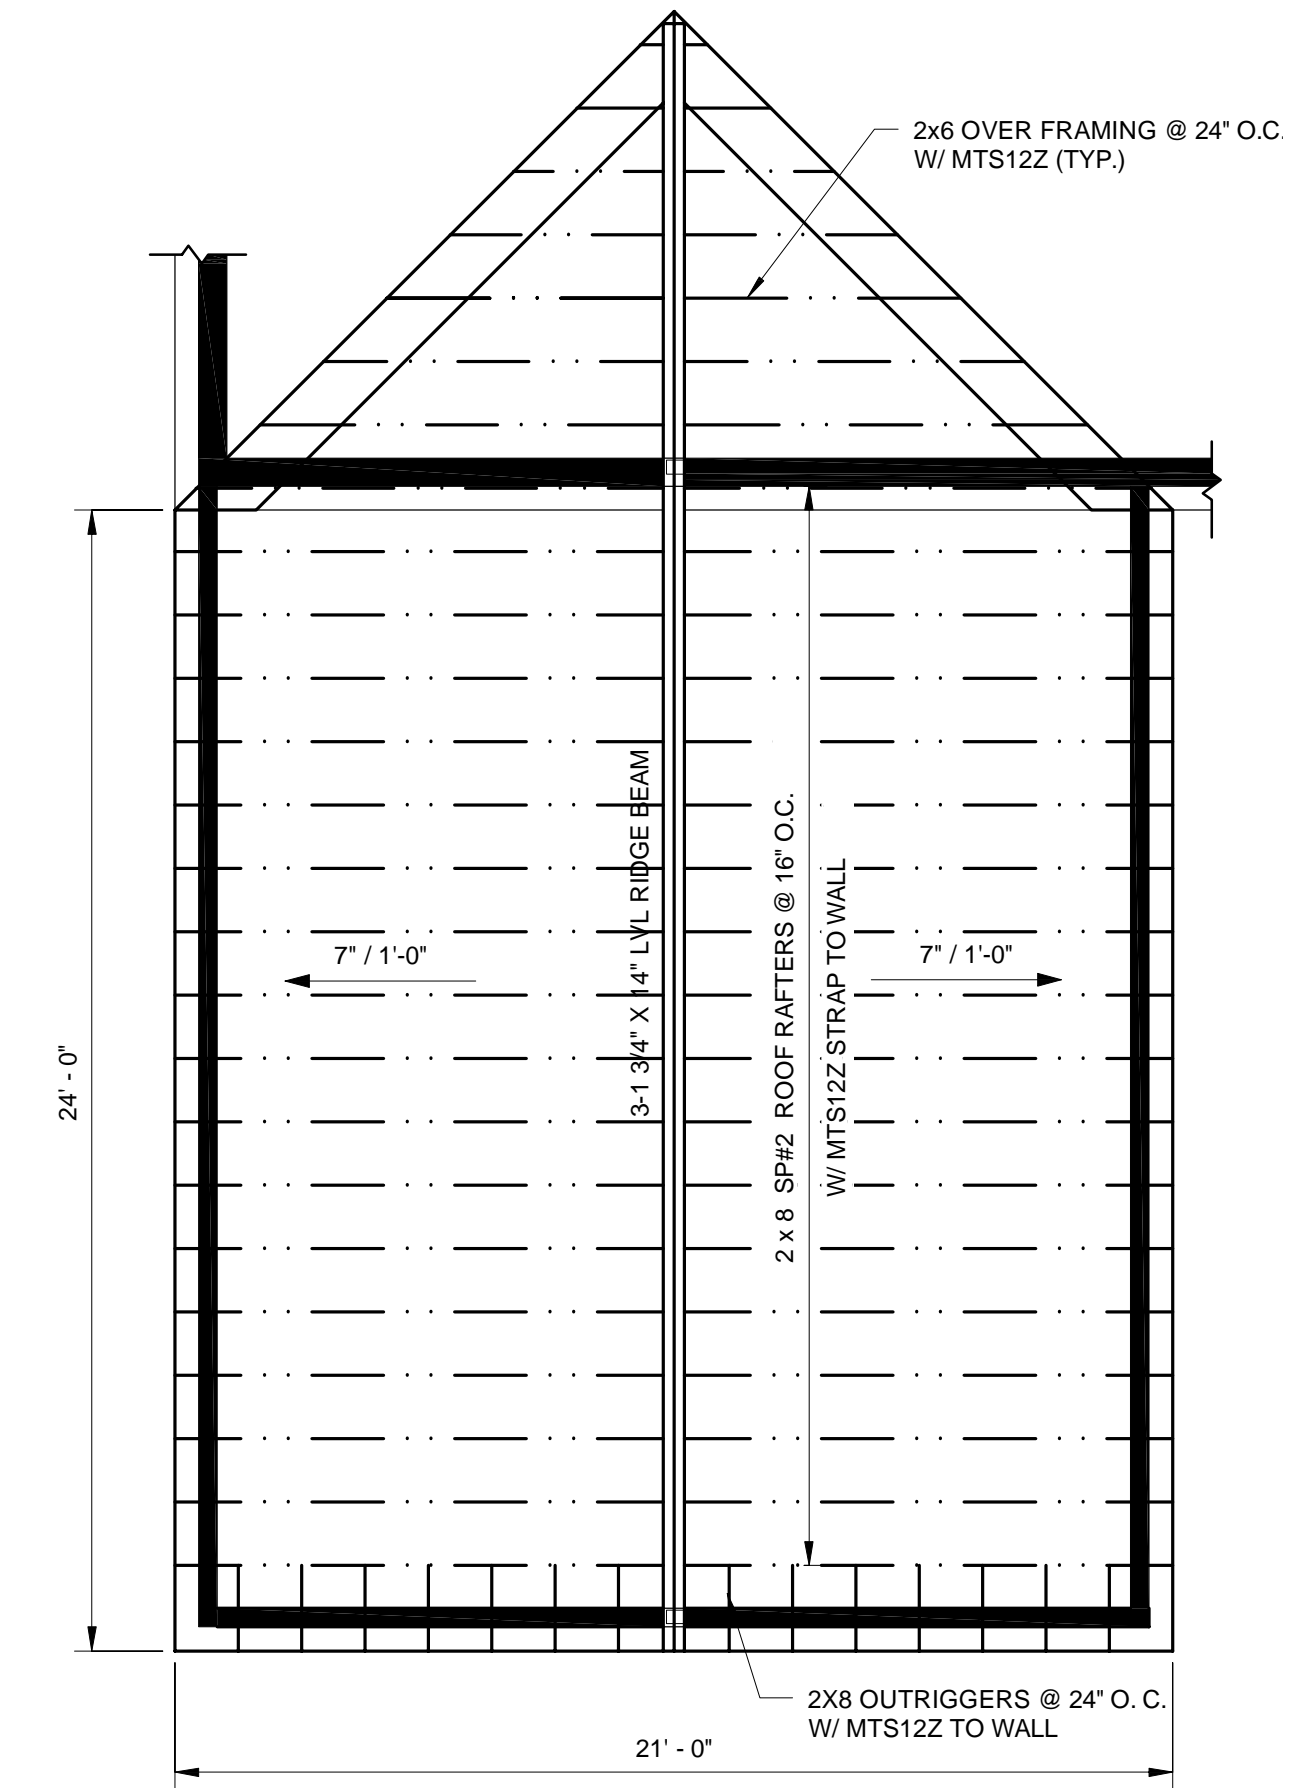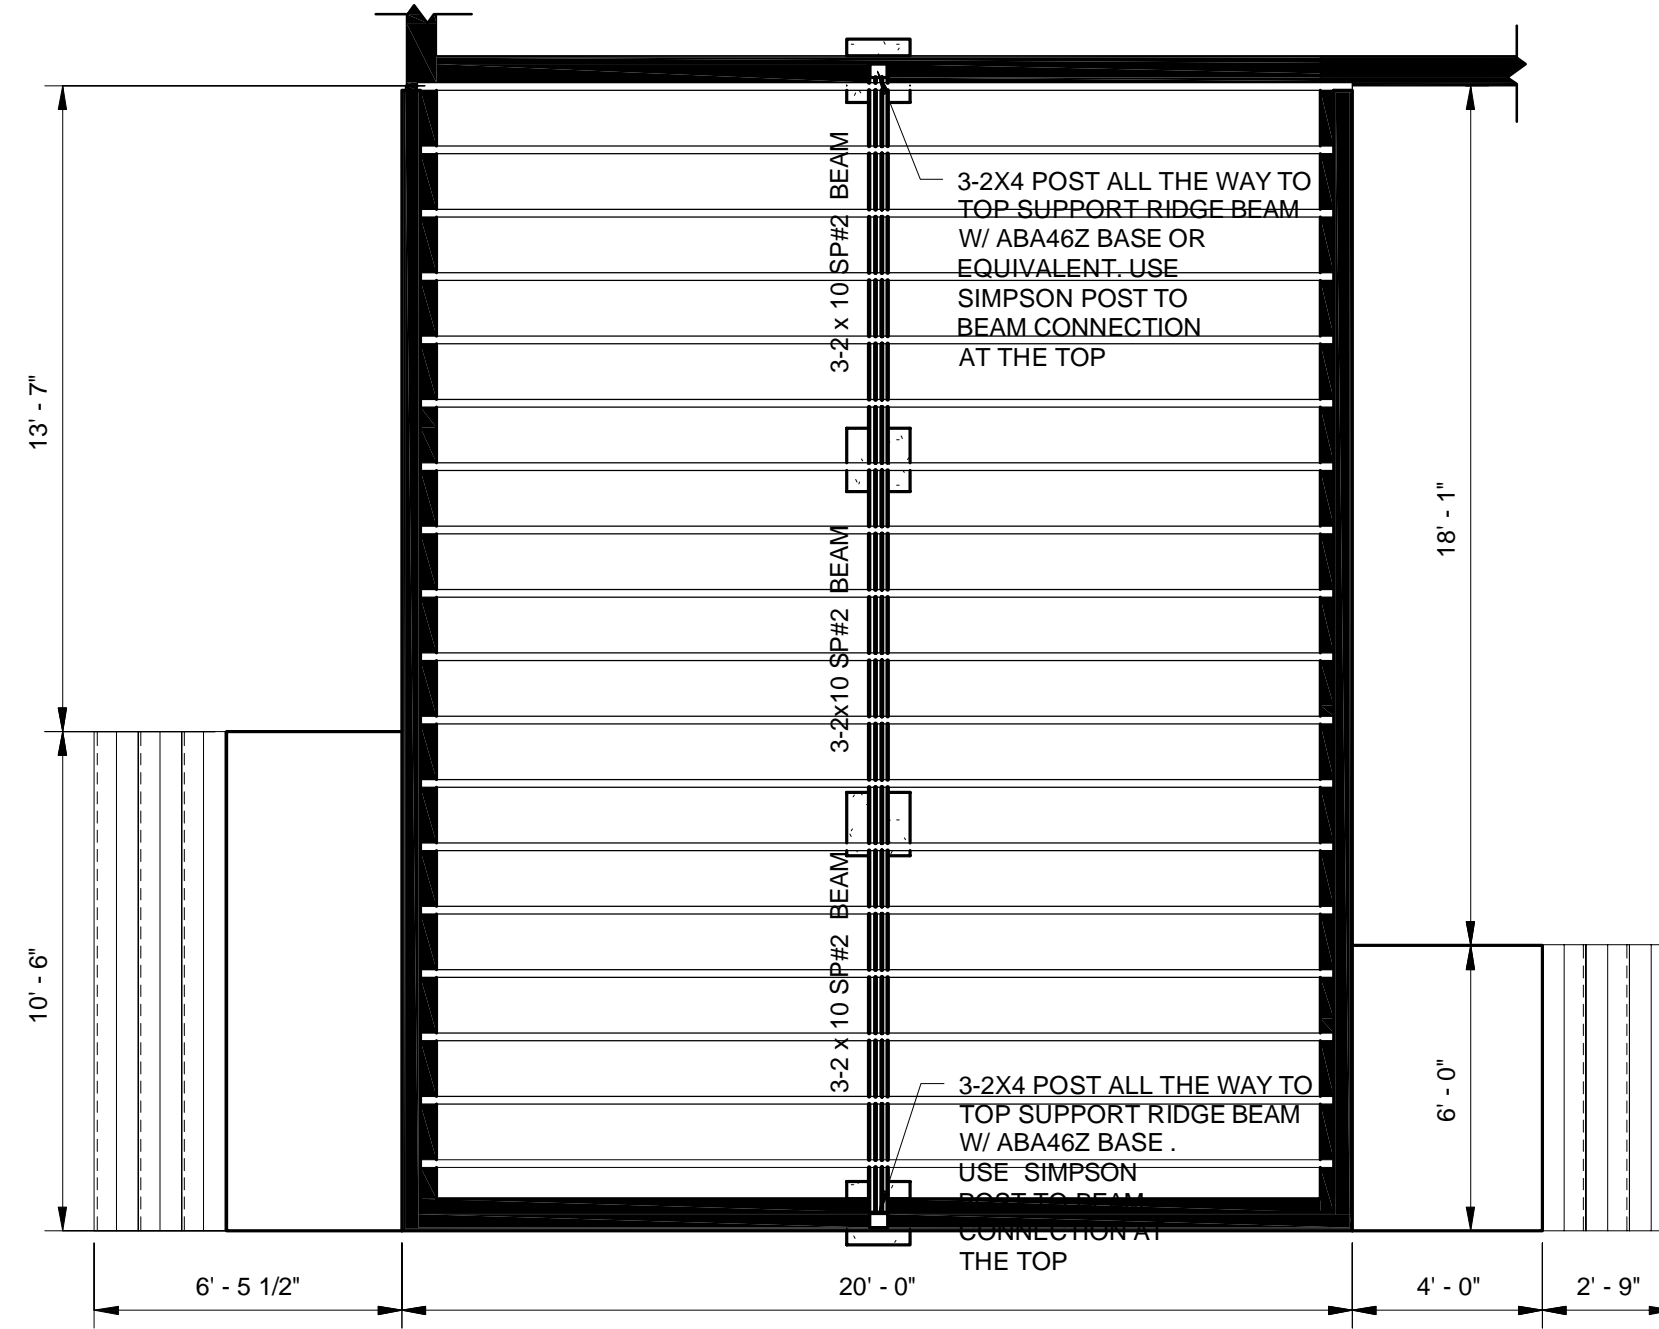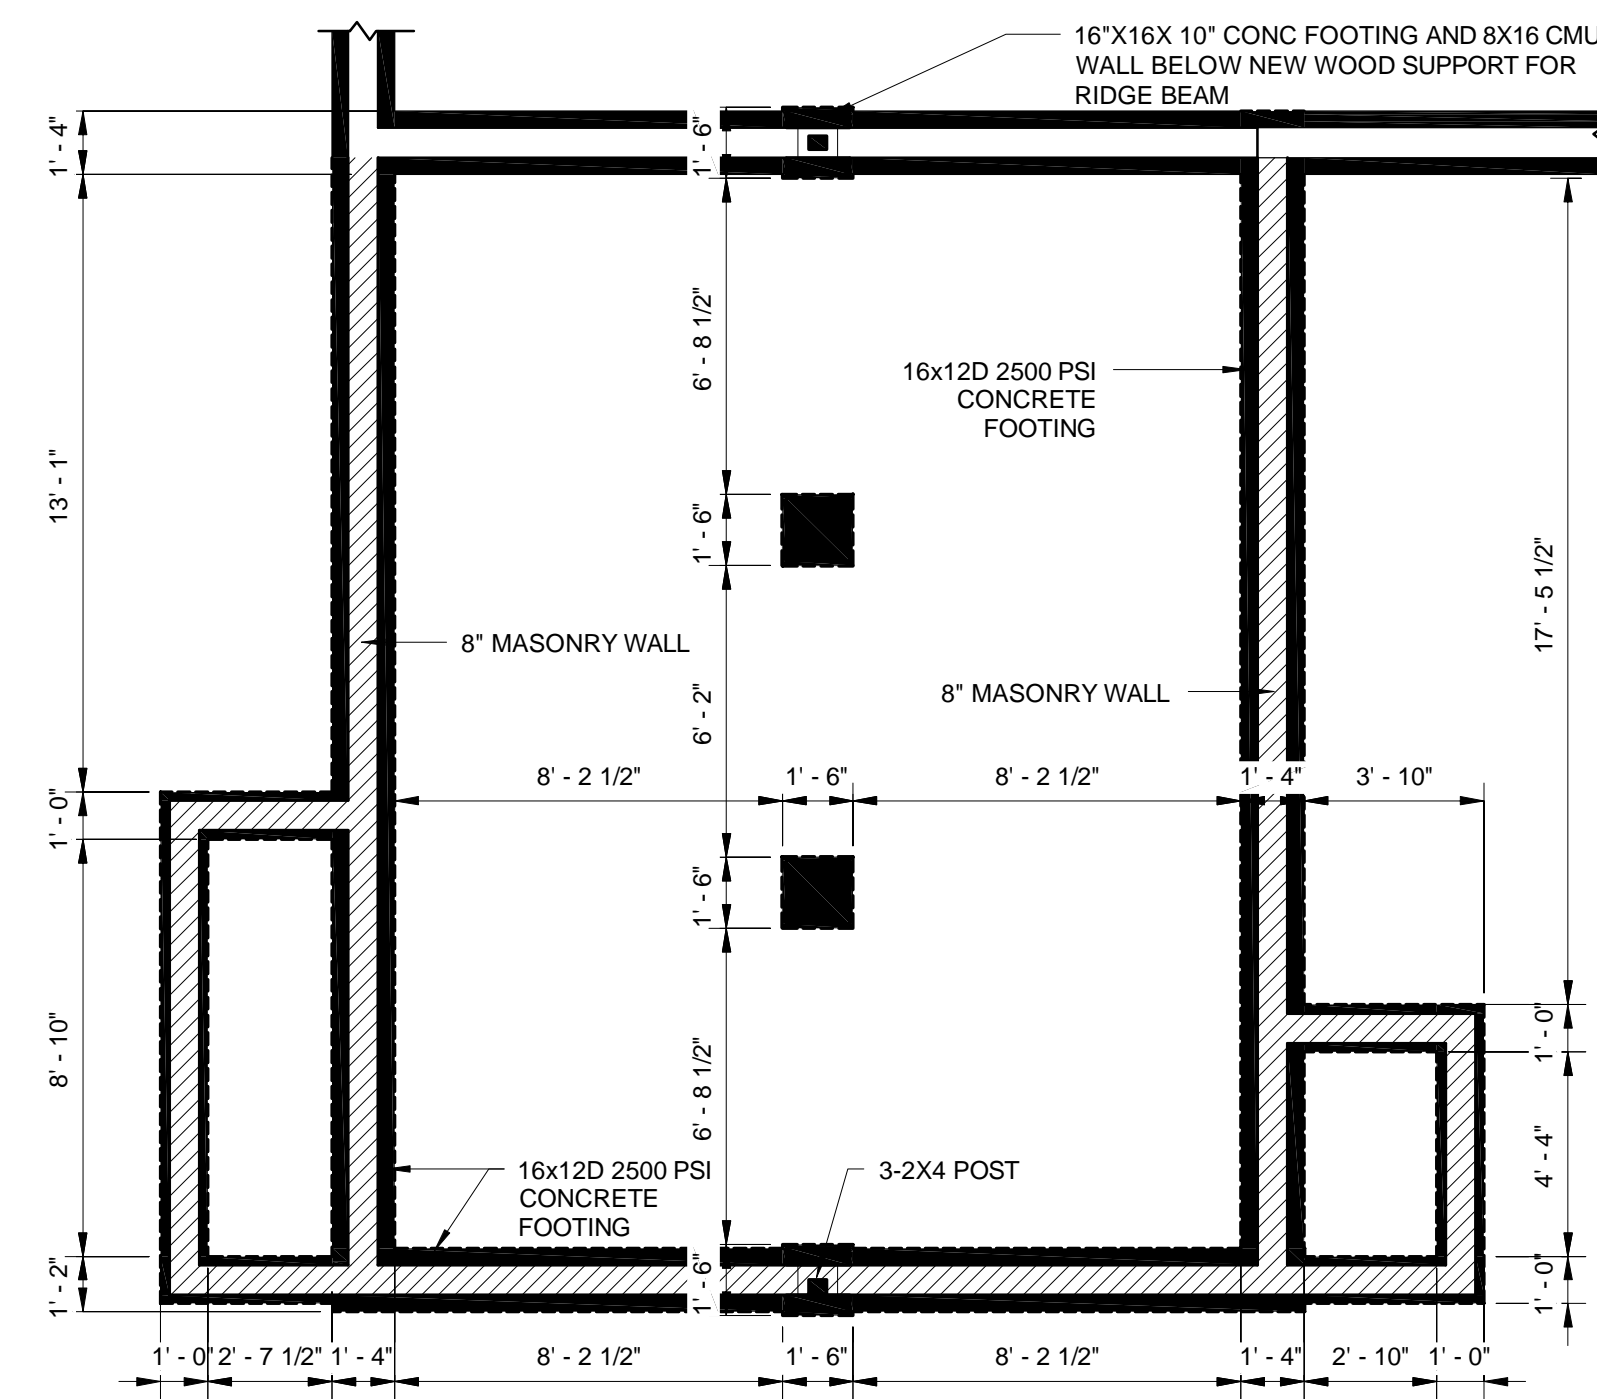

① FOUNDATION & STEMWALL PLAN STR  
1/4" = 1'-0"

② 1ST FLOOR FRAMING PLAN  
1/4" = 1'-0"



③ ROOF FRAMING PLAN  
1/4" = 1'-0"

WALL BRACING PLAN NOTES:



- ON PLAN DENOTES THE LOCATION OF BRACED WALL PANELS. STUD WALL AT BRACED WALL PANEL LOCATIONS SHALL BE A MIN. OF 2x4 SP#1/#2 AT 16" O.C. MAXIMUM, UNO. REFER TO SHEETS S4.0 FOR MORE INFO.
- ON PLAN DENOTES THE LOCATION OF BRACED WALL LINES. REFER TO SHEET S4.0 FOR MORE INFO.
- BRACED WALL PANELS SHALL BE CONNECTED TO FLOOR FRAMING PER SECTION R602.10.4.4 AND BRACED WALL PANELS SHALL BE CONNECTED TO ROOF FRAMING PER R602.10.4.5.

GENERAL FLOOR FRAMING PLAN NOTES:

- STRUCTURAL FLOOR MEMBERS SHALL NOT BE DRILLED OR NOTCHED IN EXCESS OF THE LIMITATIONS SPECIFIED IN R502.8
- WOOD STRUCTURAL PANELS USED FOR SUBFLOOR SHALL MEET THE REQUIREMENTS OF TABLE R503.2.1(1).
- STUDS AND DOUBLE TOP PLATE SHALL NOT BE DRILLED OR NOTCHED IN EXCESS OF THE LIMITATIONS SPECIFIED IN R602.6
- STRUCTURAL SHEATHING SHALL BE ATTACHED TO WALL STUDS PER TABLE R602.10.1

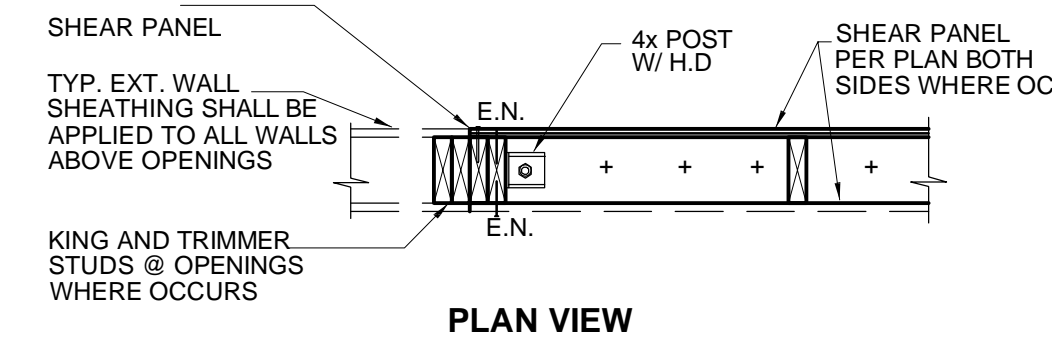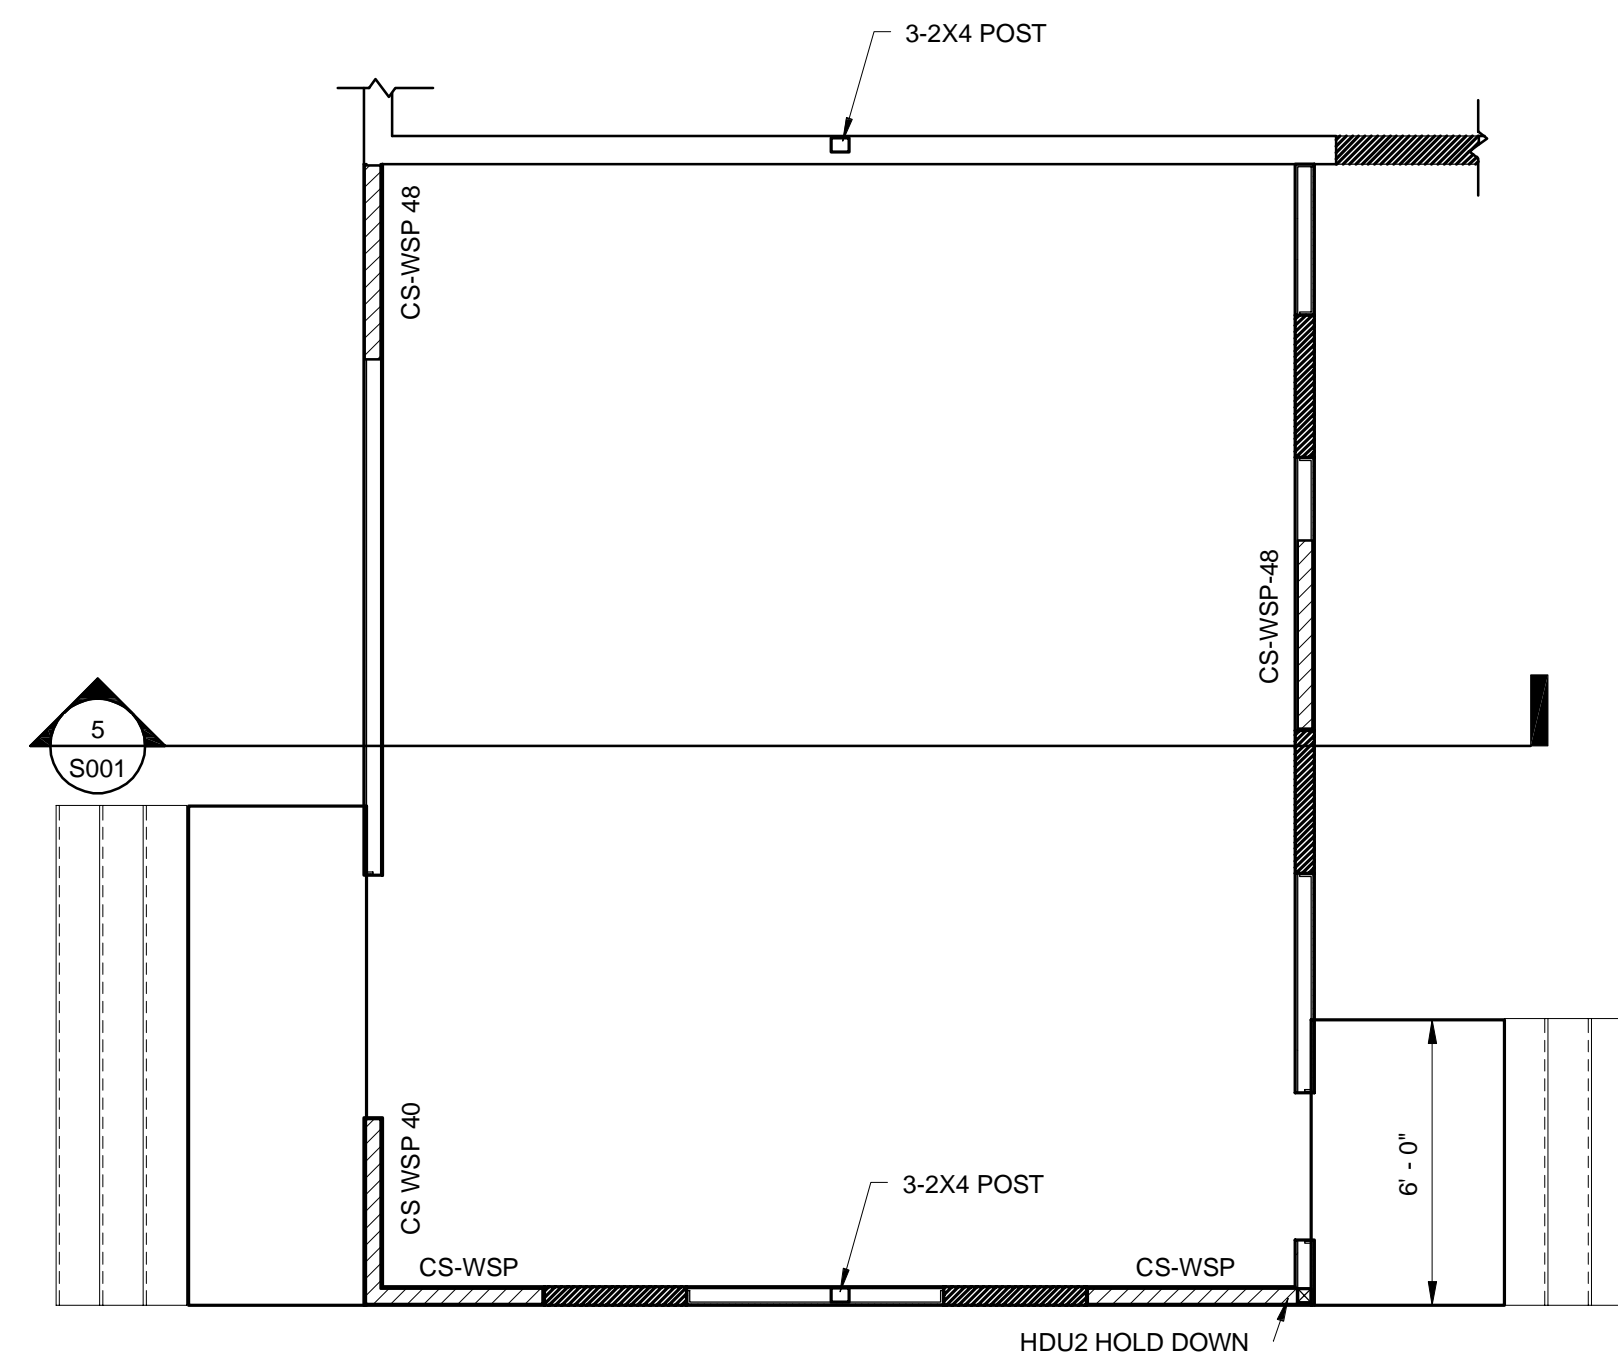

MODEL	BOLT (ASTM A36)	D
HDU2	5/8" Dx12 THREADED ROD	8"
HDU4	5/8" Dx12 THREADED ROD	12"

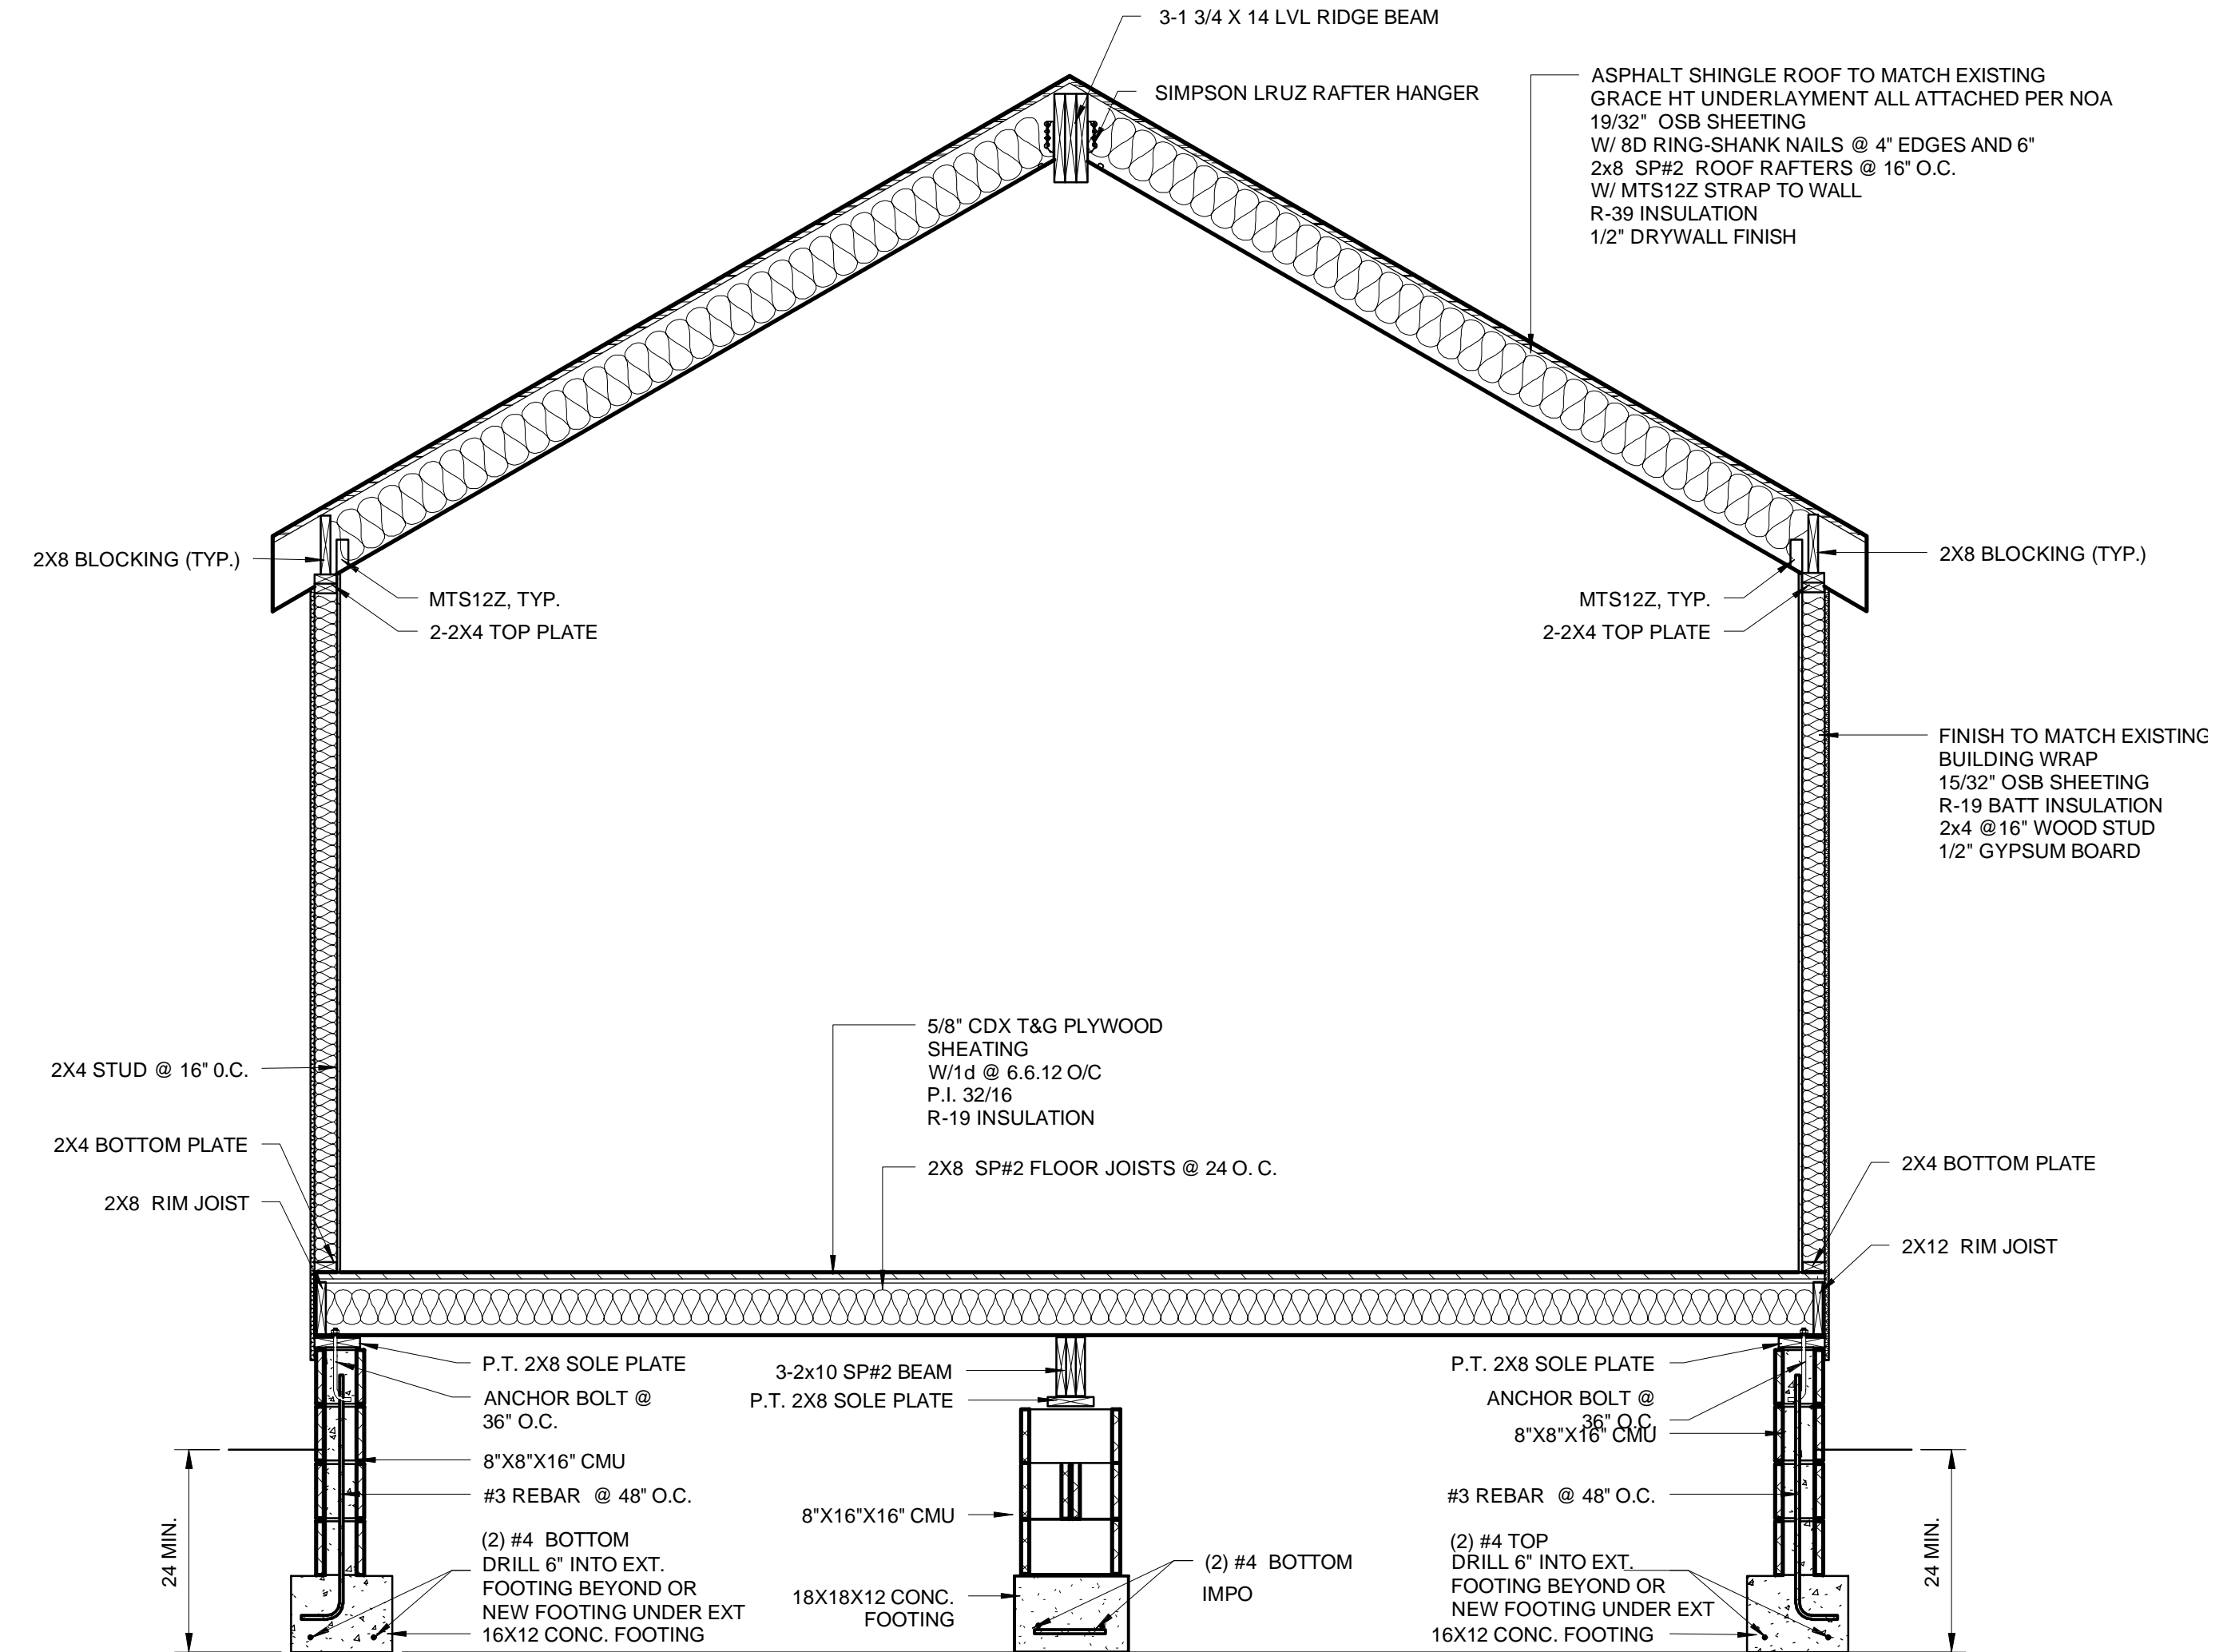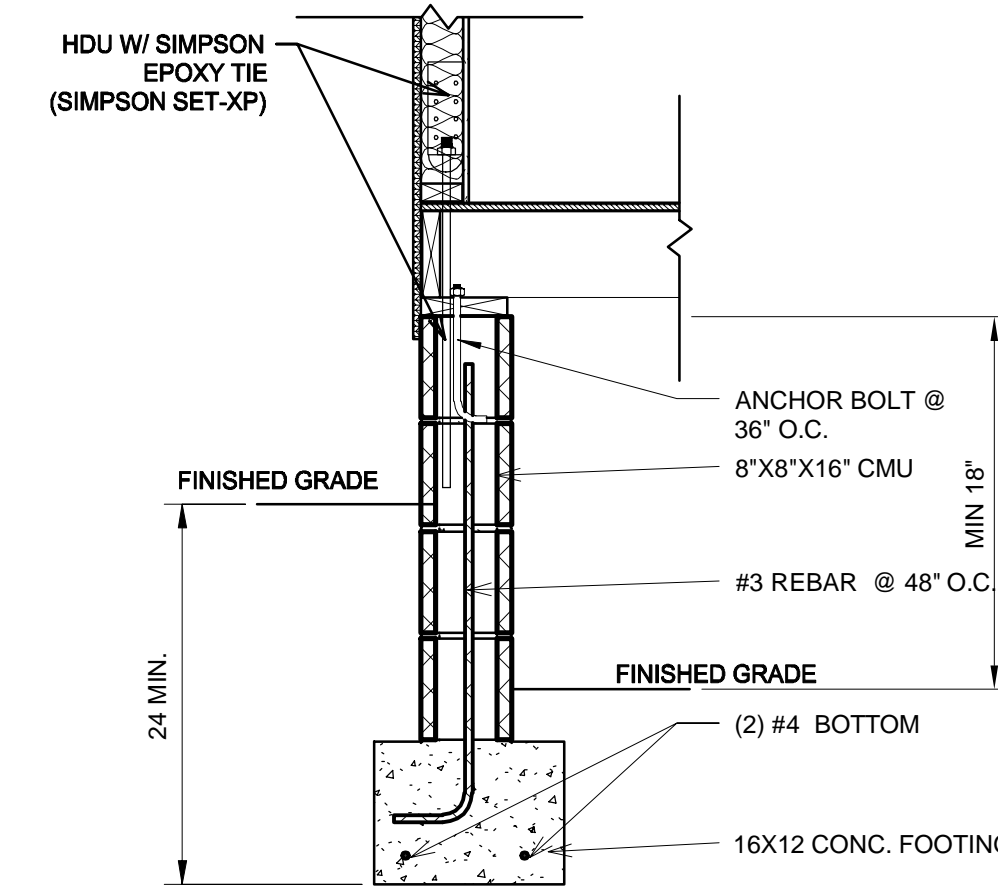

④ SHEAR WALL PLAN  
3/4" = 1'-0"

⑥ HOLDOWN INSTALLATION  
3/4" = 1'-0"

⑤ SECTION VIEW  
1/2" = 1'-0"

STRUCTURAL PLANS AND SECTIONS  
SINGLE FAMILY HOUSE  
272 Madison Ln  
Cameron, NC, 28326



**EQUAGEN®**  
ENGINEERS  
FIRM LIC. # 1869  
121 EDINBURGH SOUTH DR., STE 103  
CARY, NC 27511  
PHONE: 919.444.5442  
EMAIL: MOTI.KC@EQUAGEN.COM

DRAWN BY: DK  
CHECKED BY: MKC  
DATE: 01/24/2021  
SCALE: AS SHOWN

S002 21-2005

NO. DATE DESCRIPTIONS REVISIONS  
000 01/24/2021 Permit Submittal