BUILDER SHALL VERIFY ALL DIMENSIONS AND CONDITIONS AT TIME OF CONSTRUCTION.


ALL CONSTRUCTION SHALL CONFORM TO THE 2018 EDITION OF THE NC STATE BUILDING CODE.

CODES GOVERN OVER DRAWINGS.

DIMENSIONS GOVERN OVER SCALE.

VERIFY ALL MECHANICAL REQUIREMENTS BEFORE FRAMING.

VUNCANNON DESIGNS DOES NOT ASSUME LIABILITY FOR ANY DEVIATION OF OR CONSTRUCTION METHODS OF THESE PLANS.

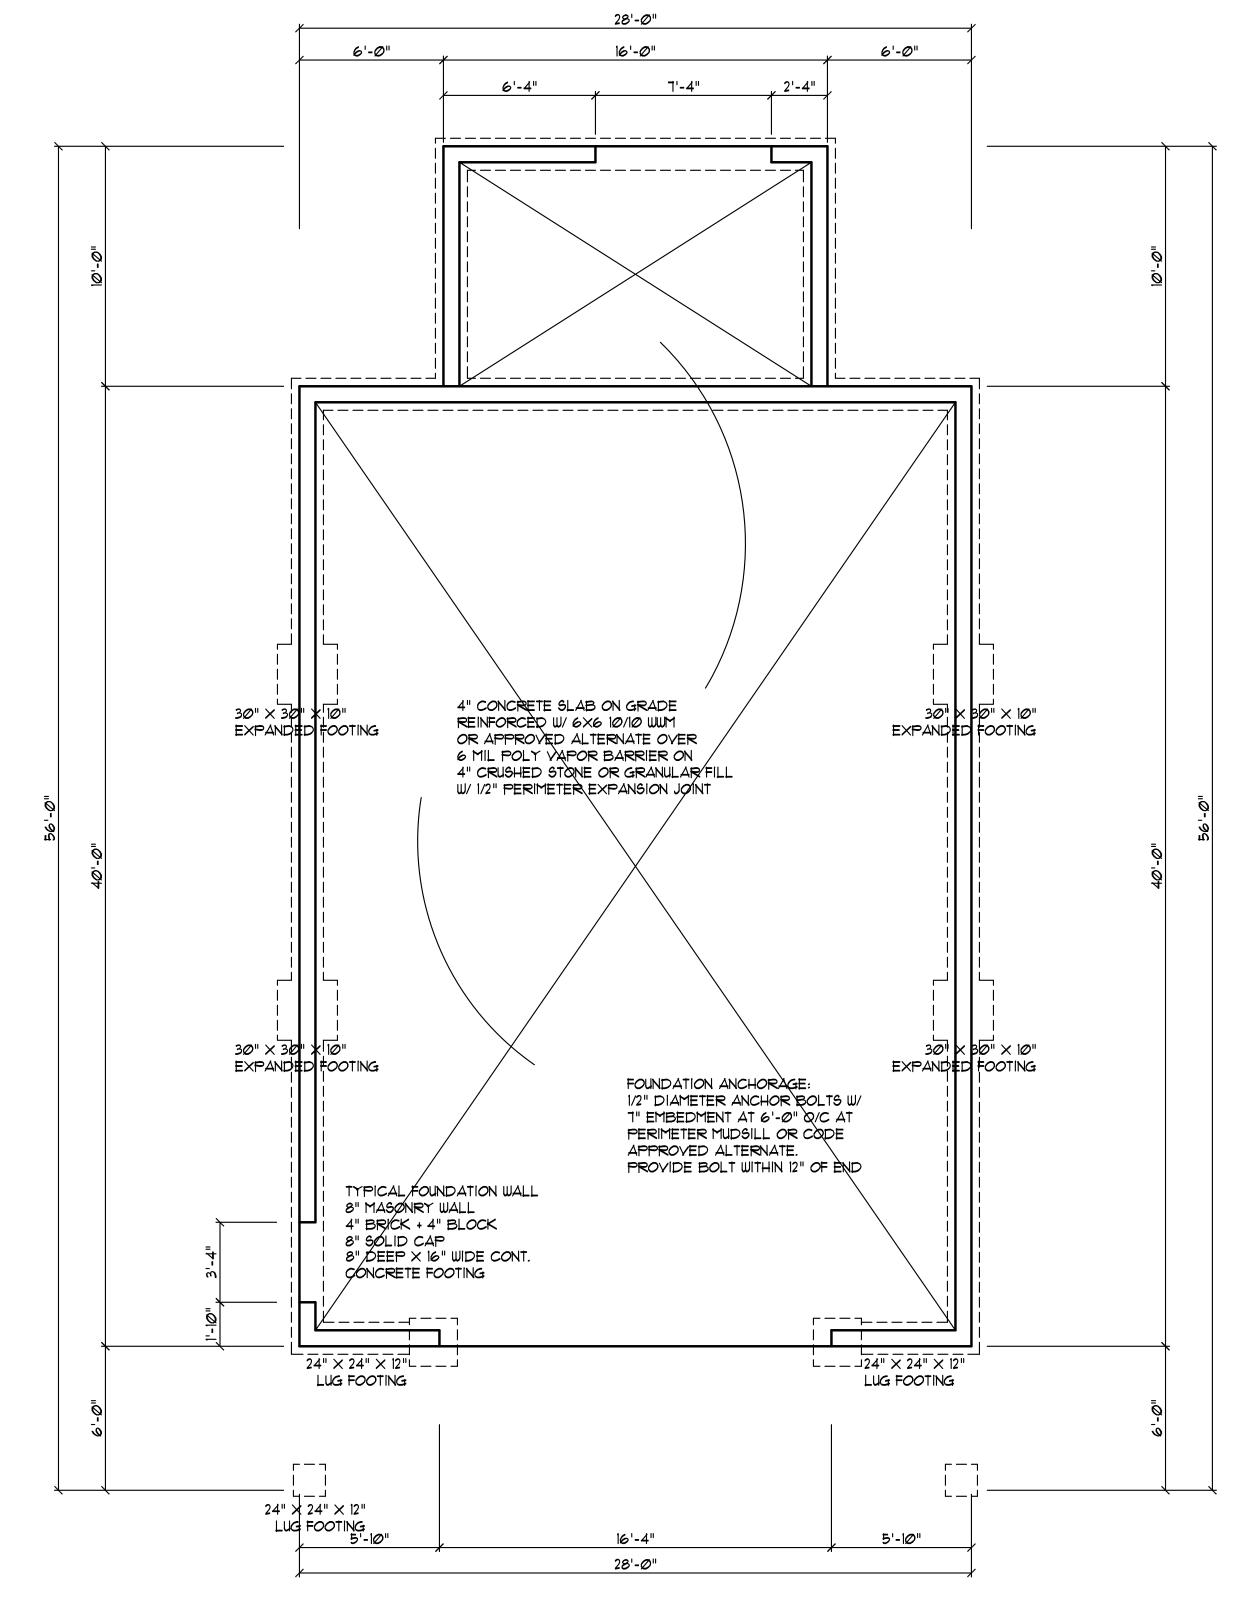

FOUNDATION PLAN

SCALE: 1/4" = 1'-0"

GENERAL FOUNDATION NOTES:

- 1. THIS PLAN DESIGNED IN ACCORDANCE WITH NC RESIDENTIAL CODE,
- 2018 EDITION.
 2. EXTERIOR WALL FOOTING WHERE NOTED TO BE 16" X 8" 3000 PSI
- STRUCTURAL CONCRETE UNLESS OTHERWISE NOTED. CONCRETE TO
- BE PREPARED AND PLACED IN ACCORDANCE WITH ACI 318. FOR
- FOUNDATION WALL HEIGHT, THICKNESS AND BACKFILL REQUIREMENTS,
- REFER TO STATE AND LOCAL BUILDING CODES. NOTE: ASSUMED SOIL
- BEARING CAPACITY=2000 PSF.
 CONTRACTOR MUST VERIFY
- CONDITIONS AND CONTACT SOIL ENGINEER IF MARGINAL OR UNSTABLE
- SOILS ARE ENCOUNTERED.

 3. FOOTINGS TO BEAR ON UNDISTURBED
- EARTH A MIN. OF 12" BELOW

 ADJACENT FINISH GRADE OR AS OTHERWISE

 DIRECTED BY LOCAL
- INSPECTOR.

 4. FOUNDATION DRAINAGE SHALL BE IN
- ACCORDANCE WITH SECTION
 R405 OF THE CODE "FOUNDATION"
- DRAINAGE".
 5. THE FOUNDATION SHALL BE TREATED IN
- ACCORDANCE W/SECTION
- R406 OF THE CODE *FOUNDATION WATERPROOFING AND
- DAMPPROOFING".
 6. THIS FOUNDATION DESIGN IS VALID FOR
- 100 MPH WIND ZONES ONLY.
 7351BOUNDAETORALWANELS. SCHADL REFLEECHBLIOCK27614
 UNLESS NOTED

BRACED WALL NOTES:

OTHERWISE.

- 1. BRACED WALLS ARE REQUIRED PER SECTION R602.10.1 2018 NCBC RESIDENTIAL CODE.
- 2. THE EXTERIOR WALL STRUCTURE SHALL BE CONTINUOUSLY SHEATHED, FULL HEIGHT WITH MIN. THICKNESS 7/16" OSB. THESE WALLS SHALL BE CONSTRUCTED IN CONFORMANCE TO TYPE CS-WSP DETAILS.
- 3. BASIS OF DESIGN FOR INTERIOR BRACE WALLS IS LIB (LET IN BRACING) METHOD AS DETAILED PER CODE TABLE R602.10.2.
- 4. SPECIAL BRACING DETAILS ARE ILLUSTRATED IN THE CODE AND ALLOWED WHERE WALLS DO NOT MEET THE MINIMUM REQUIREMENTS FOR SUPPORT. REFER TO GARAGE OPENING, PORTAL FRAMING DETAILS.

STRUCTURAL EVALUATION BY:


HOWERTON SERVICES, PLLC

LICENSE P-1716

- * ENGINEER'S SEAL APPLIES ONLY TO STRUCTURAL COMPONENTS ON THIS DOCUMENT. SEAL DOES NOT INCLUDE CONSTRUCTION REVIEW, MEANS, METHODS, TECHNIQUES, SEQUENCES, PROCEDURES OR SAFETY PRECAUTIONS.
- * ANY DEVIATIONS OR DISCREPANCIES ON PLANS ARE TO BE BROUGHT TO IMMEDIATE ATTENTION OF THE ENGINEER. FAILURE TO DO SO WILL VOID ENGINEER'S LIABILITY.
- * DO NOT SCALE THESE DRAWINGS ENGINEERING APPROVAL EXPIRES 04/01/2021





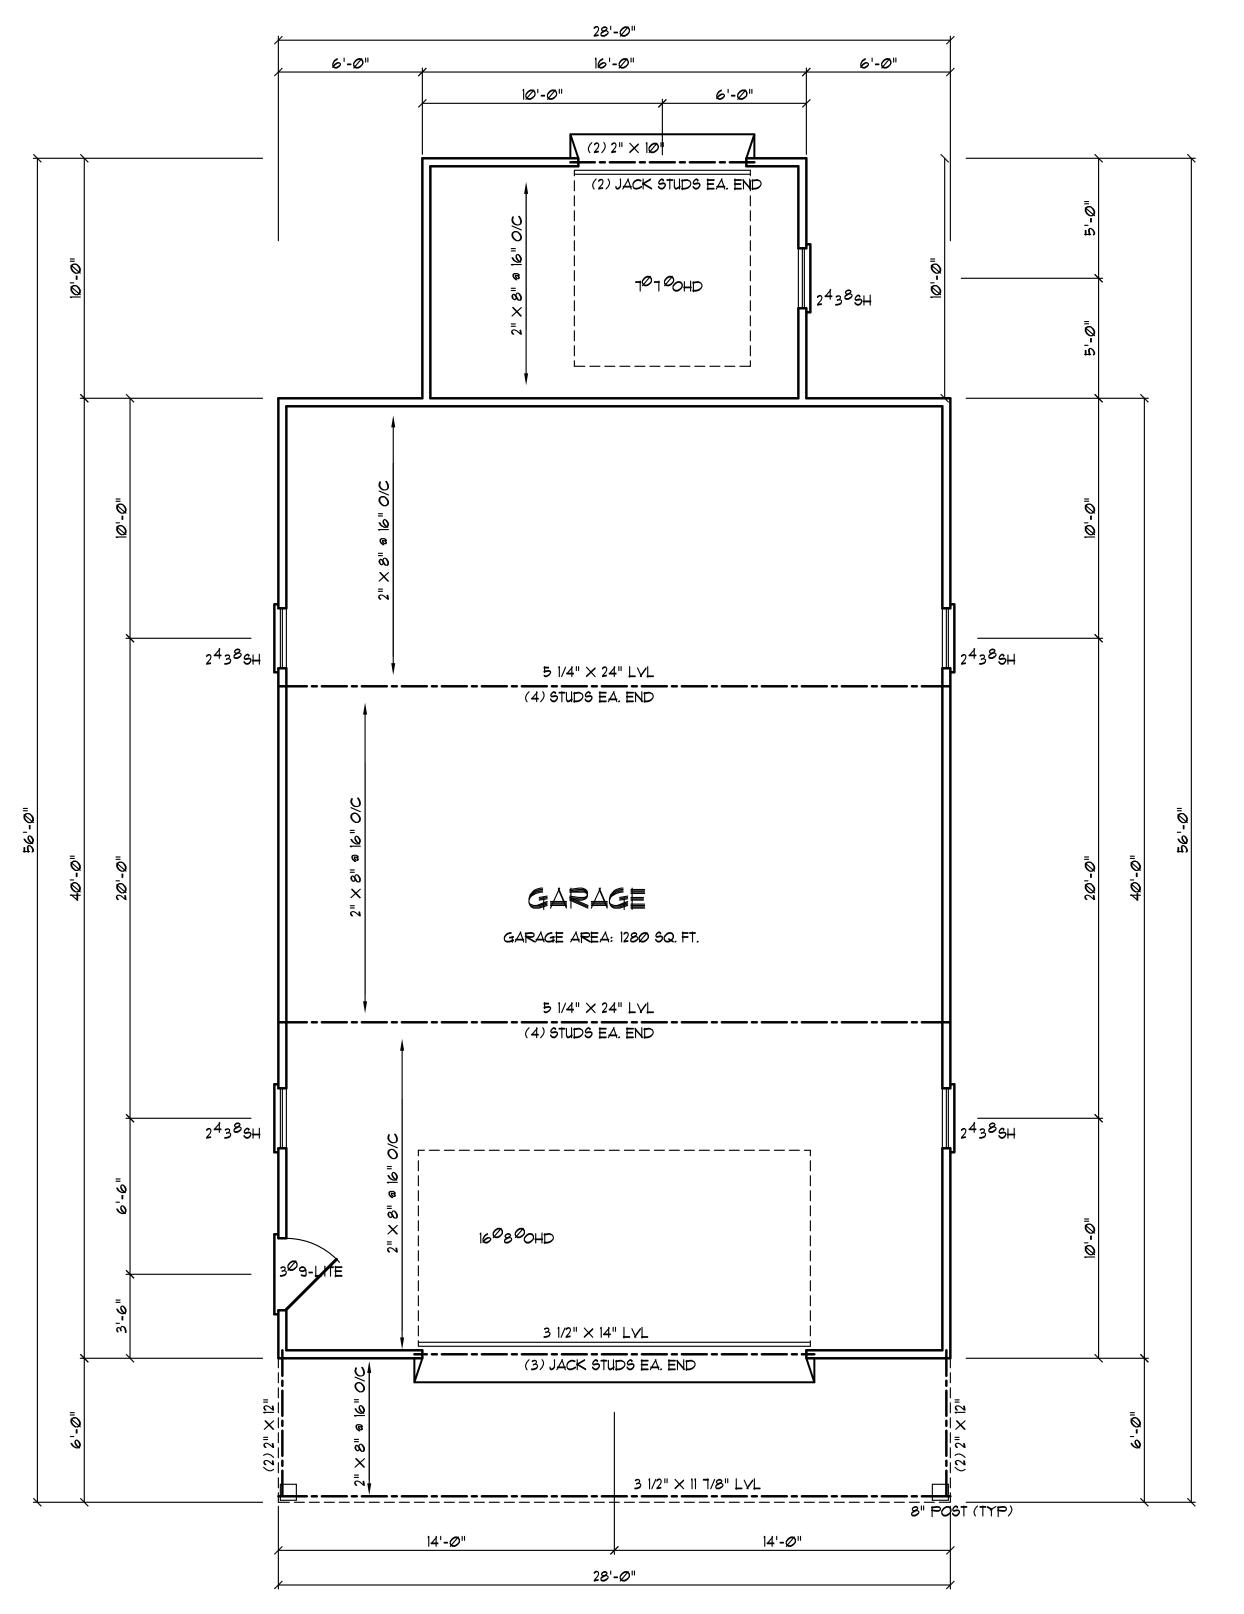

WALL BRACING FOR THE GARAGE DOORS WILL BE DONE USING PFG METHOD IN ACCORDANCE WITH FIGURE 602.10.3.4 OF THE NORTH CAROLINA BUILDING CODE FOR RESIDENCES. #LOOR PLAN 9CALE: 1/4" = 1'-0" DRAWN BY : WRY
CHK'D BY : WRY
DATE : 03/17/20
REVISIONS :

T

 $\overline{\mathbf{0}}$

Щ

Q

SHEET

A = 1

BUILDER SHALL VERIFY ALL DIMENSIONS AND CONDITIONS AT TIME OF CONSTRUCTION.

ALL CONSTRUCTION SHALL CONFORM TO THE 2018 EDITION OF THE NC STATE BUILDING CODE.

CODES GOVERN OVER DRAWINGS.

DIMENSIONS GOVERN OVER SCALE.

VERIFY ALL MECHANICAL REQUIREMENTS BEFORE FRAMING.

VUNCANNON DESIGNS DOES NOT ASSUME LIABILITY FOR ANY DEVIATION OF OR CONSTRUCTION METHODS OF THESE PLANS.

GENERAL FRAMING NOTES:

- THIS PLAN DESIGNED IN ACCORDANCE WITH NC RESIDENTIAL CODE, 2018 EDITION.
 GLAZING AREAS SHOWN ON THESE DESIGN DRAWINGS DO NOT EXCEED 15% OF THE GROSS AREA OF THE EXTERIOR WALLS. THIS STRUCTURE MEETS THE REQUIREMENTS OF N1101.2.1, RESIDENTIAL BUILDING, TYPE A-1.
- 3. WALL CLADDING IS DESIGNED FOR A 24.1 #/SF OR GREATER POSITIVE/NEGATIVE PRESSURE.
- 4. ALL WALLS, FLOORS AND CEILINGS SHALL BE INSULATED IN ACCORDANCE WITH PART IV, ENERGY CONSERVATION, CHAPTER 11, ENERGY EFFICIENCY OF THE CODE FOR ZONE 7 (TABLE N1101.2).

5. DESIGN CRITERIA 10 PSF 40 PSF PRIMARY FLOOR 10 PSF 40 PSF SECONDARY FLOOR 10 PSF 10 PSF 10 PSF SLEEPING AREAS 30 PSF 20 PSF ATTIC ROOF 20 PSF 100 MPH DEFLECTION LIMITS FLOOR - L/360

- (LIVE LOAD ONLY) ROOF L/240
- 6. ALL HEADERS IN LOAD BEARING WALLS SHALL BE DOUBLE 2X10.
- 7. ALL WALLS ARE 2X4 0 16" O.C. UNLESS OTHERWISE NOTED.
- 8. FLOOR INSULATION = R-19, EXTERIOR =R-15 AND CEILING = R-38.
- 9. PROVIDE DOUBLE FLOOR JOISTS OR TRUSS UNDER WALLS ABOVE.

R602.7.5 SUPPORTS FOR HEADERS:

HEADERS SHALL BE SUPPORTED ON EACH END WITH ONE OR MORE JACK STUDS OR WITH APPROVED FRAMING ANCHORS IN ACCORDANCE WITH TABLE R602.7(1) OR R602.7(2). THE FULL—HEIGHT STUD ADJACENT TO EACH END OF THE HEADER SHALL BE END NAILED TO EACH END OF THE HEADER WITH FOUR—16D NAILS (3.5 INCHES X 0.135 INCHES). THE MINIMUM NUMBER OF FULL—HEIGHT STUDS AT EACH END OF A HEADER SHALL BE IN ACCORDANCE WITH TABLE R602.7.5.

TABLE R602.7.5

MINIMUM NUMBER OF FULL-HEIGHT STUDS AT EACH END OF HEADERS IN EXTERIOR WALLS

HEADER SPAN	MAXIMUM STUD SPACING (INCHES) PER TABLE R602.3(5)	
	16	24
LESS THAN/EQUAL TO 3'	1	1
4	2	1
8'	3	2
12'	5	3
16'	6	4
••	•	•


STRUCTURAL EVALUATION BY:


HOWERTON SERVICES, PLLC 3513 CATHEDRAL BELL ROAD RALEIGH, NC 27614 LICENSE P-1716

* ENGINEER'S SEAL APPLIES ONLY TO STRUCTURAL COMPONENTS ON THIS DOCUMENT. SEAL DOES NOT INCLUDE CONSTRUCTION REVIEW, MEANS, METHODS, TECHNIQUES, SEQUENCES, PROCEDURES OR SAFETY PRECAUTIONS.


* ANY DEVIATIONS OR DISCREPANCIES ON PLANS ARE TO BE BROUGHT TO IMMEDIATE ATTENTION OF THE ENGINEER. FAILURE TO DO SO WILL VOID ENGINEER'S LIABILITY.

* DO NOT SCALE THESE DRAWINGS — ENGINEERING APPROVAL EXPIRES 04/01/2021

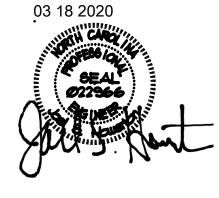

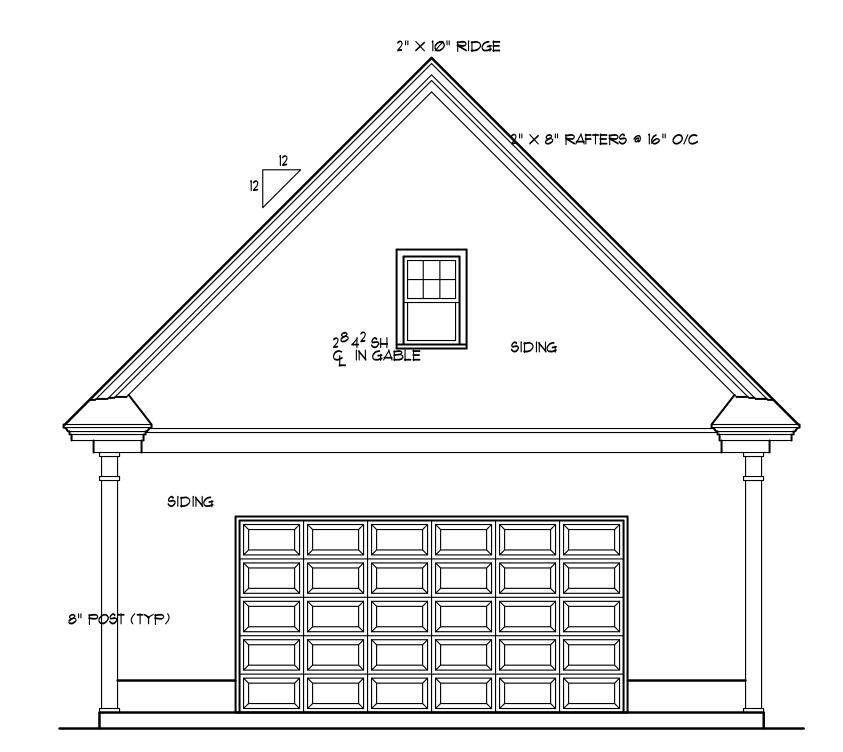



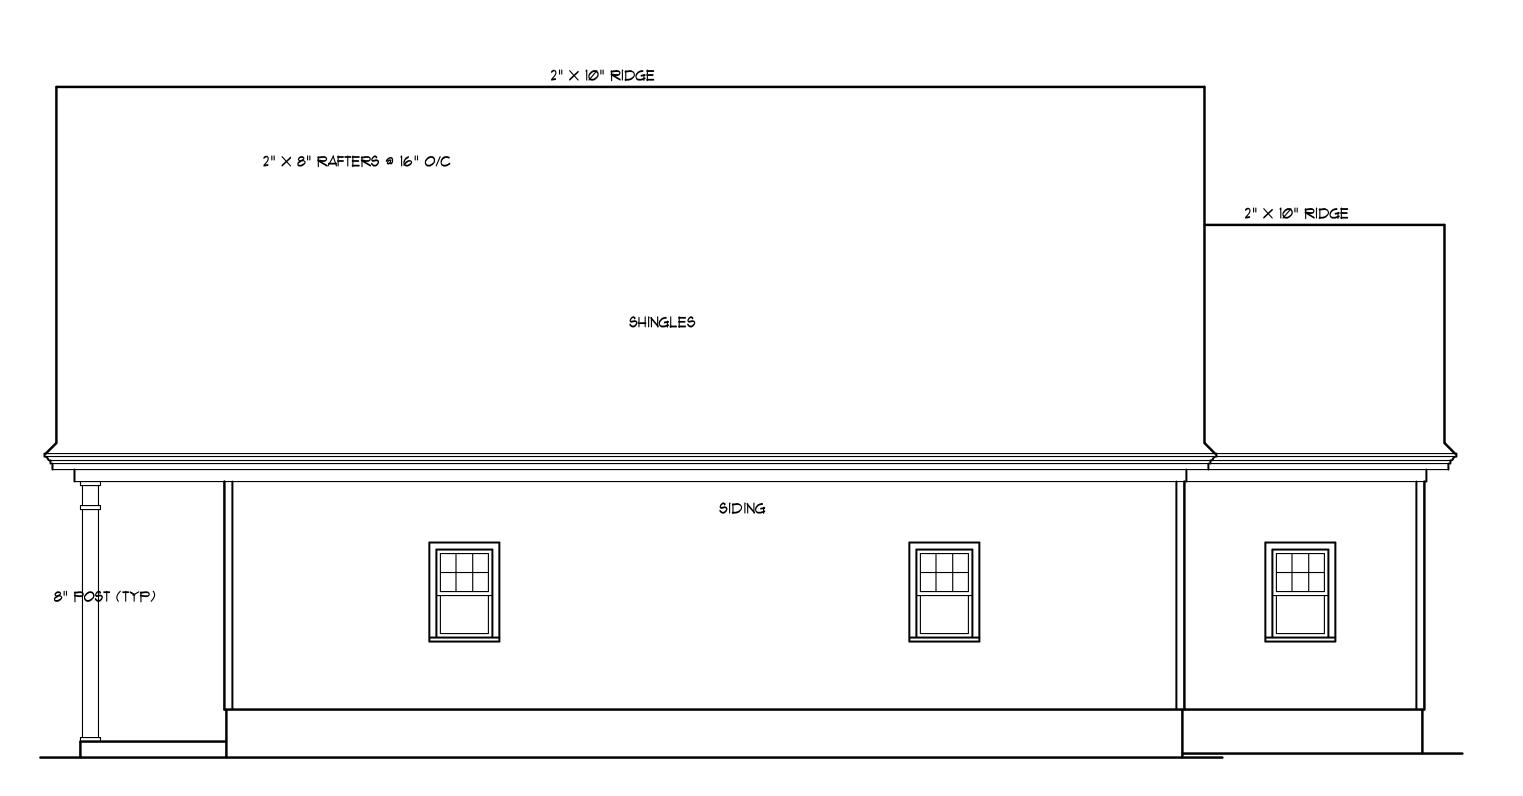

TILTON BUILT HOMES

CANNON DESIGNS
CUSTOM HOME PLANS

DRAWN BY: WRY
CHK'D BY: WRY
DATE: Ø3/17/20
REVISIONS:

SHEET $\triangle = 2$