

Approved

button 10/10/2018



Carolina Carports, Inc.

STRUCTURAL DESIGN

ENCLOSED BUILDING

MAXIMUM 30'-0" WIDE X 20'-0" EAVE HEIGHT- BOX EAVE FRAME AND BOW FRAME

15 January 2018 Revision 7 M&A Project No. 15156S, 16135S & 17324S

HARNETT SOUNTY CENTRAL PERMITTING APPLICATION # BRESISIO 0007

DATE PLANS RECEIVED

SITE PLANS APPROVED

APPROVED BY_

Prepared for:

Carolina Carports, Inc. 187 Cardinal Ridge Trail Dobson, NC 27017

Prepared by:

Moore and Associates Engineering and Consulting, Inc. 1009 East Avenue

North Augusta, SC 29841

401 S. Main Street, Suite 200 Mount Airy, NC 27030







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MOORE AND ASSOCIATES	DRAVN BY: JRS		ROLINA CARP CARDINAL RI	DGE TRAIL
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INSTALLATION NOTES AND SPECIFICATIONS

- 1 DESIGN IS FOR MAXIMUM 30'-0" WIDE x 20'-0" EAVE HEIGHT ENCLOSED STRUCTURES
- 2 DESIGN WAS DONE IN ACCORDANCE WITH THE 2017 FLORIDA BUILDING CODE (FBC) 6TH EDITION. 2012 NORTH CAROLINA BUILDING CODE. 2006 INTERNATIONAL BUILDING CODE (IBC) 2009 IBC 2012 IBC AND 2015 IBC
- 3 DESIGN LOADS ARE AS FOLLOWS
 - A) DEAD LOAD
- = 15 PSF = 12 PSF
- B) LIVE LOAD C) GROUND SNOW LOAD
- = 30 PSF (< 24'), 35 PSF (24' (W < 36'), 35 PSF @ 4'-0' DC SPACING (< 24') (MAXIMUM 45 PSF FOR EXPOSURE B AND 55 PSF FOR EXPOSURE C AT 4'-0' DC SPACING)
- 4 LOW ULTIMATE WIND SPEED (LW) 105 TO 140 MPH (NOMINAL WIND SPEED 81 TO 108 MPH) MAXIMUM RAFTER/POST AND END POST SPACING = 50 FEET
- 5 HIGH ULTIMATE WIND SPEED (HW) 141 TO 170 MPH (NOMINAL WIND SPEED 109 TO 132 MPH) MAXIMUM RAFTER/POST AND END POST SPACING = 40 FEET
- 6 RISK CATEGORY [
- 7 WIND EXPOSURE CATEGORY B OR C
- 8 SPECIFICATIONS APPLICABLE TO 29 GAUGE METAL PANELS FASTENED DIRECTLY TO 2 1/2" x 2 1/2" 14 GAGE TUBE STEEL (TS) FRAMING MEMBERS CUNLESS NOTED OTHERWISE)
- 9 AVERAGE FASTENER SPACING ON-CENTERS ALONG RAFTERS OR HAT CHANNELS AND COLUMNS (INTERIOR OR END) = 8" DC (MAX) 6' DC (MAX) FOR HIGH WIND APPLICATIONS
- IG FASTENERS CONSIST OF #12-14x3/4" SELF-DRILLING FASTENER (SDF) USE CONTROL SEAL WASHER WITH EXTERIOR FASTENERS
 SPECIFICATIONS APPLICABLE ONLY FOR MEAN ROOF HEIGHT OF 20 FEET OR LESS AND ROOF SLOPES OF 14" (3:12 PITCH) OR LESS SPACING
 REQUIREMENTS FOR OTHER ROOF HEIGHTS AND/OR SLOPES MAY VARY
- 11 ANCHORS SHALL BE INSTALLED THROUGH BASE RAIL WITHIN 6° OF EACH RAFTER COLUMN ALONG SIDES
- 12 CROUND ANCHORS (SOIL NAILS) CONSIST OF #4 REEAR W/ WELTET NUT x 30° LONG IN SUITABLE SOIL CONDITIONS OPTIONAL ANCHORAGE MAY BE USED IN SUITABLE SOILS AND MUST BE USED IN UNSUITABLE SOILS AS NOTED NOT ALLOWED FOR HIGH WIND APPLICATION
- 13 WIND FORCES GOVERN OVER SEISMIC FORCES SEISMIC PARAMETERS ANALYZED ARE

SOIL SITE CLASS = E RISK CATEGORY INIVIII

R= 325

IE= 10 v= csw

SES= 1588

S_{E1}= C 639

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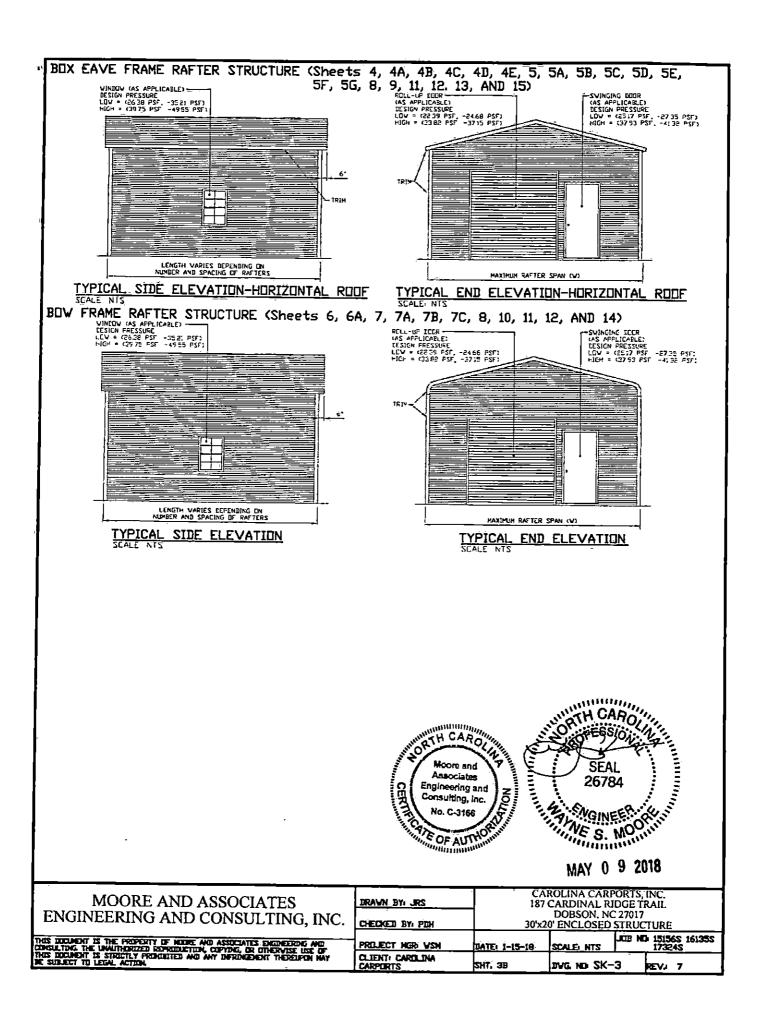
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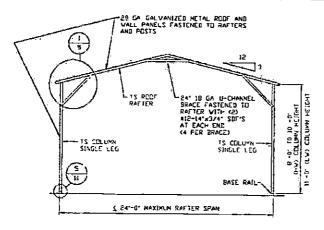
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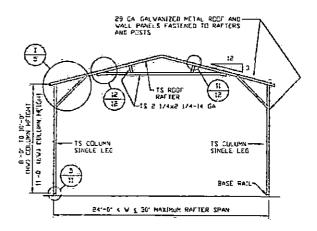
DRAVN BY: JRS	CAROLINA CARPORTS, INC. 187 CARDINAL RIDGE TRAIL
CLECKED BY ONL	DOBSON, NC 27017

CHECKED BY: PDH 30'x20' ENCLOSED STRUCTURE JOB ND 15156S 16135S 17324S PROJECT MGR VSH DATE: 1-15-18 SCALE NTS

CLIENT: CARILINA CARPORTS SHT. 3A DAC NO 2K-3 REV. 7








TYPICAL RAFTER/COLUMN END FRAME SECTION

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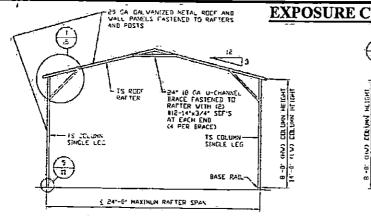


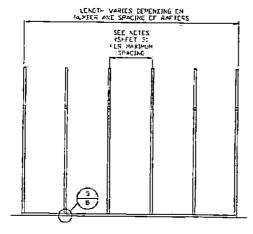
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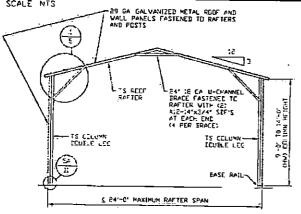


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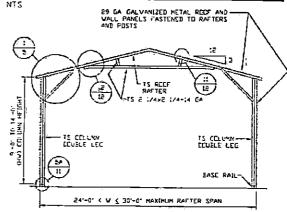




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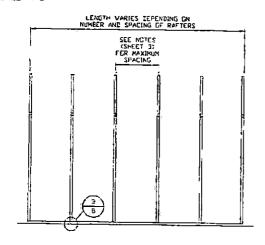


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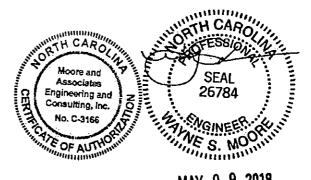

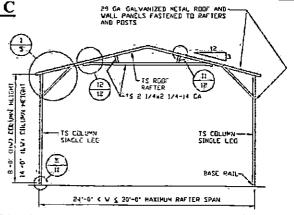
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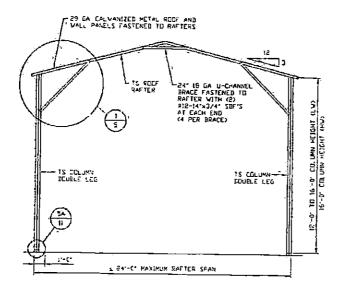


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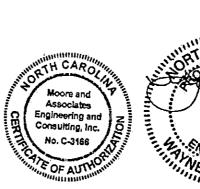
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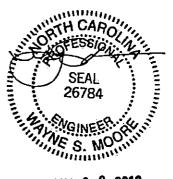


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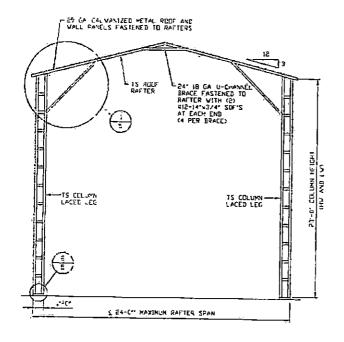
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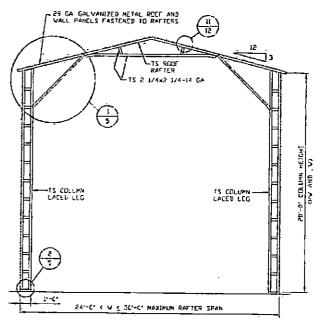
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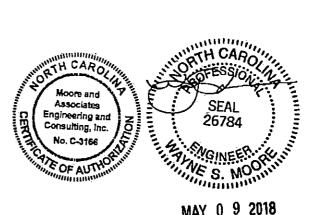
ENGINEERING AND CONSULTING INC	DRAWN BY: JRS	CAROLINA CARPORTS, INC. 187 CARDINAL RIDGE TRAIL			
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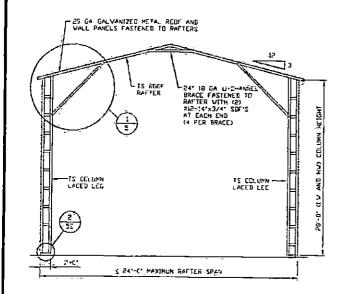
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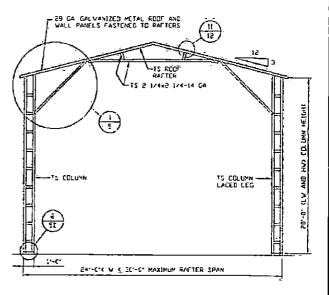


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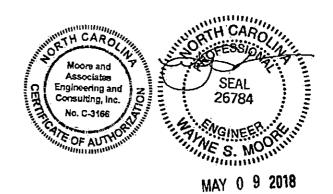
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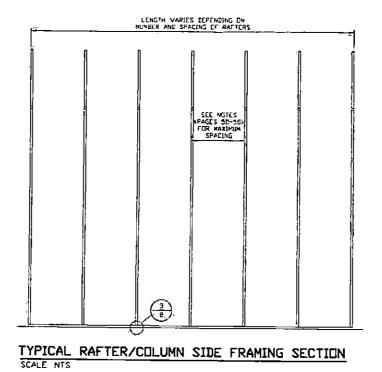
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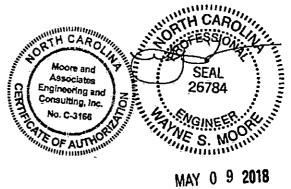


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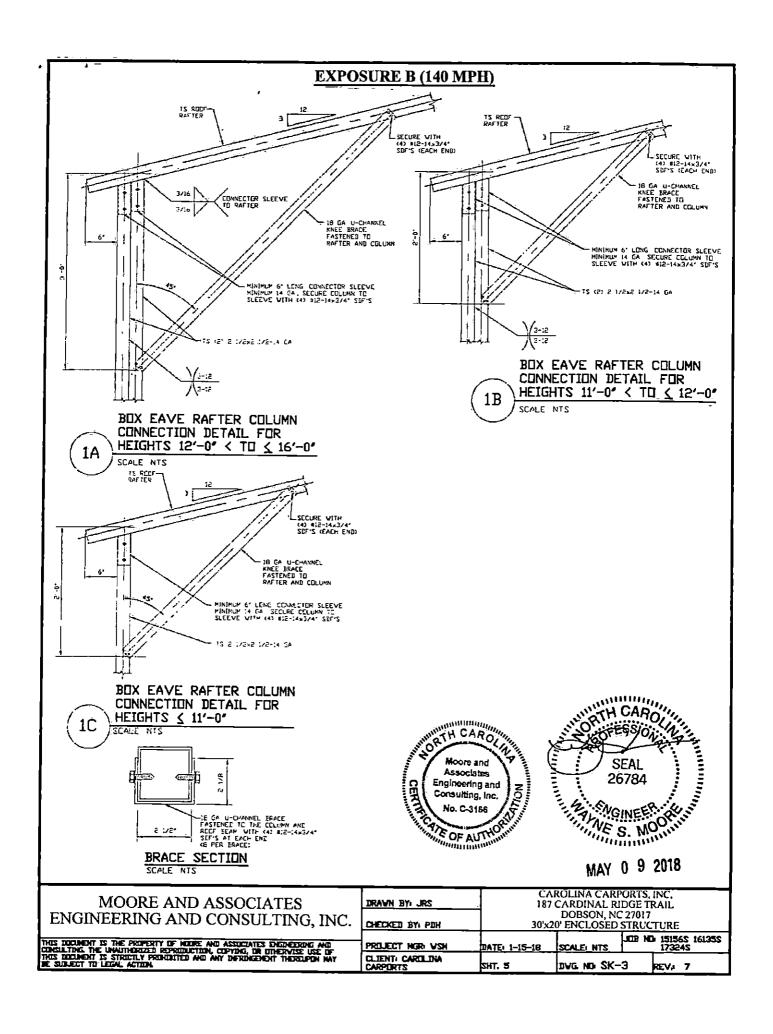



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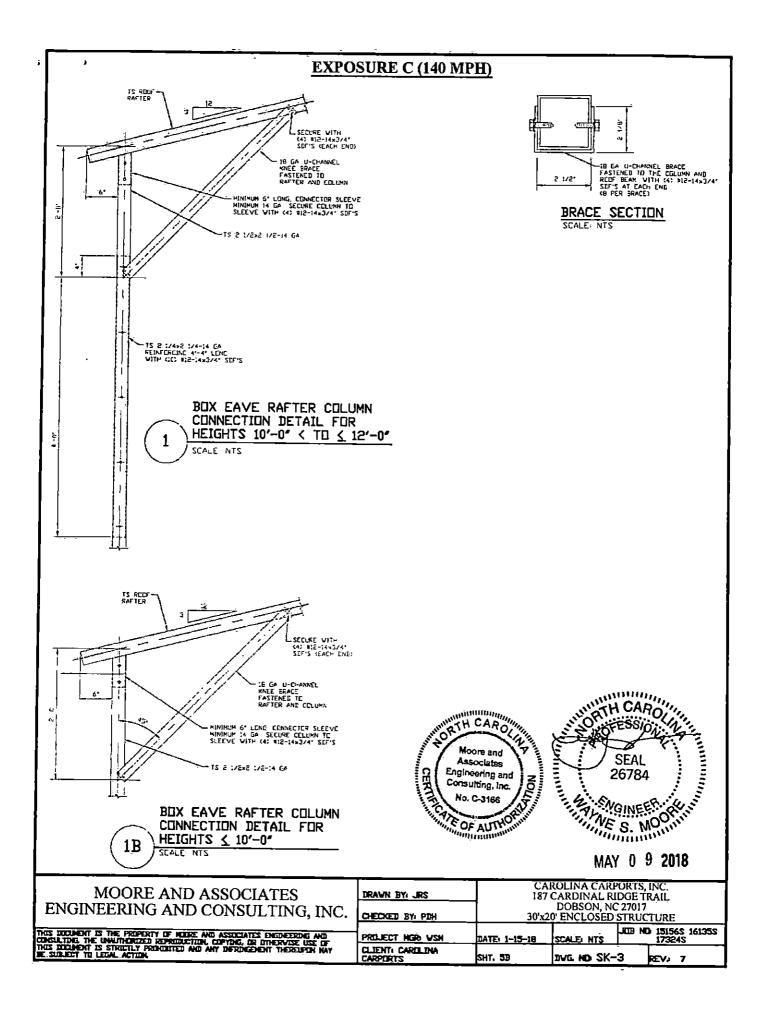






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ENGINEERING AND CONSULTING, INC.	CHECKET BY: PDH	30'x2	DOBSON, NO D' ENCLOSED		
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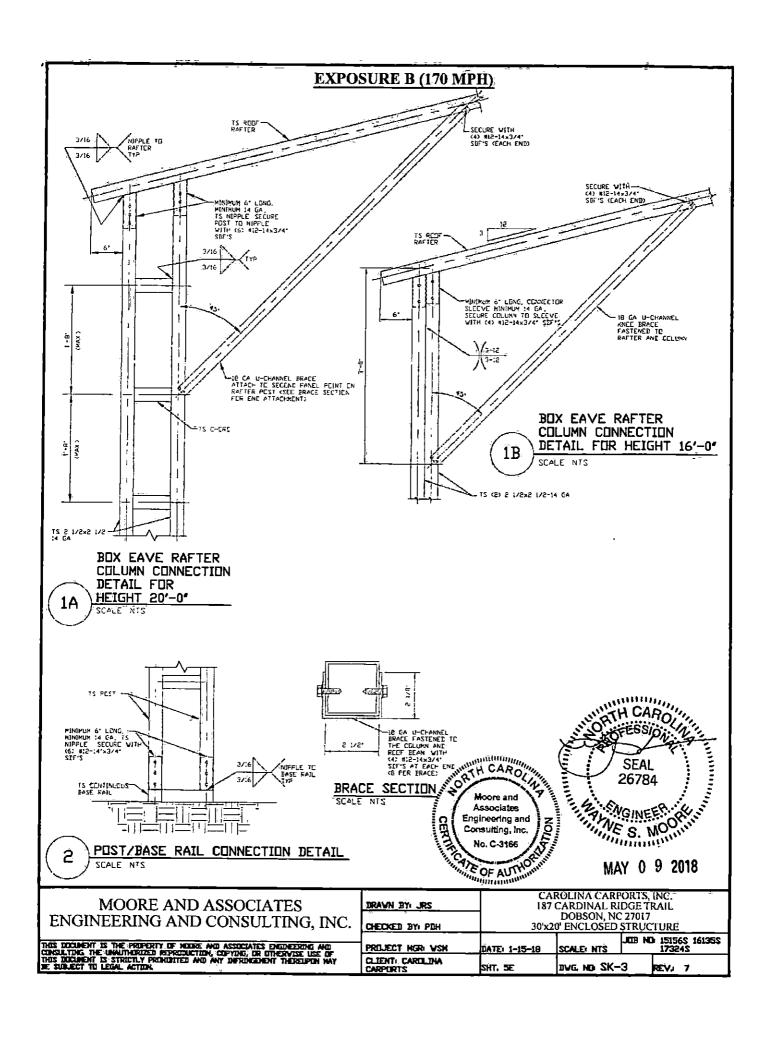








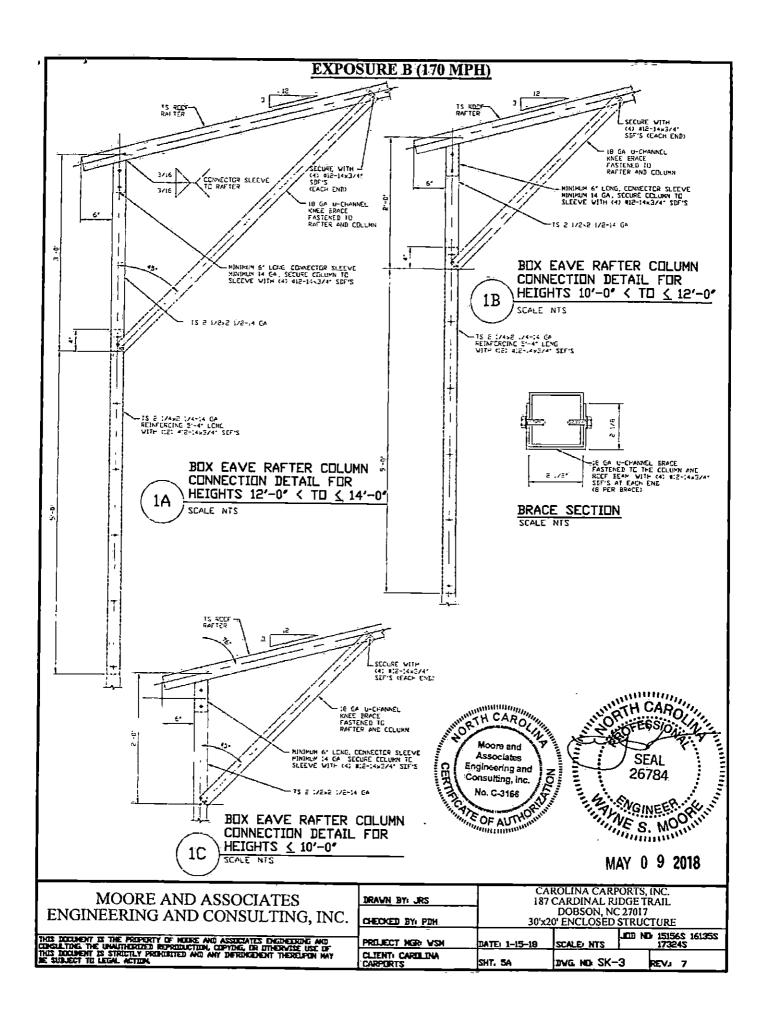


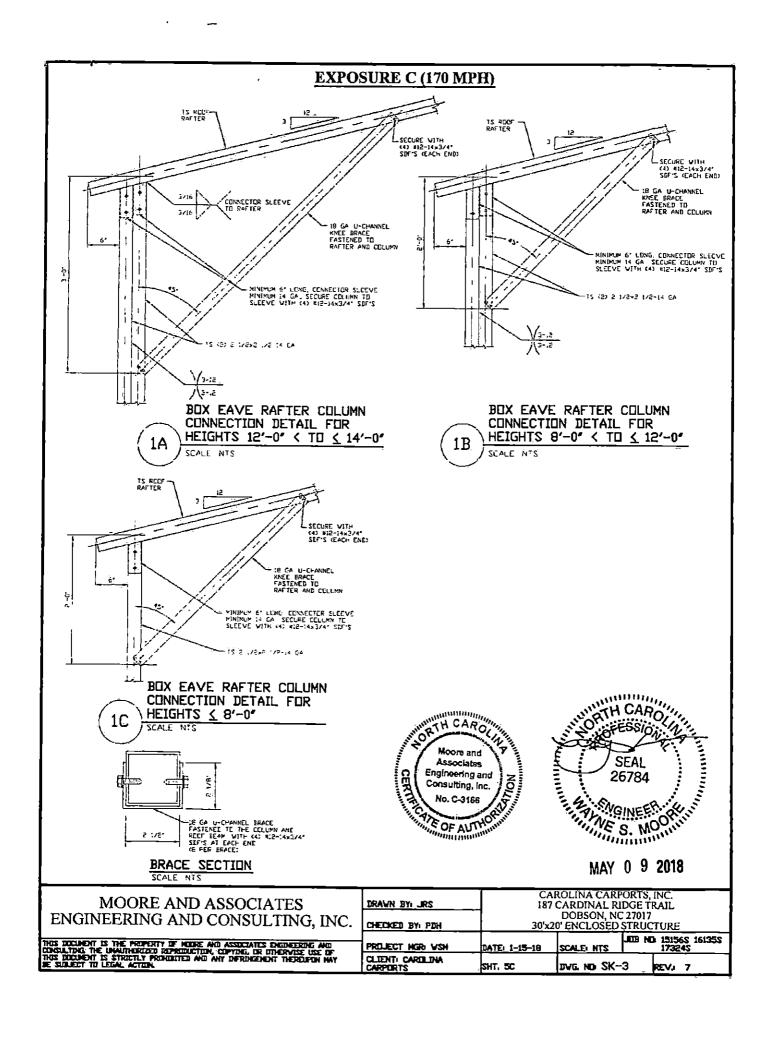


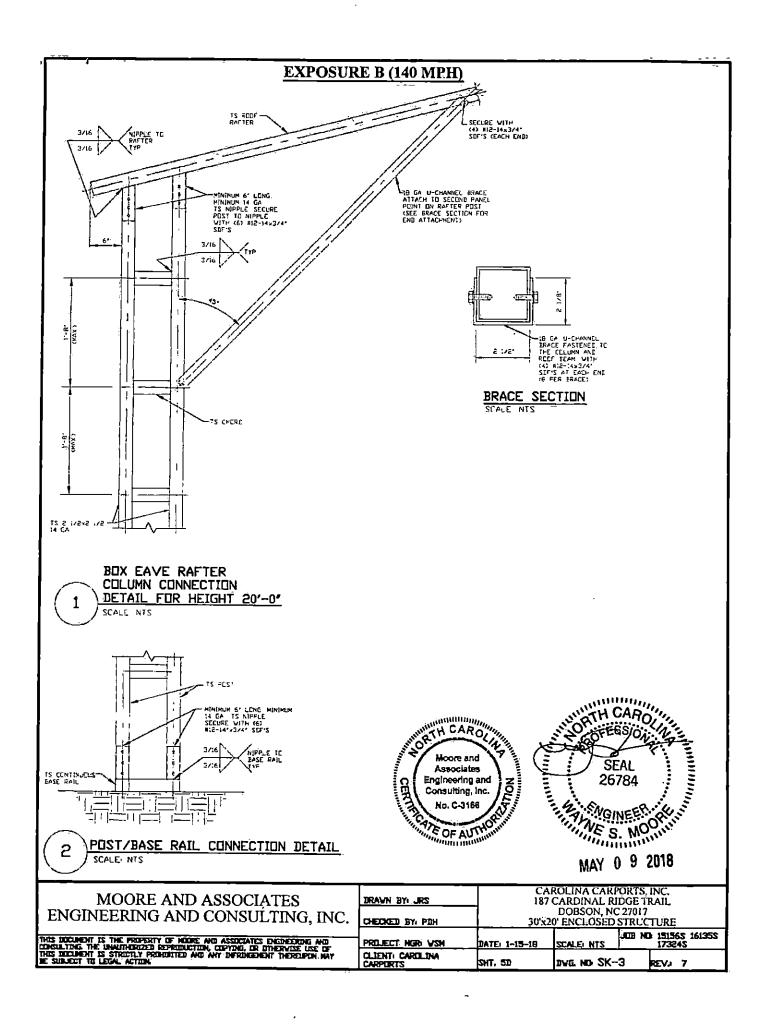

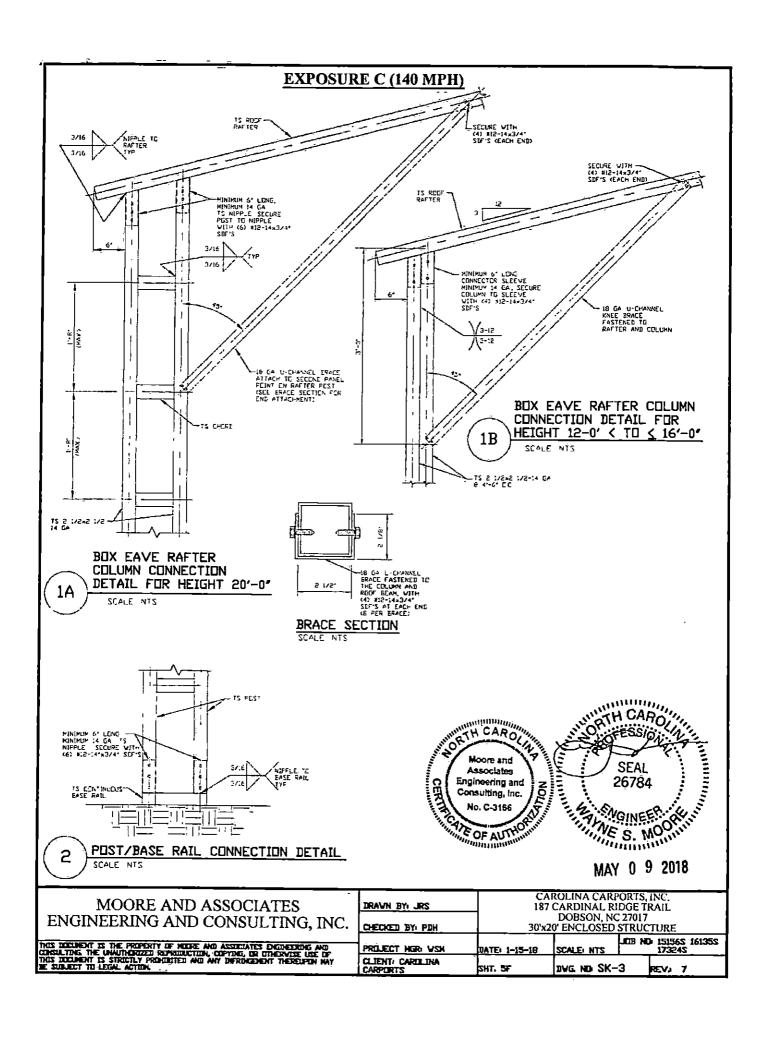

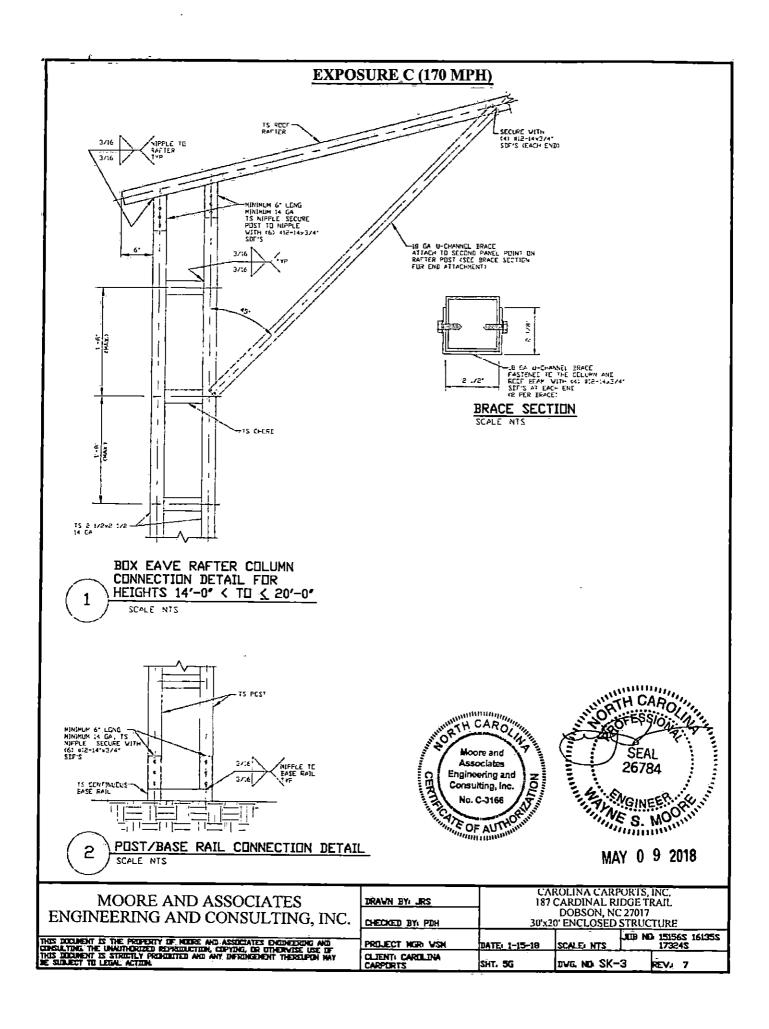


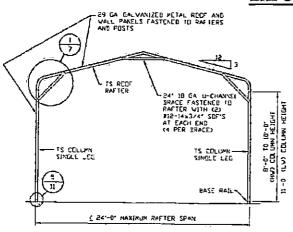

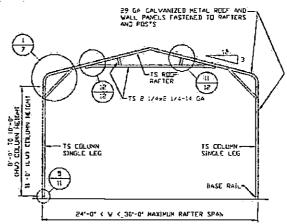

TYPICAL RAFTER/COLUMN END FRAME SECTION

TYPICAL RAFTER/COLUMN END FRAME SECTION

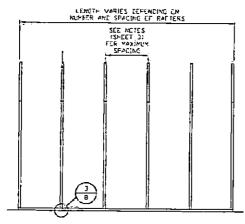

TYPICAL RAFTER/COLUMN FRAMING SIDE SECTION






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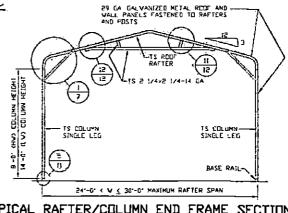
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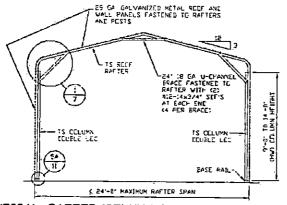
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CHECKED BY: PIN	30'x2	DOBSON, NC 27017 30'x20' ENCLOSED STRUCTURE						
PROJECT HGR: VSH	DATE: 1-15-18	ATE: 1-15-18 SCALE: NTS JUB NO. 15156S 16135S						
CLIENT) CARDLINA CARPORTS	SHT. 6	DVG ND SK-	·3 REV. 7					




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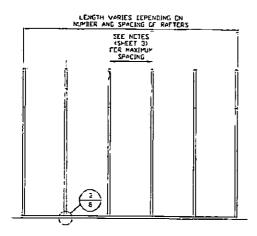
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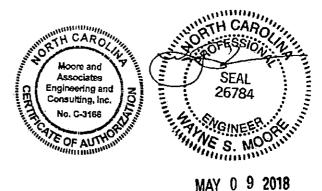
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TYPICAL RAFTER/COLUMN END FRAME SECTION SCALE: NTS

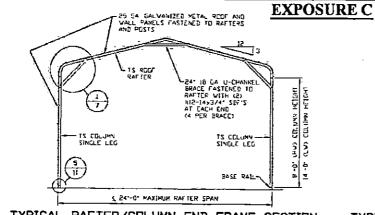



TYPICAL RAFTER/COLUMN FRAMING SIDE SECTION SCALE N'S





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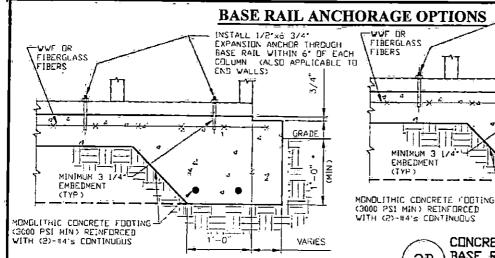
MOORE AND ASSOCIATES ENGINEERING AND CONSULTING, INC.	DRAVN BY: JRS CHECKED BY: PDH	187	ROLINA CARF CARDINAL RI DOBSON, NO 0' ENCLOSED	IDGE TRAIL 27017
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3A

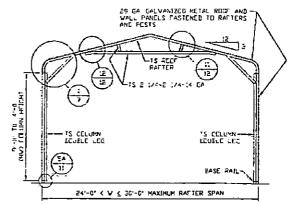CONCRETE MONOLITHIC SLAB BASE RAIL ANCHURAGE

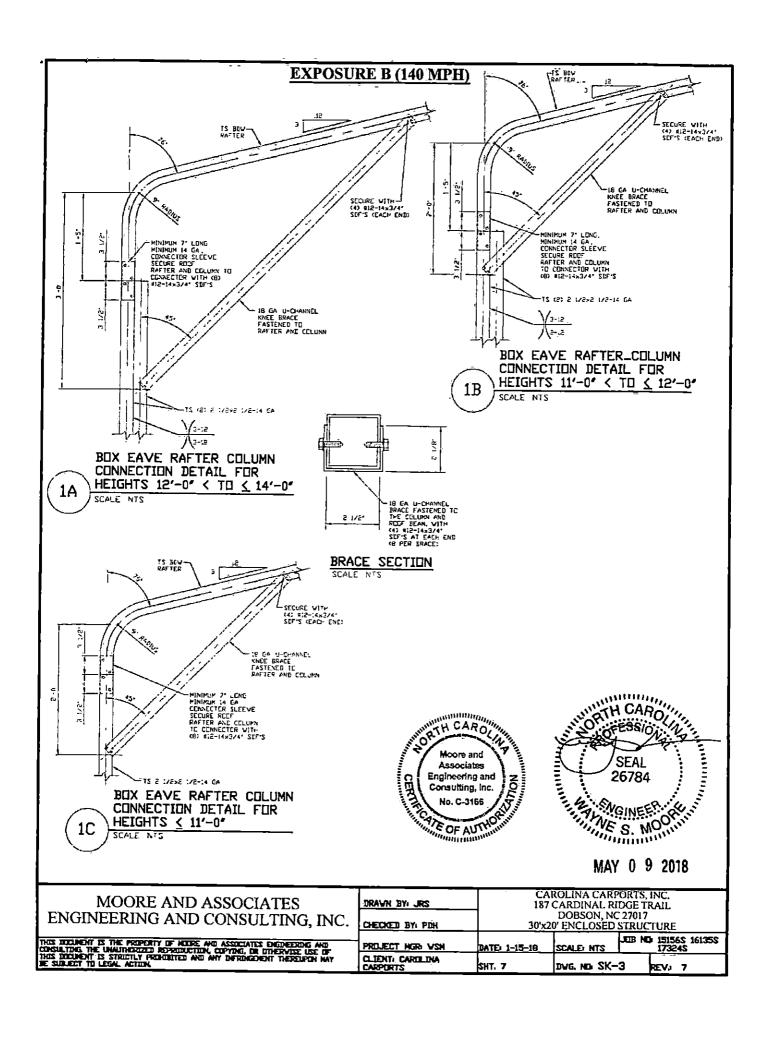MINIMUM ANCHOR EDGE DISTANCE IS 4") * COURDINATE WITH EDGAL CODES/ORE

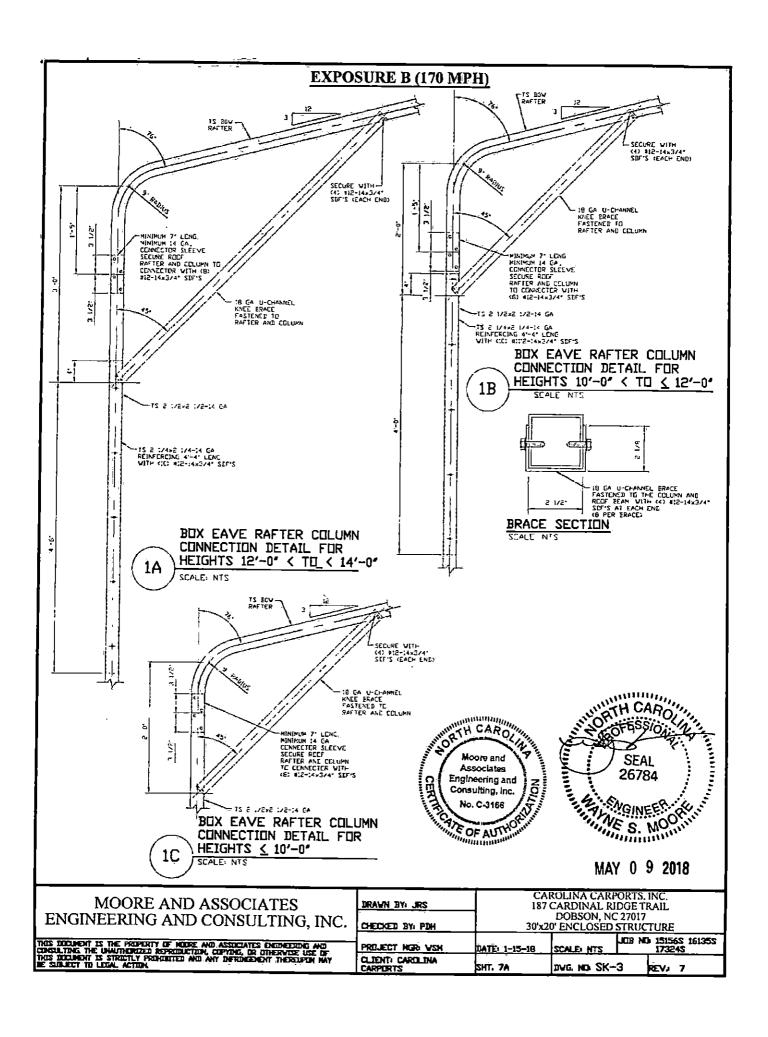GENERAL NOTES

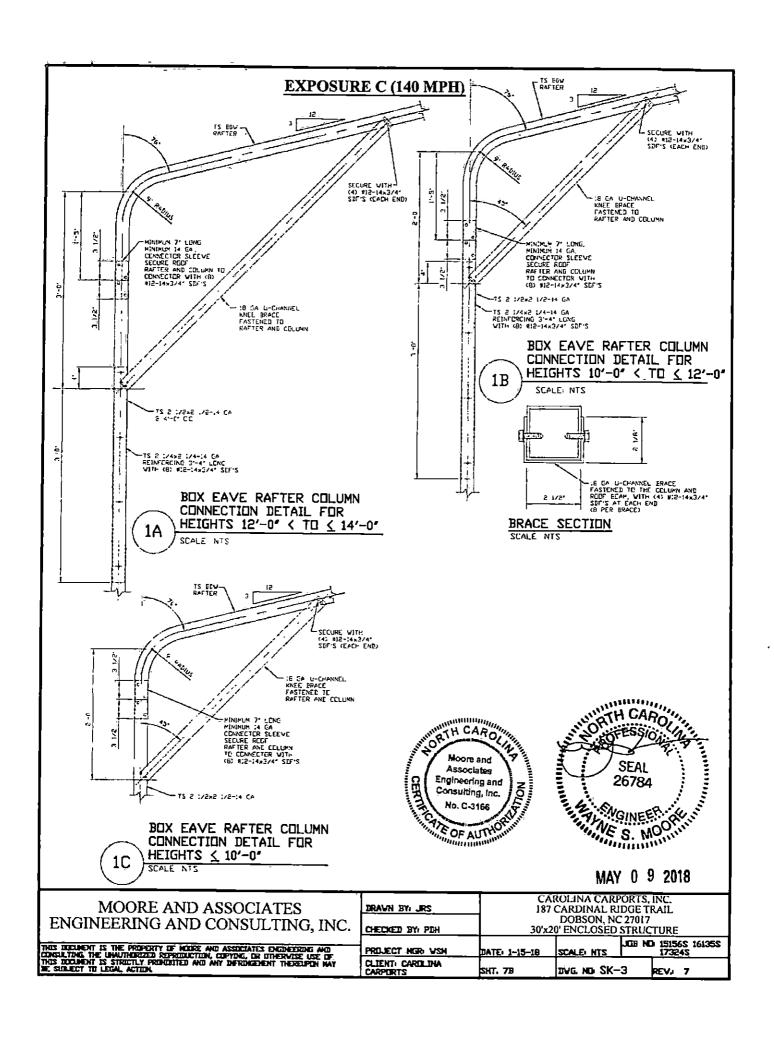CONCRETE:

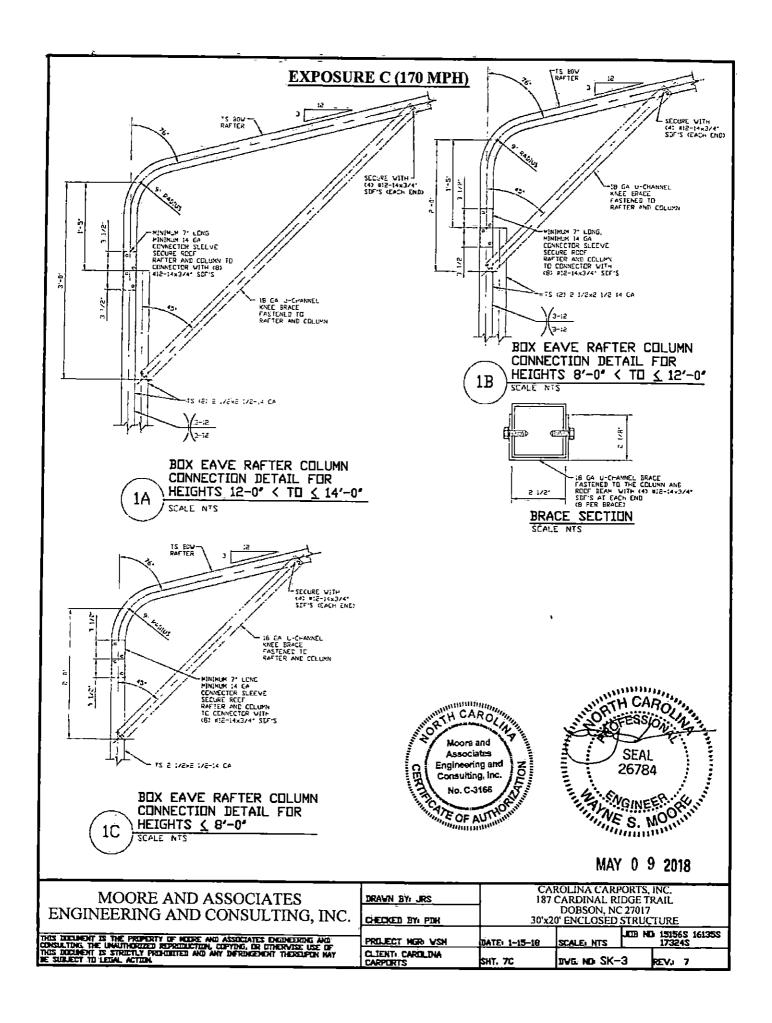CONCRETE SHALL HAVE A MINIMUM SPECIFIED COMPRESSIVE STRENGTH OF 3,000 FSI AT 28 DAYS

COVER OVER REINFORCING STEEL:

FOR FOUNDATIONS MINIMUM CONCRETE COVER OVER REINFORCING PER FOUNDATIONS MINIMUM CONCRETE COVER OVER RETURNING MEMORIAGE BARS SHALL BE PER ACI-318

3' IN FOUNDATIONS WHERE THE CONCRETE IS CAST AGAINST AND PERMANENTLY IN CONTACT WITH THE EARTH OR EXPOSED TO THE EARTH OR WEATHER, AND I 1/2' ELSEWHERE

REINFORCING STEEL


THE TURNDOWN REINFORCING STEEL SHALL BE ASTM AGIS GRADE 6C THE SLAB REINFORCEMENT SHALL BE WELLED WIRE FABRIC MEETING ASTM A185 CR FIBERGLASS FIBER REINFORCEMENT

REINFORCEMENT MAY BE BENT IN THE SHOP OR THE FIELD PROVIDED:

- REINFORCEMENT IS BENT COLD
- THE DIAMETER OF THE BEND MEASURED ON THE INSIDE OF THE BAR IS NOT LESS THAN SIX-BAR DIAMETERS REINFORCEMENT PARTIALLY EMBELDED IN CONCRETE SHALL NOT
- BE FIELD BENT


HELIX ANCHUR NUTES:

- : FOR VERY LENSE AND/OR CEMENTED SANCS CHARSE CRAVEL AND COBBLES CALICHE PRELIATED SILTS AND CLAYS USE MINIMUM (2) 4' HELICES WITH MINIMUM 3C' EMBELMENT OR SINGLE 6' HELIX WITH MINIMUM 3C' EMBELMENT
- 2 FDR CCRAL USE MINIMUM (2) 4' HELICES WITH MINIMUM 30' EMBEDMENT ER SINGLE 6' HELIX WITH MINIMUM 50' EMBEDMENT
- 3 FOR MEDIUM DENSE CHARSE SANES SANEY CRAVELS VERY STIFF SILTS AND CLAYS USE MINIMUM (2) 4" HELICES WITH MINIMUM 30 INCH EMBEDMENT OR SINGLE 6" HELIX WITH MINIMUM 50 EMBERMENT
- FER LOOSE TO MEDIUM CENSE SANCS FIRM TO STIFF CLAYS AND SILTS ALLUVIAL FILL USE MINIMUM (2) 6' HELICES WITH MINIMUM EC' EMBEDMENT
- 5 FER VERY LOSE TO MEDIUM CENSE SANES FIRM TO STIFFER CLAYS AND SILTS ALLUVIAL FILL USE MINIMUM (2: 8" HELICES WITH MINIMUM 6C" EMBEDMENT

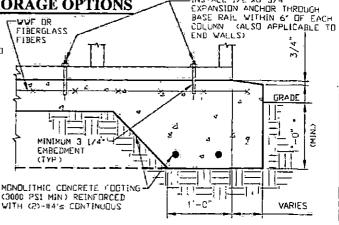


INSTALL 1/2'x6 3/4"

CONCRETE MONOLITHIC SLAB BASE RAIL ANCHURAGE **3B** SCALE NTS

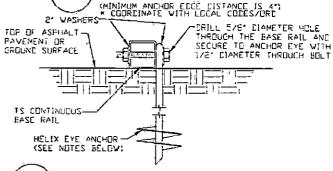

GROUND BASE HELIX ANCHURAGE SCALE NTS (CAN BE USET FOR ASPHALT)

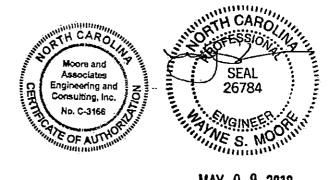


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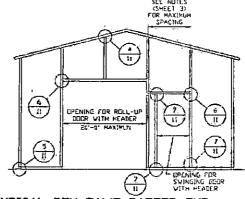
DRAVN BY JRS	DOBSON, NC 27017			
CHECKED BY PDH				TURE
PROJECŤ NGR: VŠN	DATE: 1-15-18	SCALE: NTS	J039 ND	15156S 16135S 17324S
CLIENT: CAROLINA CARPORTS	SHT. 8	DVG. ND SK-	3	REV. 7

BOX EAVE RAFTER END WALL AND SIDE WALL OPENINGS




TYPICAL BUX EAVE RAFTER END WALL FRAMING SECTION

SCALE NTS

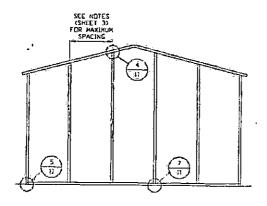

TYPICAL BUX EAVE RAFTER END WALL OPENINGS FRAMING SECTION

SCALE NTS

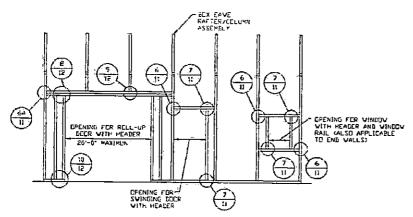


TYPICAL BOX EAVE RAFTER SIDE WALL OPENINGS FRAMING SECTION SCALE NIS

WAY CAROLINE ORTH CAROLA Moore and **Associates** Engineering and Consulting, Inc. No. C-3166 E OF AUTH




MOORE AND ASSOCIATES	DRAWN BY: JRS		ROLINA CARF CARDINAL RI DOBSON, NO	DGE TRAIL
ENGINEERING AND CONSULTING, INC.	CHECKED BY: PDH	30'x2i	0' ENCLOSED	
THIS DISCURENT IS THE PROPERTY OF HORSE AND ASSISTATES ENGINEERING AND CONSULTING, OF DITHERYSES USE OF	PROJECT NGR VSM	DATE: 1-15-19	SCALE: NTS	JUB NO 15156S 16135S 17324S
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BOW RAFTER END WALL AND SIDE WALL OPENINGS

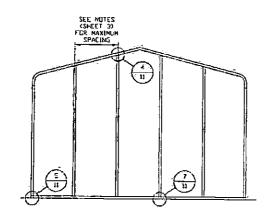


TYPICAL BOW RAFTER END WALL FRAMING SECTION

SCALE NTS

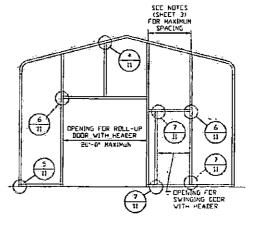

TYPICAL BOW RAFTER END WALL OPENINGS FRAMING SECTION

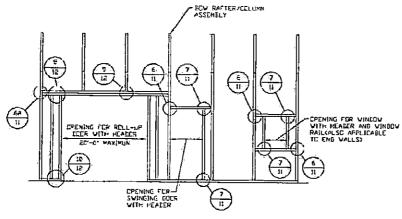

TYPICAL BOW RAFTER SIDE WALL OPENINGS FRAMING SECTION







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ENGINEERING AND CONSULTING, INC.	CHE

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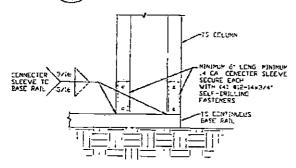
	DRAWN BYI JRS		ORTS. INC. DGE TRAIL	
		DOBSON, NC 27017		
i	CHECKED BY: PDH	30'x20' ENCLOSED STRUCTURE		
_	PROJECT MGR VSM	DATE: 1-15-18	SCALE: NTS	JOB NO 15156\$ 16135\$ 17324\$
	CLIENT: CARCLINA CARPERTS	SHT. 10	DVG. NO SK-	3 REV. 7

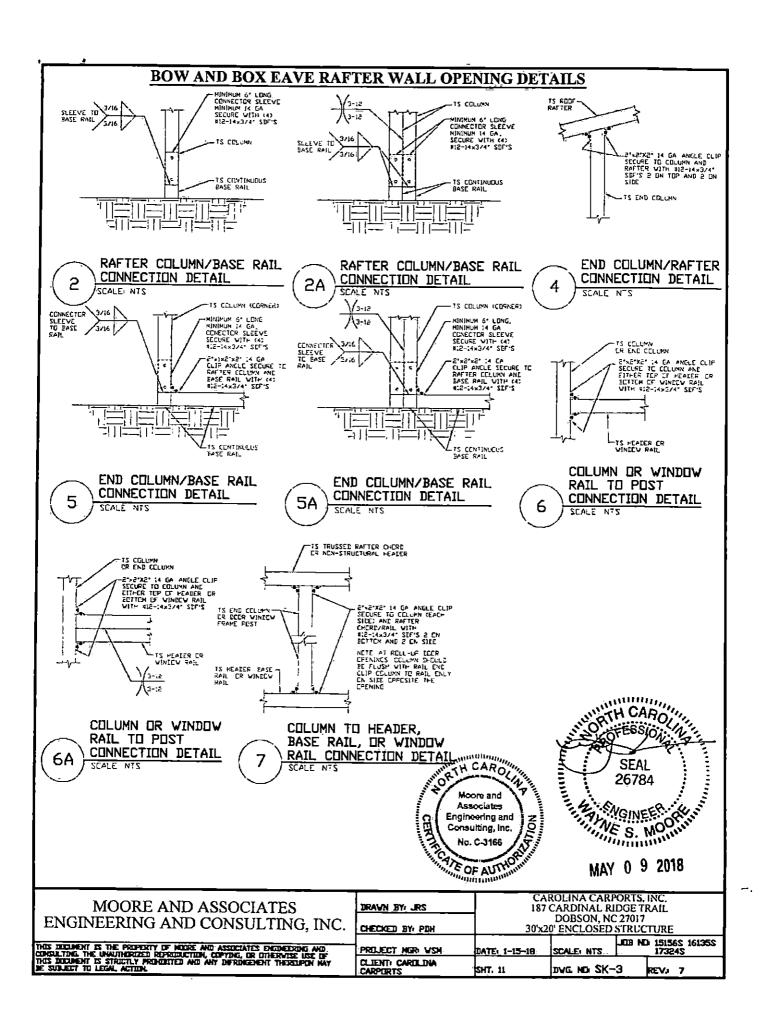


BOW AND BOX EAVE RAFTER WALL OPENING DETAILS

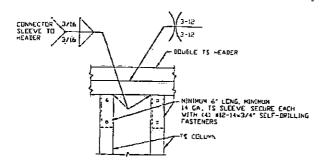


DOUBLE HEADER/COLUMN CONNECTION DETAIL 8




CULUMN/BASE RAIL CONNECTION DETAIL 10

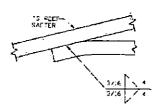

COLLAR TIE CONNECTION DETAIL 12

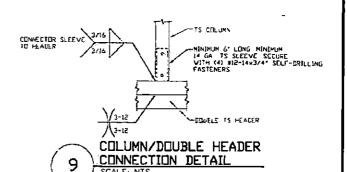

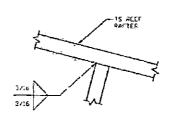

SCALE: NTS

RAFTER TO CHORD CONNECTION DETAIL 11 SCALE NTS






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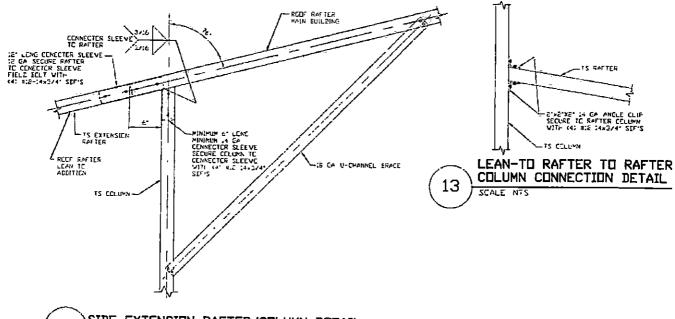
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	DOBSON, NC 27 CHECKED BY: PDH 30'x20' ENCLOSED STI				TURE
_	PROJECT HGR: VSH	DATE: 1-15-18	SCALE: NTS	JOB NO	15156S 16135S 17324S
	CLIENT: CAROLINA CARPORTS	SHT. 12	DVG NO SK-	ω	7 i.V.⊒




TYPICAL BOX EAVE RAFTER LEAN-TO OPTIONS FRAMING SECTION (BOTH OPTIONS SHOWN)

SCALE NTS MINIMUM WIDTH OF STANDARD LEAN-TO/RODF EXTENSION IS 12'-0'

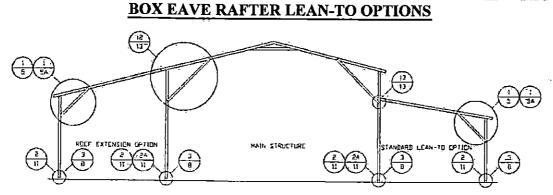

SIDE EXTENSION RAFTER/COLUMN DETAIL 12



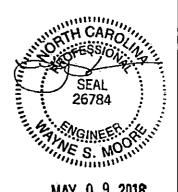


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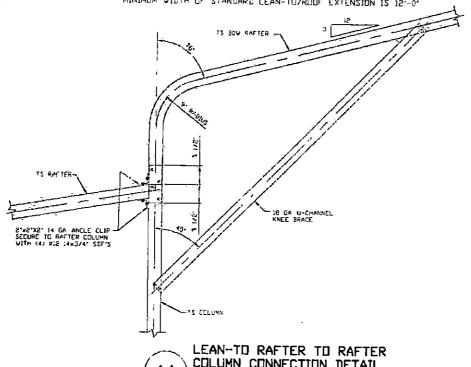
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	CHECKED BY: PDH				TURE
-	PROJECT NGR: VSH	DATE: 1-15-18	SCALE: NTS	JOB 100	15156S 16135S 17324S
	CLIENT: CARDLINA CARPURTS	SHT. 13	DVG ND SK-	3	7 ZEV. 7



TYPICAL BOW RAFTER LEAN-TO OPTION FRAMING SECTION

MINIMUM WIDTH OF STANDARD LEAN-TO/ROOF EXTENSION IS 12:-0

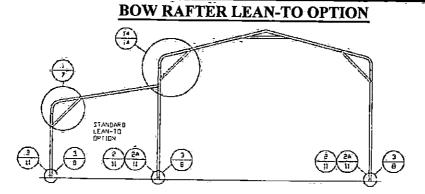

COLUMN CONNECTION DETAIL STALE NTS





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MERMEN TWO DRU	30%


AROLINA GARPORTS, INC. 87 CARDINAL RIDGE TRAIL DOBSON, NC 27017 x20' ENCLOSED STRUCTURE

ROJECT NGR: VSM	DATE: 1-15-18
LIENT: CARCLINA	SHT. 14


JOB ND: 151562 161359 173245 SCALE: NTS DVG NO SK-3

REV. 7


BOX EAVE RAFTER VERTICAL ROOF/SIDING OPTION

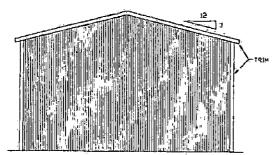


TYPICAL END ELEVATION VERTICAL ROOF/SIDING

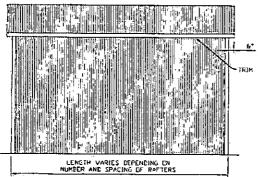


TYPICAL SIDE ELEVATION VERTICAL ROOF/SIDING

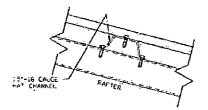

PANEL ATTACHMENT CALTERNATE FOR VERTICAL ROOF PANELS: SCALE NTS

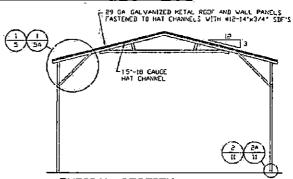

TYPICAL SECTION VERTICAL ROOF/SIDING OPTION

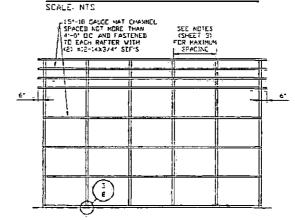


TYPICAL FRAMING SECTION VERTICAL ROOF/SIDING OPTION SCALE: NTS








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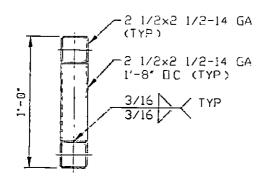




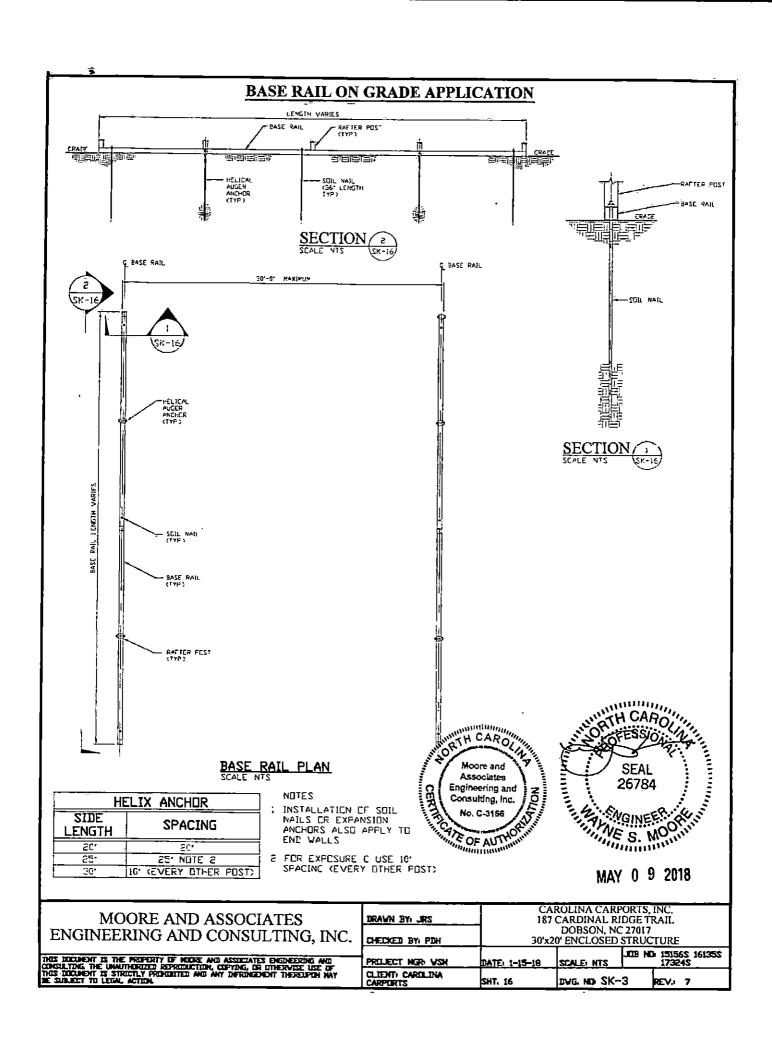


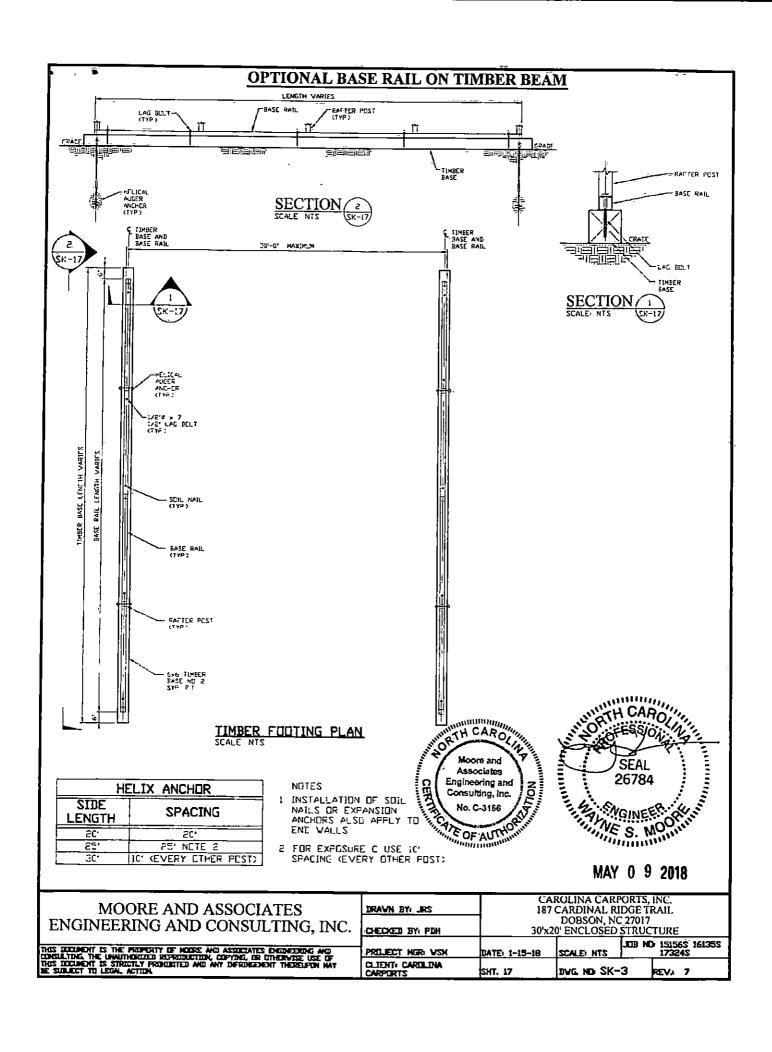

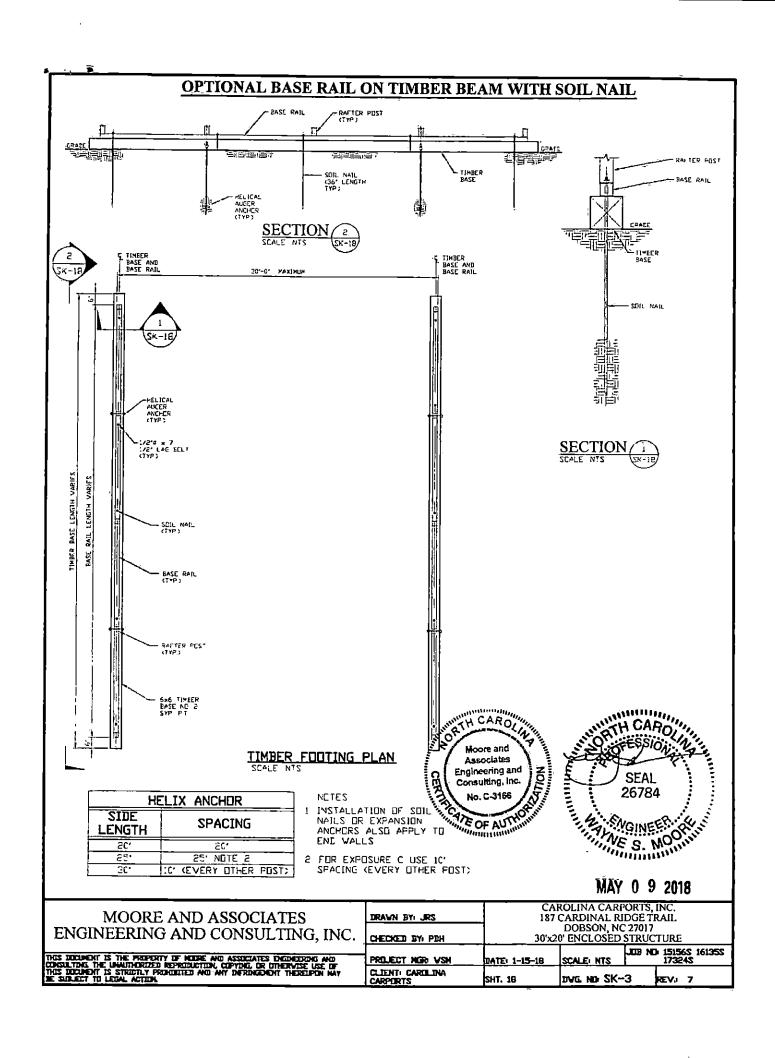OPTIONAL HEADER

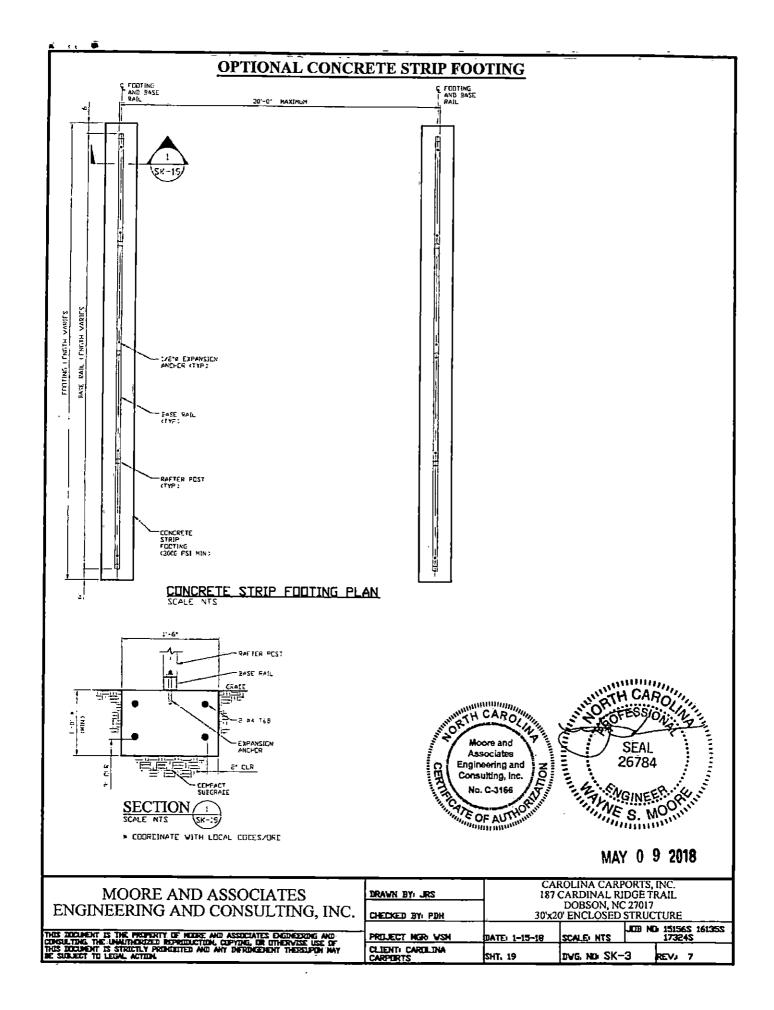

HEADER DETAIL FOR OPENINGS 12'-0' \(\) LENGTH \(\) 20'-0'

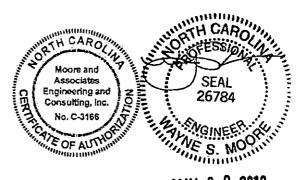

MOORE AND ASSOCIATES ENGINEERING AND CONSULTING, INC.	DRAWN BY: JRS	CAROLINA CARPORTS, INC. 187 CARDINAL RIDGE TRAIL DOBSON, NC 27017		
	CHECKED BY, PDH	30'x20' ENCLOSED STRUCTURE		
THE DESIGNATIONS STATEMENT OF MOUSE AND ASSESSATES ENGINEERING AND	PROJECT HER VSH	DATE: 1-15-18	SCALE) NTS	JOB NO 151562 161358 173248
CONSILITING THE UNMITHERIZED REPRODUCTION, CEPYING, OR DITHERVISE USE OF THIS BOUNDERT IS STRUCTLY PROHIBITED AND ANY DEPRINGENENT THERELPON MAY BE SUBJECT TO LEGAL, ACTUM	CLIENT: CARDLINA CARPURTS	SHT. 20	DVG NO SK-3	3 REV. 7