

PROJECT:
Center #: 8278 - Cameron, NC
 183 Mittie Haddock Dr, Cameron, NC 28326

OWNER:
The UPS Store, Inc.



319 N. Fourth Street, Suite 1000
 St. Louis, MO 63102
 P 314-231-5700
 F 314-231-0816

PROJECT DIRECTORY

Franchisee: Patel, Nirav
 P: 256.394.7161
 niravpatel1@live.com

General Contractor: To Be Selected

Municipality: Harnett County
 P: 910.893.7525

DISCLAIMER

PROPERTY CONTAINED WITHIN THESE DOCUMENTS ARE TAKEN DIRECTLY FROM A DESIGN INTENT DRAWING FROM THE TENANT DESIGNER AND THE DESIGN IS NOT NECESSARILY THE PROPERTY OF LAWRENCE GROUP. CONTACT CUSHMAN & WAKEFIELD PROJECT MANAGER AND DESIGNER FOR ANY CLARIFICATIONS ON PROJECT AND DELIVERY SCOPE.


PLAN NORTH VS TRUE NORTH

PLAN NORTH IS BASED ON THE PREDOMINANT AXIS OF THE BUILDING GEOMETRY. FOR THIS PROJECT, PLAN NORTH POINTS TOWARDS THE TOP OF THE DRAWING AREA. ALL VIEWS IN THIS DRAWING SET USE PLAN NORTH AS IT'S ORIENTATION. TRUE NORTH IS THE REAL-WORLD NORTH DIRECTION BASED ON SITE CONDITIONS. TRUE NORTH INFORMATION IS NOT USED OR PROVIDED FOR THESE DOCUMENTS.

NOTE TO CONTRACTOR

IT IS THE CONTRACTOR'S RESPONSIBILITY TO THOROUGHLY REVIEW THE OWNER'S DESIGN INTENT DRAWINGS & NOTIFY THE ARCHITECT IMMEDIATELY WITH ANY MAJOR DISCREPANCIES. THE ARCHITECT SHALL IN NO WAY BE HELD RESPONSIBLE FOR ANY DIFFERENCES BETWEEN THE DESIGN INTENT AND ARCHITECT PROVIDED DRAWINGS.

PROJECT LOCATION

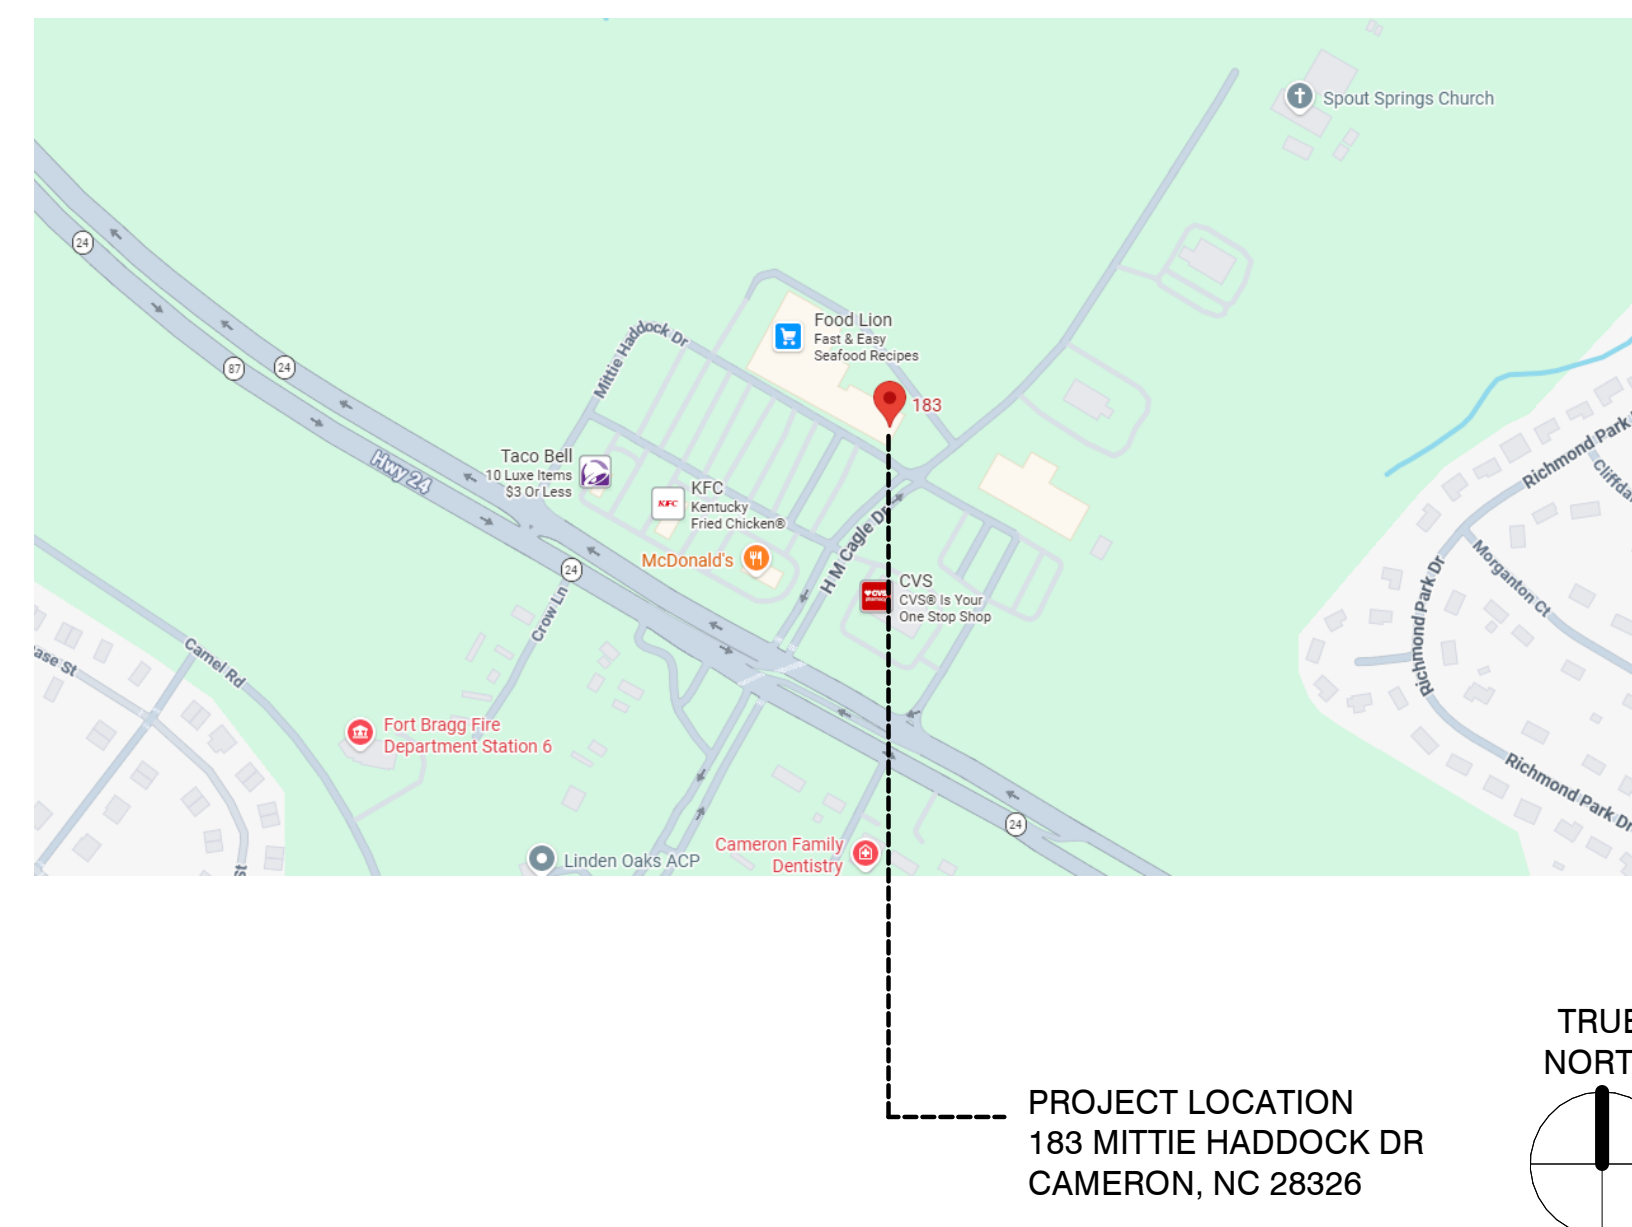

SITE PLAN



LIST OF DRAWINGS


Sheet Number	Sheet Name
A0	Cover Sheet
A0.2	Appendix B
A1	Demolition Floor Plan
A2	Construction & Modular Fixture & Life Safety Plan
A3	Reflected Ceiling Plan
A4	Electrical Plan
A5	Finish Plan
A6	Fixture Plan
A7	Graphics Plan & Elevations
A7.1	Graphic & Sign Install Instructions
A8	Interior Elevations
A9	Details
A10	Details



GENERAL NOTES

- GENERAL CONTRACTOR IS RESPONSIBLE TO VISIT THE SITE PRIOR TO BID DATE TO FAMILIARIZE THEMSELVES WITH THE ACTUAL JOB CONDITIONS AND TO CHECK FOR ANY INTERFERENCES BETWEEN THEIR WORK AND THAT OF TRADES. IF ACCESS IS DENIED, CONTACT TUPSS DESIGN COORDINATOR IMMEDIATELY. FAILURE TO CONTACT THE TUPSS DESIGN COORDINATOR WILL RESULT IN THE CONTRACTOR TO ABSORB ANY ADDITIONAL COSTS DUE TO HIDDEN CONDITIONS.
- THE GENERAL CONTRACTOR SHALL CHECK FOR APPARENT VIOLATIONS OF LOCAL, STATE OR FEDERAL CODES, LAWS, ORDINANCES AND REGULATIONS BEFORE ENTERING INTO A CONTRACT WITH EITHER THE TENANT GENERAL CONTRACTOR AND/OR TENANT. IF ANY INTERFERENCES OR VIOLATIONS APPEAR AND DEPARTURE FROM THE DESIGN INTENT DOCUMENTS IS REQUIRED, THE GENERAL CONTRACTOR SHALL NOTIFY THE ARCHITECT OF RECORD, TENANT'S PROJECT MANAGER AND TENANT IN WRITING. BEFORE ENTERING INTO CONTRACT WITH THE TENANT. FAILURE TO PROVIDE ARCHITECT AND TENANT WITH THE AFOREMENTIONED NOTIFICATION SHALL RESULT IN THE SPECIFIC CONTRACTOR BEING HELD RESPONSIBLE TO COMPLETE ALL WORK REQUIRED TO MEET THE ORIGINAL DESIGN INTENT DRAWINGS AT HIS/HER OWN COSTS WITH NO ADDITIONAL EXPENSES (EXTRAS) BEING INCURRED BY TENANT.
- GENERAL CONTRACTOR TO COORDINATE ALL PHASES OF CONSTRUCTION WITH THE TUPSS DESIGN COORDINATOR AND SUBMIT SCHEDULE TO TUPSS DESIGN COORDINATOR AND THE UPS STORE BASE DAILY WITH STORE TEAM AT OPENING AND CLOSING TO COORDINATE PHASING/SCOPE OF WORK/REQUIRED STORE PREP FOR THE FOLLOWING DAY.
- GENERAL CONTRACTOR TO ENCLOSE ALL EXPOSED BUILDING COLUMNS AND DEMISING WALL WITHIN LEASED SPACE. FIRE RATED ENCLOSURE TO MEET LOCAL AND STATE CODES AND LANDLORD REQUIREMENTS.
- GENERAL CONTRACTOR TO IMMEDIATELY NOTIFY TUPSS DESIGN COORDINATOR OF ANY DISCREPANCIES, ERRORS OR OMISSIONS DISCOVERED IN THE DESIGN INTENT DRAWINGS ACTUAL WIDTHS, LENGTHS, AVAILABLE CEILING HEIGHTS, COLUMN LOCATIONS, STOREFRONT CONDITIONS, UTILITY LOCATIONS, ETC. BEFORE PROCEEDING WITH RELATED WORK; OTHERWISE, THE CORRECTION OF SUCH ITEMS IS THE RESPONSIBILITY OF THE CONTRACTOR.
- ALL CONSTRUCTION, INCLUDING TRIM, MUST BE WITHIN LEASE LINES (WHERE APPLICABLE). USE OF ANY AREA OUTSIDE OF LEASE LINES FOR STORAGE OF MATERIALS, TOOLS, FIXTURES, ETC., IS PROHIBITED.
- GENERAL CONTRACTOR TO REMOVE ALL CONSTRUCTION DEBRIS FROM JOB SITE AS DIRECTED BY LANDLORD. ALL CONSTRUCTION DEBRIS SHALL BE CONTAINED WITHIN LEASE SPACE AT ALL TIMES.
- ALL WOOD FRAMING, BLOCKING AND PLYWOOD TO BE FIRE RETARDANT AND PRESSURE TREATED MILL STAMP. USE SELECT GRADE LUMBER AT ALL EXPOSED AREAS. ALL FIRE RETARDANT WOOD FRAMING, BLOCKING, FURRING STRIPS AND PLYWOOD SHALL REMAIN UNPAINTED FOR VISUAL INSPECTION.
- ALL DIMENSIONS ARE TO FINISH FACE OF GYPSUM WALL BOARD OR TO FINISH FACE OF EXISTING CONSTRUCTION UNLESS NOTED OTHERWISE.
- ALL ANGLES 90 DEGREES UNLESS NOTED OTHERWISE.
- GENERAL CONTRACTOR IS RESPONSIBLE TO HAVE ENTIRE STORE THOROUGHLY CLEAN AND DUST FREE AT THE TIME OF TURN OVER.
- TENANT'S GENERAL CONTRACTOR TO ASSEMBLE ALL MISCELLANEOUS FLOOR DISPLAYS, RACKS, BRACKETS, HANG RODS, ETC., INCLUDING, BUT NOT LIMITED TO, ROUND RACKS; 2 WAY RACKS, 4 WAY RACKS. DISPLAY MERCHANDISE TABLES, NON-SALES AREA-TENANT'S GENERAL CONTRACTOR TO ASSEMBLE ALL MISCELLANEOUS NON-SALES OFFICE EQUIPMENT, SHELVES, RACKS, BRACKETS, HANG RODS, ETC. TENANT'S GENERAL CONTRACTOR MUST FILE BURRS SMOOTH BEFORE INSTALLING SNAP-IN END CAPS ANYTIME HANG ROD IS CUT TO LENGTH.
- GENERAL CONTRACTOR AND SUB-CONTRACTORS MUST FAMILIARIZE THEMSELVES WITH THE UPS STORE TENANT CRITERIA MANUAL. THE UPS STORE CONSTRUCTION REGULATIONS AND LOCAL CODE REQUIREMENTS FOR ANY ADDITIONAL INFORMATION NOT SPECIFICALLY INCLUDED IN THESE DOCUMENTS.
- THE SPRINKLER SYSTEM SHALL BE FULLY CHARGED AND OPERATIONAL WHEN THE CONTRACTOR IS OFF-SITE.
- MATERIALS, EQUIPMENT, AND ASSEMBLIES SHOWN OR SPECIFIED ARE MINIMUM REQUIREMENTS OR PERFORMANCE STANDARDS. LOCAL JURISDICTIONS MAY REQUIRE PERFORMANCE STANDARDS BEYOND THOSE SHOWN OR SPECIFIED. FURTHERMORE, LOCAL JURISDICTIONS MAY PREVENT THE USE OF COMMONLY ACCEPTED MATERIALS. CONTRACTOR SHALL FAMILIARIZE HIMSELF WITH ALL LOCAL REQUIREMENTS FOR LICENSING, MATERIALS, AND PERFORMANCE STANDARDS PRIOR TO SUBMITTING BID. ALL CONFLICTS BETWEEN THE DESIGN INTENT DRAWINGS AND LOCAL REQUIREMENTS SHALL BE BROUGHT TO THE OWNER'S ATTENTION AND RESOLVED, BY MUTUAL AGREEMENT, PRIOR TO SUBMISSION OF BID OR HIGHEST PRICED WORK. LOCAL REQUIREMENTS VERSUS SPECIFIED REQUIREMENTS SHALL BE INCLUDED IN THE BID.
- THIS DESIGN CRITERIA IS PROVIDED FOR BUILDING OFFICIAL REVIEW CONVENIENCE ONLY IS NOT INTENDED FOR USE BY COMPONENT DESIGNERS OR MANUFACTURERS AS THEIR SOLE DESIGN CRITERIA WITHOUT VERIFICATION. EACH DESIGNER AND/OR MANUFACTURER MUST INDEPENDENTLY CONFIRM ALL CODE CRITERIA WITH WHICH THEIR ELEMENTS OR COMPONENTS MUST COMPLY INCLUDING BUT NOT LIMITED TO LOADING, APPLICATION, FUNCTIONALITY, ETC. PERFORMANCE CRITERIA PROVIDED ELSEWHERE BY A SPECIFIC DISCIPLINE SHOULD BE REGARDED AS THE MINIMUM STANDARDS ACCEPTABLE TO THE CLIENT. EACH SUPPLIER MUST EVALUATE THESE MINIMUMS AGAINST SPECIFIC INDUSTRY STANDARDS AS WELL AS CODES, LAWS, ORDINANCES AND UNDERWRITER REQUIREMENTS GOVERNING HIS PRODUCT AS WELL AS OWNER INSURER REQUIREMENTS, AS APPLICABLE. THE MOST STRINGENT OF THESE CRITERIA SHALL GOVERN.
- LEAVE ALL APPROPRIATE DOCUMENTATION INDEXED IN A BINDER.
- LEAVE AS-BUILT SET OF PLANS WITH THE LANDLORDS TENANT COORDINATOR.
- TURN OVER ALL KEYS TO FRANCHISEE OWNER MARKING EACH KEY FOR IDENTIFICATION.
- CONTRACTOR TO PROVIDE CIRCUIT DIRECTORY ON ELECTRICAL PANELS, TYP.
- GENERAL CONTRACTOR TO VERIFY ALL DIMENSIONS PRIOR TO CONSTRUCTION. IF ANY DIMENSIONS FROM THE PLAN ARE CONTRADICTORY TO FIELD CONDITIONS, CONTACT TUPSS DESIGN COORDINATOR IMMEDIATELY. FAILURE TO CONTACT TUPSS DESIGN COORDINATOR WILL RESULT IN THE GENERAL CONTRACTOR ABSORBING ANY ADDITIONAL COSTS.

PROFESSIONAL SEAL:

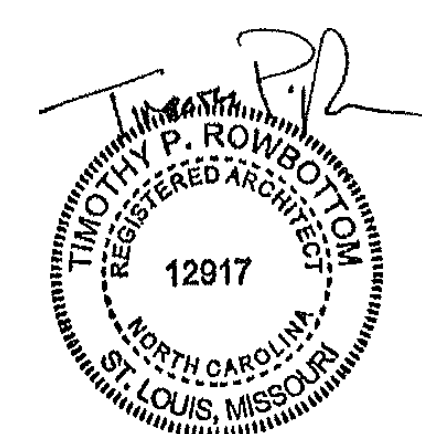

ISSUE DATE: 04/09/2026
 EXP. DATE: 06/30/2026

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CODE SUMMARY

APPLICABLE CODES:

- 2018 NORTH CAROLINA BUILDING CODE
- 2020 NATIONAL ELECTRIC CODE
- 2018 NORTH CAROLINA FIRE CODE
- 2018 NORTH CAROLINA MECHANICAL CODE
- 2018 NORTH CAROLINA PLUMBING CODE
- 2018 NORTH CAROLINA ENERGY CONSERVATION CODE

PROJECT AREA:

PARTIAL 1ST FLOOR: 1681 SF

OCCUPANCY:

PARTIAL 1ST FLOOR OF EXISTING 1-STORY BUILDING
 PROPOSED: (B) BUSINESS (PROFESSIONAL SERVICES)

CALCULATED OCCUPANT LOAD:

PARTIAL 1ST FLOOR
 TOTAL LOAD = 17 OCCUPANTS (100 SF/OCC)

CONSTRUCTION TYPE:

TYPE IIB, UNCOMBUSTIBLE, UNPROTECTED

FIRE PROTECTION:

SPRINKLER SYSTEM: YES

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No.	Description	Date

Sheet Title:
Cover Sheet

Project Number:
 2026901.084

Issue Date:
 04/09/2026

Sheet Number:
A0

2018 APPENDIX B
BUILDING CODE SUMMARY FOR ALL COMMERCIAL PROJECTS
(EXCEPT 1 AND 2-FAMILY DWELLINGS AND TOWNHOUSES)
(Reproduce the following data on the building plans sheet 1 or 2)

Name of Project: The UPS Store #8278
Address: 183 Mittie Haddock Dr, Cameron, NC
Owner/Authorized Agent: Phone # () E-Mail
Owned By: City/County Private State
Code Enforcement Jurisdiction: City County Hamett State

CONTACT:
DESIGNER FIRM NAME LICENSE # TELEPHONE # E-MAIL
Architectural
Civil
Electrical
Fire Alarm
Plumbing
Mechanical
Sprinkler-Standpipe
Structural
Retaining Walls >5' High
Other

2018 NC BUILDING CODE:
New Building Addition Renovation
1st Time Interior Completion
Shell/Core - Contact the local inspection jurisdiction for possible additional procedures and requirements
Phased Construction - Shell/Core - Contact the local inspection jurisdiction for possible additional procedures and requirements

2018 NC EXISTING BUILDING CODE: EXISTING:
Prescriptive Repair Chapter 14
Alteration: Level I Level II Level III
Historic Property Change of Use
CONSTRUCTED: (date) Unknown CURRENT OCCUPANCY(S) (Ch. 3): N/A
RENOVATED: (date) PROPOSED OCCUPANCY(S) (Ch. 3): (B) Business
RISK CATEGORY (Table 1604.5): Current: I II III IV Proposed: I II III IV

BASIC BUILDING DATA
Construction Type: I-A II-A III-A IV V-A
I-B II-B III-B V-B
Sprinklers: No Partial Yes NFPA 13 NFPA 13R NFPA 13D
Standpipes: No Yes Class I II III Wet Dry
Fire District: No Yes Flood Hazard Area: No Yes
Special Inspections Required: No Yes (Contact the local inspection jurisdiction for additional procedures and requirements.)

2018 NC Administrative Code and Policies

PERCENTAGE OF WALL OPENING CALCULATIONS
FIRE SEPARATION DISTANCE (FEET) FROM PROPERTY LINES
DEGREE OF OPENINGS PROTECTION (TABLE 705.8)
ALLOWABLE AREA (%)
ACTUAL SHOWN ON PLANS (%)

LIFE SAFETY SYSTEM REQUIREMENTS
Emergency Lighting: No Yes
Exit Signs: No Yes
Fire Alarm: No Yes
Smoke Detection Systems: No Yes Partial
Carbon Monoxide Detection: No Yes

LIFE SAFETY PLAN REQUIREMENTS
Life Safety Plan Sheet #: A2
Fire and/or smoke rated wall locations (Chapter 7)
Assumed and real property line locations (if not on the site plan)
Exterior wall opening area with respect to distance to assumed property lines (705.8)
Occupancy Use for each area as it relates to occupant load calculation (Table 1004.1.2)
Occupant loads for each area
Exit access travel distances (1017)
Common path of travel distances (Tables 1006.2.1 & 1006.3.2(1))
Dead end lengths (1020.4)
Clear exit widths for each exit door
Maximum calculated occupant load capacity each exit door can accommodate based on egress width (1005.3)
Actual occupant load for each exit door
A separate schematic plan indicating where fire rated floor/ceiling and/or roof structure is provided for purposes of occupancy separation
Location of doors with panic hardware (1010.1.10)
Location of doors with delayed egress locks and the amount of delay (1010.1.9.7)
Location of doors with electromagnetic egress locks (1010.1.9.9)
Location of doors equipped with hold-open devices
Location of emergency escape windows (1030)
The square footage of each fire area (202)
The square footage of each smoke compartment for Occupancy Classification I-2 (407.5)
Note any code exceptions or table notes that may have been utilized regarding the items above

2018 NC Administrative Code and Policies

Gross Building Area Table
FLOOR EXISTING (SQ FT) NEW (SQ FT) SUB-TOTAL
3rd Floor
2nd Floor
Mezzanine
1st Floor
Basement
TOTAL

ALLOWABLE AREA
Primary Occupancy Classification(s):
Assembly A-1 A-2 A-3 A-4 A-5
Business
Educational
Factory F-1 Moderate F-2 Low
Hazardous H-1 Detonate H-2 Deflagrate H-3 Combust H-4 Health H-5 HPM
Institutional
I-1 Condition I-2
I-2 Condition I-1 I-2
I-3 Condition I-1 I-2 I-3 I-4 I-5
I-4
Mercantile
Residential R-1 R-2 R-3 R-4
Storage S-1 Moderate S-2 Low High-piled
Parking Garage Open Enclosed Repair Garage
Utility and Miscellaneous

Accessory Occupancy Classification(s): None
Incidental Uses (Table 509):
Special Uses (Chapter 4 - List Code Sections):
Special Provisions: (Chapter 5 - List Code Sections):
Mixed Occupancy: No Yes Separation: Hr. Exception:
Non-Separated Use (508.3) - The required type of construction for the building shall be determined by applying the height and area limitations for each of the applicable occupancies to the entire building. The most restrictive type of construction, so determined, shall apply to the entire building.
Separated Use (508.4) - See below for area calculations for each story, the area of the occupancy shall be such that the sum of the ratios of the actual floor area of each use divided by the allowable floor area for each use shall not exceed 1.
Actual Area of Occupancy A + Actual Area of Occupancy B / Allowable Area of Occupancy A + Allowable Area of Occupancy B <= 1

2018 NC Administrative Code and Policies

ACCESSIBLE DWELLING UNITS (SECTION 1107)
TOTAL UNITS ACCESSIBLE UNITS REQUIRED PROVIDED
TYPE A UNITS TYPE B UNITS
TYPE A UNITS PROVIDED TYPE B UNITS PROVIDED

ACCESSIBLE PARKING (SECTION 1106)
LOT OR PARKING AREA TOTAL # OF PARKING SPACES REQUIRED PROVIDED
OF ACCESSIBLE SPACES PROVIDED
REGULAR WITH 5' ACCESS AISLES VAN SPACES WITH 13' ACCESS AISLES 8' ACCESS AISLES
TOTAL # ACCESSIBLE PROVIDED

PLUMBING FIXTURE REQUIREMENTS (TABLE 2902.1)
USE WATERCLOSETS URINALS LAVATORIES SHOWERS DRINKING FOUNTAINS
MALE FEMALE UNSEX MALE FEMALE UNSEX REGULAR ACCESSIBLE
SPACE EXIST'G NEW REQ'D

SPECIAL APPROVALS
Special approval: (Local Jurisdiction, Department of Insurance, OSC, DPI, DHHS, etc., describe below)

2018 NC Administrative Code and Policies

STORY NO. DESCRIPTION AND USE (A) BLDG AREA PER STORY (ACTUAL) (B) TABLE 506.2 AREA (C) AREA FOR FRONTAGE INCREASE 1,2 (D) ALLOWABLE AREA PER STORY OR UNLIMITED 1,3

Frontage area increases from Section 506.3 are computed thus:
a. Perimeter which fronts a public way or open space having 20 feet minimum width = (F)
b. Total Building Perimeter = (P)
c. Ratio (F/P) = (F/P)
d. W = Minimum width of public way = (W)
e. Percent of frontage increase I_f = 100[F/P - 0.25] x W/30 = (%)
Unlimited area applicable under conditions of Section 507.
Maximum Building Area = total number of stories in the building x D (maximum 3 stories) (506.2).
The maximum area of open parking garages must comply with Table 406.5.4.
Frontage increase is based on the unsprinklered area value in Table 506.2.

ALLOWABLE HEIGHT
Building Height in Feet (Table 504.3) 2 75' Existing
Building Height in Stories (Table 504.4) 3 4 1 (Existing)

Provide code reference if the "Shown on Plans" quantity is not based on Table 504.3 or 504.4.
The maximum height of air traffic control towers must comply with Table 412.3.1.
The maximum height of open parking garages must comply with Table 406.5.4.

2018 NC Administrative Code and Policies

ENERGY REQUIREMENTS:
The following data shall be considered minimum and any special attribute required to meet the energy code shall also be provided. Each Designer shall furnish the required portions of the project information for the plan data sheet. If performance method, state the annual energy cost for the standard reference design vs annual energy cost for the proposed design.
Existing building envelope complies with code: No Yes (The remainder of this section is not applicable)
Exempt Building: No Yes (Provide code or statutory reference):
Climate Zone: 3A 4A 5A
Method of Compliance: Energy Code Performance Prescriptive
ASHRAE 90.1 Performance Prescriptive
(If "Other" specify source here)

THERMAL ENVELOPE (Prescriptive method only)
Roof/ceiling Assembly (each assembly)
Description of assembly:
U-Value of total assembly:
R-Value of insulation:
Skylights in each assembly:
U-Value of skylight:
total square footage of skylights in each assembly:
Exterior Walls (each assembly)
Description of assembly:
U-Value of total assembly:
R-Value of insulation:
Openings (windows or doors with glazing)
U-Value of assembly:
Solar heat gain coefficient:
projection factor:
Door R-Values:
Walls below grade (each assembly)
Description of assembly:
U-Value of total assembly:
R-Value of insulation:
Floors over unconditioned space (each assembly)
Description of assembly:
U-Value of total assembly:
R-Value of insulation:
Floors slab on grade
Description of assembly:
U-Value of total assembly:
R-Value of insulation:
Horizontal/vertical requirement:
slab heated:

2018 NC Administrative Code and Policies

ETR - EXISTING TO REMAIN FIRE PROTECTION REQUIREMENTS
BUILDING ELEMENT FIRE SEPARATION DISTANCE (FEET) RATING REQ'D PROVIDED (W/REDUCTION) DETAIL # AND SHEET # DESIGN # FOR RATED ASSEMBLY SHEET # FOR RATED PENETRATION SHEET # FOR RATED JOINTS
Structural Frame, including columns, girders, trusses
Bearing Walls
Exterior
North
East
West
South
Interior
Nonbearing Walls and Partitions
Exterior walls
North
East
West
South
Interior walls and partitions
Floor Construction
Including supporting beams and joists
Floor Ceiling Assembly
Columns Supporting Floors
Roof Construction, including supporting beams and joists
Roof Ceiling Assembly
Columns Supporting Roof
Shaft Enclosures - Exit
Shaft Enclosures - Other
Corridor Separation
Occupancy/Fire Barrier Separation
Party/Fire Wall Separation
Smoke Barrier Separation
Smoke Partition
Tenant/Dwelling Unit/ Sleeping Unit Separation
Incidental Use Separation

* Indicate section number permitting reduction.


2018 NC Administrative Code and Policies



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Project Team:
Franchisee: Patel, Nirav
P: 256.394.7161
niravpatel1@live.com

General Contractor: To Be Selected

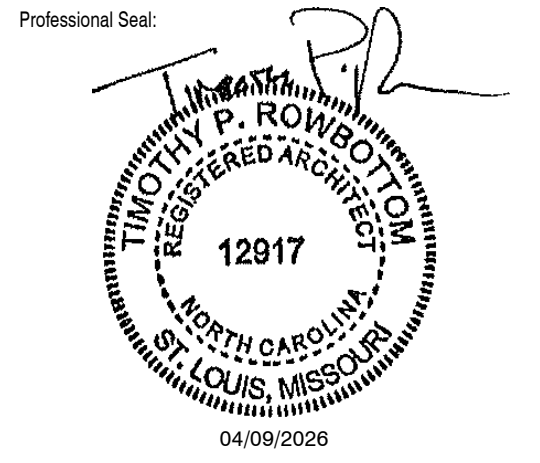

04/09/2026

Project Title:

COMMERCIAL TENANT IMPROVEMENT FOR:
THE UPS STORE, INC.
Center #: 8278 - Cameron, NC
183 Mittie Haddock Dr, Cameron, NC 28326


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No. Description Date

Sheet Title:

Appendix B
Project Number: 2026901.084
Sheet Number:
Drawn By: CEL
Issue Date: 04/09/2026
A0.2




Project Title:

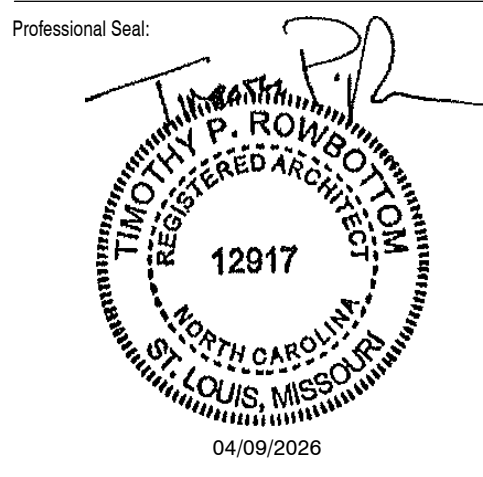GRAPHIC INSTALL INSTRUCTIONS WALL DECALS, WINDOWS CLINGS & SMALL BOX DISPLAYS

WALL DECAL INSTALLATION

- 1. INSTALL WALL GRAPHICS 5-7 DAYS AFTER WALLS HAVE BEEN PAINTED TO ALLOW FOR OFF-GASSING. 2. CLEAN SURFACE THOROUGHLY WHERE DECAL IS TO BE APPLIED... 3. PLACE DECAL (WITHOUT REMOVING THE BACKING PAPER) INTO POSITION ON SURFACE AND MAKE REMOVABLE GUIDES ON SURFACE WITH MASKING TAPE ON TOP, AS SHOWN ABOVE. 4. TURN DECAL UPSIDE DOWN ON A FLAT SURFACE... 5. PLACE ONE CORNER EDGE OF THE DECAL WITH PRE-MASK INTO POSITION. 6. AFTER DECAL IS STRAIGHT AND IN CORRECT POSITION, PRESS THE DECAL SLOWLY AND GENTLY AGAINST THE SURFACE... 7. WHEN ALL BUBBLES ARE REMOVED, BURNISH THE DECAL FIRMLY... 8. PEEL OFF THE PRE-MASK LAYER SLOWLY.

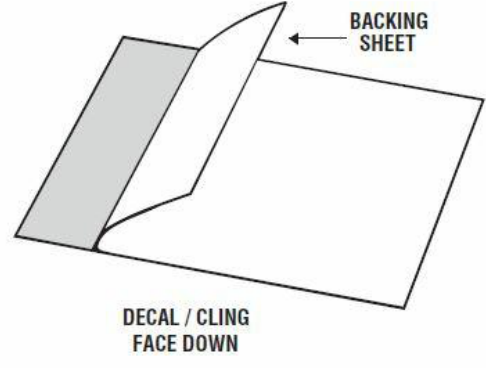


EXTERIOR WINDOWS GRAPHIC INSTALLATION

- 1. INSTALL EXTERIOR WINDOW GRAPHICS WHEN WINDOW TEMPERATURE IS 40-85 DEGREES FAHRENHEIT DURING INSTALLATION AND 24 HOURS AFTER THE VINYL GRAPHIC IS INSTALLED. 2. INSPECT WINDOWS FOR ANY ADHESIVE REMNANTS, PAINT SPECS, GRIME AND LOOSE SILICONE ON GLASS. 3. CLEAN SURFACE THOROUGHLY WHERE CLING IS TO BE APPLIED... 4. VERNY CAREFULLY SCRAPE OFF ANY CONTAMINATES ON THE INSTALLATION SURFACE... 5. PEEP BACKING SHEET OFF OF CLING. 6. PLACE IN LOCATION SO THAT ANY COPY WILL BE READ FROM THE DESIRED DIRECTION... 7. MAKE SURE NO AIR BUBBLES ARE TRAPPED BENEATH... 8. ONCE APPLICATION OF VINYL IS COMPLETED, THE EXCESS VINYL WILL NEED TO BE CUT...




SMALL BOX DISPLAY INSTALLATION

- 1. MEASURE TO DETERMINE PLACEMENT OF THE ASSEMBLED BOX DISPLAY ON WALL, MAKING SURE THE TEMPLATE IS LEVEL, TAPE TO WALL WITH REMOVABLE TAPE. 2. USE A PENCIL TO MARK THE HOLE LOCATIONS ON WALL. REMOVE TEMPLATE. 3. INSTALL ANCHORS WHERE MARKED ON WALL FROM STEP 2... 4. TURN SCREWS INTO ANCHORS LEAVING ABOUT 1/4" OF THE SCREW EXPOSED. 5. ALIGN HOLES IN BACKER OF BOX DISPLAY WITH EXPOSED SCREWS AND HANG PANEL TO WALL... 6. PLACE IN LOCATION SO THAT ANY COPY WILL BE READ FROM THE DESIRED DIRECTION...

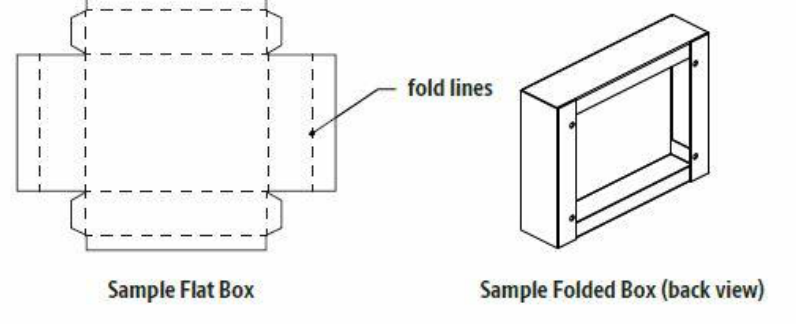

Assembled Boxes mounted to the Display Backer Front View of Small Box Display

- SUPPLIES NEEDED: 70% ISOPROPYL ALCOHOL, AMMONIA FREE GLASS CLEANER, SQUEEGEE, MICROFIBER TOWELS, BIMM STAINLESS STEEL SHARP KNIFE, STAINLESS STEEL SCRAPER, HEAT GUN.

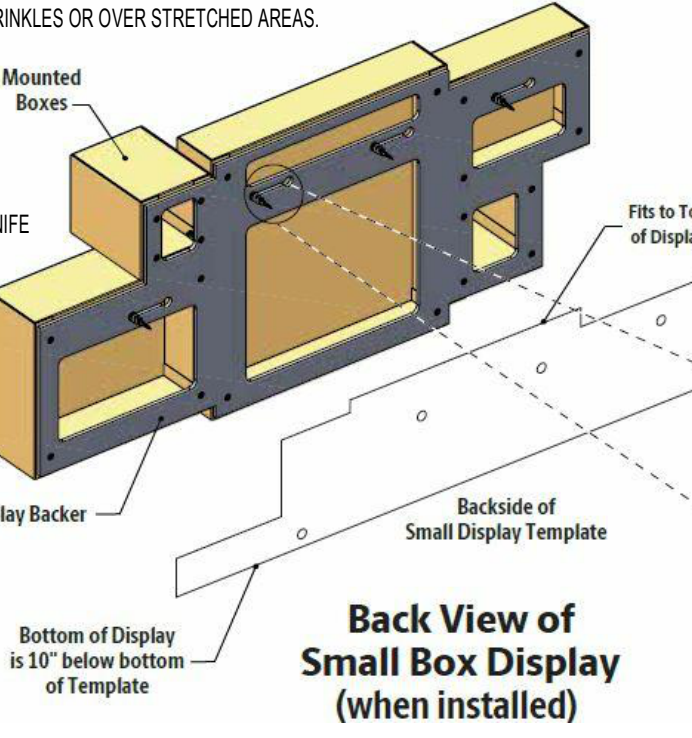

- SMALL BOX DISPLAY (UPS-3018-Y) INCLUDES: 1 - FLAT BOX "12X9X3", 1 - FLAT BOX "6X6X6", 1 - FLAT BOX "20X20X12 AND 20X20X20", 1 - FLAT BOX "6X6X6", 1 - FLAT BOX "15X12X10", 20 - PHILLIPS FLAT-HEAD SCREWS, 20 - FLANGED WING NUTS, 4 - WALLBOARD ANCHORS, 4 - PHILLIPS SELF-DRILL #8 SCREWS, 1 - DISPLAY BACKER (46.5" X 19.5"), 1 - INSTALLATION TEMPLATE (46.5" X 10")

HANGING SIGN INSTALL INSTRUCTIONS

The UPS Store Hanging Sign Install Instructions: Hanging Sign Kits GX-43A 18" or GX-43B 10"

- Kit Contents: 1. GX-43A, 17"W x 18"H P&S, 7/2"W x 18"H RTN, 36"W x 18"H PS and hardware (see hardware list) OR 2. GX-43B, 11"W x 10"H P&S, 7/2"W x 10"H RTN, 36"W x 10"H PS and hardware (see hardware list)








Graphics Panels

Table with columns for Formats (A, B, C, DL, DS, E), Pack & Ship Return, and Print Shop Return. Includes a note about the GC's responsibility for the graphics panels.

Hanging Options

- Drywall Ceilings and Drop Ceiling Panels: When hanging on drop ceiling rails... Panel Bracket: This applies to all connections to the panels regardless of the method used to attach the wire to the ceiling... Celling Figures: When hanging on existing ceiling fixtures...

Positioning and Hardware Installation

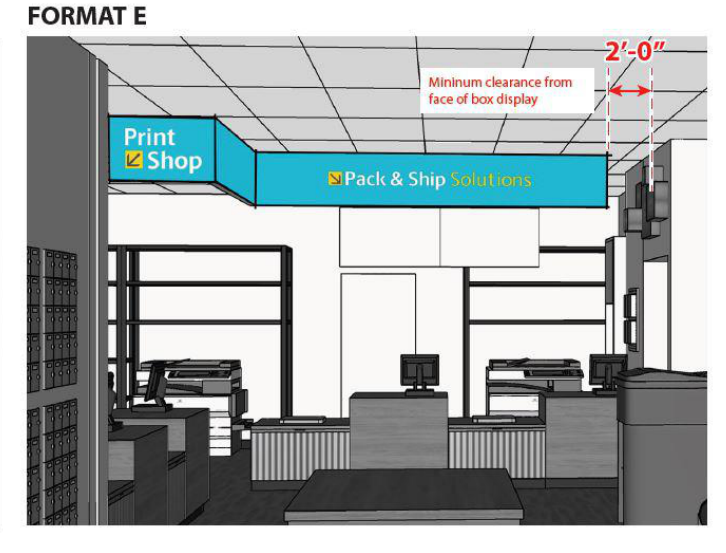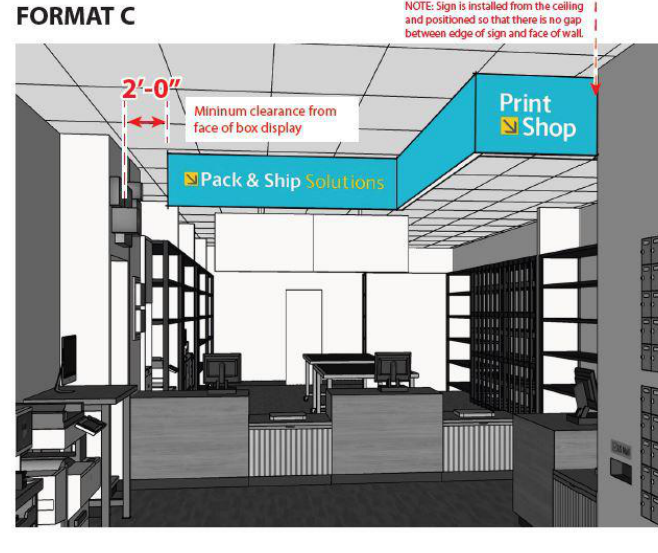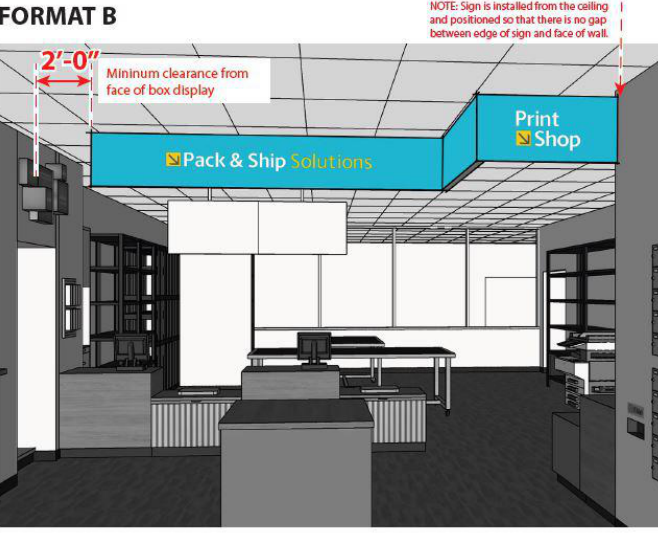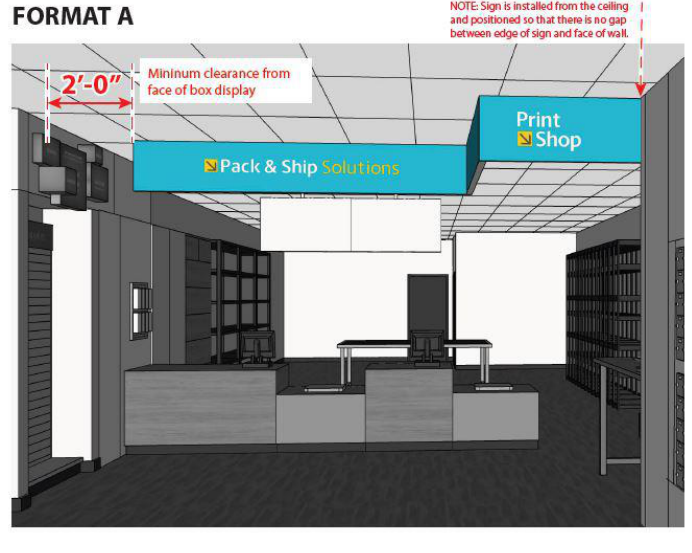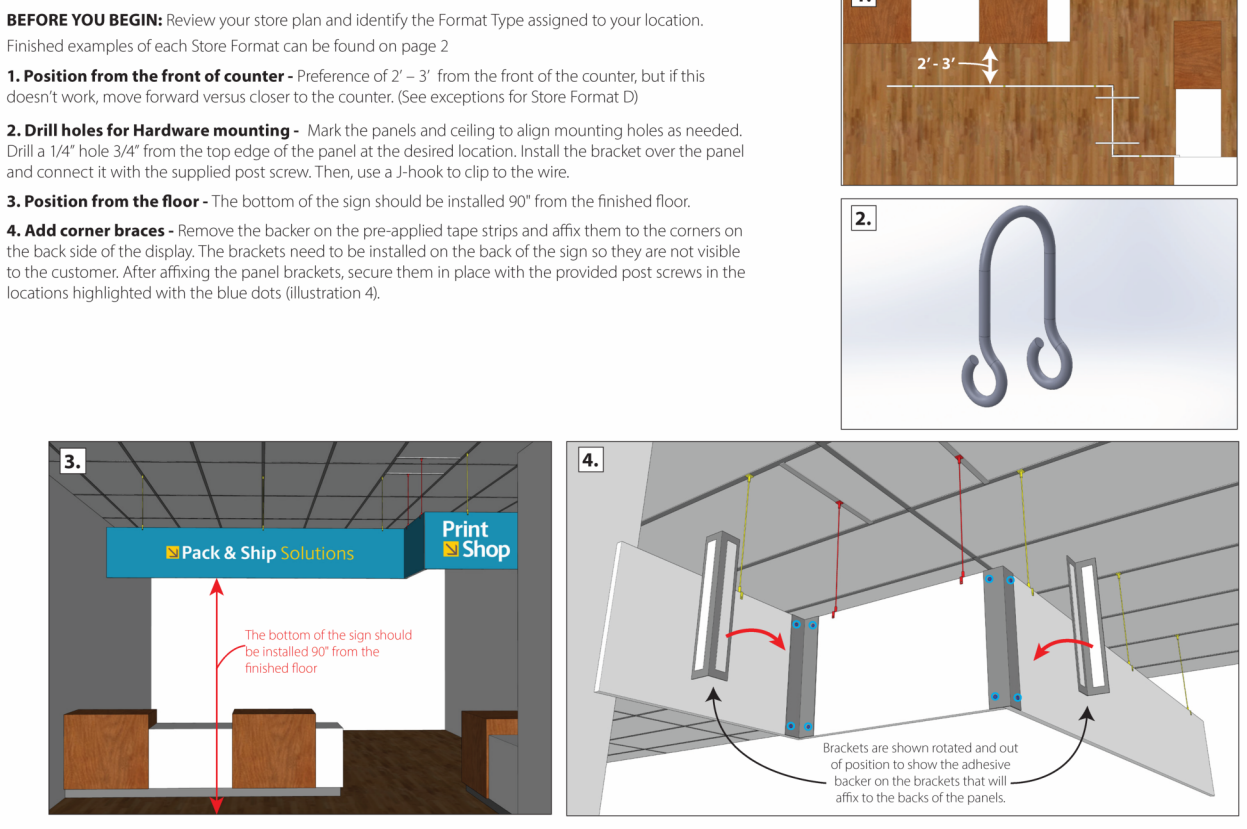

THE UPS STORE HANGING SIGN EXAMPLES

- THE UPS STORE DESIGN TEAM DETERMINED THE HANGING SIGN FORMAT TYPE. HANGING SIGNS ARE REQUIRED TO BE INSTALLED ACCORDING TO THE CENTER'S THE UPS STORE DESIGN INTENT DRAWINGS AND CONSTRUCTION DOCUMENTS. SIGN FORMAT MAY NOT BE PLACED ACCORDING TO THE GENERAL CONTRACTOR/FRANCHISEE.

FORMAT DL - L-Shaped Counter



FORMAT DS - Straight POS counter



COMMERCIAL TENANT IMPROVEMENT FOR: THE UPS STORE, INC. Center #: 8278 - Cameron, NC 183 Mittie Haddock Dr, Cameron, NC 28326

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Table with columns: No., Description, Date.


Sheet Title: Graphic & Sign Install Instructions

4/9/2026 9:01:47 AM \\vs-f62\users\SS\Documents\BIM\LOCAL\pln_202601084_024_Charlotte.Lorenz.RMW\B.dwg

Office: 319 N. Fourth Street, Suite 1000
St. Louis, MO 63102
p 314-231-5700
f 314-231-0816

Project Team:
Franchisee: Patel, Nirav
P: 256.394.7161
niravpatel1@live.com

General Contractor: To Be Selected

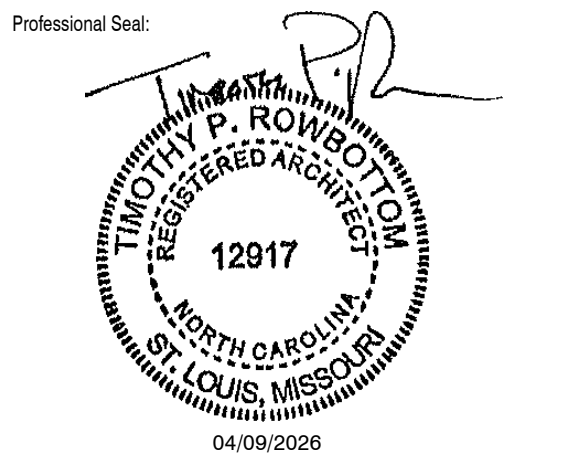

Project Title:

COMMERCIAL TENANT IMPROVEMENT FOR:
THE UPS STORE, INC.
Center #: 8278 - Cameron, NC
183 Mittie Haddock Dr, Cameron, NC 28326

The Professional Architect's seal affixed to this sheet applies only to the material and items shown on this sheet. All drawings, instruments or other documents not exhibiting this seal shall not be considered prepared by this architect, and this architect expressly disclaims any and all responsibility for such plans, drawings or documents not exhibiting this seal.


This drawing and details on it are the sole property of the architect and may be used for this specific project only. It shall not be loaned, copied or reproduced, in whole or part, or for any other purpose or project without the written consent of the architect.

No.	Description	Date


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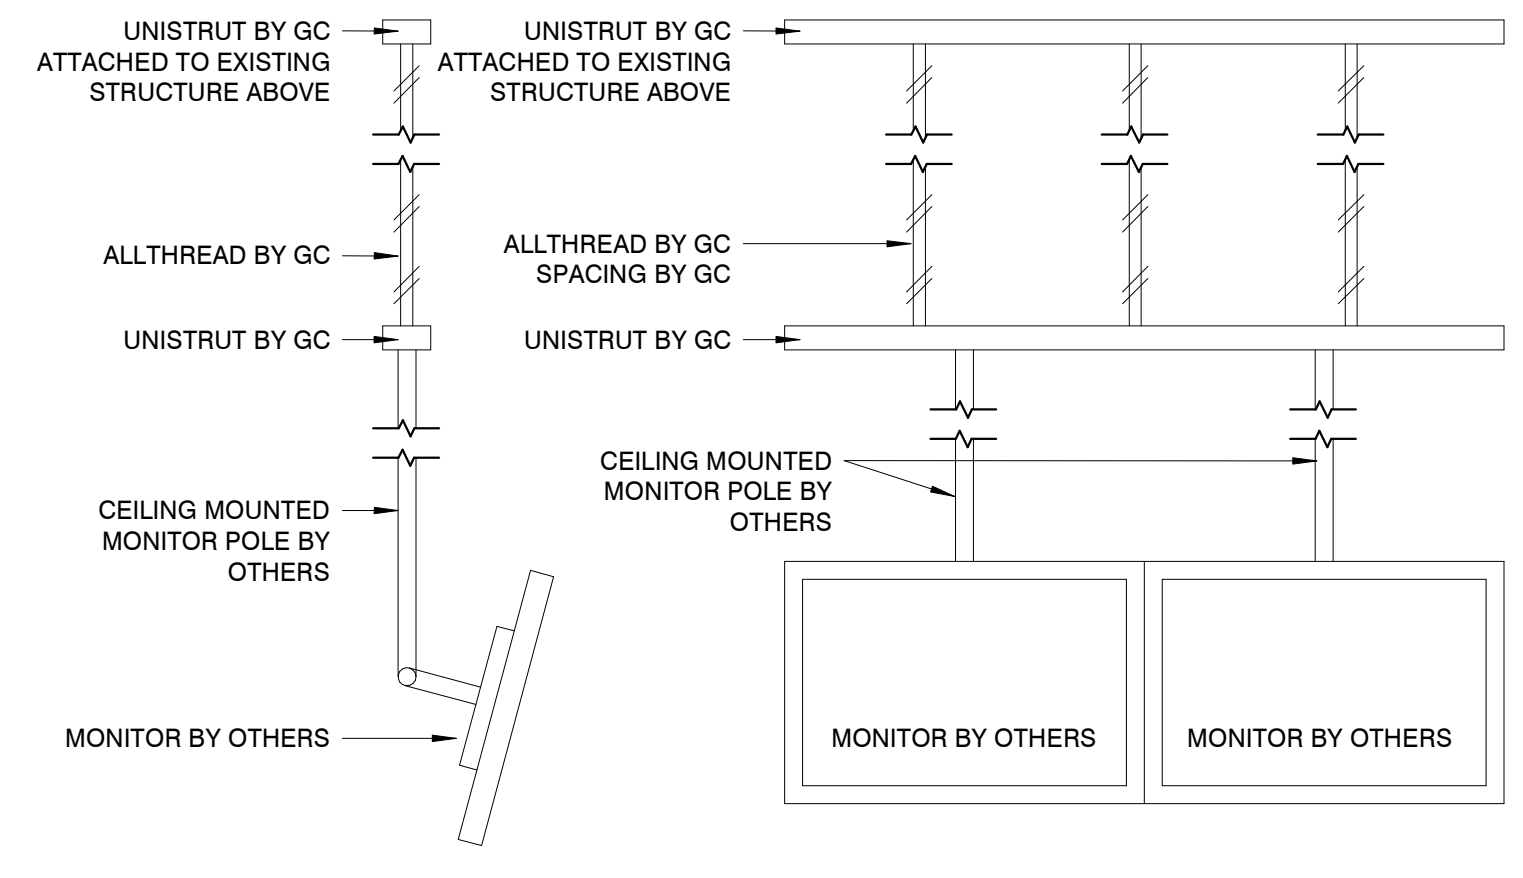
Project Number: 202601.084
Drawn By: CEL
Issue Date: 04/09/2026
Sheet Number: **A9**




3 PLAN SECTION THROUGH CONV. GATE POCKET FOR SLIDING GATES
A9 1 1/2" = 1'-0"

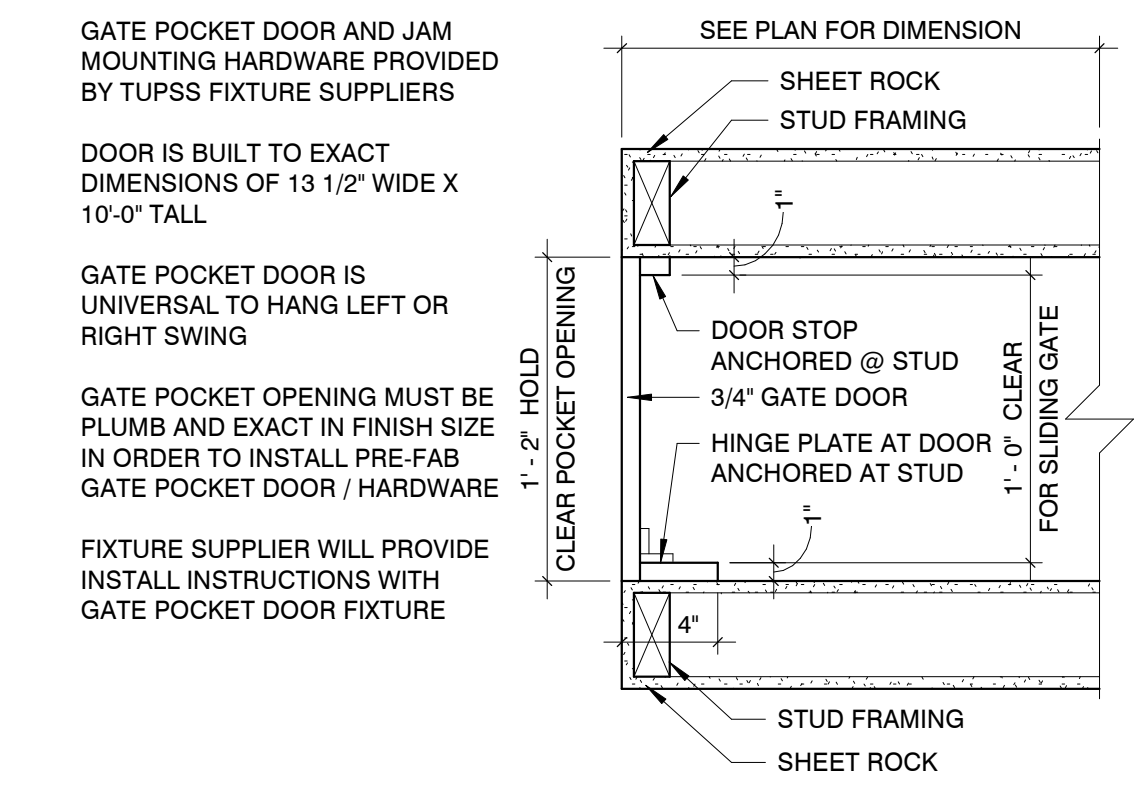


4 POS COUNTER - KNOCKOUTS
A9 3/4" = 1'-0"

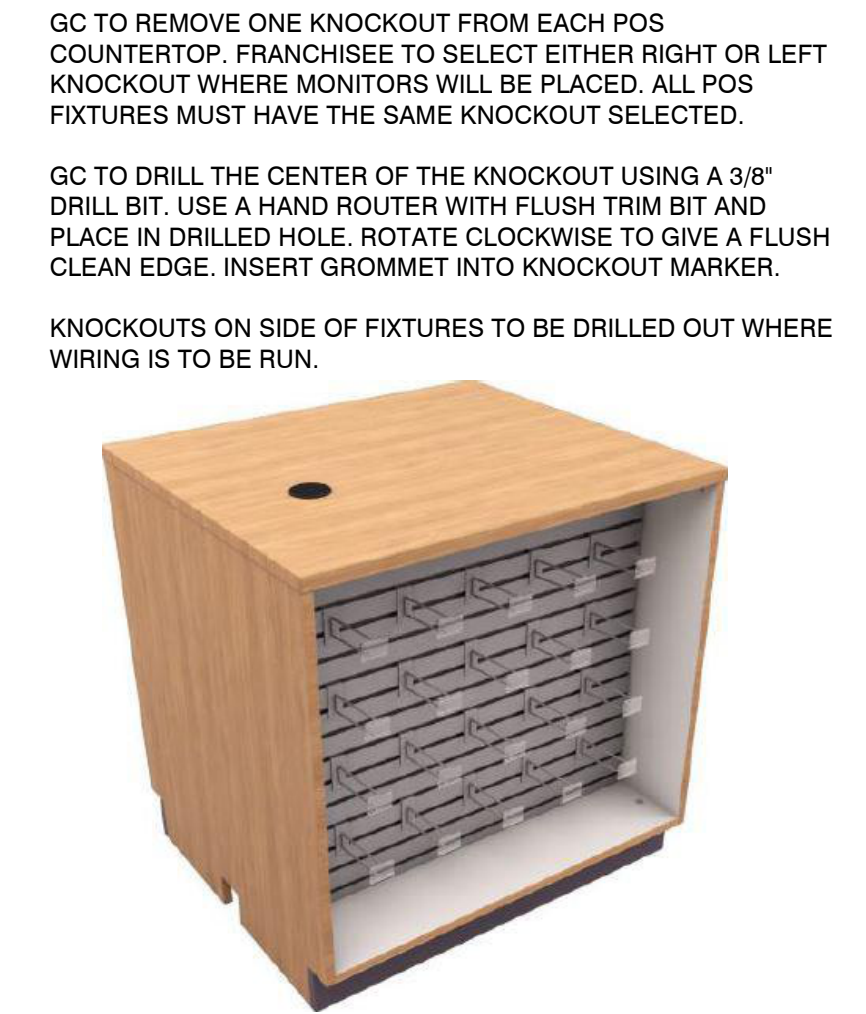


5 MONITOR MOUNT DETAIL FOR OPEN CEILINGS OR CEILINGS ABOVE 12'-0"
A9 3/4" = 1'-0"

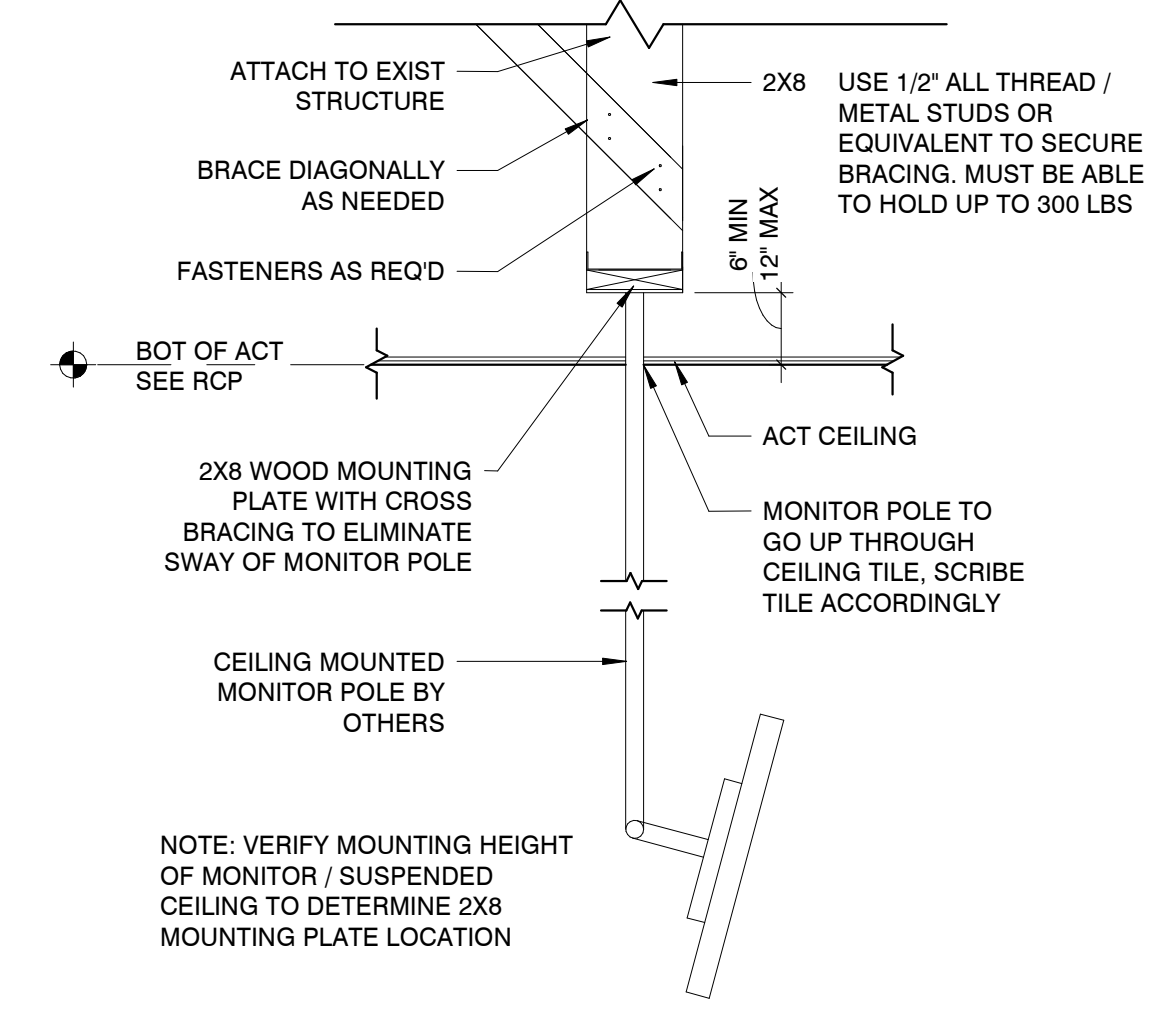


6 MONITOR MOUNT DETAIL TYP
A9 3/4" = 1'-0"

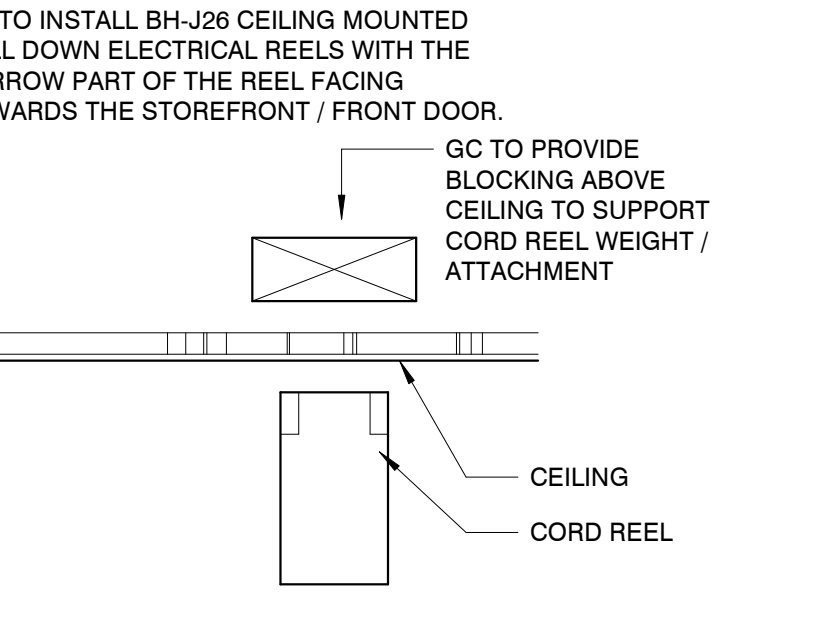


7 RETRACTABLE EXTENSION CORD
A9 3" = 1'-0"

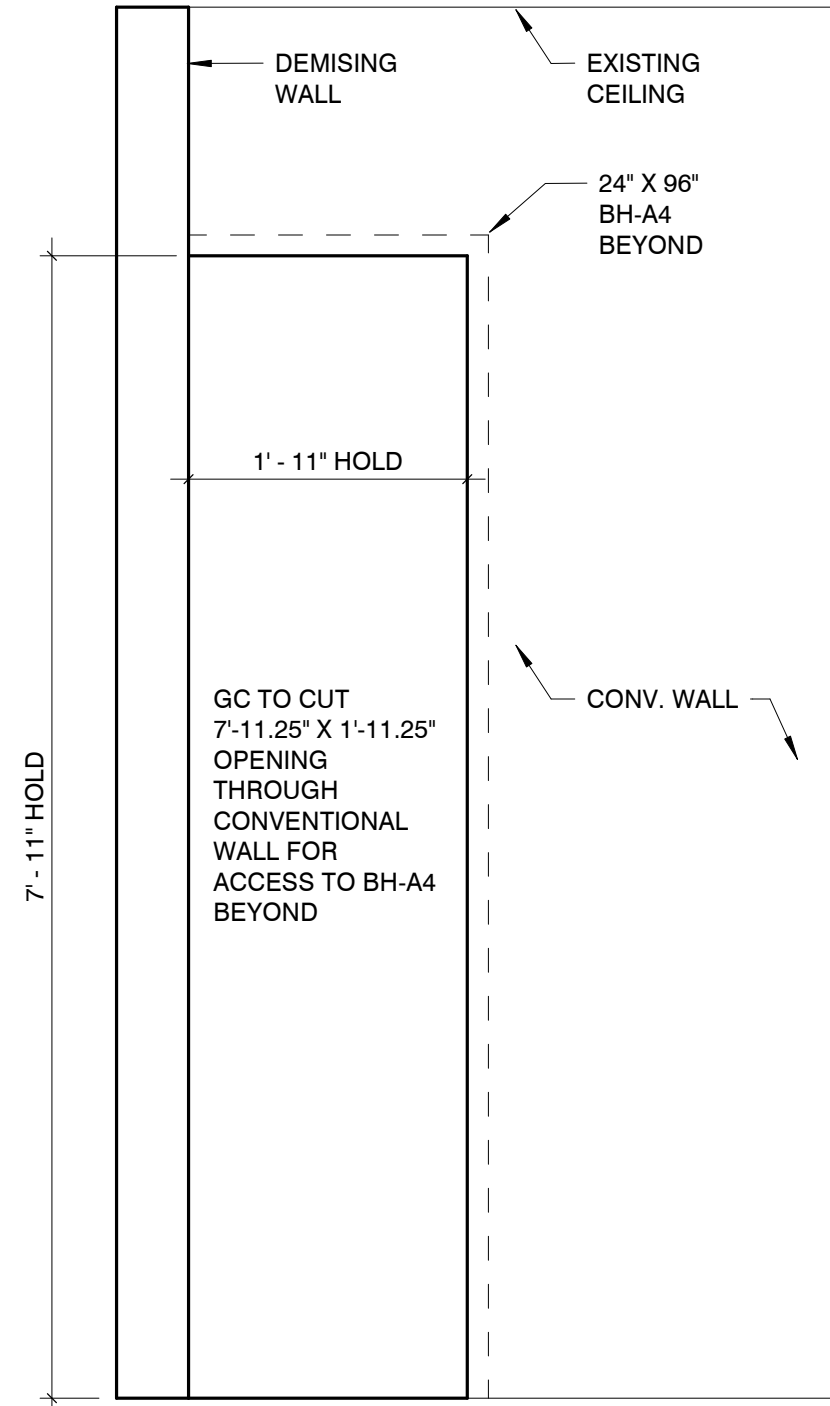

9 ELEV - CONV WALL ACCESS FOR BH-A4
A9 3/4" = 1'-0"

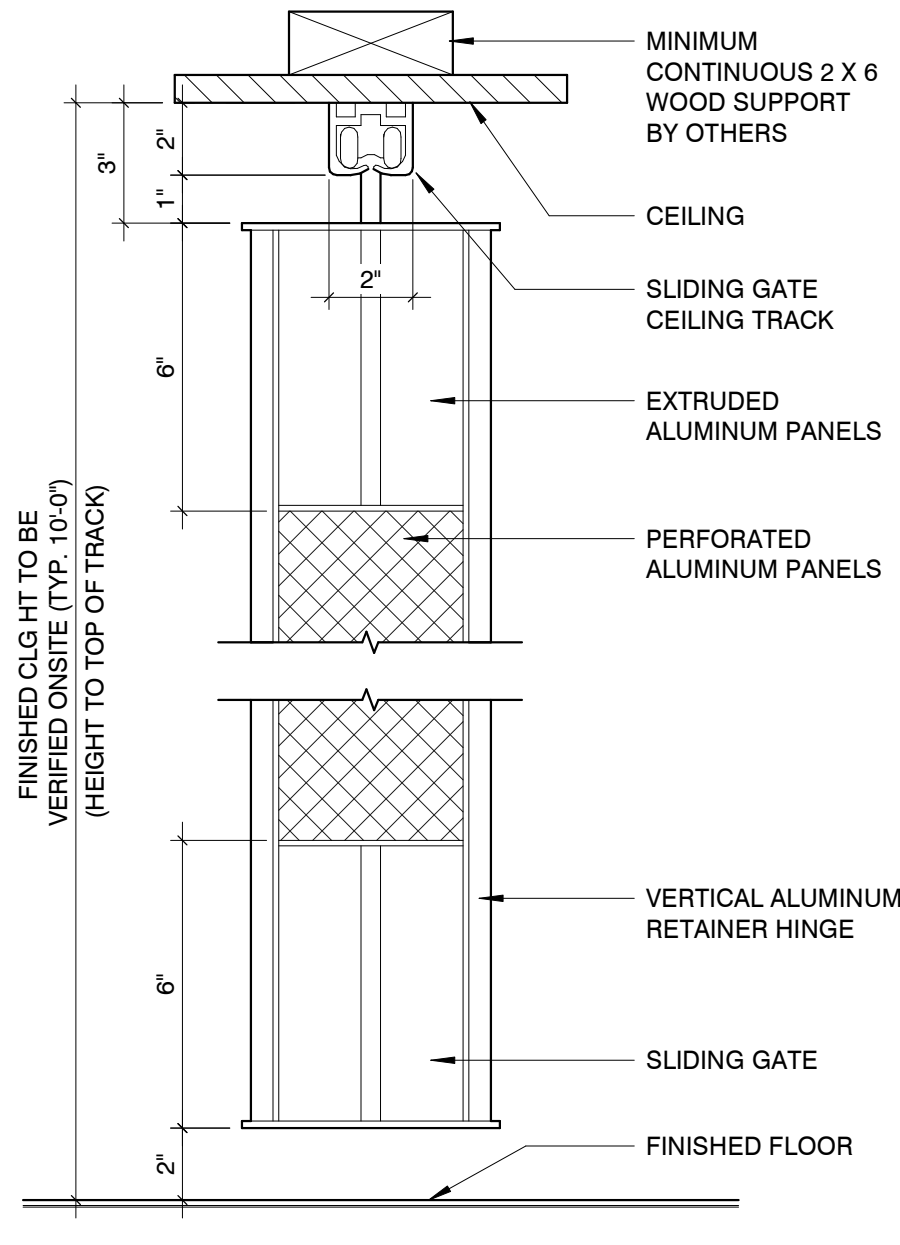

10 HEADER TRACK SUPPORT DETAIL
A9 3" = 1'-0"

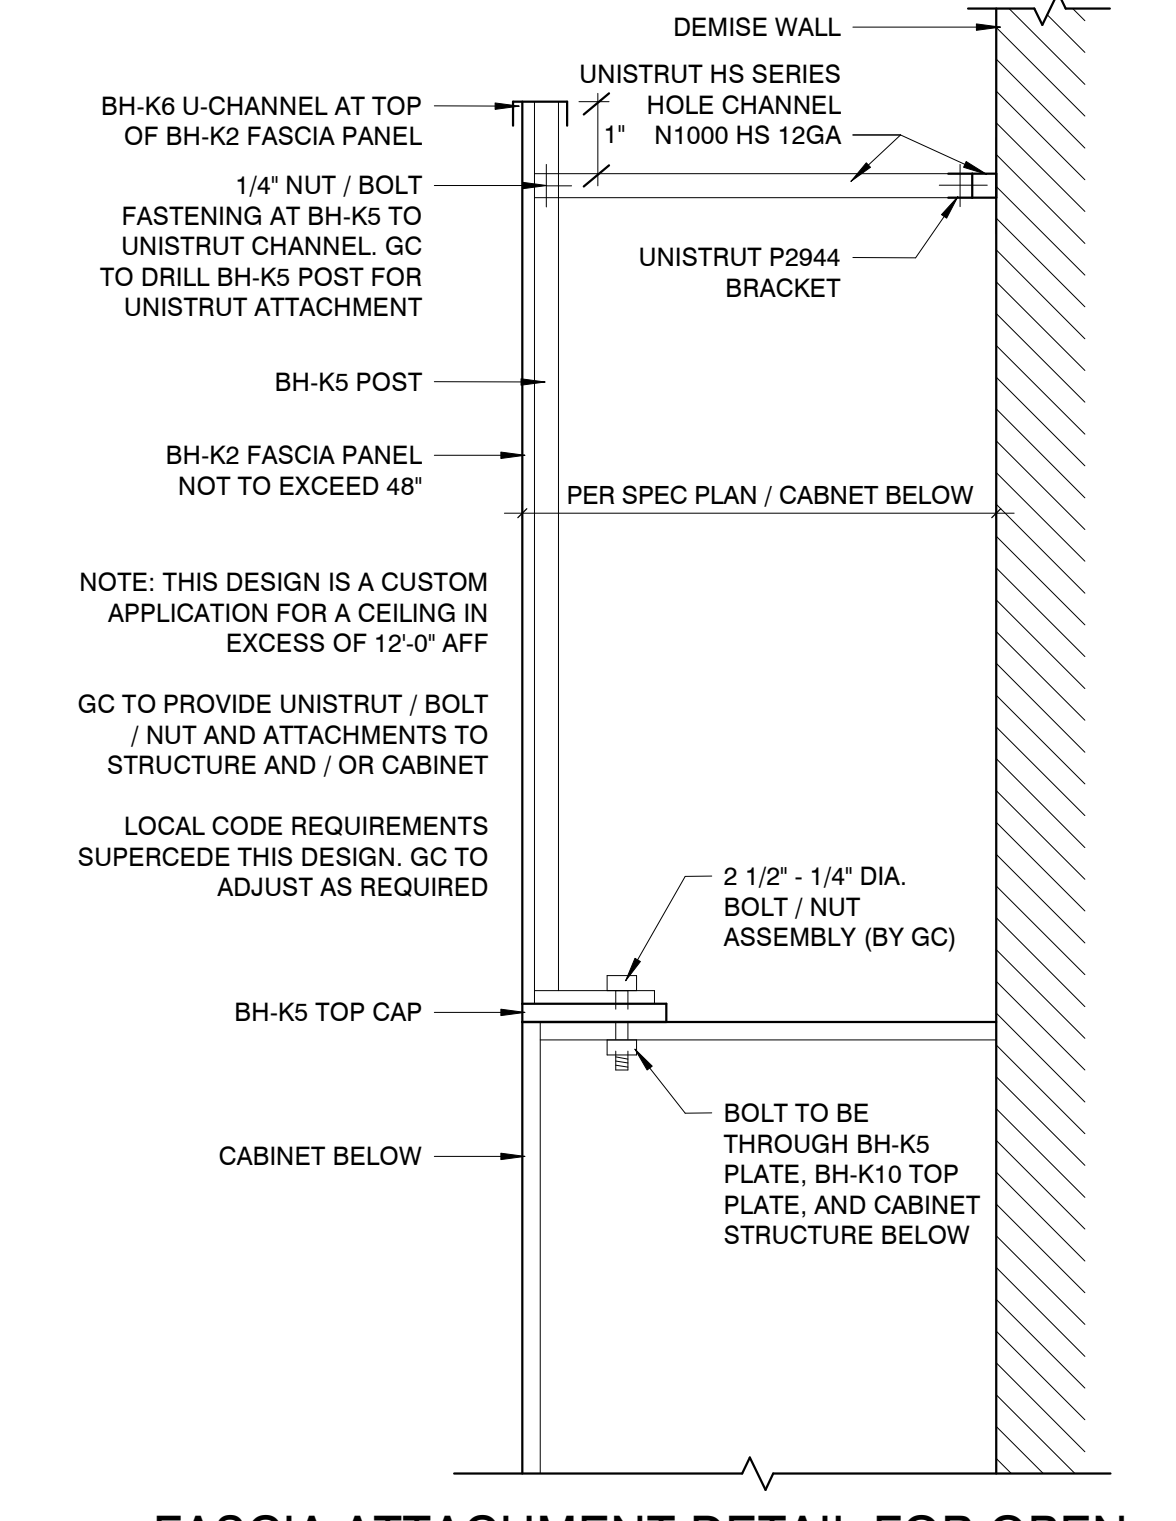


11 FASCIA ATTACHMENT DETAIL FOR OPEN CEILINGS OR CEILINGS ABOVE 12'-0"
A9 1 1/2" = 1'-0"


3C FIXTURE INSTALL MANUAL:

VIRA INSIGHTS FIXTURE INSTALL MANUAL:

12 FIXTURE INSTALL QR CODES
A9 3/4" = 1'-0"

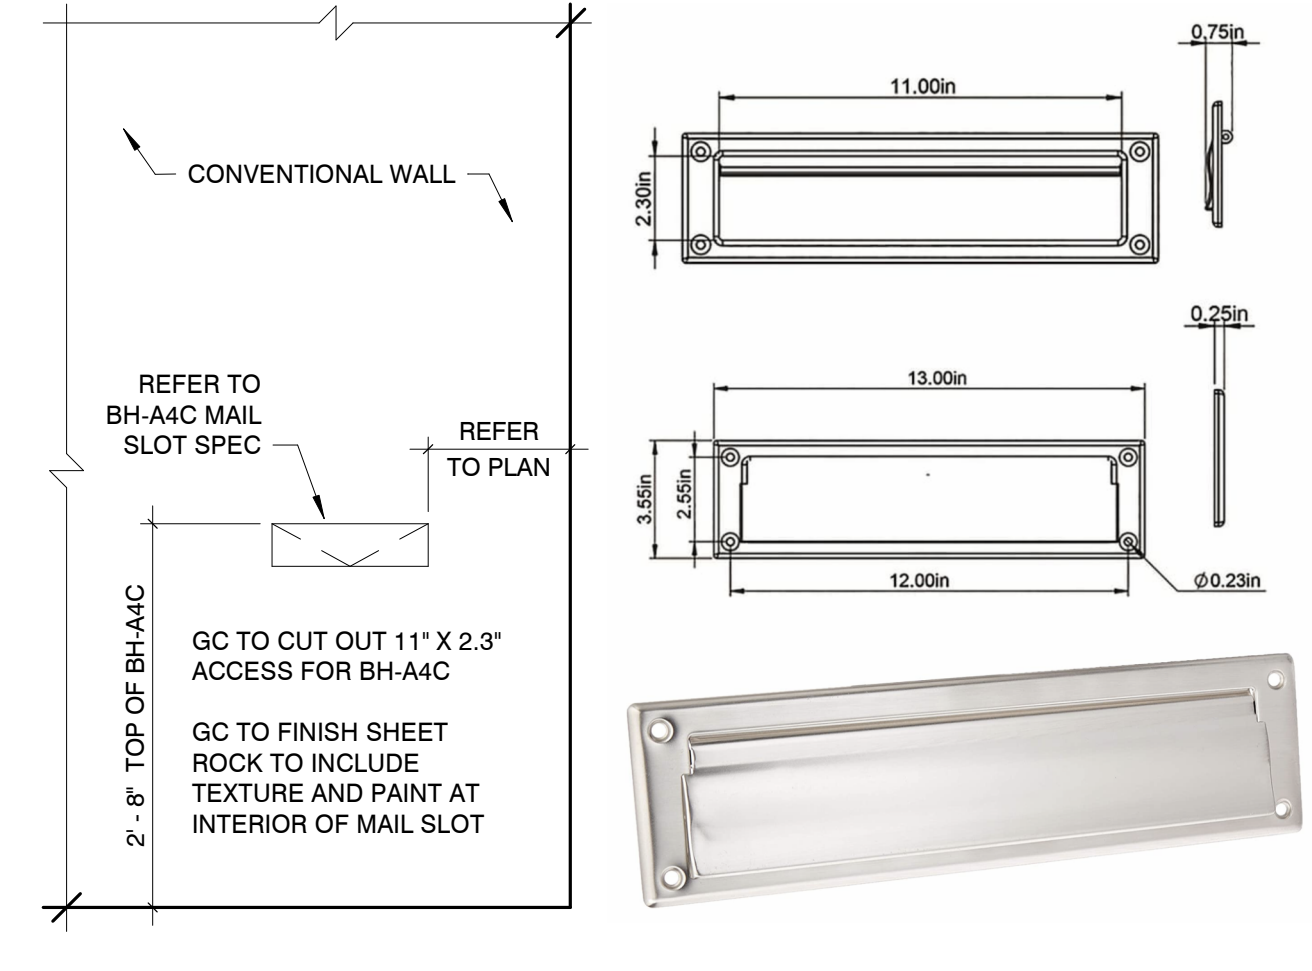

13 BH-A4C MAIL SLOT MOUNTING INSTALL - CONVENTIONAL WALLS
A9 3/4" = 1'-0"

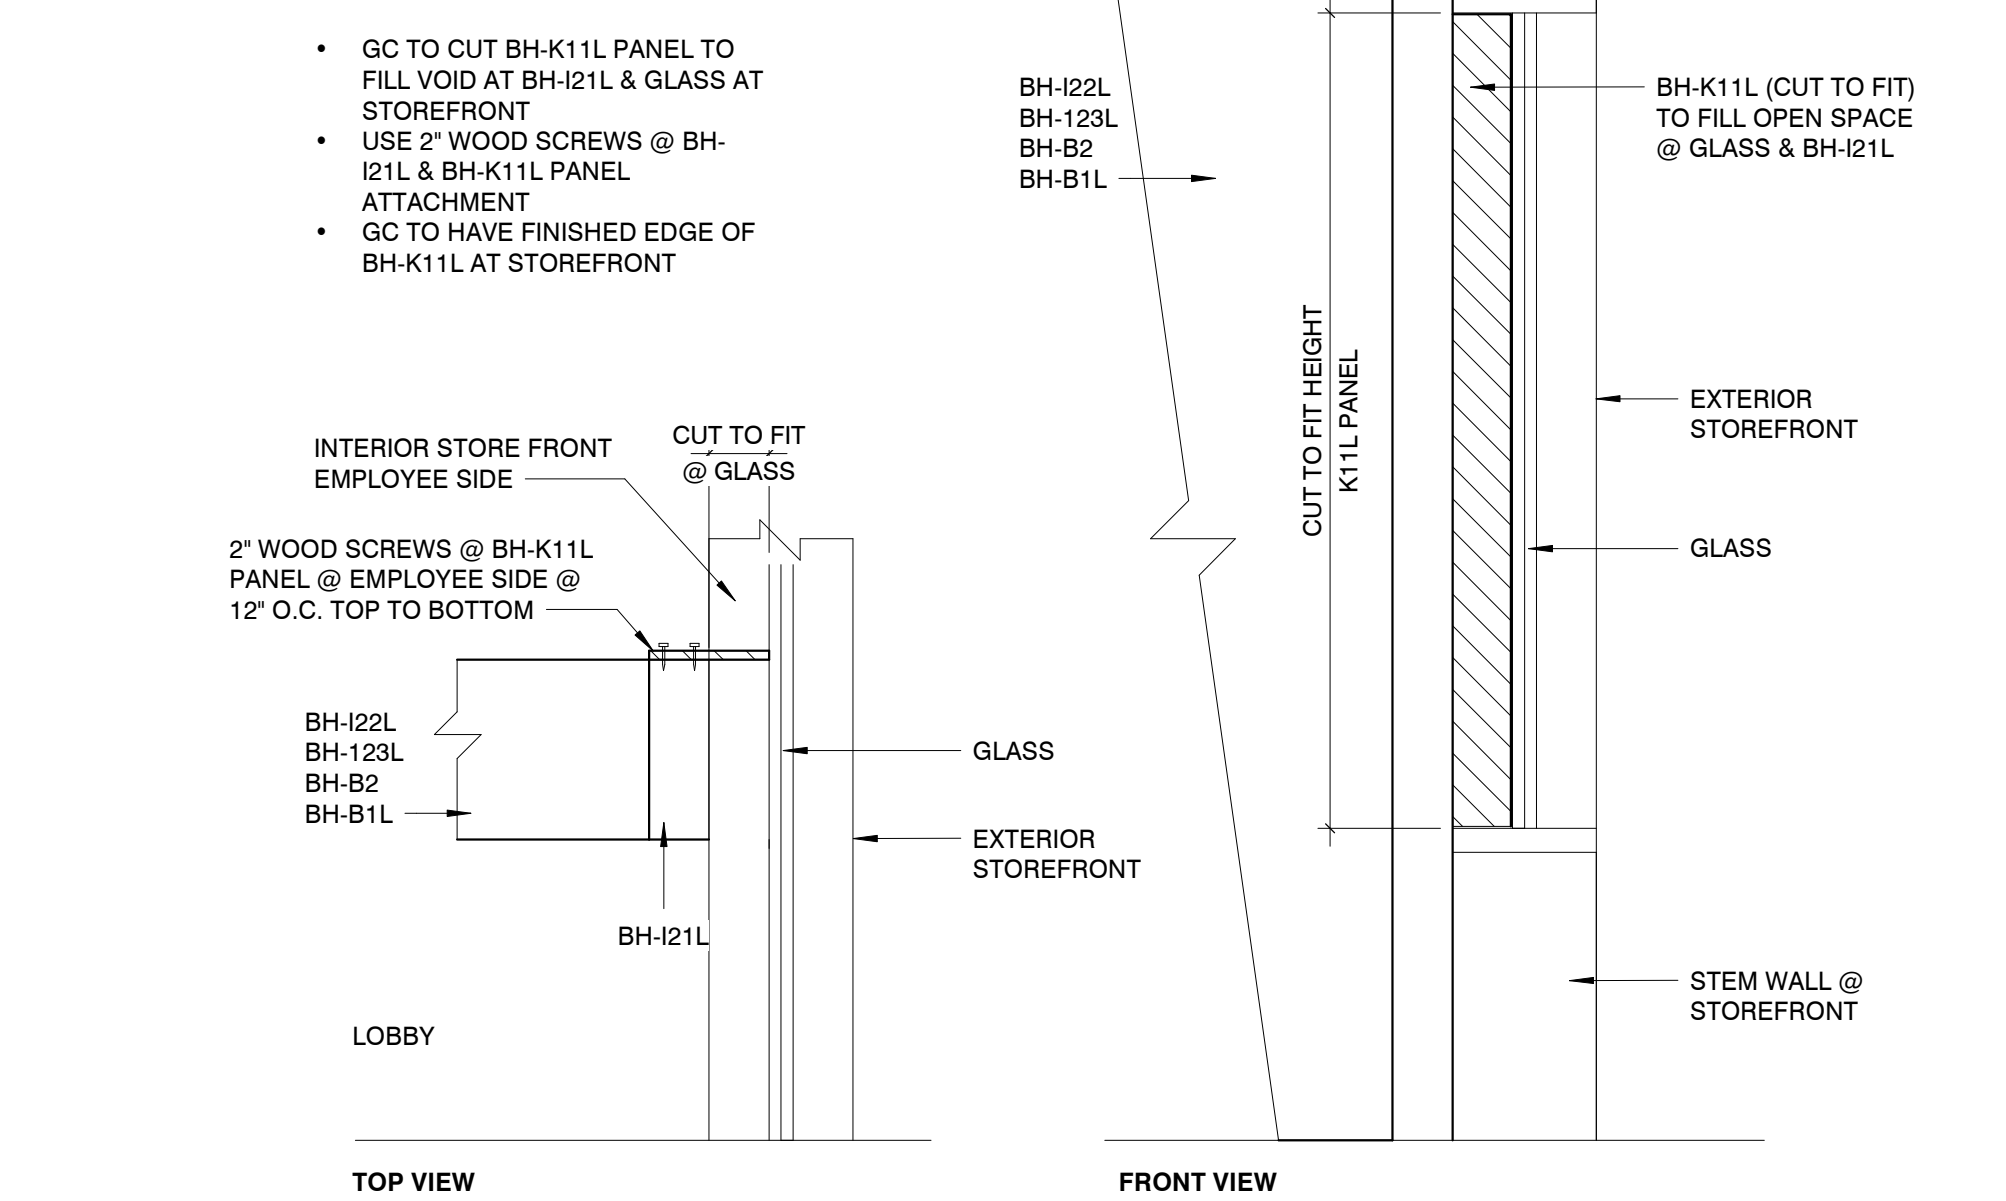

14 STOREFRONT FILLER @ BH-I21L APPLICATION
A9 3/4" = 1'-0"

