

HWY 42 STORE ALL

HOLLY SPRINGS, NORTH CAROLINA

SUBMITTED TO:

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NOTE: DETAIL LABELS CONTAINED WITHIN THIS SET OF PLANS MAY REFERENCE THE ERECTION DRAWINGS MARKED IN THIS SCHEDULE. EXAMPLE: DETAIL A/900 REFERS TO DETAIL "A" LOCATED ON ERC900X.

	ERECTION DRAWINGS								
ERC010X		ERC200X		ERC420X		ERC619X		ERC752X	l
ERC016X	X	ERC201X	X	ERC500X		ERC620X		ERC753X	T
ERC100X	X	ERC202X	X	ERC505X	X	ERC621X		ERC754X	Τ
ERC105X	X	ERC203X	X	ERC506X	X	ERC622X		ERC800X	Ī
ERC106X		ERC204X		ERC515X		ERC623X		ERC900X	T
ERC110X	X	ERC206X		ERC600X	X	ERC624X		ERC901X	Ī
ERC112X	X	ERC207X		ERC601X	X	ERC625X		ERC902X	T
ERC115X	X	ERC208X	X	ERC602X	X	ERC626X		ERC903X	Ī
ERC125NXT		ERC209X		ERC603X		ERC630X	X	ERC904X	Ī
ERC130X	X	ERC250X	X	ERC604X		ERC631X	X	ERC905X	I
ERC150X		ERC250XFHP		ERC605X		ERC650X	X	ERC907X	Ī
ERC151X		ERC251X		ERC606X		ERC651X		ERC908X	Ī
ERC152X		ERC251XFHP		ERC607X		ERC652X		ERC910X	Ī
ERC153X		ERC252X	X	ERC608X		ERC700X	X	ERC911X	I
ERC154X		ERC252XFHP		ERC609X		ERC710X		ERC912X	
ERC155X		ERC253X		ERC610X		ERC711NXT		ERC913X	
ERC175X		ERC254X	X	ERC611X		ERC713NXT		ERC914X	
ERC176X		ERC255X		ERC612X		ERC720X		ERC915X	I
ERC177X		ERC256X		ERC613X		ERC730X		ERC916X	Ī
ERC178X		ERC257X		ERC614X		ERC731X		ERC917X	I
ERC179X		ERC260X		ERC615NXT		ERC731XFHP		ERC918X	I
ERC180X		ERC262X		ERC616X		ERC732X		ERC919X	
ERC181X		ERC302X	X	ERC617X	X	ERC732XFHP			
ERC182X		ERC410XFL	X	ERC618X	X	ERC750X			I
ERC183X		ERC411X		ERC618XALT	X	ERC751X			

SCHEDULE OF DRAWINGS

DRAWING NO. DESCRIPTION
CS1 COVER SHEET CS2 BUILDING NOTES CS3 APPENDIX B CS4 UL SPECIFICATIONS
F1 FOUNDATION PLAN, DETAIL & NOTES F2 FOUNDATION PLANS & NOTES F3 FOUNDATION PLAN & NOTES F4 FOUNDATION PLAN & NOTES F5 FOUNDATION DETAILS
S1 ELEVATIONS & NOTES S2 FLOOR PLAN, SECTION, DETAIL & NOTES S3 FLOOR PLAN & NOTES S4 FLOOR PLAN, & NOTES S5 CROSS SECTION, & DETAILS

BUILDING DETAILS FRAMING ELEVATIONS

FLOOR PLAN. CROSS SECTION, DETAILS & NOTES

WIND LOAD DESIGN DATA:

ULTIMATE DESIGN WIND SPEED(V_{ULT}): 115 MPH

NOMINAL DESIGN WIND SPEED (V_{ASD}): 90 MPH

RISK CATEGORY: II

WIND EXPOSURE: B

INTERNAL PRESSURE COEFFICIENT: ± 0.18

SNOW LOAD DESIGN DATA:

GROUND SNOW LOAD (P_g) : 15.0 PSF FLAT-ROOF SNOW LOAD (P_f) : 12.1 PSF SNOW EXPOSURE FACTOR (C_e) : 1.2 SNOW LOAD IMPORTANCE FACTOR (I_S) : 1.0 THERMAL FACTOR (C_t) : 1.2

EARTHQUAKE LOAD DESIGN DATA:

- RISK CATEGORY: II
- SEISMIC IMPORTANT FACTOR (I_E) : 1.0
- SEISMIC DESIGN CATEGORY: C
- ANALYSIS PROCEDURE: EQUIVALENT LATERAL FORCE PROCEDURE (ASCE 7-10 SECTION 12.8)
- BASIC SEISMIC-FORCE-RESISTING SYSTEM: LIGHT FRAMED WALLS WITH STEEL SHEAR PANELS
- SITE CLASS:D
- DESIGN BASE SHEAR:

BUILDING "1": 1.837^K BUILDING "2": 3.200^K BUILDING "3": 0.729^K

- RESPONSE MODIFICATION FACTOR (R): 7.0
- SEISMIC RESPONSE COEFFICIENT (C_s): 0.027

 MAPPED SPECTRAL RESPONSE ACCELERATION:

 (S_S) : 17.4% G

 $(S_1);$ 8.4% G

- SPECTRAL RESPONSE COEFFICIENTS:

(S_{DS}): 18.6% G

 $(S_{D1}): 13.4\% G$

BUILDING DATA:

BUILDING DESCRIPTION:

SINGLE STORY METAL BUILDINGS BOLTED TO CONCRETE SLAB FOUNDATIONS.

BUILDING SIZE:

BUILDING "1" 60' x 180' = 10,800 sq. ft. BUILDING "2" 60' x 395' = 23,700 sq. ft. BUILDING "3" 20' x 270' = 5,400 sq. ft. TOTAL = 39,900 sq. ft. 8'-4" EAVE HGT. 8'-6" EAVE HGT.

PARKING DATA:

SEE SITE PLAN BY OTHERS

BUILDING CODE:

THE 2018 NORTH CAROLINA BUILDING CODE

DESIGN CRITERIA:

THESE BUILDINGS HAVE BEEN DESIGNED TO CONFORM TO THE STRUCTURAL REQUIREMENTS OF THE 2018 NORTH CAROLINA BUILDING CODE WITH CURRENT REVISIONS.

THESE BUILDINGS HAVE BEEN DESIGNED FOR THE FOLLOWING LIVE LOADINGS IN ADDITION TO THE DEAD LOADINGS:

ROOF LIVE LOADING: 20 psf

FLOOR LIVE LOADING: 125 psf

USE GROUP: S-1

TYPE OF CONSTRUCTION: II-B

IT IS THE RESPONSIBILITY OF THE BUYER/OWNER TO VERIFY THE FIREWALL, LIVE LOAD AND WIND LOAD REQUIREMENTS WITH THE LOCAL CODE AUTHORITY.

PROJECT NUMBER:

NC24204



BETCO, Inc. 228 Commerce Blvd.

Statesville, NC 28625

Limited Engineering License # D-0140

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- FOR INTERIOR AND EXTERIOR FOOTINGS SUPPLIED AND INSTALLED BY BETCO. 2. EXTERIOR OPENINGS, NOT DESIGNATED AS DOOR LOCATIONS, TO BE COMPLETED USING EXTERIOR WALL PANELS
- 3. USE DOW 191 SILICONE CAULK AND 1/2" WIDE BUTYL RUBBER TAPE SEALANT FOR ROOF INSTALLATION. USE DOW 199 SILICONE CAULK AT DOWNSPOUT TO GUTTER JOINT.
- 4. INTERIOR PARTITIONS PERPENDICULAR TO ROOF BEAM(S) MUST BE COMPLETED BEFORE ROOF PANELS ARE INSTALLED. USE PARTITION FRAMING TO PLUMB AND SQUARE COLUMNS AND HEADER SECTIONS. CHECK BUILDING WIDTH AT TOP OF COLUMNS PRIOR TO ROOF INSTALLATION.
- 5. THOROUGHLY SWEEP ROOF PANELS FOLLOWING INSTALLATION TO REMOVE METAL DRILLINGS.
- 6. THIS DESIGN IS BASED ON USING ONLY METAL BUILDING COMPONENTS WHICH ARE PROPRIETARY TO BETCO. FURTHER, THE PROFESSIONAL ENGINEER'S SEAL IS INVALID UNLESS ONLY BETCO METAL BUILDING COMPONENTS ARE UTILIZED.
- 1. METAL STUDS (IF APPLICABLE) MAY REQUIRE FIELD CUTTING DEPENDING UPON THE EAVE HEIGHT OF THE STRUCTURE.
- 8. UNIT SIZES SHOWN ARE NOMINAL. ACTUAL CLEAR DIMENSIONS INSIDE UNITS MAY YARY ACCORDING TO FINAL DESIGN OF COMPONENTS.
- 9. THESE DRAWINGS ARE THE PROPERTY OF BETCO, INC. AND MAY NOT BE USED OR REPRODUCED IN WHOLE OR IN PART WITHOUT THE EXPRESS WRITTEN CONSENT OF BETCO, INC.
- 10. THESE DRAWINGS SHALL BE USED IN CONJUNCTION WITH AND COORDINATED WITH THE ARCHITECTURAL DRAWINGS AND OTHER CONTRACT DOCUMENTS.
- 11. THE GENERAL CONTRACTOR SHALL VERIFY THE SIZE AND LOCATION OF ALL SLEEVES, PADS, DEPRESSIONS, OPENINGS, ETC. AS REQUIRED BY THE VARIOUS TRADES.

FOUNDATIONS:

- 1. THE FOUNDATION DESIGN IS BASED ON A PRESUMED ALLOWABLE SOIL BEARING PRESSURE OF 3000 PSF.
- NOTIFY ENGINEER IF SITE CONDITIONS DIFFER FROM DESIGN ASSUMPTIONS SPECIFIED. 2. IF FOOTING ELEVATIONS SHOWN OCCUR IN A DISTURBED, UNSTABLE OR UNSUITABLE SOIL,
- THE ENGINEER SHALL BE NOTIFIED.
- 3. TOP OF FOOTING ELEVATIONS ARE SHOWN ON THE DRAWINGS ARE TO BE DETERMINED BY THE CONTRACTOR IN THE FIELD IN ACCORDANCE WITH THE GUIDE LINES SET FORTH IN THE DRAWINGS AND SPECIFICATIONS.
- 4. FILL MATERIAL SHALL BE FREE OF ROOTS. WOOD OR OTHER ORGANIC MATERIAL AND COMPLY WITH THE REQUIREMENTS OF THE GEOTECHNICAL REPORT. MATERIALS USED FOR FILL UNDER FOOTINGS AND WITHIN BUILDING LIMITS SHALL BE TESTED AND APPROVED FOR THE USE BY THE GEOTECHNICAL TESTING AGENCY.
- 5. UTILITY LINES SHALL NOT BE PLACED THROUGH OR BELOW FOUNDATIONS WITHOUT THE STRUCTURAL ENGINEERS APPROVAL
- 6. FOUNDATION WALLS RETAINING EARTH SHALL BE BRACED AGAINST BACK FILLING PRESSURES UNTIL FLOOR SLABS AT TOP AND BOTTOM ARE IN PLACE.
- 1. FOUNDATION WALLS OR GRADE BEAMS HAVING EARTH PLACED ON EACH SIDE SHALL HAVE BOTH FILLED
- SIMULTANEOUSLY TO MAINTAIN A COMMON ELEVATION. 8. DO NOT PLACE CONCRETE IN ANY EXCAVATION CONTAINING ICE, FROST, FROZEN GROUND
- OR FREE WATER FROZEN SUB GRADES MUST BE THAWED AND RECOMPACTED PRIOR TO PLACING
- 9. EARTH FORMED FOOTINGS SHALL CONFORM TO THE SHAPE, LINES, AND DIMENSIONS AS SHOWN ON THE FOUNDATION PLAN. ALL WATER SHALL BE REMOVED BEFORE DEPOSITING CONCRETE.
- 10. BEFORE PLACING CONCRETE, ALL EMBEDDED ITEMS SHALL BE PROPERLY LOCATED, ACCURATELY POSITIONED, AND MAINTAINED SECURELY IN PLACE.
- II. THE CONTRACTOR SHALL COORDINATE AND VERIFY ALL DIMENSIONS PRIOR TO STARTING CONSTRUCTION, AND ANY DISCREPANCY SHALL BE BROUGHT TO THE ATTENTION OF THE ENGINEER.
- 12. PERIMETER FOUNDATION MUST NOT EXCEED 1/4" ELEVATION VARIATION ALONG ANY 50" DISTANCE OF BUILDING LENGTH.
- 13. PERIMETER FOUNDATION TO EXTEND BELOW FROST LINE. VERIFY REQUIRED DEPTH WITH LOCAL BUILDING OFFICIALS PRIOR TO PROCEEDING WITH FOUNDATION WORK AND NOTIFY ENGINEER OF DEVIATION FROM DRAWING.
- 14. THE AMERICAN CONCRETE INSTITUTE DOES NOT RECOGNIZE FIBERMESH AS A SUBSTITUTE FOR WIRE MESH REINFORCED CONCRETE WHEN SUBJECTED TO TENSILE STRESS
- 15. SAW CUT CONTROL JOINTS IN SLAB SURFACE AT APPROXIMATELY 10'-0" INTERVALS ... OFFSET CUIS 2'-6" MINIMUM FROM INTERIOR COLUMN LINES

REINFORCING STEEL:

- REINFORCING STEEL SHALL BE NEW BILLET STEEL, DEFORMED BARS CONFORMING TO ASTM A-615, GRADE 60 (Fy-60,000 PSI).
- 2. FIELD BENDING OF CONCRETE REINFORCING STEEL IS NOT PERMITTED WITHOUT
- WRITTEN APPROVAL OF THE STRUCTURAL ENGINEER.
- 3. ALL REINFORCING SHALL BE DETAILED, FABRICATED AND PLACED IN ACCORDANCE WITH ACI SP-66 "ACI DETAILING MANUAL-1994" AND THE "CRSI MANUAL OF STANDARD PRACTICE", LATEST EDITION.
- 4. PLACE REINFORCEMENT AND TIES IN GROUT SPACES PRIOR TO GROUTING.
- 5. CONCRETE COVERAGE OF REINFORCING STEEL SHALL BE IN
- ACCORDANCE WITH THE FOLLOWING SCHEDULE UNLESS NOTED
- A. FOOTING AND GRADE BEAMS
- IN GROUND CONTACT 3 INCHES B. BEAMS AND COLUMNS
- C. SLABS, WALLS, AND JOISTS
- 2 INCHES 3/4 INCH - NOT EXPOSED TO EARTH, LIQUID OR WEATHER
- 2 INCHES FROM TOP D. SLABS ON GRADE
- E. FORMED SURFACES IN GROUND CONTACT
- 2 INCHES
- 6. DEVELOPMENT LENGTHS AND LAP SPLICES SHALL BE IN ACCORDANCE WITH ACI 318-14 CHAPTER 12 AND AS INDICATED ON THE DRAWINGS. WHERE SPLICES ARE NOT CALLED OUT ON THE DRAWINGS, USE CLASS "B", BUT IN NO CASE SHALL ANY SPLICE BE LESS THAN 12 INCHES, FOR BARS AS INDICATED BELOW THE BASIC DEVELOPMENT LENGTH SHALL BE MULTIPLIED BY THE FACTORS AS INDICATED FOR TENSION OR COMPRESSION AND THEN ROUNDED UP TO THE NEAREST WHOLE INCH. THE FACTORS INDICATED BELOW ARE CUMULATIVE FOR EACH OF THE CONDITIONS APPLICABLE.
- 1. WELDED WIRE MAT/FABRIC SHALL CONFORM TO ASTM AISS AND AISS RESPECTIVELY AND BE LAPPED I'-0' AT ALL SPLICES.
- 8. ALL REINFORCING TERMINATING AT THE TOPS OF COLUMNS AND PILASTERS SHALL BE HOOKED UNLESS OTHERWISE NOTED.
- 9. SUBMIT SHOP DRAWINGS FOR FABRICATION, BENDING, AND PLACEMENT OF CONCRETE REINFORCEMENT. COMPLY WITH ACI DETAILING MANUAL (SP-66) SHOWING BAR SCHEDULES, STIRRUP SPACING, DIAGRAMS OF BENT BARS, ARRANGEMENT OF CONCRETE REINFORCEMENT. INCLUDE SPECIAL REINFORCEMENT REQUIRED AT OPENINGS THROUGH CONCRETE STRUCTURES. INCLUDE ALL ACCESSORIES SPECIFIED/ REQUIRED TO SUPPORT REINFORCING.
- 10. SHOP DRAWINGS SHALL BE REVIEWED BY THE CONTRACTOR PRIOR TO SUBMISSION. DRAWINGS SHALL BEAR THE CONTRACTOR'S APPROVAL STAMP ACCEPTING RESPONSIBILTY FOR DIMENSIONS, QUANTITIES AND COORDINATION WITH THE OTHER
- 11. CONTRACTOR SHALL NOTIFY THE STRUCTURAL ENGINEER AND TESTING AGENCY A MINIMUM OF 48 HOURS PRIOR TO ALL CONCRETE POURS IN ORDER TO PERMIT REINFORCING STEEL REVIEW AS REQUIRED BY THE INSPECTION SCHEDULE.
- 12. REINFORCING IN ALL CONTINUOUS STRIP FOOTINGS SHALL HAVE CORNER BARS OR DOWELS. PROVIDE AT ALL CORNERS AND INTERSECTIONS.

CONSTRUCTION AND SAFETY:

CONTRACTORS RESPONSIBILITY.

OF THE CONTRACTOR.

WORK MAY PROCEED.

- THE CONTRACTOR IS SOLELY RESPONSIBLE FOR ALL SAFETY REGULATIONS, PROGRAMS AND PRECAUTIONS RELATED TO ALL WORK ON THIS PROJECT.
- 2. THE CONTRACTOR IS SOLELY RESPONSIBLE FOR THE PROTECTION OF PERSONS AND PROPERTY EITHER ON OR ADJACENT TO THE PROJECT AND SHALL PROTECT SAME AGAINST INJURY, DAMAGE OR LOSS.
- 3. MEANS AND METHODS OF CONSTRUCTION AND ERECTION OF STRUCTURAL MATERIALS ARE SOLELY THE
- 4. STRUCTURAL DRAWINGS ARE INTENDED TO BE USED IN CONJUNCTION WITH THE DRAWINGS OF OTHER CONSULTANTS
- AND TRADES. THE CONTRACTOR SHALL COORDINATE THE VARIOUS REQUIREMENTS.
- 5. NO OPENINGS NOR ANY CHANGES IN SIZE, DIMENSION OR LOCATION SHALL BE MADE IN ANY STRUCTURAL ELEMENTS WITHOUT WRITTEN APPROVAL OF THE STRUCTURAL ENGINEER

6. THE CONTRACTOR IS RESPONSIBLE FOR LIMITING THE AMOUNT OF CONSTRUCTION LOAD IMPOSED ON THE

- STRUCTURE. SUCH LOADS SHALL NOT EXCEED THE CAPACITY OF THE STRUCTURE AT ANY TIME. 1. THE STRUCTURE IS DESIGNED TO FUNCTION AS A UNIT UPON COMPLETION, AND ANY TEMPORARY BRACING OR SUPPORT REQUIRED TO ACCOMMODATE THE CONTRACTORS MEANS AND METHODS ARE THE RESPONSIBILITY
- 8. THE CONTRACTOR SHALL INFORM THE STRUCTURAL ENGINEER, CLEARLY AND EXPLICITLY IN WRITING, OF ANY DEVIATION OR SUBSTITUTION OF REQUIREMENTS OF THE CONTRACT DOCUMENTS, CONTRACTOR IS NOT RELIEVED OF ANY REQUIREMENTS OF THE CONTRACT DOCUMENTS BY VIRTUE OF THE STRUCTURAL ENGINEERS REVIEW OF SHOP DRAWINGS, PRODUCT DATA, ETC., UNLESS THE CONTRACTOR HAS CLEARLY AND EXPLICITLY INFORMED THE STRUCTURAL ENGINEER IN WRITING OF ANY DEVIATIONS OR SUBSTITUTIONS AT TIME OF SUBMISSION, AND THE
- STRUCTURAL ENGINEER HAS GIVEN WRITTEN APPROVAL FOR THE SPECIFIC DEVIATIONS OR SUBSTITUTIONS. 9. ALL THINGS WHICH, IN THE OPINION OF THE CONTRACTOR, APPEAR TO BE DEFICIENCIES, OMISSIONS, CONTRADICTIONS OR AMBIGUITIES IN THE DRAWINGS OR SPECIFICATIONS, SHALL BE BROUGHT TO THE ATTENTION OF THE STRUCTURAL ENGINEER. CORRECTIONS OR WRITTEN INTERPRETATIONS SHALL BE ISSUED BEFORE AFFECTED
- 10. CONTRACTOR SHALL VERIFY ALL EXISTING CONDITIONS PRIOR TO ORDERING MATERIALS OR PROCEEDING WITH NEW WORK IN AREAS AFFECTED BY THE EXISTING CONDITIONS, STRUCTURAL ENGINEER SHALL BE INFORMED IN WRITING OF CONFLICTS BETWEEN EXISTING AND PROPOSED NEW CONSTRUCTION.
- CONTRACTOR IS RESPONSIBLE FOR COORDINATING ALL DIMENSIONS SHOWN ON THE CONTRACT DOCUMENTS. INCONSISTENCIES ON THE STRUCTURAL DRAWINGS OR BETWEEN THE STRUCTURAL DRAWINGS AND ANY OTHER CONTRACT, SHOP, FABRICATION, OR OTHER DRAWINGS OR INFORMATION SHALL BE BROUGHT TO THE ATTENTION OF THE STRUCTURAL ENGINEER PRIOR TO PROCEEDING WITH AFFECTED WORK.
- 12. DO NOT SCALE THESE DRAWINGS, USE THE DIMENSIONS SHOWN.

CONCRETE:

- SUBMIT WRITTEN REPORTS OF EACH PROPOSED CONCRETE DESIGN MIX NOT LESS THAN 15 DAYS PRIOR TO THE START OF WORK. DESIGN MIXES PREPARED MORE THAN TWELVE (12) MONTHS PRIOR TO THE DATE THE SUBMITTAL ARE NOT PERMITTED.
- ! ALL CONCRETE WORK SHALL BE DONE IN ACCORDANCE WITH CURRENT ACI BUILDING CODE REQUIREMENTS FOR REINFORCED CONCRETE

FOR STANDARD PARAMETERS (SLUMP, COMPRESSIVE STRENGTH, ETC.)

TWO COPIES OF ALL REPORTS SHALL BE SUBMITTED TO THE ENGINEER/

- 3. ALL CONCRETE SHALL BE TESTED BY AN INDEPENDENT TESTING AGENCY
- I. ALL NORMAL WEIGHT CONCRETE SHALL HAVE ASTM C-33 AGGREGATE WITH MAXIMUM UNIT WEIGHT OF 150 PCF. CONCRETE COMPRESSIVE STRENGTH SHALL BE 3000 PSI AT 28 DAYS, MINIMUM FOR FOUNDATIONS AND SLABS ON GRADE. ALL CONCRETE FOR FLOOR SLABS ON METAL DECK FORMS
- SHALL BE NORMAL WEIGHT CONCRETE WITH COMPRESSIVE STRENGTH OF 4000 PSI AT 28 DAYS. 5. MIX DESIGNS, INCLUDING WATER CEMENT RATIOS AND SLUMPS, SHALL BE PREPARED IN ACCORDANCE WITH MOST CURRENT ACI 301 CHAPTER 3, EXCEPT WHERE NOTED OTHERWISE IN THE PROJECT SPECIFICATIONS, CEMENT SHALL COMFORM TO ASTM C 150 TYPE I OR AT CONTRACTOR'S OPTION, ASTM C 595 TYPE IP WHERE FLY ASH IS PERMITTED. NORMAL WEIGHT CONCRETE SHALL CONFORM TO

SHALL CONFORM TO ASTM C 330 AGGREGATE. NO ADMIXTURES CONTAINING CALCIUM

CHLORIDE SHALL BE PERMITTED IN ANY CONCRETE.

OR SERVICE CONDITIONS.

AGGREGATE SIZES SHALL BE: FORMED CONCRETE ELEMENTS, UN.O. _167 STONE (3/4" MAX) GRADE SLABS AND EARTH FORMED ELEMENTS... COARSE MASONRY GROUT REQUIRED167 STONE (3/4" MAX)

...*8 STONE (3/8" MAX)

ASTM C 33 AGGREGATE WITH MAXIMUM UNIT WEIGHT OF 150 PCF AND LIGHT WEIGHT CONCRETE

- FINE MASONRY GROUT REQUIRED
- 6. WATER REDUCING ADMIXTURE SHALL BE USED IN ALL CONCRETE. I. AIR ENTRAINING ADMIXTURE IN ACCORDANCE WITH ACI 301-84 TABLE 3.4.1. SHALL BE USED IN ALL CONCRETE EXPOSED TO FREEZING AND THAWING DURING CONSTRUCTION
- 8. WATER/CEMENT RATIO SHALL NOT EXCEED 0.45 FOR ANY CONCRETE SUBJECTED TO FREEZING/THAWING.
- 9, ALL PUMPED CONCRETE SHALL HAVE A WATER/CEMENT RATIO LESS THAN 0.45 AND SHALL CONTAIN A HIGH RANGE WATER REDUCING ADMIXTURE (SUPERPLASTICIZER).
- IO. IN NO CASE SHALL A WATER/CEMENT RATIOS EXCEED THE FOLLOWING:
- ALL FOUNDATION CONCRETE to 3000 pei EXTERIOR PAYING CONCRETE to 3500 psi....
- III. ALL EXPOSED C.I.P. WATERTABLE, PIERS, ETC... fc 3500 psi _______0.45 MAX. W/C RATIO III. SLABS ON GRADE to 3000 psi......Ø.45 MAX. W/C RATIO 11. LIQUID MEMBRANE CURING COMPOUND WITH A MINIMUM 30% SOLIDS CONTENT SHALL BE
- APPLIED WITHIN TWO (2) HOURS AFTER COMPLETION OF FINISHING TO ALL CONCRETE FLATWORK AND WALLS, UNO., OTHER THAN FOOTINGS AND GRADE BEAMS. 12. FLOORS IN AREAS RECEIVING QUARRY TILE, CERAMIC TILE AND LIQUID FLOOR HARDENER SHALL BE CURED WITH DISSIPATING LIQUID MEMBRANE CURING COMPOUND OR WET
- CURED BY USE OF MOISTURE RETAINING COVER. DISSIPATING CURING COMPOUND SHALL BE THOROUGHLY BROOMED AND WASHED OFF PRIOR TO APPLICATION OF FLOOR FINISH. 3. USE A NON-CORROSIVE, NON-CHLORIDE ACCELERATING ADMIXTURE IN CONCRETE EXPOSED TO
- TEMPERATURES BELOW 40 DEGREES. UNIFORMLY HEAT THE WATER AND AGGREGATES TO A TEMPERATURE OF NOT LESS THAN 50 DEGREES. PLACE AND CURE CONCRETE IN ACCORDANCE
- 4. ALL CONSTRUCTION JOINTS SHOWN ON THE DRAWINGS SHALL BE INCORPORATED INTO THE STRUCTURE UNLESS THEIR ELIMINATION IS APPROVED BY THE STRUCTURAL ENGINEER.
- 5. REINFORCING IN ALL ABUTTING CONCRETE, INCLUDING FOOTINGS, SHALL BE CONTINUOUS THROUGH OR AROUND ALL CORNERS OR INTERSECTIONS. DOWELS OR SPLICES SHALL BE EQUAL IN SIZE AND SPACING TO THE REINFORCING IN THE ABUTTING MEMBERS
- 16. REFER TO ARCHITECTURAL DRAWINGS FOR DOOR AND WINDOW OPENINGS, DRIPS, REGLETS, WASHES, MASONRY ANCHORS, BRICK LEDGE ELEVATIONS, SLAB DEPRESSIONS AND MISCELLANEOUS EMBEDDED PLATES, BOLTS, ANCHORS, ANGLES, ETC.
- 7. FORMS FOR ROUND COLUMNS SHALL BE ONE PIECE FIBERGLASS FORM TO PRODUCE SMOOTH FINISH ON EXPOSED COLUMNS.
- 18. REFER TO ARCHITECTURAL DRAWINGS FOR CONCRETE FINISHES. WHERE FINISH IS NOT SPECIFIED, CONFORM TO REQUIREMENTS OF ACI 301.
- 19. BASE PLATES, ANCHOR RODS, SUPPORT ANGLES AND OTHER STEEL EXPOSED TO EARTH OR GRANULAR FILL SHALL BE COVERED WITH A MINIMUM OF 3" OF CONCRETE.

SHALL BE GIVEN TO SEQUENCING OF CONCRETE PLACEMENT TO FACILIATE CONTROL OF FINISH

20. FINISHING TOLERANCE SHALL BE WITHIN CLASS B IN ACCORDANCE WITH ACI 301 AND CONSIDERATION

- II. NON-SHRINK GROUT SHALL BE PRE-MIXED, NON-CORROSIYE, NON-METALLIC, NON-STAINING CONTAINING SILICA SANDS, PORTLAND CEMENT, SHRINKAGE COMPENSATING AND WATER REDUCING AGENTS. PRODUCTS SHALL ONLY REQUIRE THE ADDITION OF WATER MINIMUM COMPRESSIVE STRENGTH SHALL BE 5000 PSI AFTER ONE DAY AND 7000 PSI AFTER 28 DAYS. GROUT SHALL BE FREE OF GAS PRODUCING OR AIR RELEASING AND OXIDIZING AGENTS AND CONTAIN NO CORROSIVE IRON, ALUMINUM
- 22. PROVIDE CONCRETE GROUT NOT MORTAR FOR REINFORCING MASONRY LINTEL AND BOND BEAMS WHERE INDICATED ON DRAWINGS OR AS SCHEDULED.
- 23. TOLERANCE FOR ANCHOR RODS AND OTHER EMBEDDED ITEMS SHALL BE PER THE AISC CODE OF STANDARD PRACTICE SECTION 1.5.
- 24. UNLESS OTHERWISE SHOWN IN THE ARCHITECTURAL DRAWINGS, PROVIDE 3/4" CHAMFERS AT ALL COLUMN, WALL, SLAB, OR BEAM EDGES THAT ARE EXPOSED TO VIEW IN THE FINISHED STRUCTURE.

BRICK VENEER - STEEL STUDWALLS:

- a, 2 in (51 mm) MINIMUM AIR SPACE RECOMMENDED ± 1 in (24.5 mm) MINIMUM AIR SPACE REQUIRED. b. 4 1/2 in (114 mm) MAXIMUM DISTANCE REQUIRED BETWEEN BACK OF BRICK VENEER AND STEEL FRAMING UNLESS ANCHORS ARE RATIONALLY DESIGNED.
- a. DO NOT STOP FLASHING BEHIND FACE OF THE BRICKWORK.
- b. PLACE FLASHING AT ALL POINTS WHERE AIR SPACE IS INTERRUPTED. C. EXTEND FLASHING VERTICALLY UP THE BACKING TO 8 In (2003 mm) MINIMUM HEIGHT. d. LAP FLASHING 4 in (102 mm) MINIMUM HEIGHT UNDER WATER-RESISTANT BARRIER OR BEHIND SHEATHING ABOVE GRADE.
- e. INSTALL BASE FLASHING MINIMUM 6 In (152 mm) ABOYE GRADE. f. TURN UP FLASHING ENDS INTO HEAD JOINT A MINIMUM OF 1 In (25.4 mm) FOR FORM END DAM.

a. OPEN HEAD JOINT WEEPS SPACED AT NO MORE THAN 24 in (610 mm) O.C. RECOMMENDED.

- b. MOST BUILDING CODES PERMIT WEEPS NO LESS THAN 3/16" IN (4.8 mm) DIAMETER AND SPACED NO MORE THAN 33 in (838 mm) O.C. c. WICK AND TUBE WEEP SPACING RECOMMENDED AT NO MORE THAN 16 in (406 mm) O.C.

- a. CORRUGATED ANCHORS NOT PERMITTED WITH STEEL STUD BLOCKING.
 b. MINIMUM WI.1 (9 gage) ADJUSTABLE WIRE ANCHORS, HOT-DIPPED GALVANIZED, TWO PIECE PER ASTM AI53 CLASS B-2.
- c. VERTICAL SPACING: MAXIMUM 16 in (406 mm) O.C.
- d. HORIZONTAL SPACING: MAXIMUM 24 in (610 mm) O.C. e. SECURELY ATTACH ANCHORS TO THE STEEL STUDS THROUGH THE SHEATHING, NOT THE SHEATHING ALONE.
- a. SHELF ANGLES LOCATED ABOVE THE HEIGHT LIMIT MAY SUPPORT NO MORE THAN b. SIZE HORIZONTAL LEG OF ALL SHELF ANGLES AND LINTELS TO PROVIDE A MINIMUM
- BEARING OF 2/3 THICKNESS OF THE BRICK WYTHE.
- a. EXTERIOR GRADE GYPSUM SHEATHING OR OSB OR GLASS FIBER MAT-FACED SHEATHING OR CEMENT BOARD, MINIMUM 1/2 in (12.7 mm) THICK.
- a. WATER-RESISTANT BARRIERS INCLUDE IS ASPHALT FELT, BUILDING PAPER, QUALIFYING HIGH-DENSITY POLYETHYLENE OR POLYPROPYLENE PLASTICS (HOUSEWRAPS).
- b. INSTALL WATER-RESISTANT BARRIER OVER SHEATHING. C. SEAL WATER-RESISTANT SHEATHING PER MANUFACTURER TO PERFORM AS
- WATER-RESISTANT BARRIER d. SHIP LAP WATER-RESISTANT BARRIER PIECES MINIMUM 6 in (152 mm).
- a. GALYANIZED STEEL STUDS WITH MINIMUM G-90 COATING. b. RESTRICT ALLOWABLE OUT-OF-PLANE DEFLECTION OF STEEL STUDS TO L/600 USING
- SERVICE LEVEL LOADS. c. MINIMUM 0043 in (18 gage : 109 mm) STUDS FOR EXTERIOR WALLS. d. DO NOT FIELD WELD STEEL STUDS.
- a. COMPLY WITH ASTM C270. b. TYPE N RECOMMENDED ± TYPE & ALTERNATE.
- a. PROVIDE VERTICAL AND HORIZONTAL EXPANSION JOINTS THROUGH BRICK VENEER.

BRIC	CK LINTEL SCHEDULE
MAX OPENING WIDTH	STEEL ANGLE
4'-0"	L 3" x 3 1/2" x 1/4" LLH
6'-0"	L 4" x 3 1/2" x 1/4" LLV
8'-0"	L 5" x 3 1/2" x 1/4" LLV
10'-0"	L 6" x 3 1/2" x 5/16" LLV
12'-0"	L 7" x 4" x 3/8" LLV
14'-0"	L 7" x 4" x 3/8" LLV

. PROVIDE 8" MINIMUM BEARING.

GALVANIZED.

(NOT BY BETCO)

2. ALL EXPOSED LINTELS TO BE HOT DIP

ABOVE SCHEDULE FOR LOOSE LINTELS.

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NAC				R. KEATH
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EDN. SELLINIT				
Manning Manning	REVISIONS	DATE	BY	



228 COMMERCE BL STATESVILLE, NC 28

HWY 42 STORE ALL PROJECT ADDRESS: HOLLY SPRINGS, NORTH CAROLINA

	OWNER: F & S LAND DEVELOPMENT LLC.	PROJECT NO.: NC24204
28 COMMERCE BLVD. ATESVILLE, NC 28625 (800) 654-7813	SHEET TITLE: BUILDING NOTES	CS2 of 4

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### PENDIX B BUILDING CODE SUMMARY FOR ALL COMMERCIAL PROJECTS (EXCEPT 1 AND 2-FAMILY DWELLINGS AND TOWNHOUSES) (Reproduce the following data on the building plans sheet 1 or 2) Name of Project: Hwy 42 Storage All Address: Holly Springs, NC Zip.Code: 27540 Owner/Authorized Agent: Drew Stephenson: Phone # (919) 730-7802 E-Mail: Owned By: Private Code Enforcement Jurisdiction: Select one **CONTACT:** DESIGNER FIRM NAME LICENSE # TELEPHONE # E-MAIL Architectural ()	Incidental Uses (Table 509): Special Uses (Chapter 4 — List Code Sections): Mixed Occupancy: No Separation: Select one Exception: Select one Actual Area of Occupancy A + Actual Area of Occupancy B Allowable Area of Occupancy A + Allowable Area of Occupancy B ** **Allowable Area of Occupancy A + Allowable Area of Occupancy B ** ** ** ** ** ** ** ** ** ** ** ** *	Exterior walls North North NVA North NVA South NVA South NVA South NVA South NVA Interior walls and partitions NVA Columns Supporting bears Roof Construction, including supporting bears Roof Contraction, including Supporting Bears and joists Roof Ceiling Assembly NVA Columns Supporting Roof NVA Shaft Enclosures - Exit NVA Shaft Enclosures - Exit NVA Shaft Enclosures - Other NVA Cortifor Supporting Roof NVA Cortifor Supporting Roof NVA Shaft Enclosures - Other NVA Cortifor Supporting NVA Cortifor Supporting NVA NVA Shaft Enclosures - Other NVA Shaft Enclosures - Other NVA Cortifor Supporting NVA Cortifor Supporting NVA Shaft Enclosures - NVA Shaft Enclosures - NVA NVA Shaft Enclosures - NVA NVA Shaft Enclosures - Other NVA Cortifor Supporting NVA Shaft Enclosures - Other NVA Shaft Enclosures - Other NVA Cortifor Supporting NVA Shaft Enclosures - Other NVA Shaft Enclosures - Other NVA Cortifor Supporting NVA Shaft Enclosures - Other NVA Shaft Enclosures - Exit Enclosures NVA Shaft Enclosures - Exit Enclosures NVA Shaft Enclosures - Other NVA Shaft Enclosures - Exit Enclosures NVA Shaft Enclosures	Occupant loads for each area Rxit access travel distances (1017) Common path of travel distances (Tables 1006.2.1 & 1006.3.2(1)) Dead and lengths (1020.4) Clear exit widths for each exit door Maximum calculated occupant load capacity each exit door can accommodate based on egress width (1005.3) Actual occupant load for each exit door A separate schematic plan indicating where fire rated floor/ceiling and/or roof structure is provided for purposes of occupancy separation Location of doors with panic hardware (1010.1.10) Location of doors with panic hardware (1010.1.10) Location of doors with electromagnetic egress locks and the amount of delay (1010.1.9.7) Location of doors with electromagnetic egress locks (1010.1.9.9) Location of doors equipped with hold-open devices Location of doors equipped with hold-open devices Location of or energency escape windows (1030) The square footage of each fire area (202) The square footage of each moke compartment for Occupancy Classification I-2 (407.5) Note any code oxceptions or table notes that may have been utilized regarding the items above ACCESSIBLE DWELLING UNITS (SECTION 1107) TOTAL ACCESSIBLE DWELLING UNITS UNITS UNITS UNITS UNITS UNITS UNITS ACCESSIBLE UNITS PROVIDED PROVIDE
BASIC BUILDING DATA Construction Type: II-B Sprinklers: N/A N/A Standpipes: N/A Primary Fire District: Select one Special Inspections Required: No Gross Building Area Table FLOOR EXISTING (SO FT) NEW (SO FT) SUB-TOTAL Building 1 10800 10800 Building 2 23700 23700 Building 3 5400 5400 TOTAL 39900 39900 ALLOWABLE AREA Primary Occupancy Classification(s): Storage - S-1 N/A N/A N/A N/A N/A N/A Accessory Occupancy Classification(s): 2018 NC Administrative Code and Policies	Building Height in Stories (Table 504.4) Building Height in Stories (Table 504.4) Provide code reference if the "Shown on Plans" quantity is not based on Table 504.3 or 504.4. FIRE PROTECTION REQUIREMENTS BUILDING ELEMENT FIRE RATING BUILDING ELEMENT SEPARATION DISTANCE (W) FROUDED AND FOR RATED FOR SHEET # RATED FOR RATED FOR SHEET # RATED FOR SHEET # RATED JOINTS SUBJECT # ASSEMBLY BUILDING ELEMENT SEPARATION DISTANCE (FEET) NC NC SUBJECT # AND FOR RATED JOINTS BUILDING ELEMENT FOR RATED FOR RATED FOR FARTED JOINTS NC BUILDING ELEMENT AND FOR RATED FOR FOR FARTED FOR FARTED JOINTS NC NOTH East Dearing Wells Faterior North Public Tearly FOR RATED FOR FARTED JOINTS NC NORTH ASSEMBLY JOINTS NORTH RATED JOINTS NORTH ASSEMBLY JOINTS NORTH RATED JOINTS NORTH ASSEMBLY JOINTS NORTH RATED JOINTS ASSEMBLY JOINTS NORTH RATED JOINTS ASSEMBLY JOINTS NORTH RATED JOINTS ASSEMBLY JOINTS AND JOIN	LIFE SAFETY SYSTEM REQUIREMENTS Emergency Lighting: Select one Exit Signs: Select one Fire Alarm: Select one Smoke Detection Systems: Select one Carbon Monoxide Detection: Select one LIFE SAFETY PLAN REQUIREMENTS Life Safety Plan Sheet #: Fire and/or smoke rated wall locations (Chapter 7) Assumed and real property line locations (if not on the site plan) Exterior wall opening area with respect to distance to assumed property lines (705.8) Occupancy Use for each area as it relates to occupant load calculation (Table 1004.1.2) 2018 NC Administrative Code and Policies	PLUMBING FIXTURE REQUIREMENTS (TABLE 2902.1) USE WATERCLOSETS URINALS LAVATORIES SHOWERS DRINKING FOUNTAINS MALE FEMALE UNISEX MALE FEMALE UNISEX /TURE REQUILAR ACCESSIBLE SPACE EXIST'G NEW REQ'D SPECIAL APPROVALS SPECIAL APPROVALS Special approval: (Local Jurisdiction, Department of Insurance, OSC, DPI, DHHS, etc., describe below) 2018 NC Administrative Code and Policies
ENERGY SEQUIREMENTS: The following data shall be considered minimum and any special attribute required to meet the energy code shall also be provided. Butch Designer shall furnish the required portions of the project information for the plan data sheet. If performance method, state the annual energy cost for the standard reference design vs annual energy cost for the proposed design. Existing building envelope compiles with code; Select one Exempt Building; Yes Provide code or statutory reference: N.C.G.S. 143-138 Climate Zone: Select one Method of Compliance: Select one (If 'Other' specify source here) THERMAL ENVELOPE (Prescriptive method only) Rooffeedling Assembly (such assembly) Description of assembly: U-Value of total assembly: U-Value of total assembly: Exterior Walts (seah assembly: U-Value of stoal assembly: U-Value of insulation: Openings (windows or doors with glazing) U-Value of insulation: Openings (windows or doors with glazing) U-Value of total assembly: Exterior Door R-Values: Walls below grade (each assembly) Description of assembly: U-Value of insulation: Floors over unconditioned space (each assembly) Description of assembly: U-Value of ressembly: R-Value of insulation: Floors over unconditioned space (each assembly) Description of assembly: U-Value of total assembly: R-Value of insulation: Floors also us grade Description of assembly: U-Value of total assembly: R-Value of insulation: Floors also us grade Description of assembly: U-Value of total assembly: U-Value of total assembly: R-Value of insulation: Floors also us grade Description of assembly: U-Value of total assembly: R-Value of insulation: Floors also us grade Description of assembly: Horizontal/vertical requirement: slab beated:	### Part	### PROPRIES STATEMENT OF THE PROPECTS OF THE PROPECT OF THE	Additional Efficiency Package Options (When a sing the 2016 CA Shering Controls (CA06.5 O Bedicated Outdoor Air System CA06.5 O Bedicated Outdoor Air System CA06.7 Reduced Energy Use in Service Water Heading
2018 NC Administrative Code and Policies	2018 NC Administrative Code and Policies	2018 NC Administrative Code and Policies	2018 NC Administrative Code and Policies
		DATE: 12/9/24 DRAWN BY: R. KEATH SCALE:	HWY 42 STORE ALL PROJECT ADDRESS: HOLLY SPRINGS, NORTH CAROLINA OWNER: PROJECT NO.:


OWNER: 228 COMMERCE BLVD. STATESVILLE, NC 28625 (800) 654-7813


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DATE BY

REVISIONS


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	SHEET TI	TLE:						DRAWING NUMBER:]
)					API	PENDIX B		CS3 of 4	



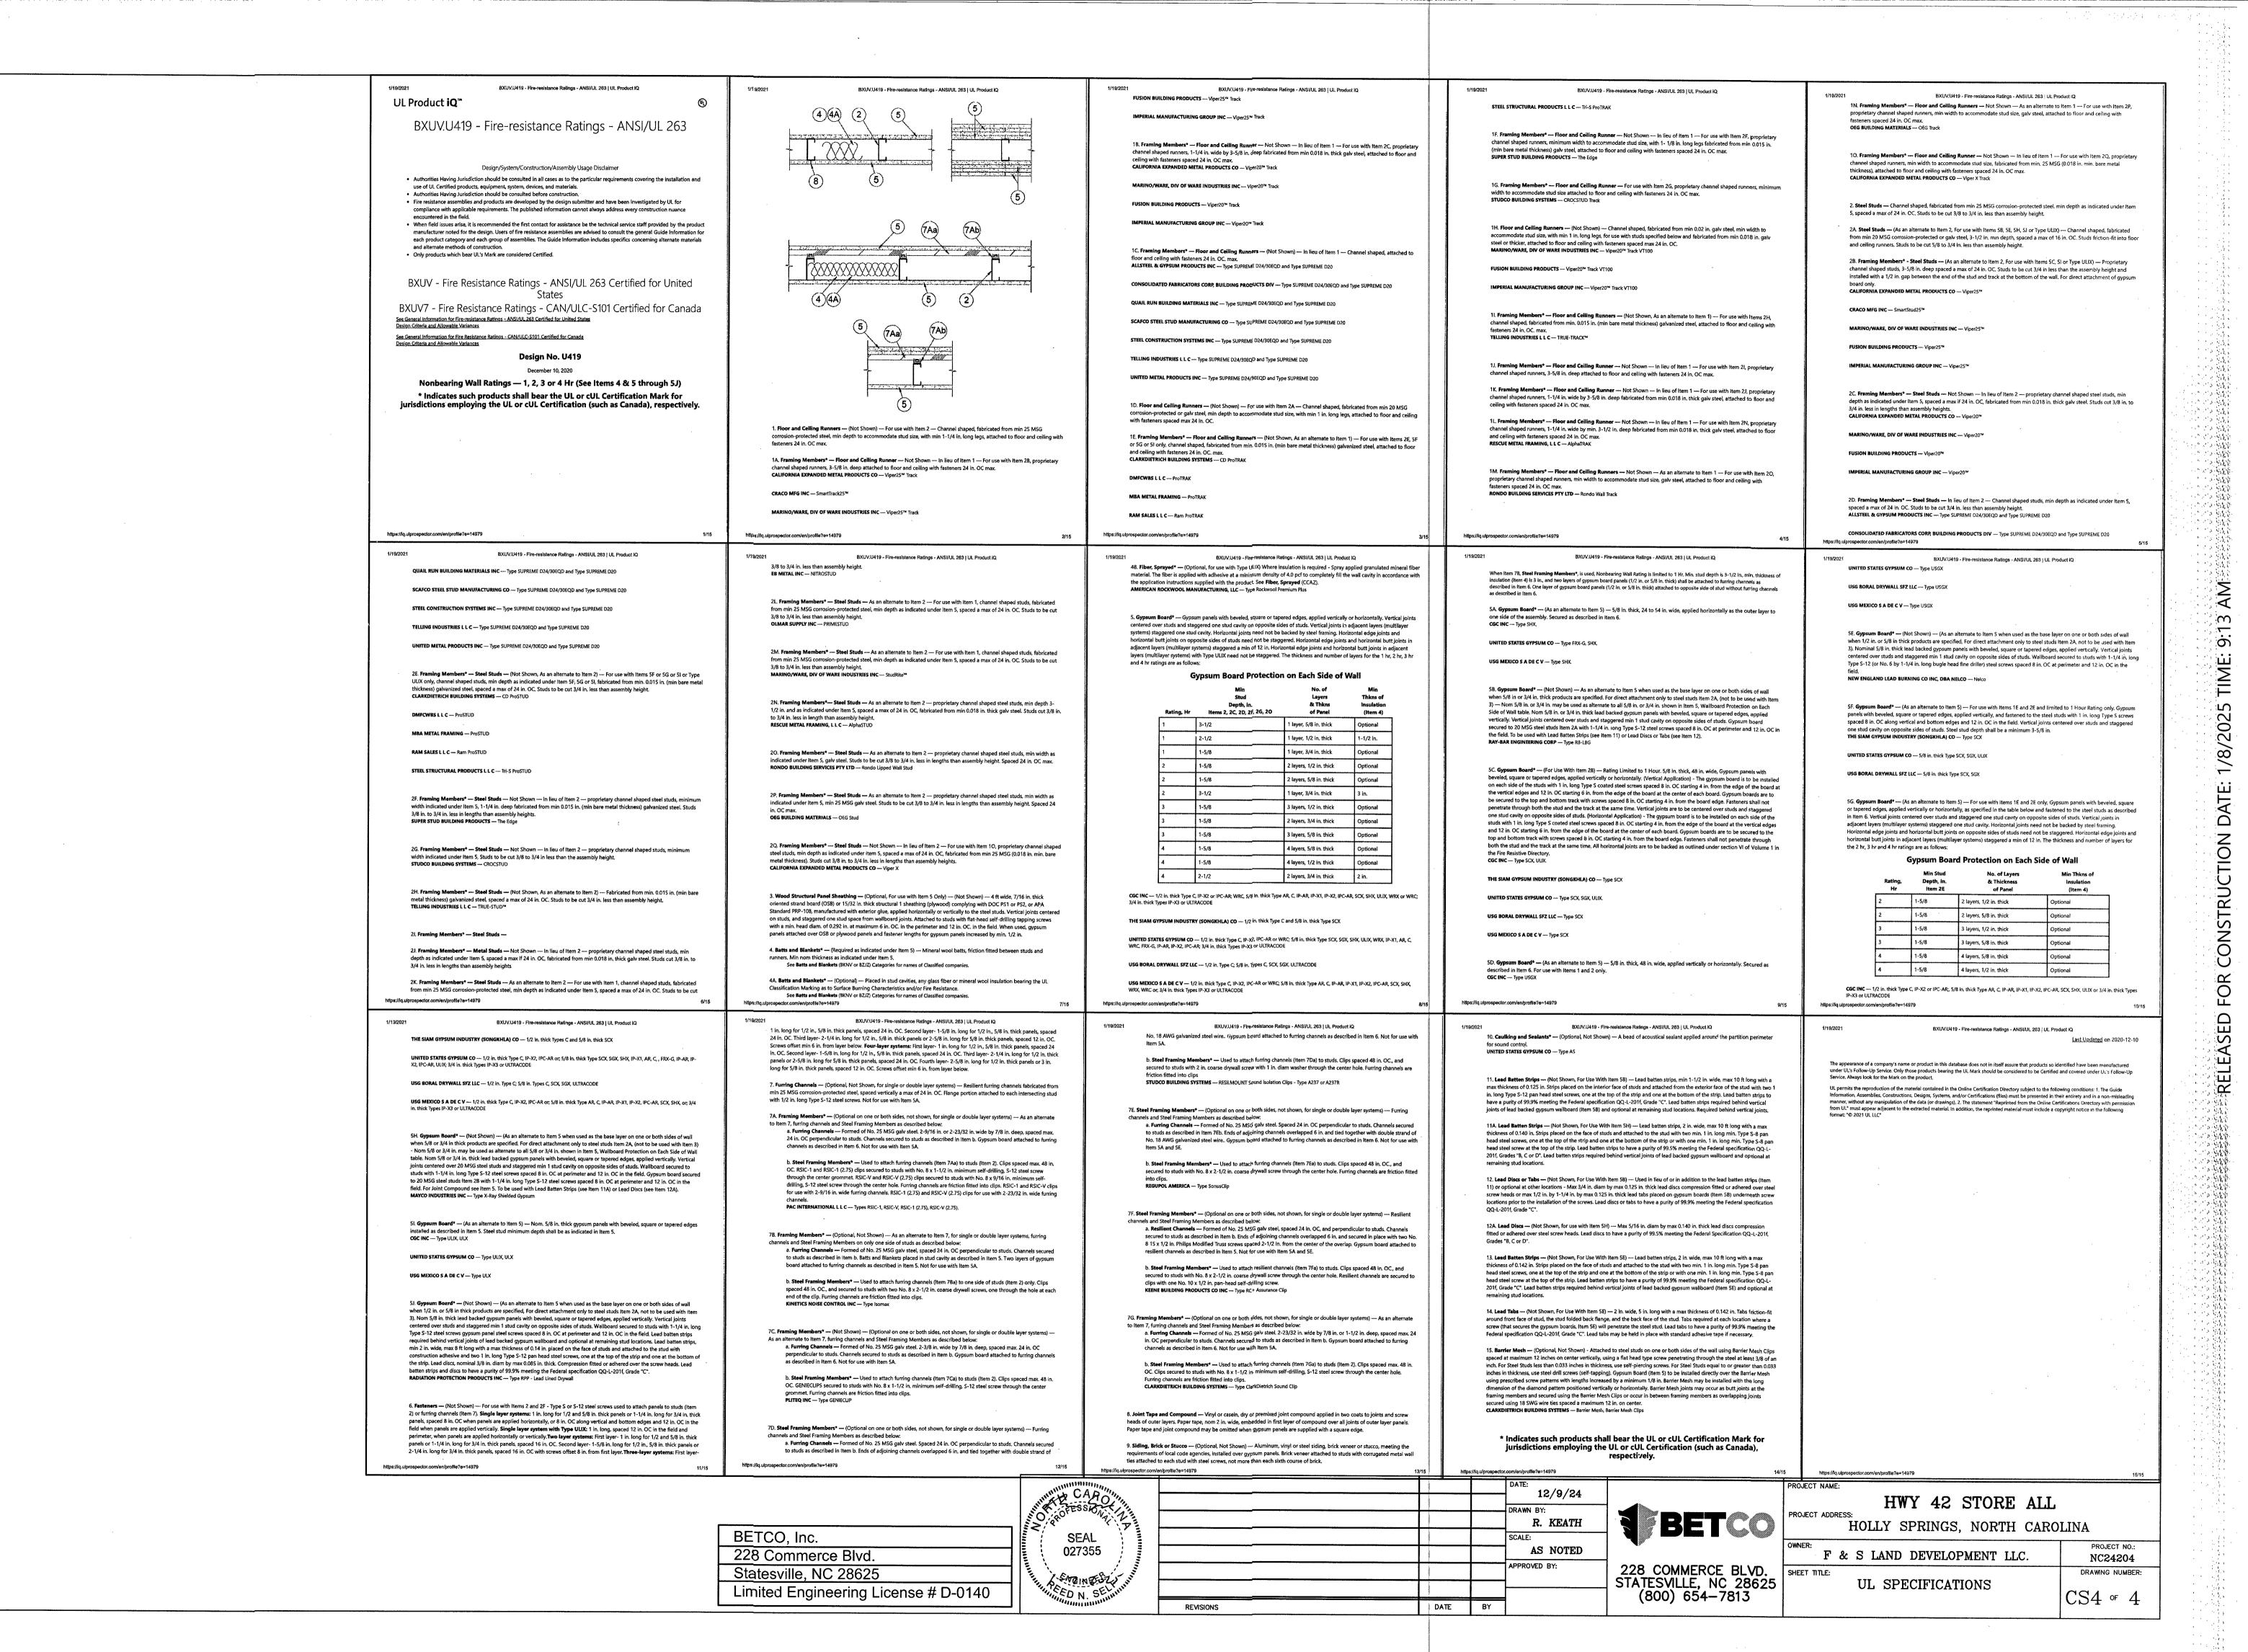

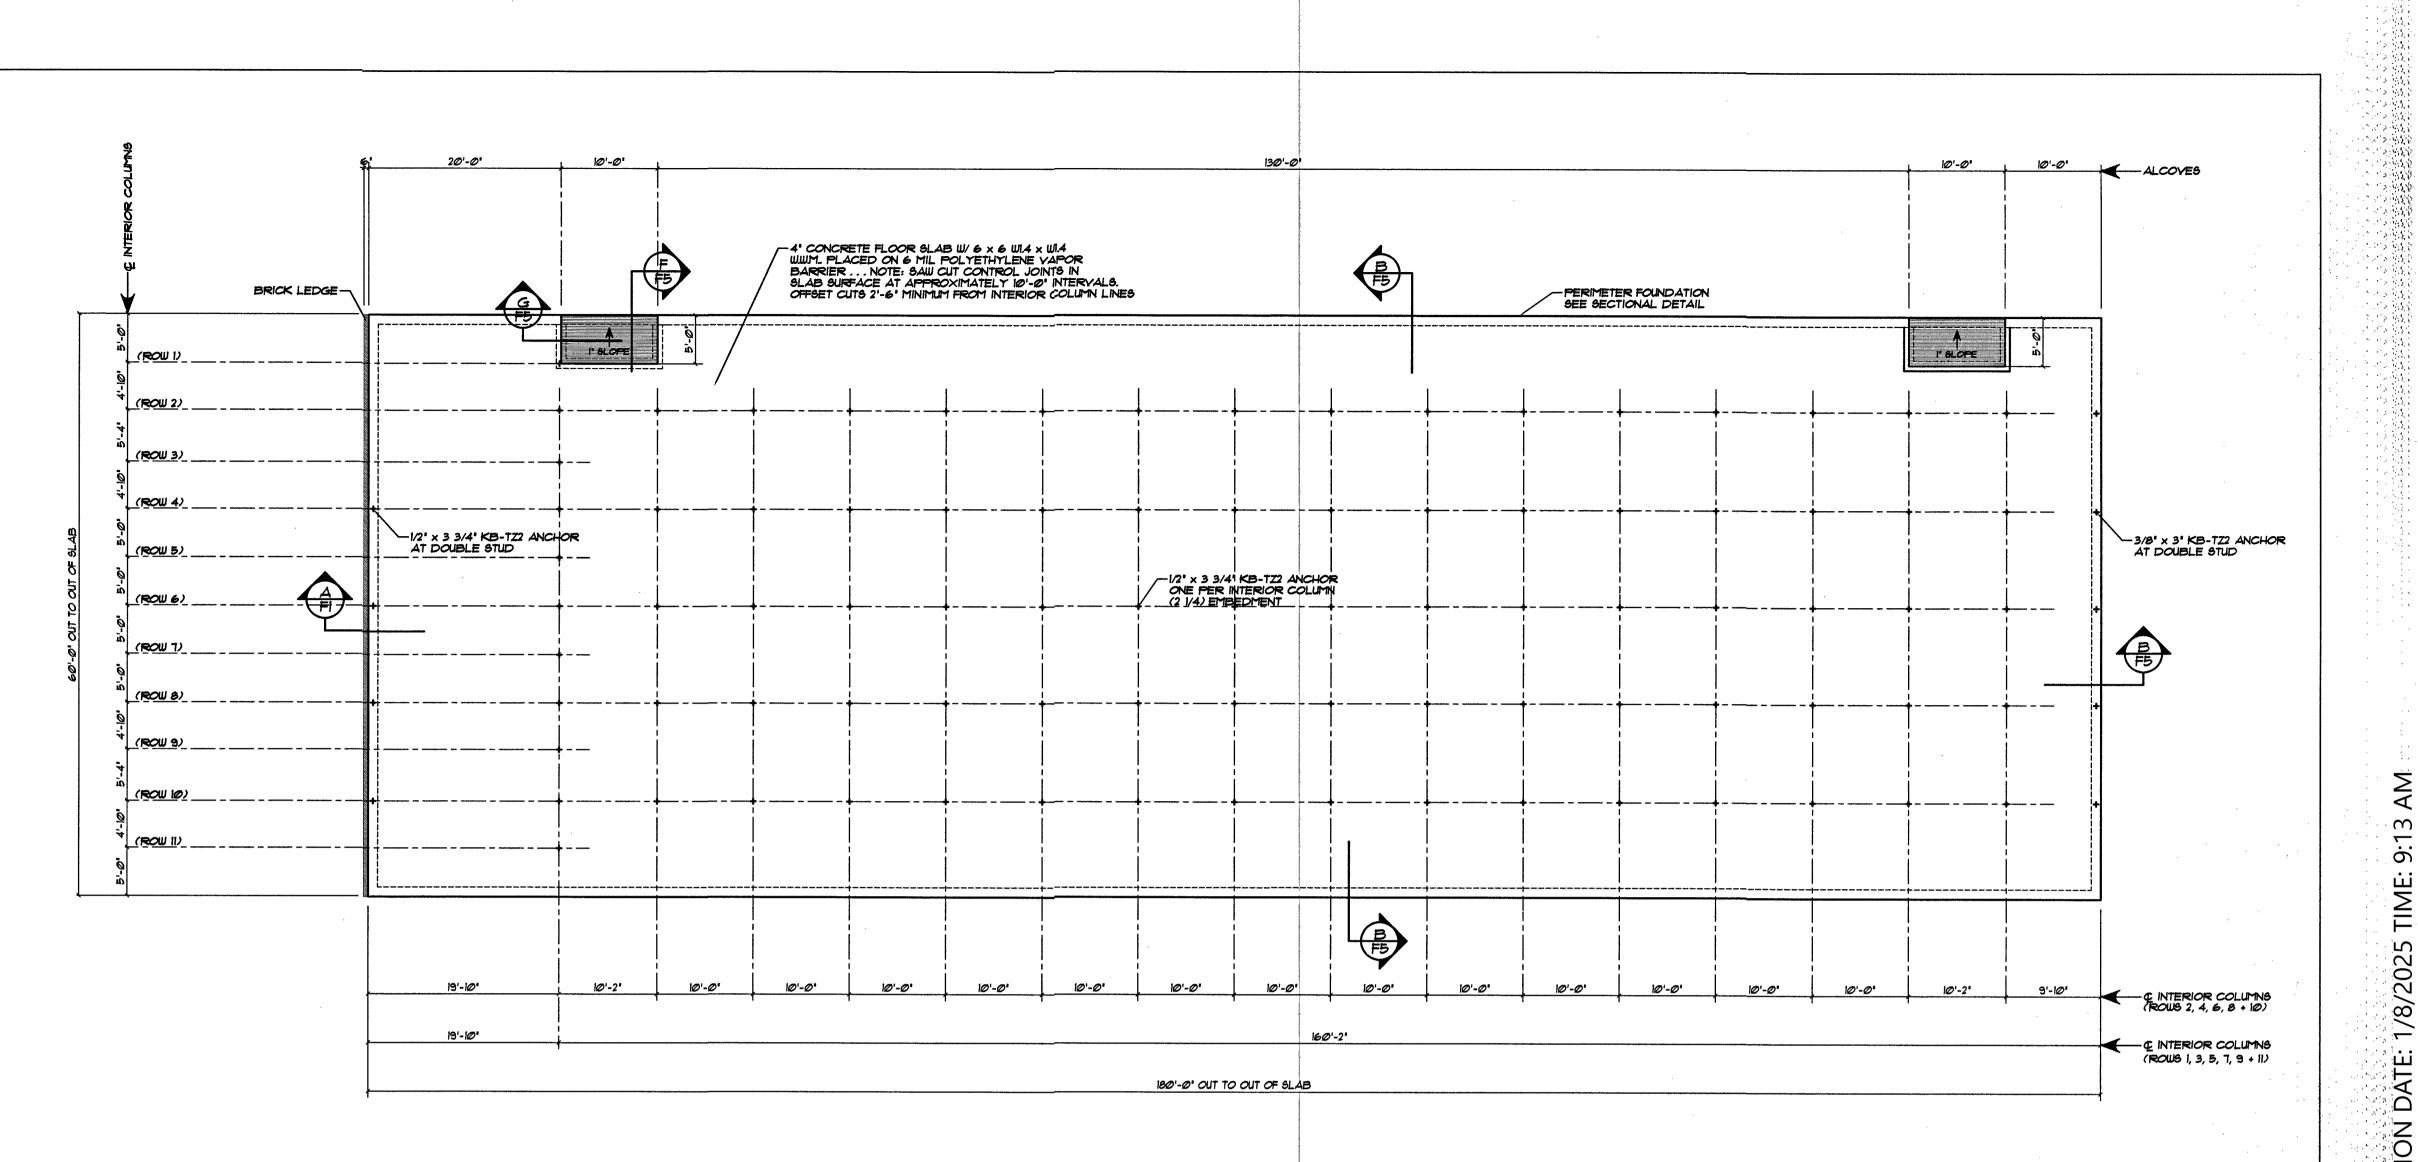FOUNDATION PLAN ... BUILDING "I"

SAW CUT CONTROL JOINTS IN SLAB SURFACE AT APPROXIMATELY 10'-0" INTERVALS . . . OFFSET CUTS 2'-6" MINIMUM FROM INTERIOR COLUMN LINES.

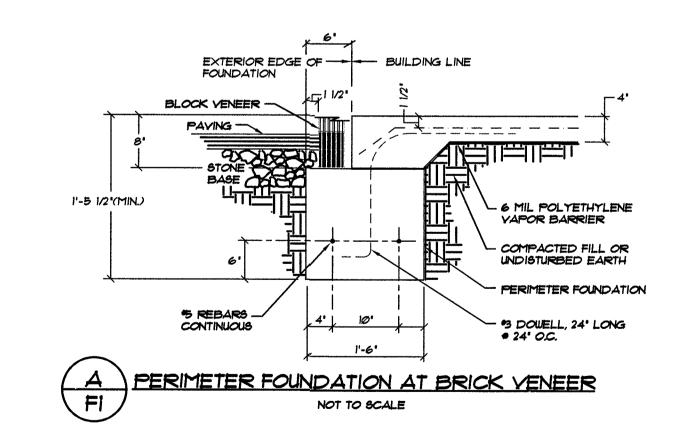

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CONCRETE NOT EXPOSED TO FREE	ZING-	
WATER-SOLUBLE SULFATE (SO ₄) IN SOIL, PERCENT BY WEIGHT	DISSOLVED SULFATE (SO ₄) IN WATER, ppm	NOTE:
SO ₄ < 0.10	SO ₄ < 150	KB-TZ2 AN EMBEDDE NOT REQU
CONCRETE DRY IN SERVICE, CONCE WITH WATER AND LOW PERMEABILE		NOTE
CONCRETE EXPOSED TO MOISTURE NOT TO EXTERNAL SOURCES OF CI	DO NO DOING OF THE MAY F	

ACI 318 - TABLE 19.3.1.1 EXPOSURE CATEGORIES AND CLASSES

REFERENCE ACI 318-14 - TABLE 19.3.1.1 FOR REQUIREMENTS FOR CONCRETE BY EXPOSURE CLASS.

SEVERITY CLASS

NOT APPLICABLE

NOT APPLICABLE

NOT APPLICABLE

MODERATE

CATEGORY

F FREEZING AND THAWING

S SULFATE

W REQUIRING LOW PERMEABILITY

CORROSION PROTECTION OF REINFORCEMENT

ANCHORS ARE PROVIDED BY BETCO. DED ANCHOR BOLTS IN SLAB ARE QUIRED BY BUYER.


TO OWNER / CONTRACTOR: OT CUT SAW JOINTS ALONG COLUMN LINES. G SO WILL REDUCE THE STRUCTURAL CAPACITY HE BUILDING ANCHORAGE TO THE CONCRETE AND MAY RESULT IN ADDITIONAL MATERIAL AND LABOR CHARGES. SAW CUTS MUST BE OFFSET 2'-6" MINIMUM FROM COLUMN LINES.

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W. January	"	REVISIONS	DATE	BY		

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₹#	OWNER
228 COMMERCE BLVD.	
STATESVILLE, NC 28625 (800)654-7813	SHEET
	228 COMMERCE BLVD.

PROJECT ADDRESS: HOLLY SPRINGS, NORTH CAROLI	PROJECT NA]	HWY	42	STORE	ALL	
	PROJECT A		SPR	INGS	, NORTH	CAROLI	N

OWNER:	PROJECT NO.:
F & S LAND DEVELOPMENT LLC	NC24204
SHEET TITLE:	DRAWING NUMBER:
FOUNDATION PLAN, DETAIL & NOTES — BUILDING "1"	F1 of 5

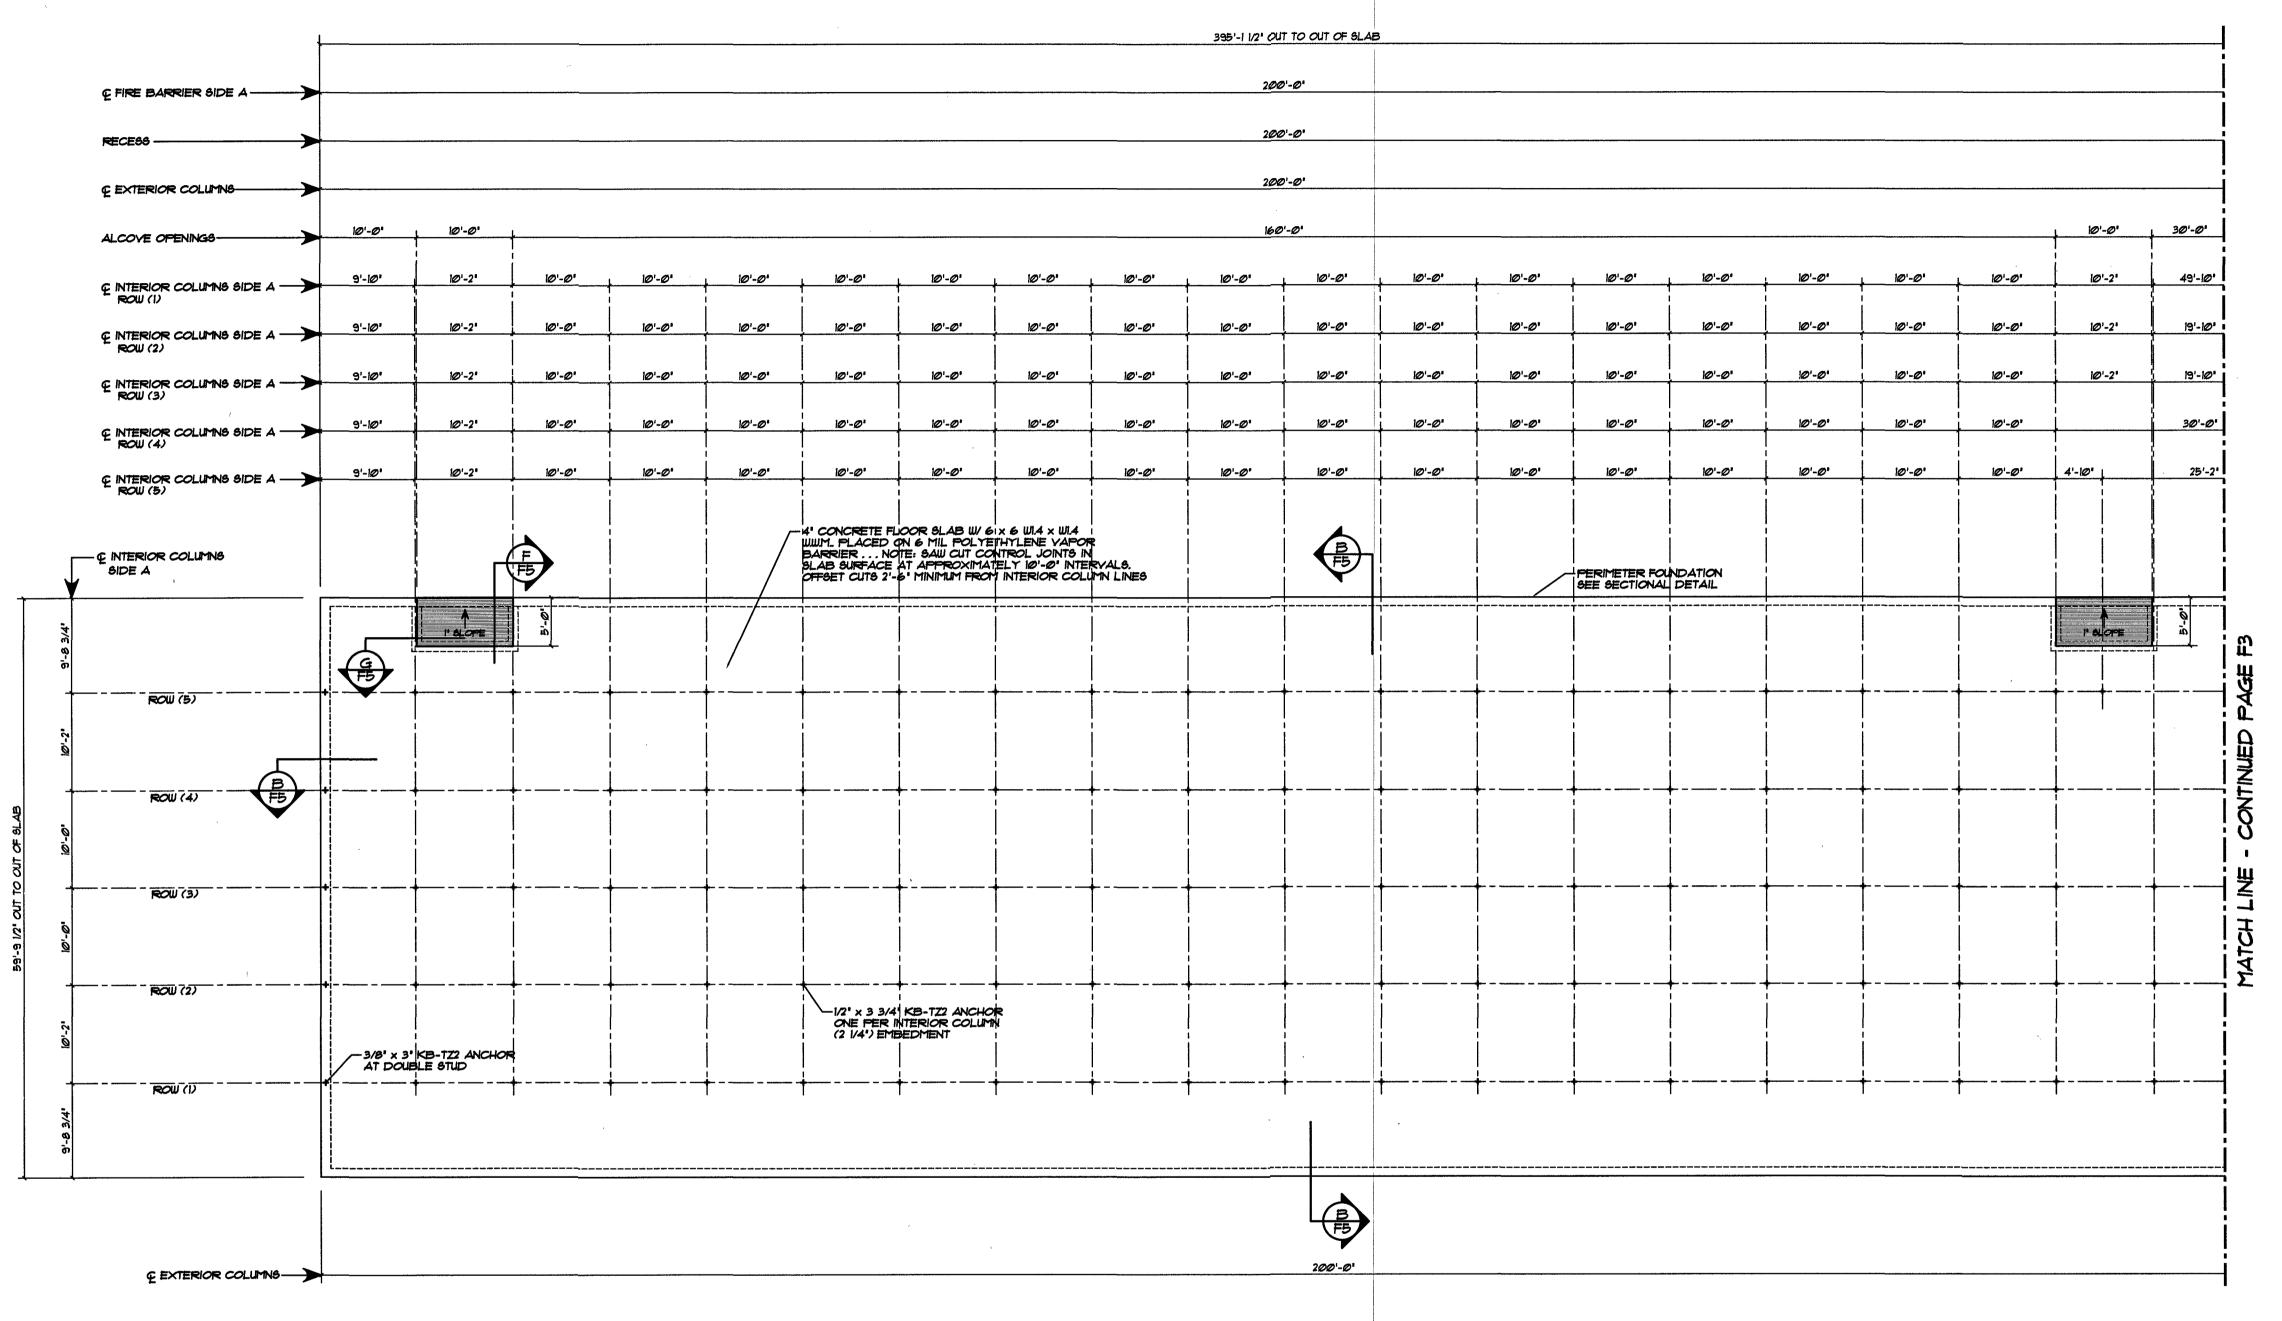

FOUNDATION PLAN ... BUILDING "2A" SCALE: VB' - 1'-0' -- OR -- 08' - 10'-0'

SAW CUT CONTROL JOINTS IN SLAB SURFACE AT APPROXIMATELY 10'-0" INTERVALS . . . OFFSET CUTS 2'-6" MINIMUM FROM INTERIOR COLUMN LINES.

NOTE: KB-T72 ANCHORS ARE PROVIDED BY BETCO. EMBEDDED ANCHOR BOLTS IN SLAB ARE NOT REQUIRED BY BUYER

NOTE TO OWNER / CONTRACTOR:

DO NOT CUT SAW JOINTS ALONG COLUMN LINES.
DOING SO WILL REDUCE THE STRUCTURAL CAPACITY
OF THE BUILDING ANCHORAGE TO THE CONCRETE AND
MAY RESULT IN ADDITIONAL MATERIAL AND LABOR
CHARGES. SAW CUTS MUST BE OFFSET 2'-6" MINIMUM
FROM COLUMN LINES.

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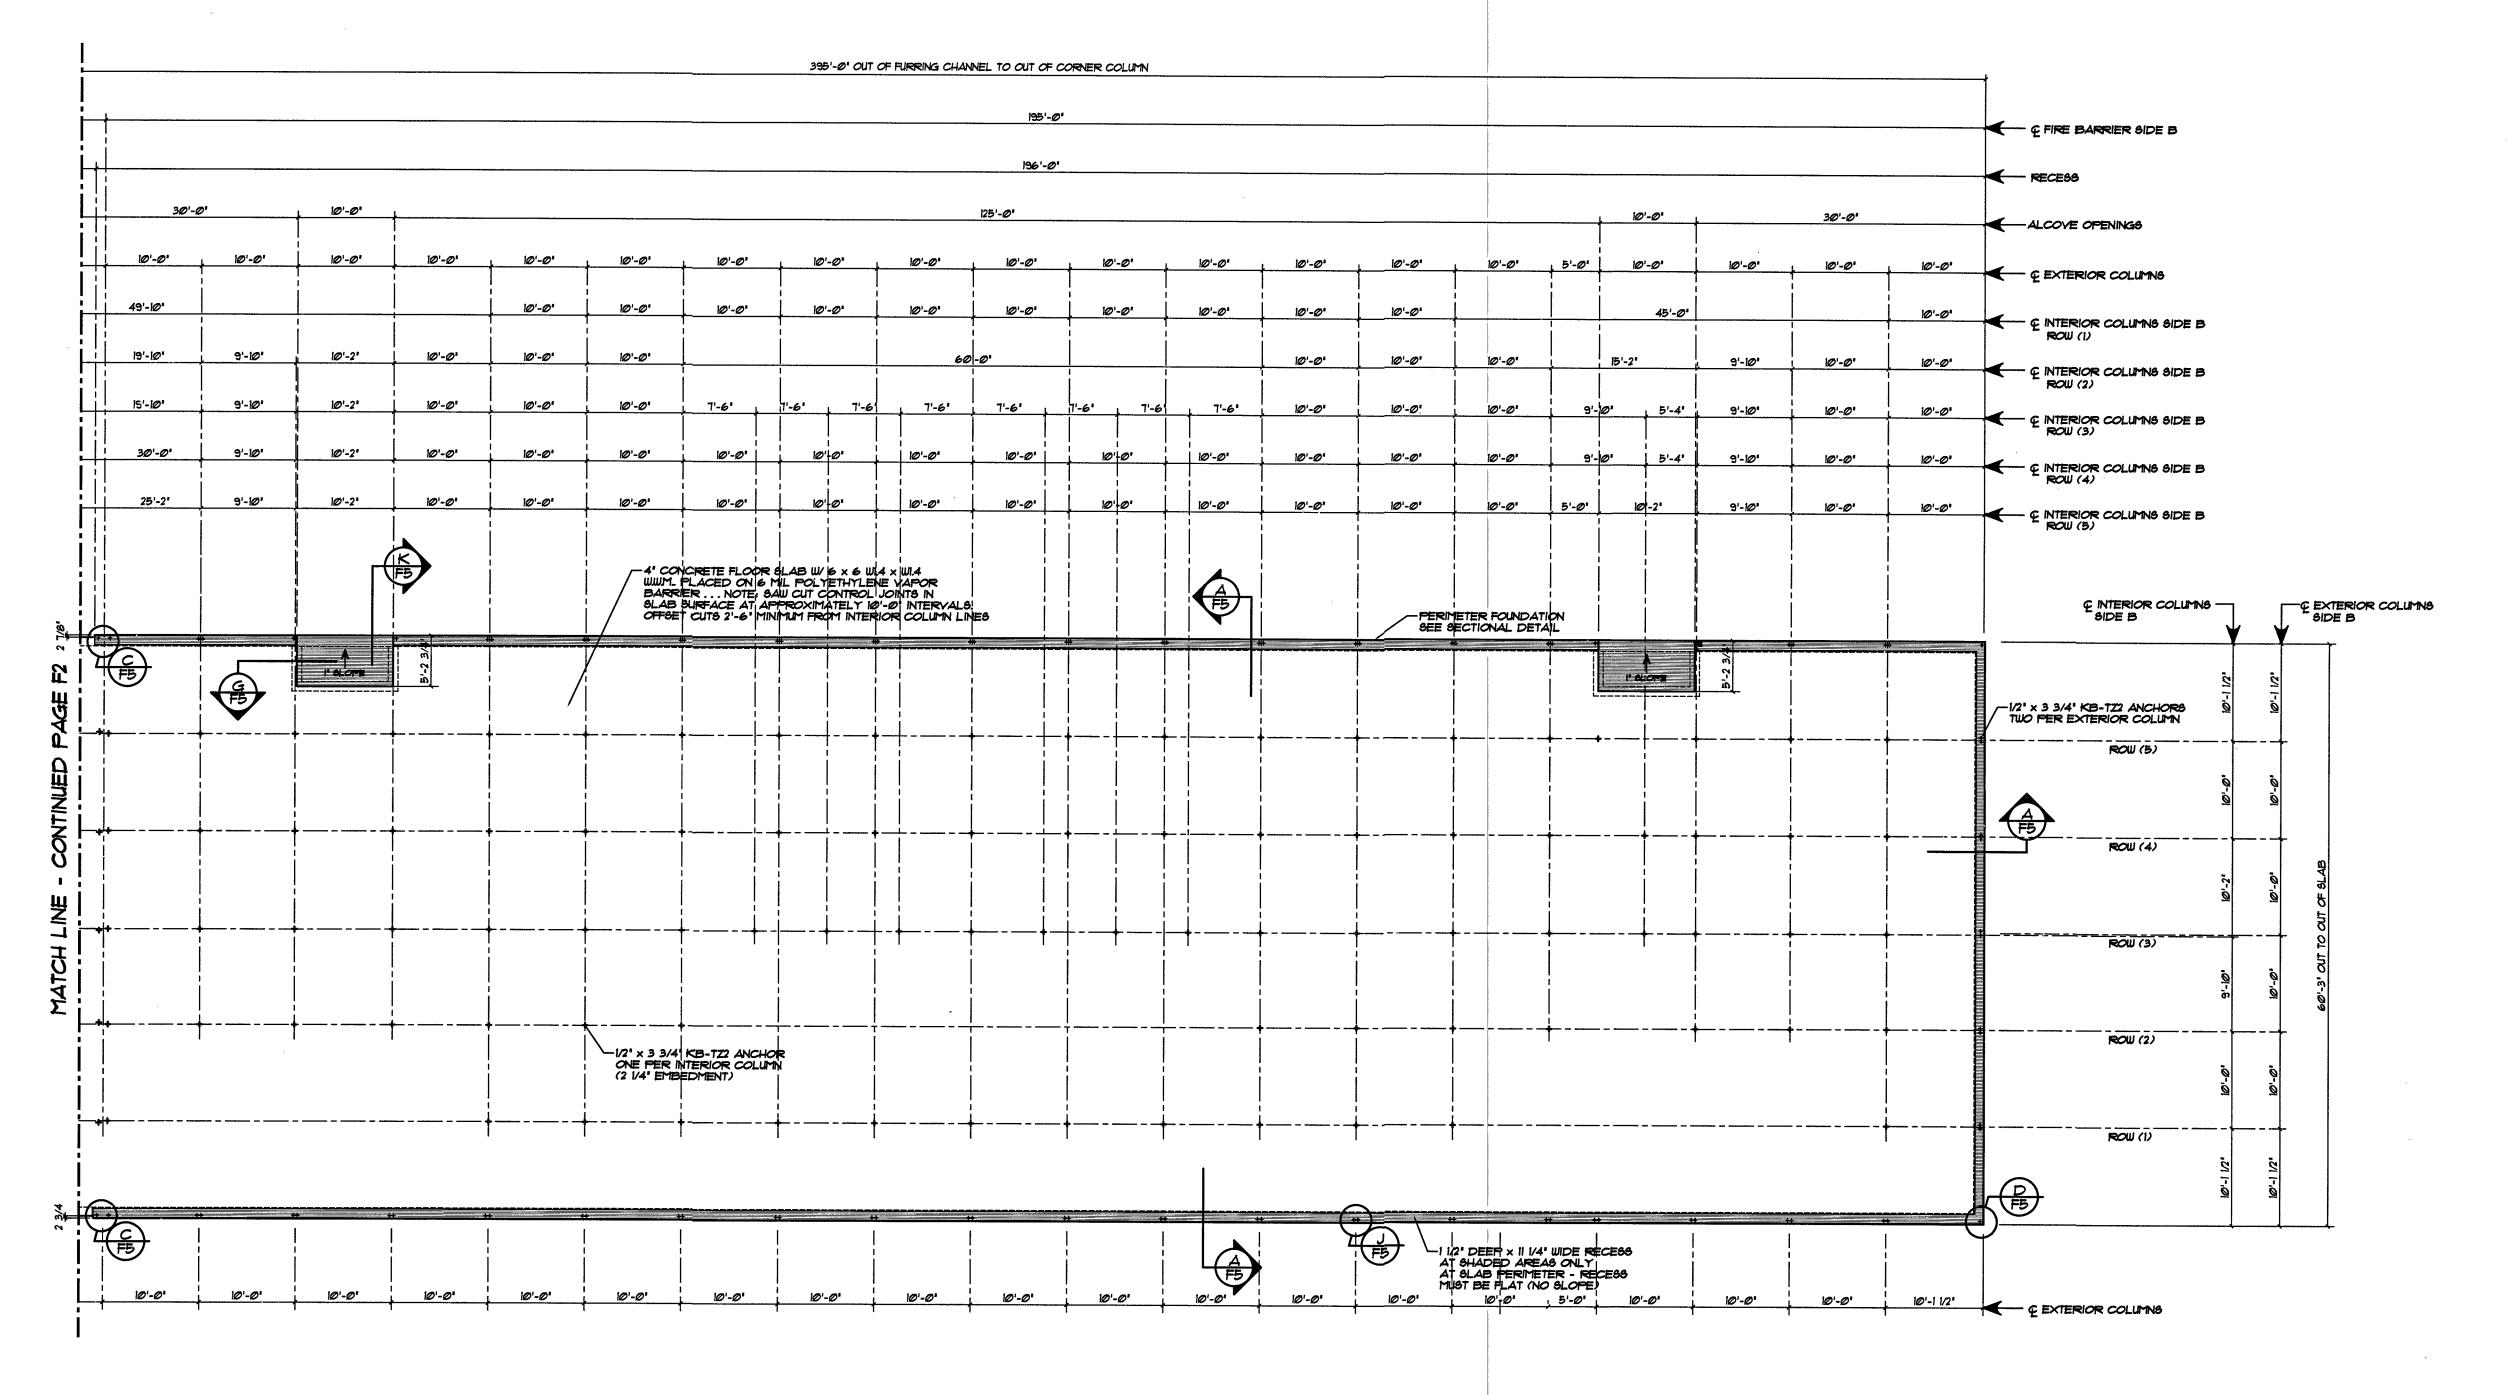
Statesville, NC 28625 Limited Engineering License # D-0140 PROJECT NAME: B COMMERCE BLVD. TESVILLE, NC 28625 (800)654—7813

HWY 42 STORE ALL HOLLY SPRINGS, NORTH CAROLINA

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	OWNER:	PROJECT NO.:	
D.	F & S LAND DEVELOPMENT LLC	NC24204	
25	SHEET TITLE:	DRAWING NUMBER:	
	FOUNDATION PLAN & NOTES — BUILDING "2"	F2 of 5	
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BETCO, Inc.

228 Commerce Blvd.



FOUNDATION PLAN ... BUILDING "2B"

SAW CUT CONTROL JOINTS IN SLAB SURFACE AT APPROXIMATELY 10'-0" INTERVALS . . . OFFSET CUTS 2'-6" MINIMUM FROM INTERIOR COLUMN LINES.

NOTE: KB-TZZ ANCHORS ARE PROVIDED BY BETCO. EMBEDDED ANCHOR BOLTS IN SLAB ARE NOT REGUIRED BY BUYER

NOTE TO OWNER / CONTRACTOR:

DO NOT CUT SAW JOINTS ALONG COLUMN LINES.

DOING SO WILL REDUCE THE STRUCTURAL CAPACITY

OF THE BUILDING ANCHORAGE TO THE CONCRETE AND

MAY RESULT IN ADDITIONAL MATERIAL AND LABOR

CHARGES. SAW CUTS MUST BE OFFSET 2'-6" MINIMUM

FROM COLUMN LINES.

SEAL 027355

DATE:
12/9/2024

DRAWN BY:
R. KEATH

SCALE:
AS NOTED

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PROJECT NAME:
PROJECT ADDRESS

BET COMMERCE BLVD.
STATESVILLE, NC 28625
(800)654-7813

PROJECT NAME:
OWNER:
SHEET TITLE:

NOTE:
FIELD LOCATE WEDGE ANCHORS AT
3 HOUR FIRE BARRIER.

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Statesville, NC 28625
Limited Engineering License # D-0140

HWY 42 STORE ALL
PROJECT ADDRESS:
HOLLY SPRINGS, NORTH CAROLINA

OWNER:

F & S LAND DEVELOPMENT LLC

SHEET TITLE:

FOUNDATION PLAN

& NOTES - BUILDING "2"


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NC24204

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NOTE: KB-TZZ ANCHORS ARE PROVIDED BY BETCO. EMBEDDED ANCHOR BOLTS IN SLAB ARE NOT REQUIRED BY BUYER

NOTE TO OWNER / CONTRACTOR: DO NOT CUT SAW JOINTS ALONG COLUMN LINES.
DOING SO WILL REDUCE THE STRUCTURAL CAPACITY
OF THE BUILDING ANCHORAGE TO THE CONCRETE AND
MAY RESULT IN ADDITIONAL MATERIAL AND LABOR
CHARGES. SAW CUTS MUST BE OFFSET 2'-6" MINIMUM
FROM COLUMN LINES.

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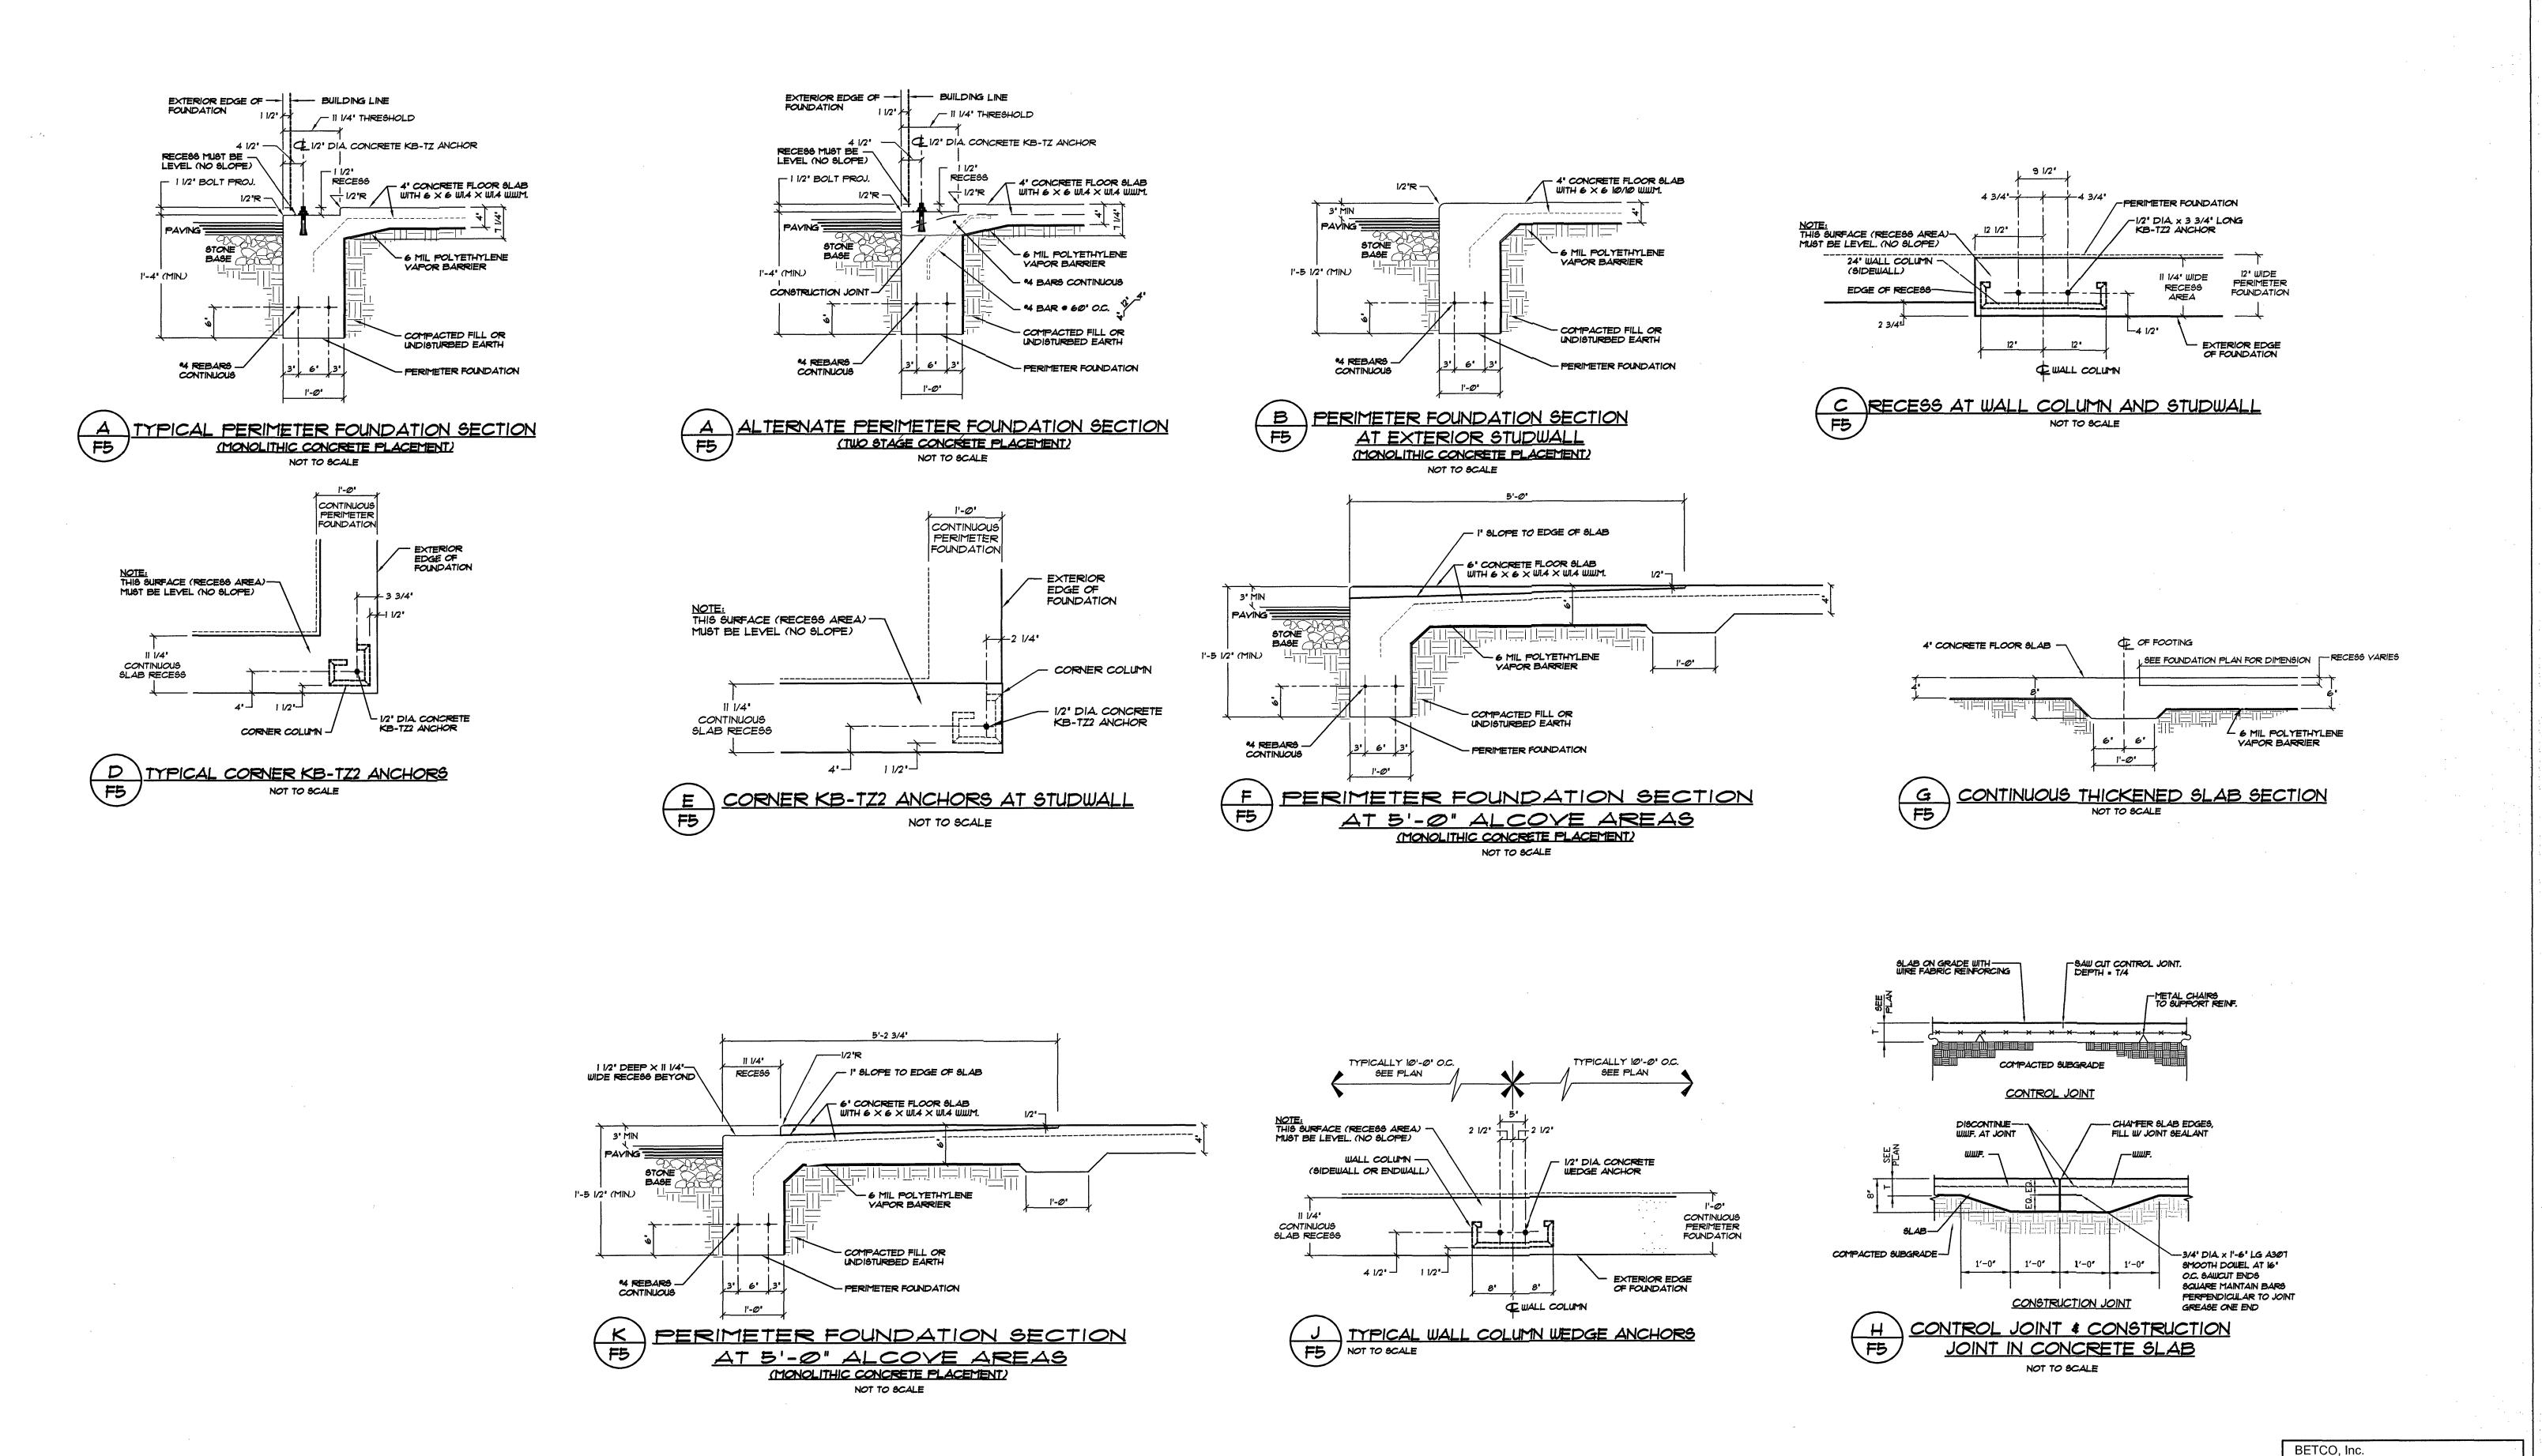
Limited Engineering License # D-0140 HWY 42 STORE ALL

BETCO, Inc.

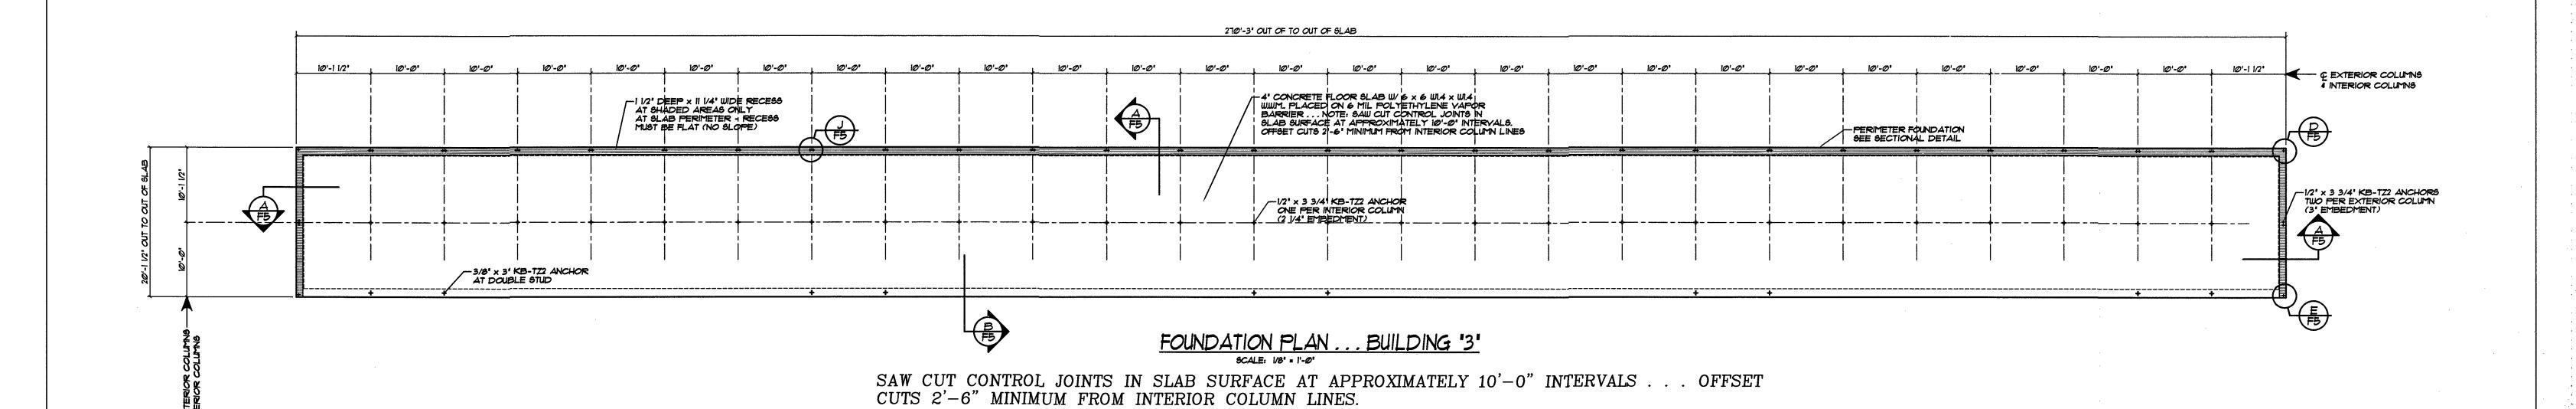228 Commerce Blvd. Statesville, NC 28625

HOLLY SPRINGS, NORTH CAROLINA PROJECT NO .: 228 COMMERCE BLVD.
STATESVILLE, NC 28625
(800)654-7813 F & S LAND DEVELOPMENT LLC NC24204 DRAWING NUMBER: FOUNDATION PLAN F4 • 5 & NOTES - BUILDING "3"





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228 COMMERCE BLVD.
STATESVILLE, NC 28625
(800)654-7813

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PROJECT ADDRESS:
HOLLY SPRINGS, NORTH CAROLINA

F & S LAND DEVELOPMENT


FOUNDATION DETAILS LLC

228 Commerce Blvd. Statesville, NC 28625


Limited Engineering License # D-0140

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NC24204

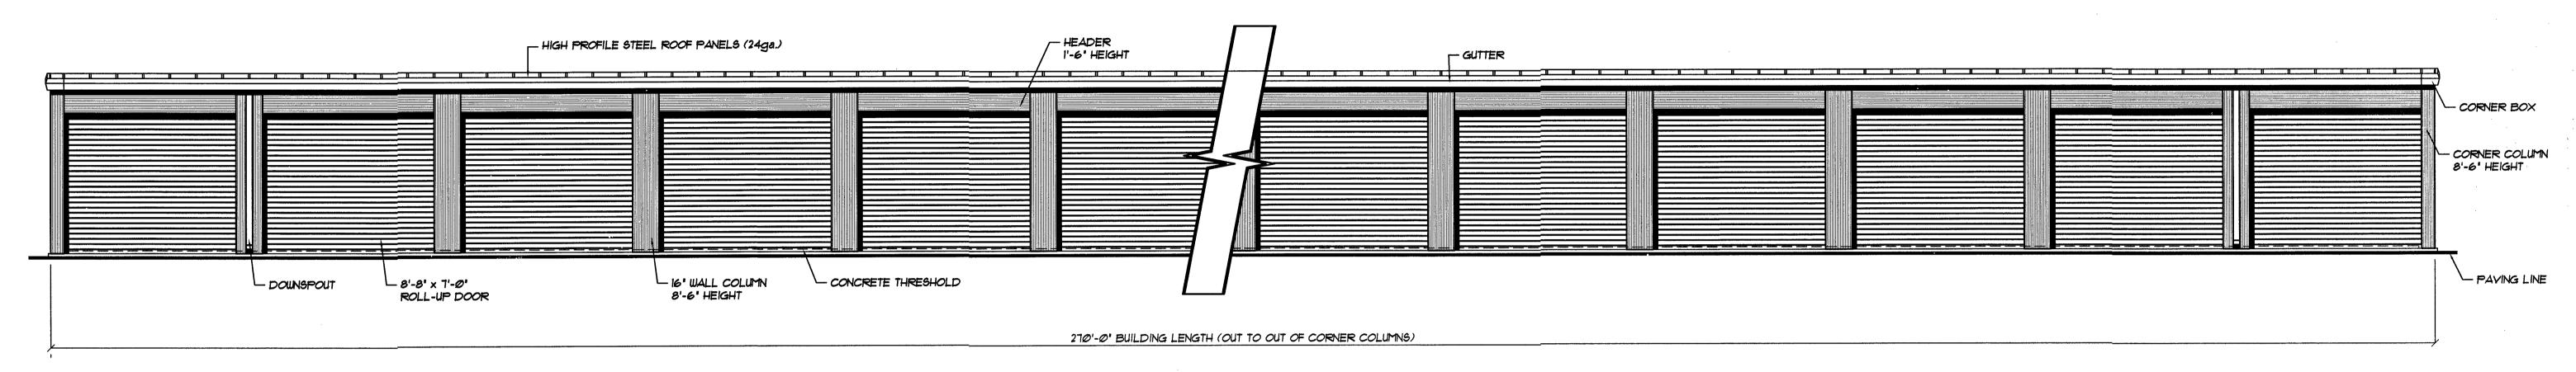

A SIDEWALL ELEVATION . . BUILDING "3"
SI SCALE: 1/4" = 1'-0"

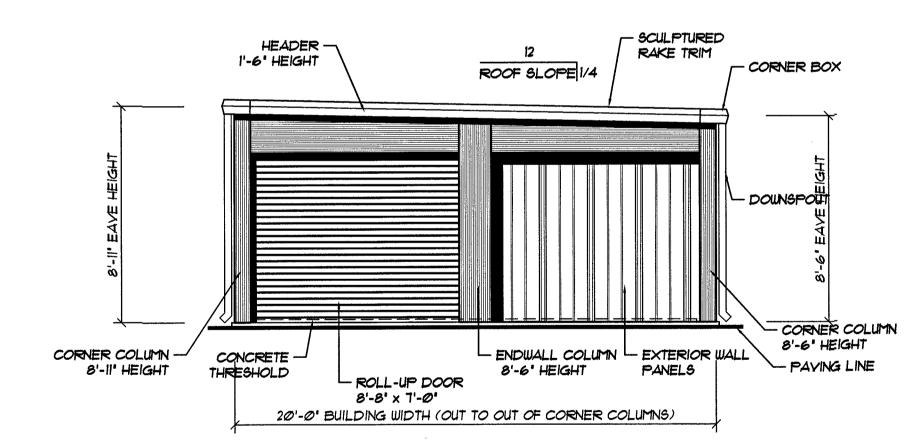

BENDWALL ELEVATION . . BUILDING "3"
SI SCALE: 1/4" = 1'-0'

NOTE:
DOWNSPOUTS LOCATIONS SHOWN FOR
ELEVATION PURPOSE ONLY, REFER
TO FLOOR PLAN SHEETS FOR LOCATIONS


NOTE: . . SEE OWNER FOR BUILDING ORIENTATION ON SITE


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228 Commerce Blvd.	
Statesville, NC 28625	
Limited Engineering Licens	se # D-0140


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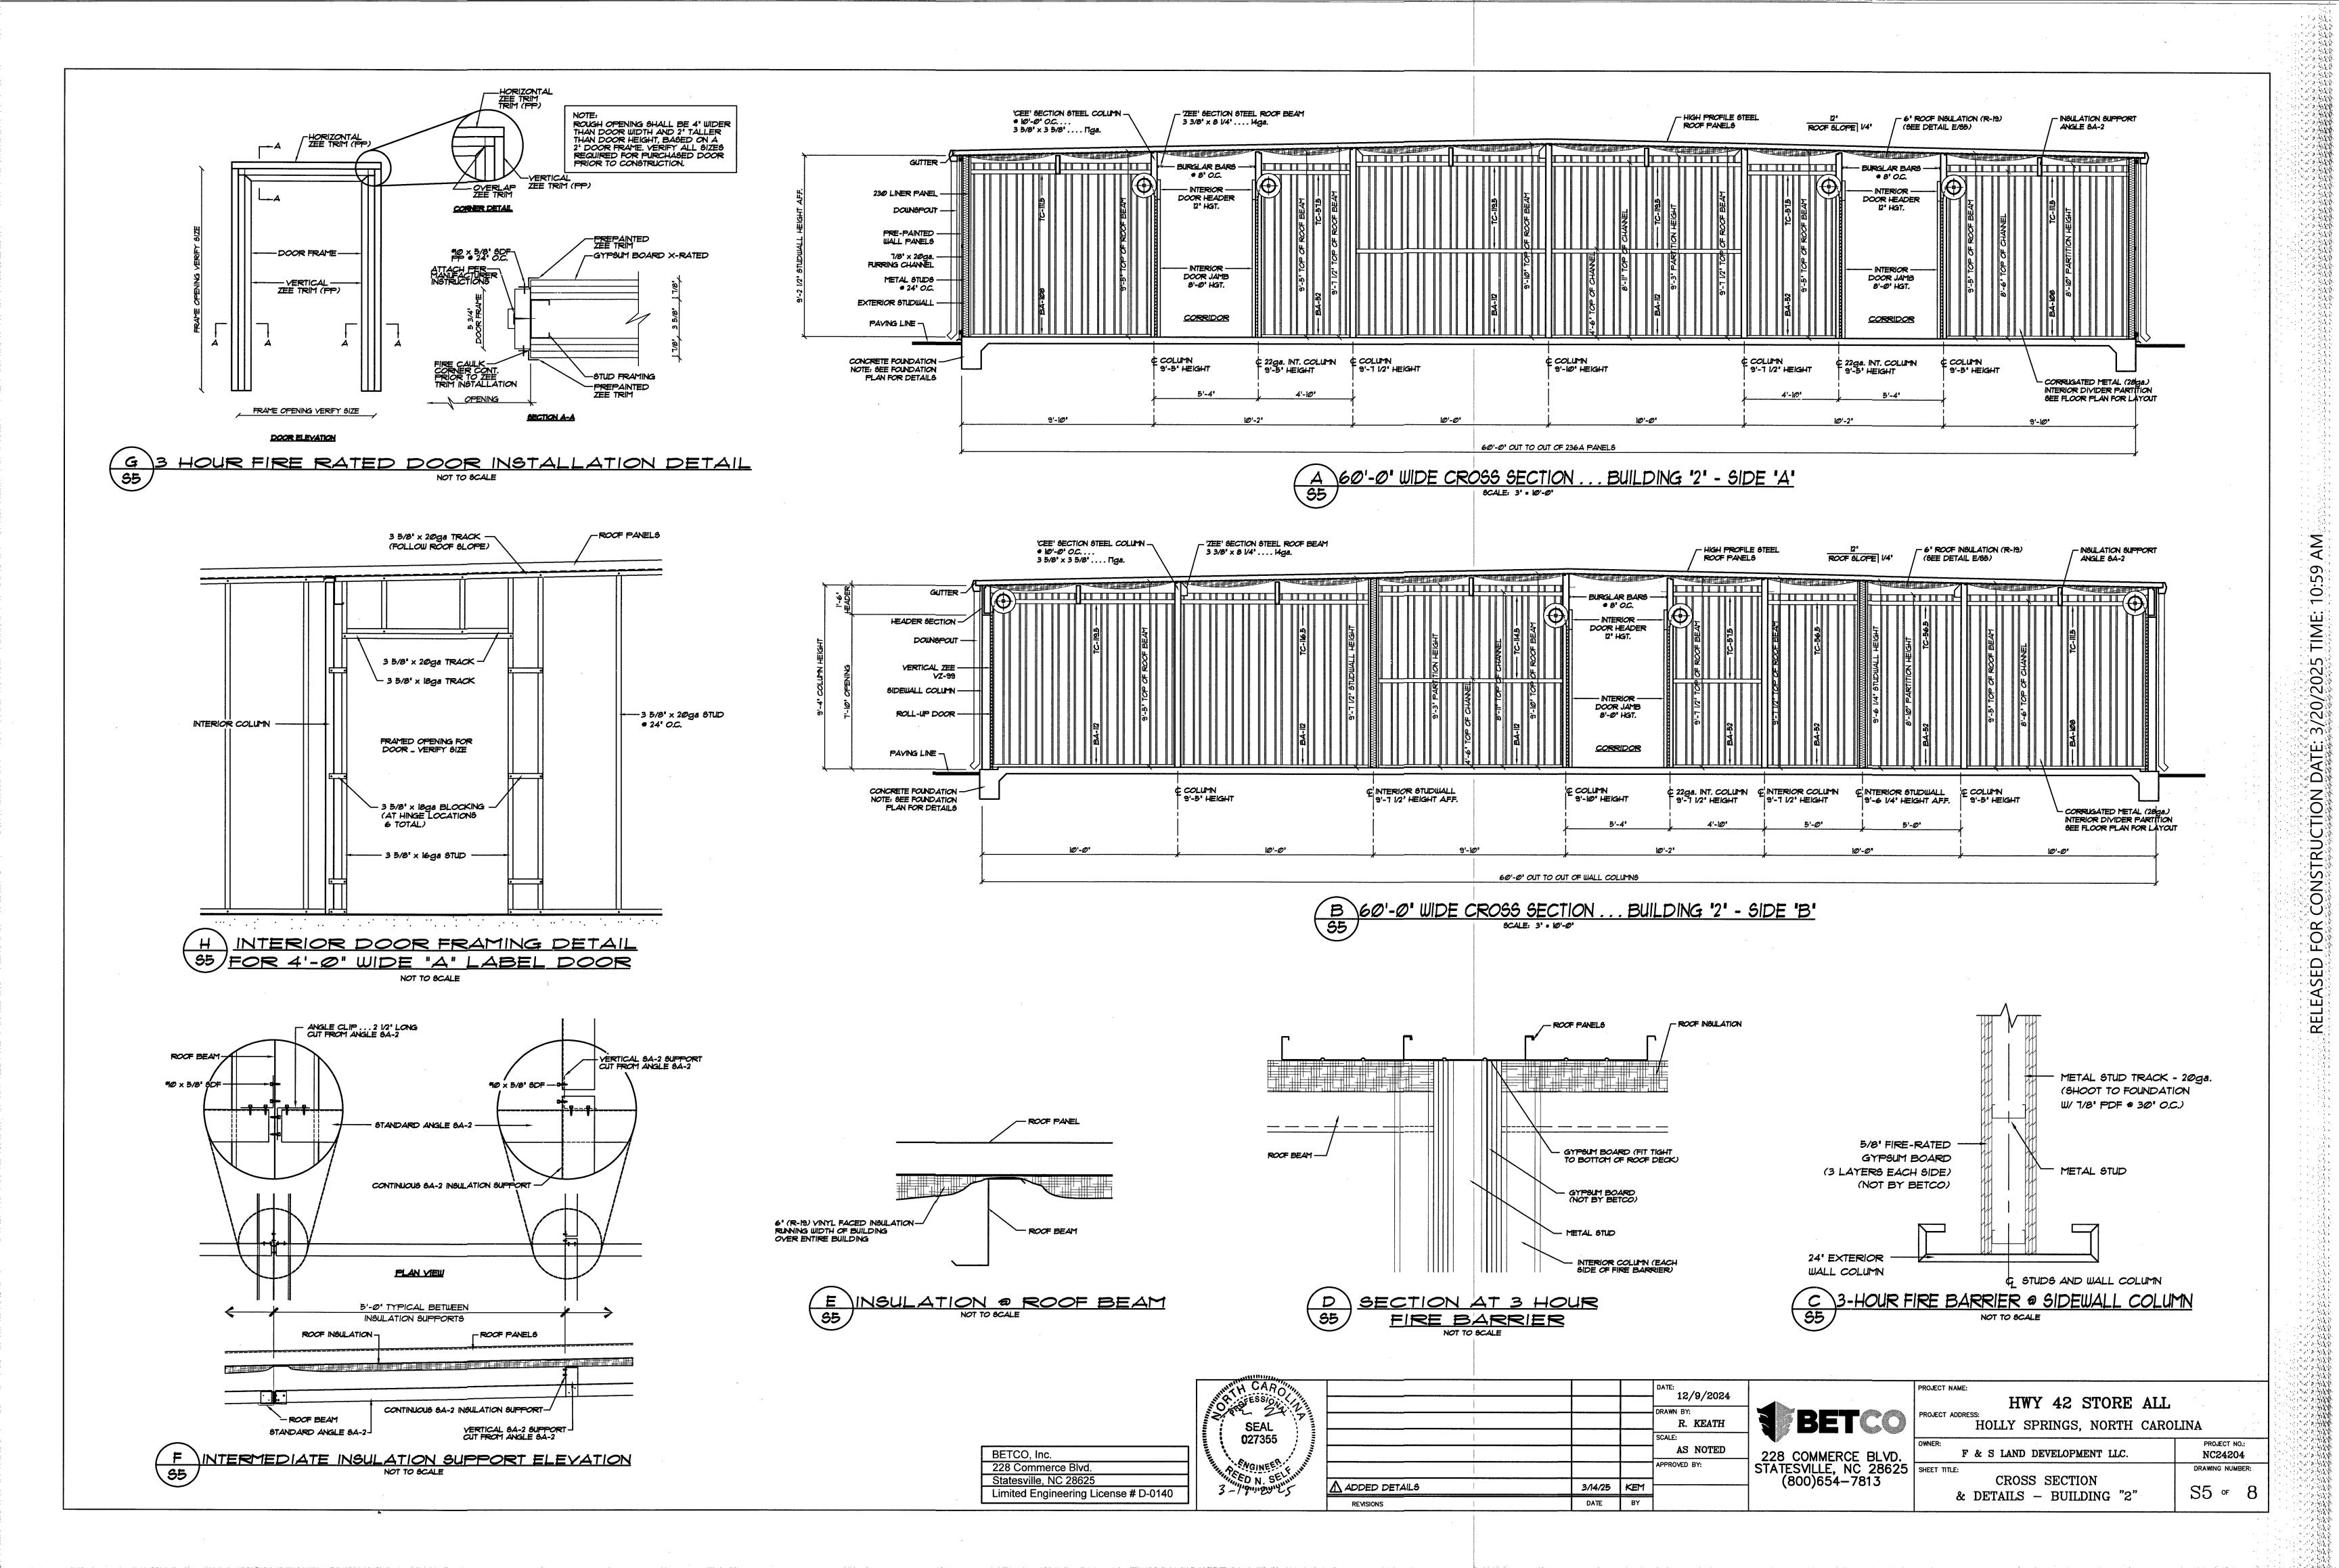
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	_ ****	HWY 42 STORE ALL	
	BETCO	PROJECT ADDRESS: HOLLY SPRINGS, NORTH CARO	Ι
		OWNER: F & S LAND DEVELOPMENT LLC.	
	228 COMMERCE BLVD. STATESVILLE, NC 28625 (800) 654-7813	ELEVATIONS & NOTES BUILDING "3"	

	HOLLY SPRINGS, NORTH CARO	LINA
	OWNER: F & S LAND DEVELOPMENT LLC.	PROJECT NO.: NC24204
	SHEET TITLE:	DRAWING NUMBER:
5	ELEVATIONS & NOTES BUILDING "3"	S1 of 8



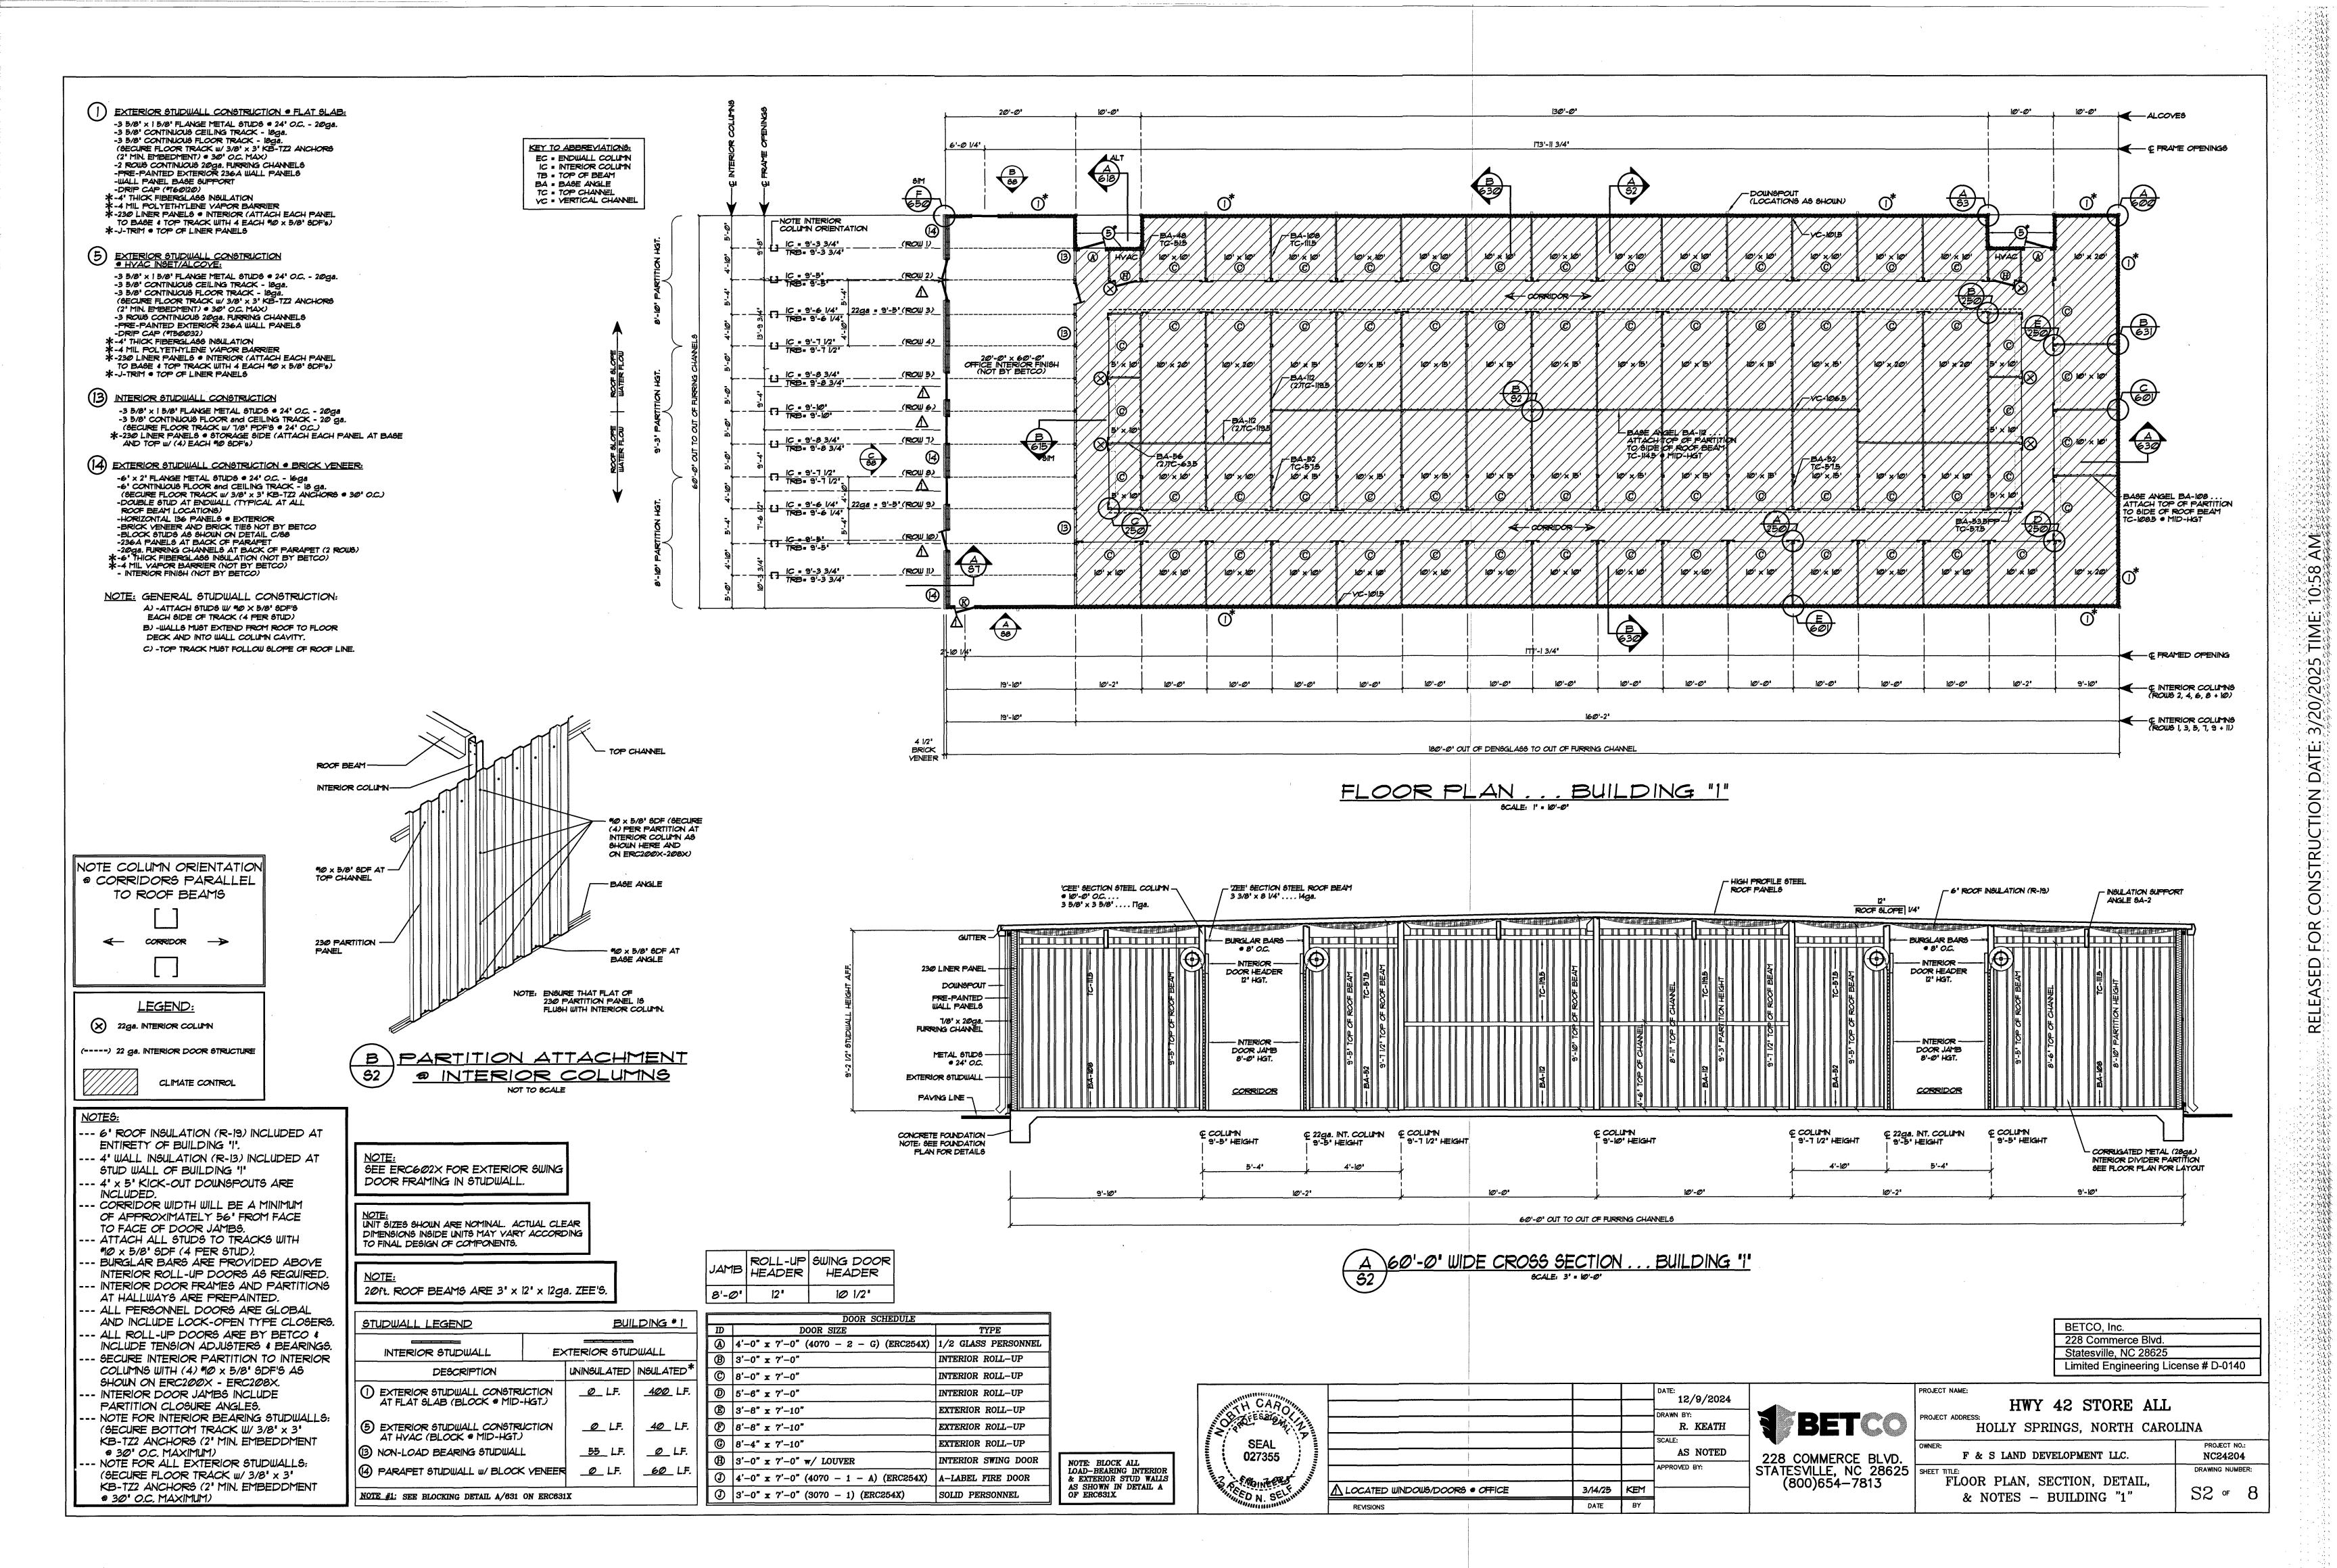

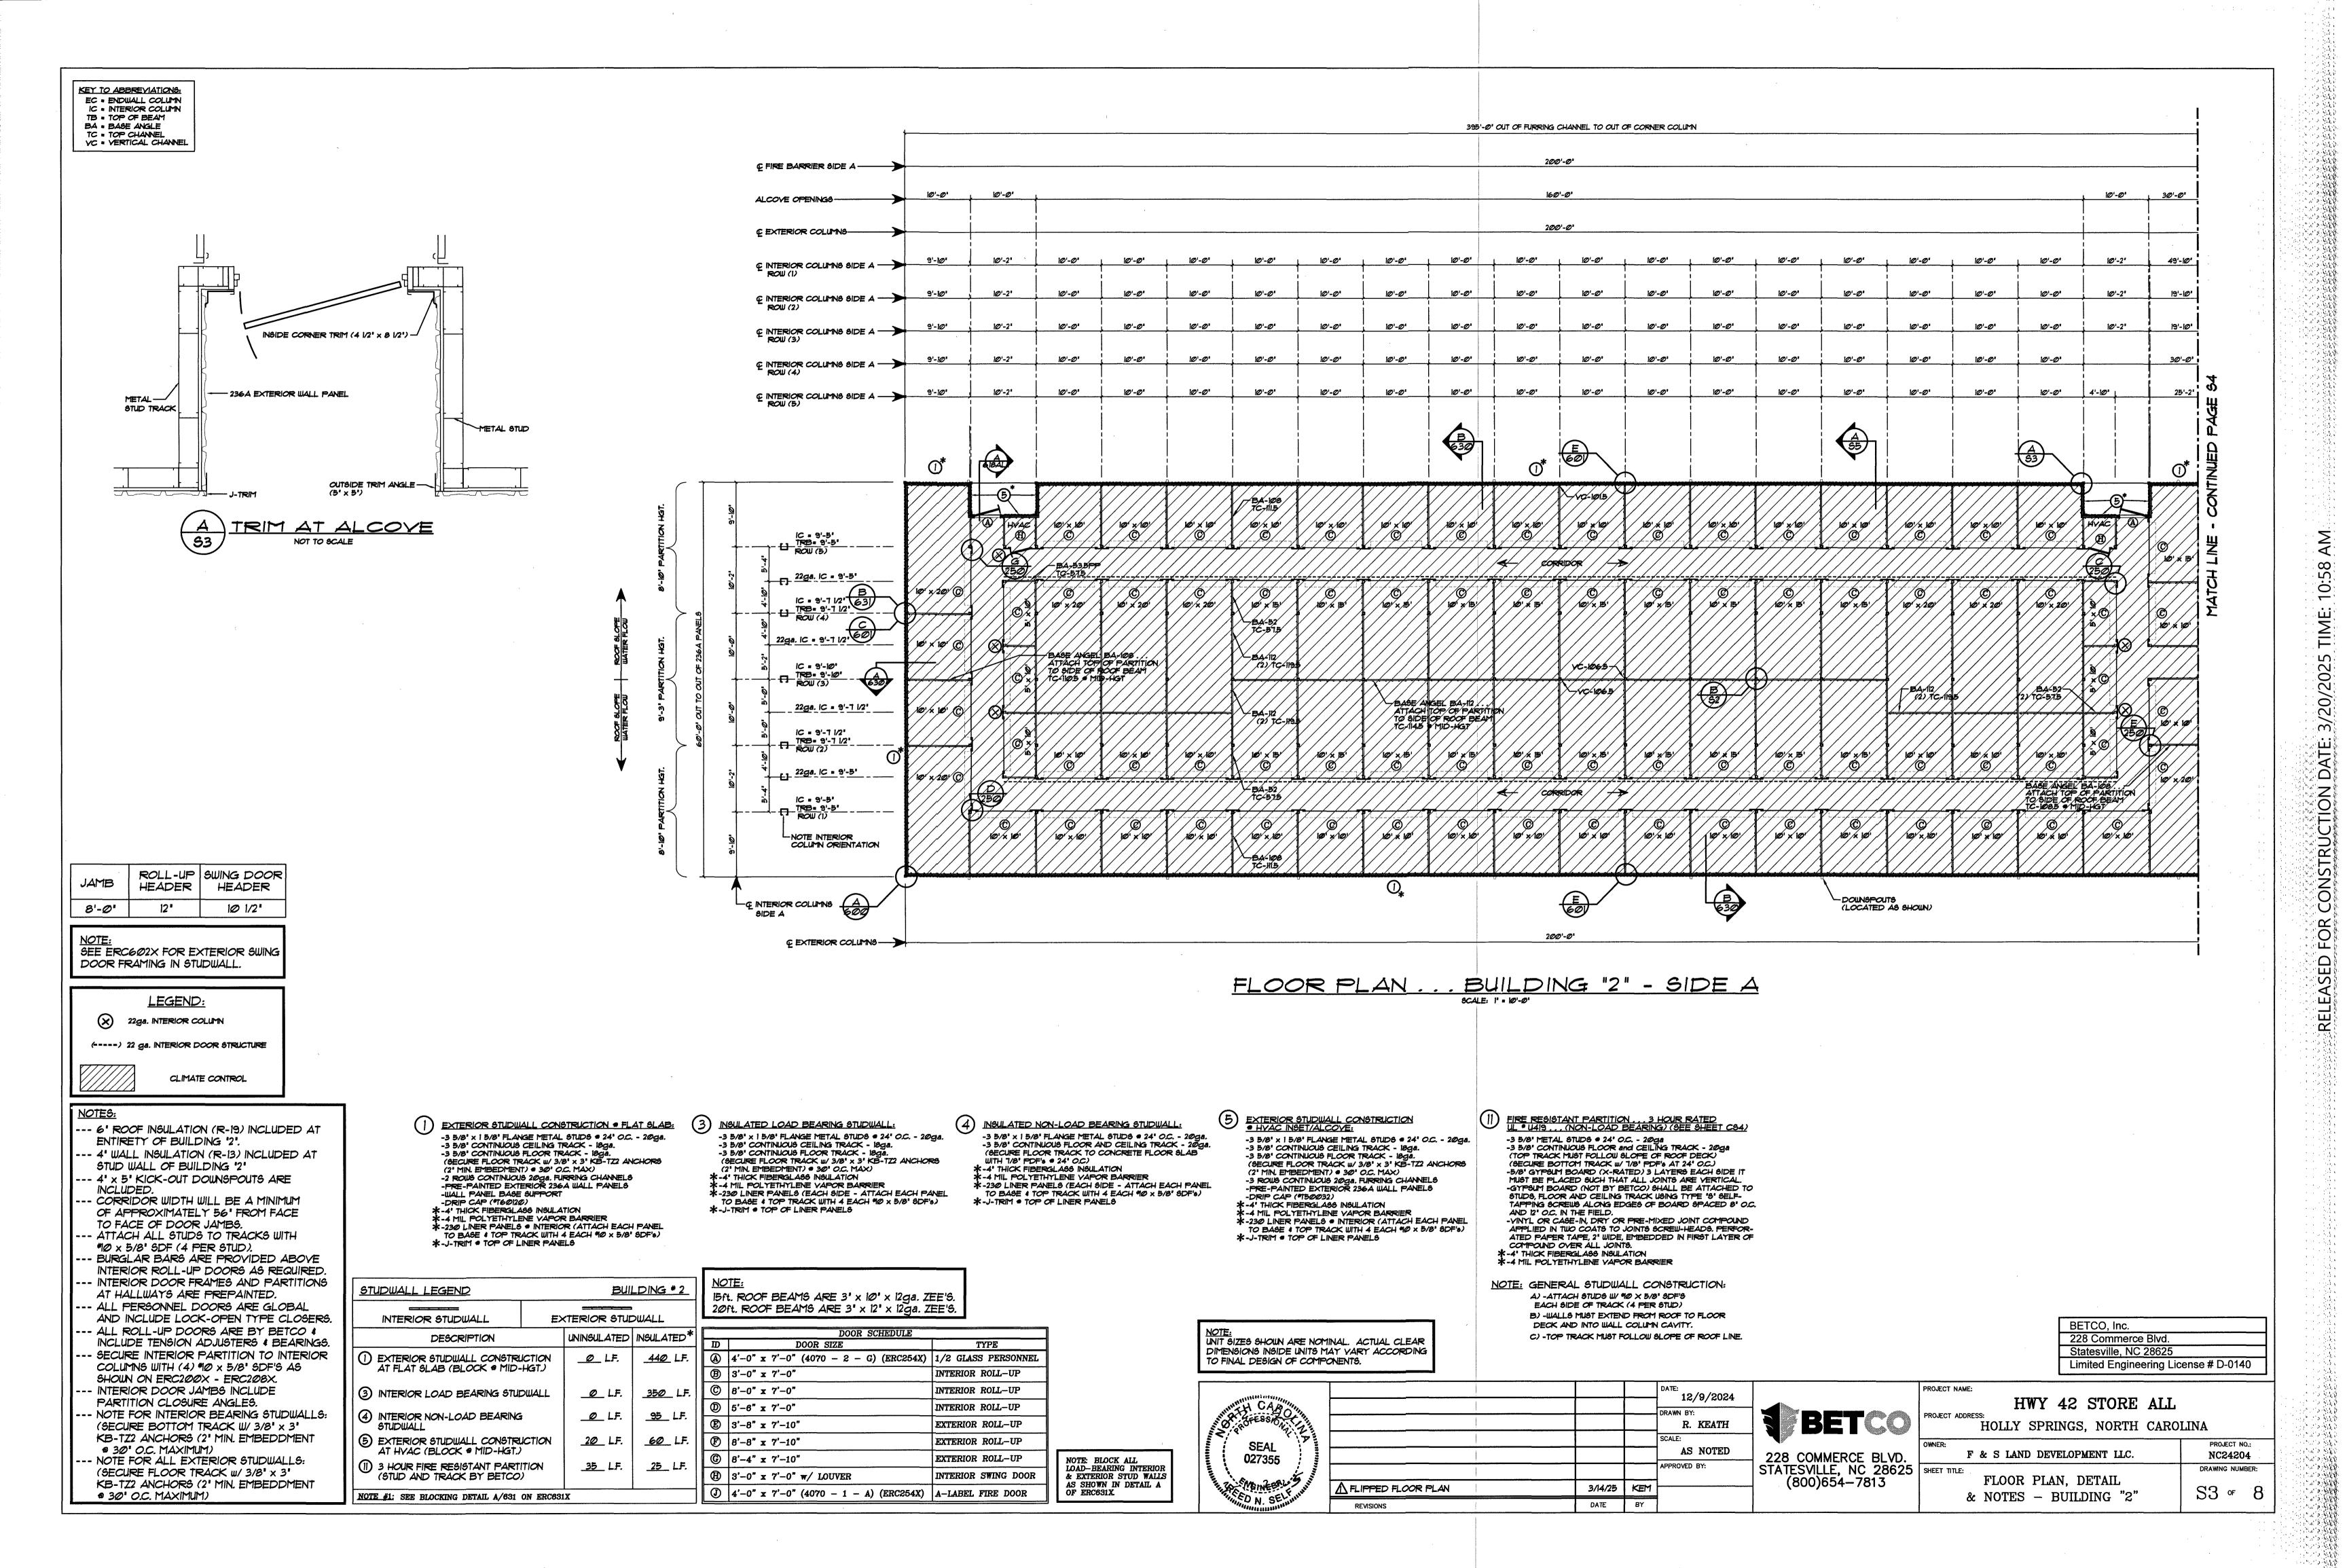

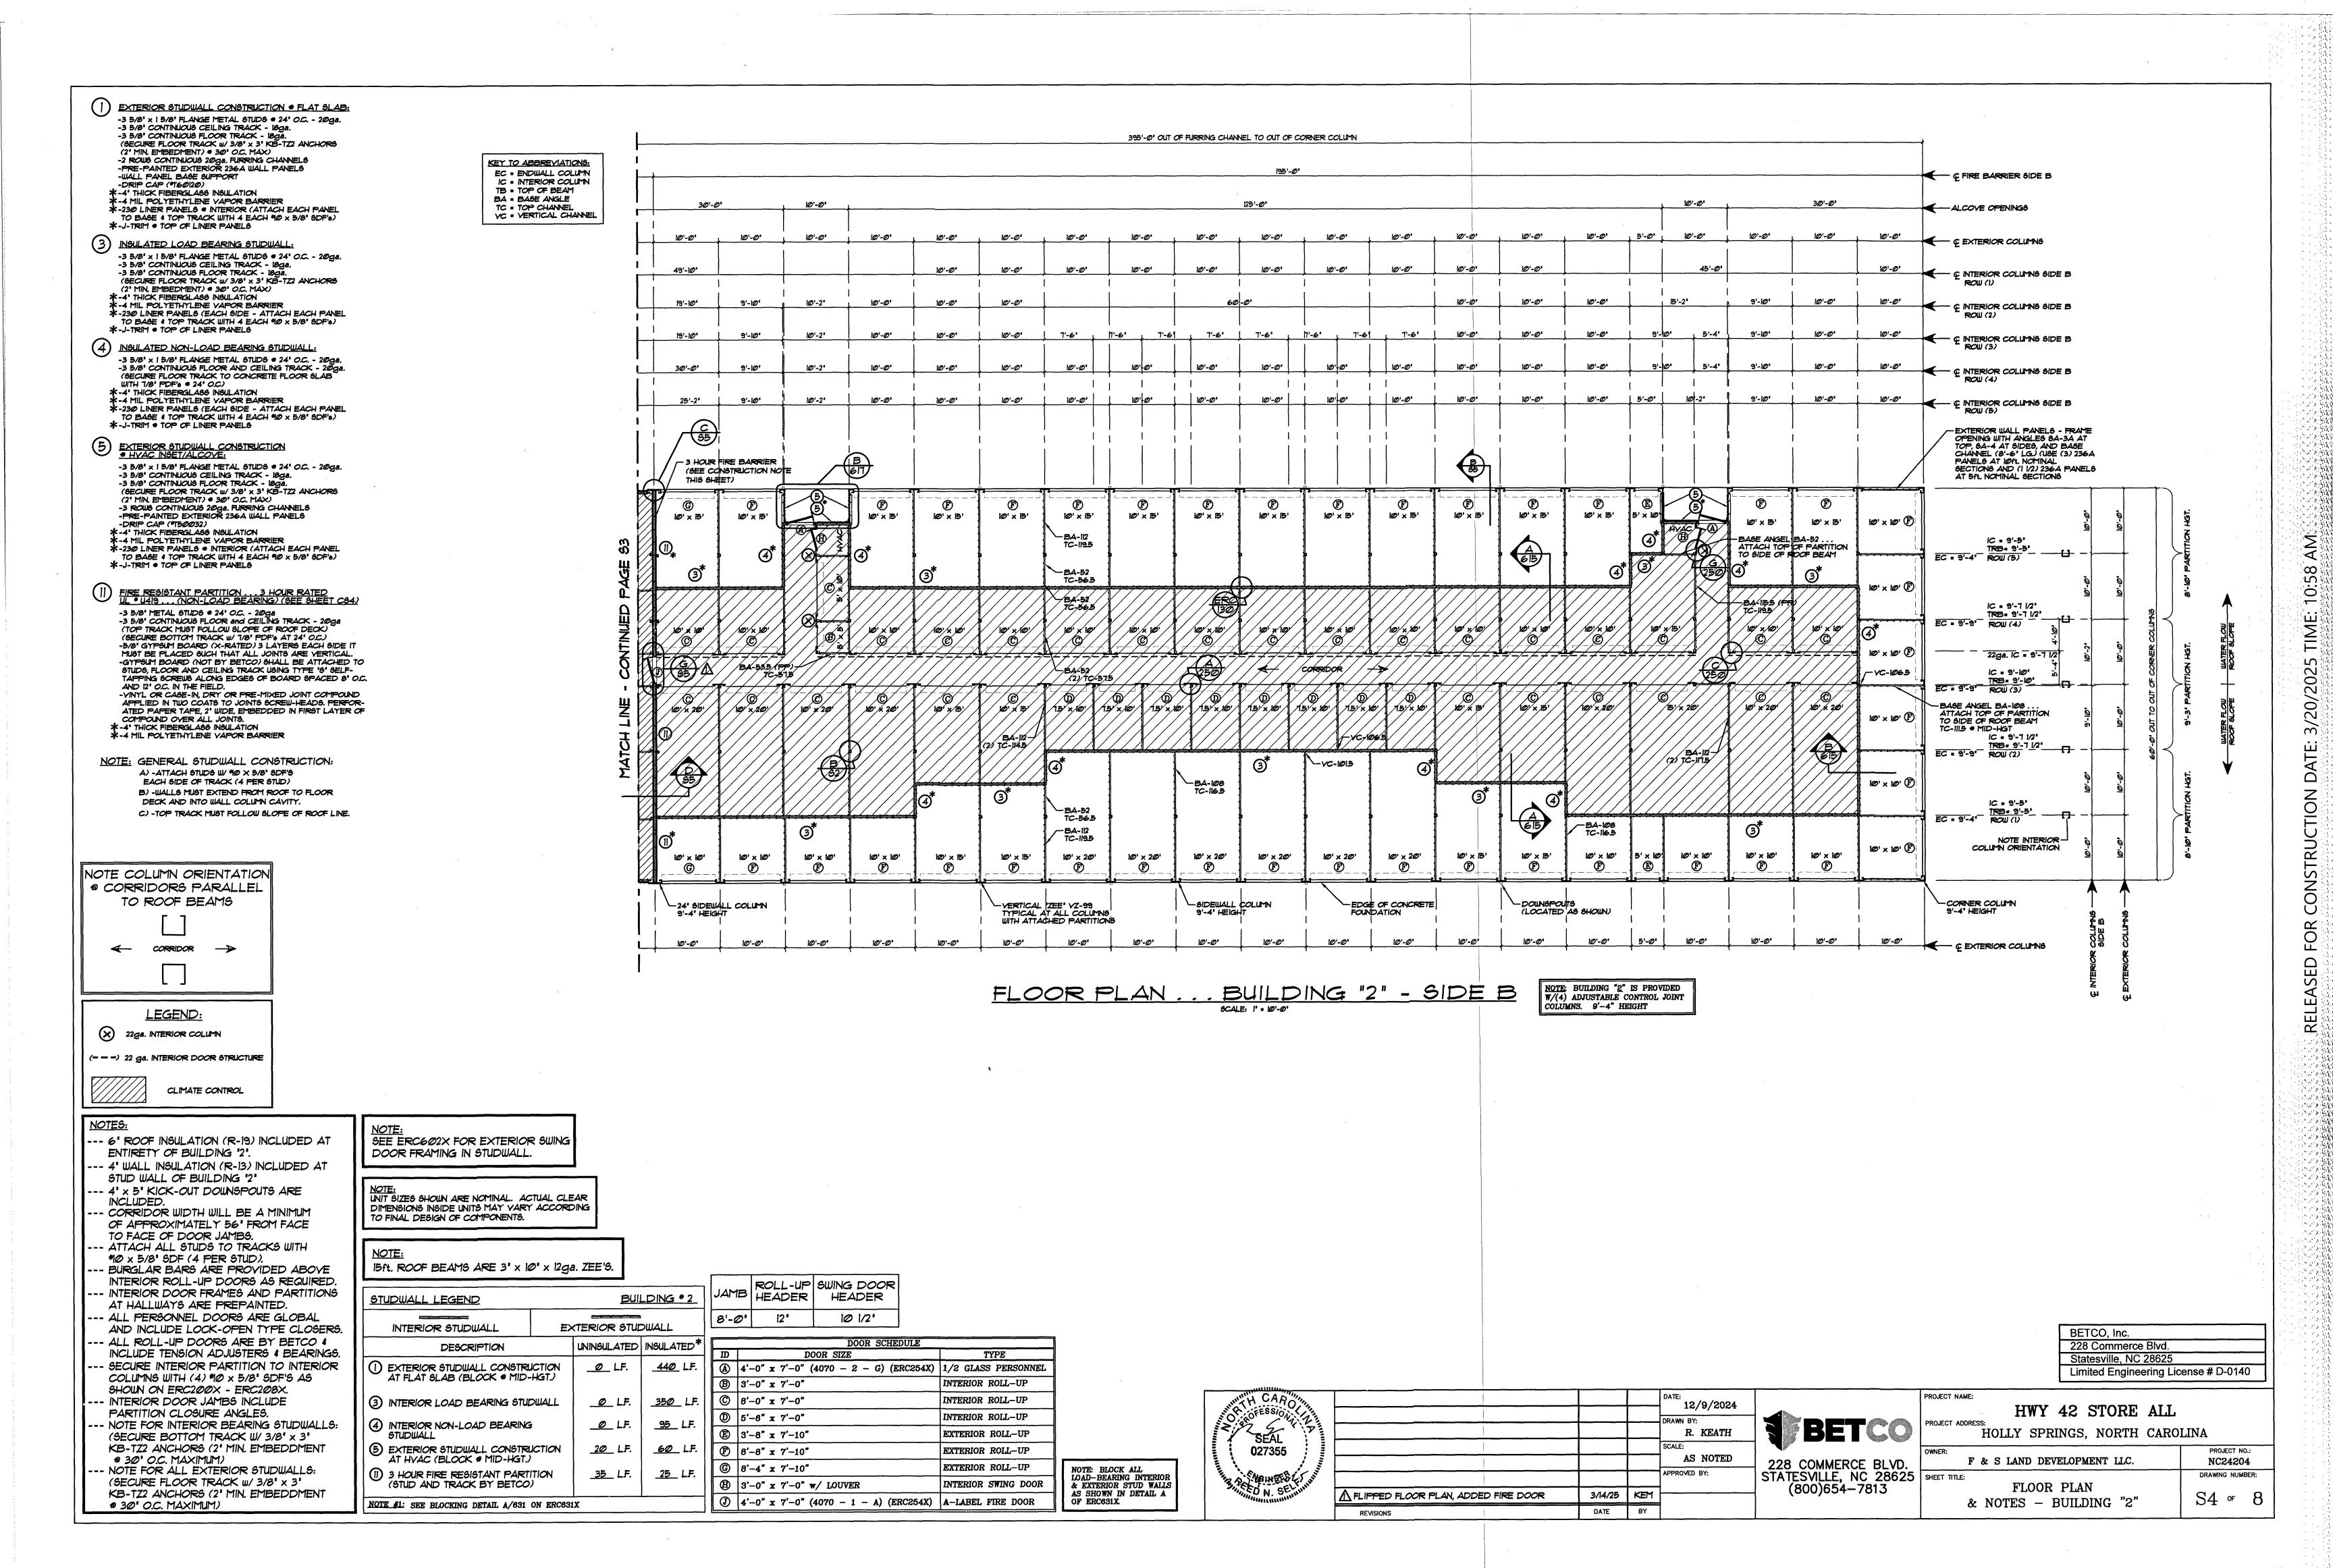

GENERAL STUDWALL CONSTRUCTION:

A) -ATTACH STUDS W/ *10 X 5/8* SDF'S

EACH SIDE OF TRACK (4 PER STUD)

B) -WALLS MUST EXTEND FROM ROOF TO FLOOR

DECK AND INTO WALL COLUMN CAVITY.

C) -TOP TRACK MUST FOLLOW SLOPE OF ROOF LINE.

EXTERIOR STUDWALL CONSTRUCTION • FLAT SLAB:

-3 5/8' x 1 5/8' FLANGE METAL STUDS • 24' O.C. - 20ga.

-3 5/8' CONTINUOUS CEILING TRACK - 18ga.

-3 5/8' CONTINUOUS FLOOR TRACK - 18ga.

(SECURE FLOOR TRACK W/ 3/8' x 3' KB-TZZ ANCHORS


(2' MIN. EMBEDMENT) • 30' O.C. MAX)


-2 ROWS CONTINUOUS 20ga. FURRING CHANNELS


-PRE-PAINTED EXTERIOR 236A WALL PANELS

-WALL PANEL BASE SUPPORT

-DRIP CAP (*160120)

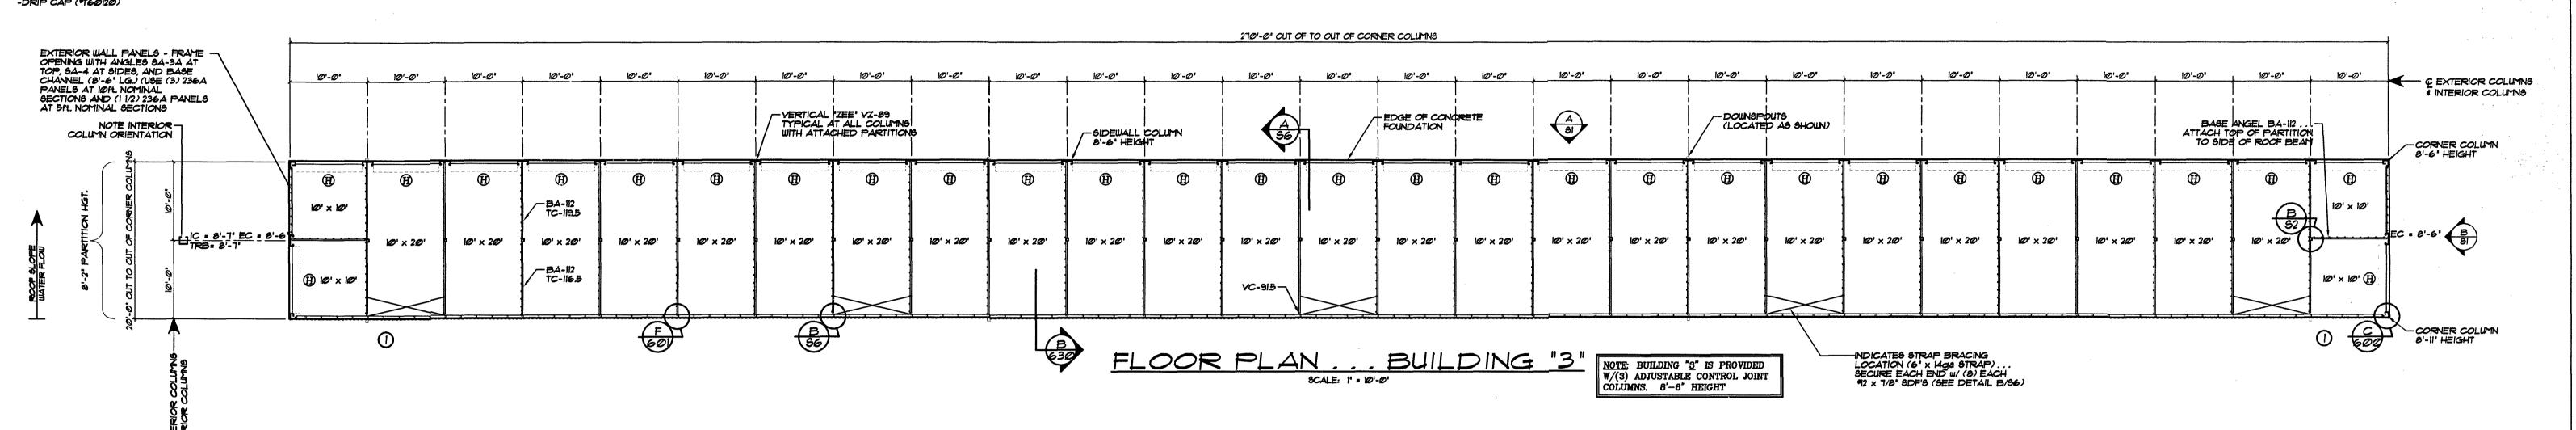

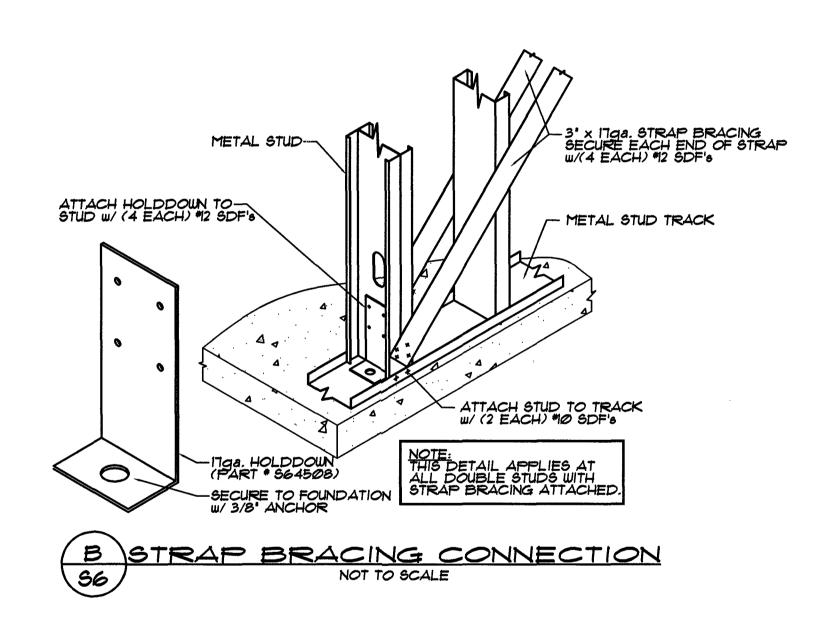

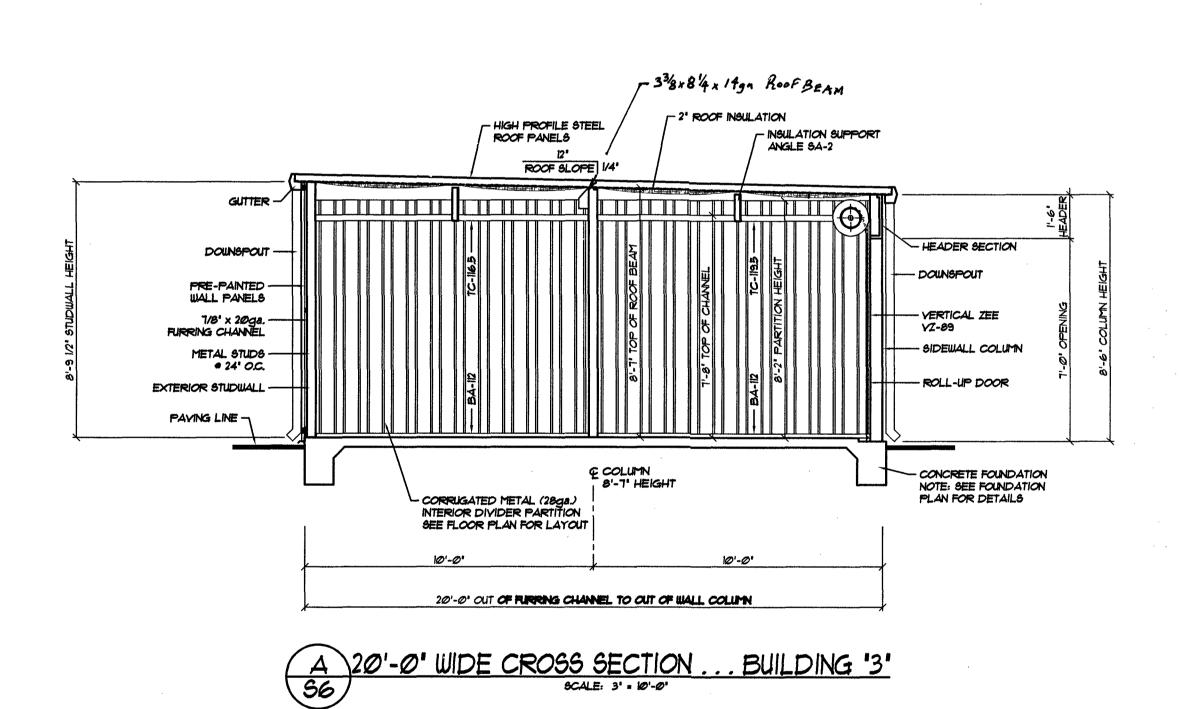

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	BEARING		ERIOR	ı
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S SH	OWN IN	DET	AIL A	ı
F ER	C631X.			ı

STUDWALL LEGEND		Buij	LDING #3
INTERIOR STUDWALL	E	XTERIOR STUD	DWALL
DESCRIPTION		UNINGULATED	INSULATED*
(1) EXTERIOR STUDWALL CONSTRUCT AT FLAT SLAB (BLOCK * MID-HO	TION ET.)	<u>270</u> LF.	<u>Ø</u> LF.

		DOOR SCHEDULE	
	ID	DOOR SIZE	TYPE
	A	4'-0" x 7'-0" (4070 - 2 - G) (ERC254X)	1/2 GLASS PERSONNEL
-	₿	3'-0" x 7'-0"	INTERIOR ROLL-UP
	©	8'-0" x 7'-0"	INTERIOR ROLL-UP
*	(D)	5'-6" x 7'-0"	INTERIOR ROLL-UP
\dashv	Œ	3'-8" x 7'-10"	EXTERIOR ROLL-UP
	(F)	8'-8" x 7'-10"	EXTERIOR ROLL-UP
4	©	8'-4" x 7'-10"	EXTERIOR ROLL-UP
	(H)	8'-8" x 7'-0"	EXTERIOR ROLL-UP

1	NOTE:
	UNIT SIZES SHOWN ARE NOMINAL. ACTUAL CLEAR
Н	DIMENSIONS INSIDE UNITS MAY YARY ACCORDING
Н	UNIT SIZES SHOWN ARE NOMINAL. ACTUAL CLEAR DIMENSIONS INSIDE UNITS MAY VARY ACCORDING TO FINAL DESIGN OF COMPONENTS.
H	

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HINTH CAROLLIN	DATE: 12/9/2024	
OZROESSON TO	DRAWN BY: R. KEATH	BETC
SEAL 027355	SCALE:	
ENOUTER!	AS NOTED APPROVED BY:	228 COMMERCE BL' STATESVILLE, NC 28
12 CORSEL INTER		(800)654-7813

DATE BY

BETCO, Inc.
228 Commerce Blvd.
Statesville, NC 28625
Limited Engineering License # D-0140

9:19 AM

1/8/2025 TIME:


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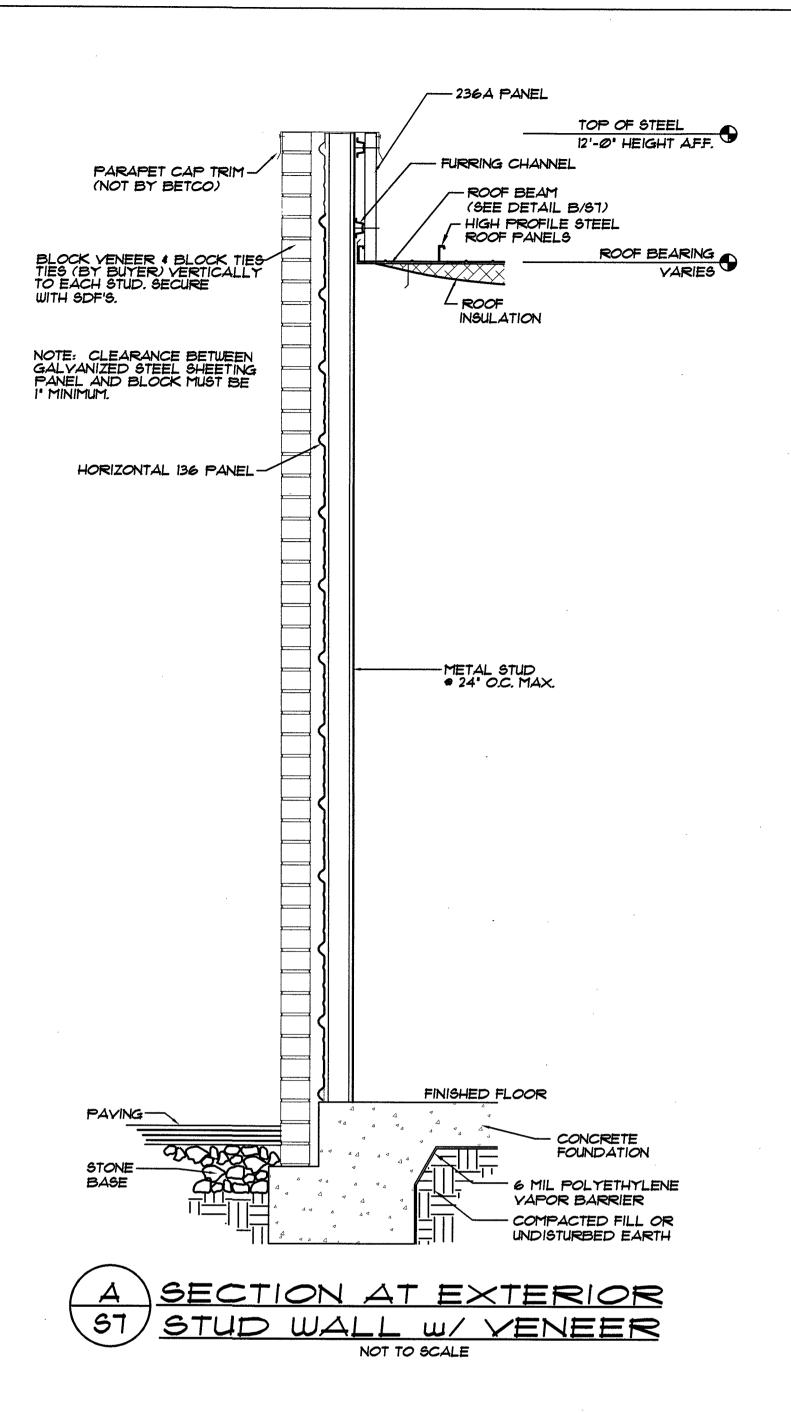
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HWY 42 STORE ALL
PROJECT ADDRESS:
HOLLY SPRINGS, NORTH CAROLINA

D.	OWNER: F & S LAND DEVELOPMENT LLC.	PROJECT NO.: NC24204
525	SHEET TITLE: FLOOR PLAN, CROSS SECTION, DETAIL & NOTES — BUILDING "3"	DRAWING NUMBER:




TO PARAPET WALL

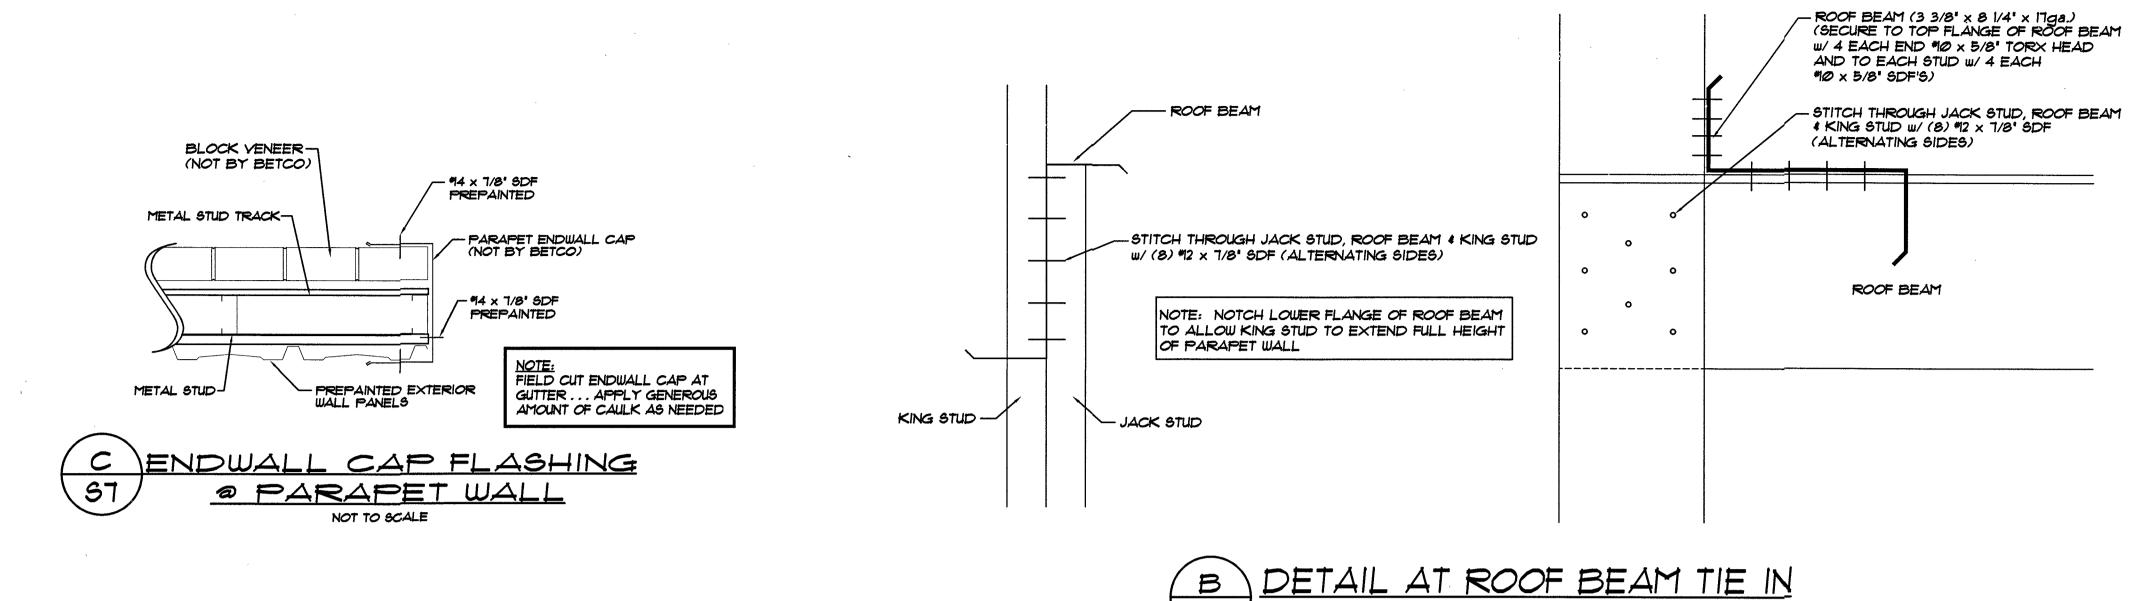

	BETCO, Inc.
	228 Commerce Blvd.
	Statesville, NC 28625
	Limited Engineering License # D-0140
 E:	

SEAL 027355			DATE: 12/9/20 DRAWN BY: R. KEAT SCALE: AS NOTE APPROVED BY:	BET
William Million	REVISIONS	DATE	BY	·

24		PROJECT NAME: HWY 42 STORE ALL	
I	BETCO	PROJECT ADDRESS: HOLLY SPRINGS, NORTH CARO	LINA
D	228 COMMERCE BLVD.	OWNER: F & S LAND DEVELOPMENT LLC.	PROJECT NO.: NC24204
	STATESVILLE, NC 28625 (800)654-7813	SHEET TITLE: BUILDING DETAILS BUILDING "1"	DRAWING NUMBER: $S7$ of $\{$

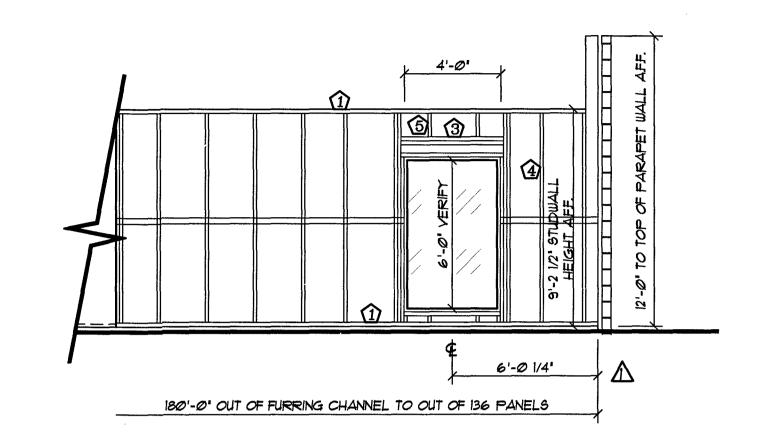


B FRAMING ELEVATION SIDEWALL . . BUILDING "1"

(NOTE: VERIFY ALL ROUGH OPENING LOCATIONS AND SIZES)

A FRAMING ELEVATION SIDEWALL . . . BUILDING "1"

S8 SCALE: 1/4" = 1'-0" (NOTE: VERIFY ALL ROUGH OPENING LOCATIONS AND SIZES)

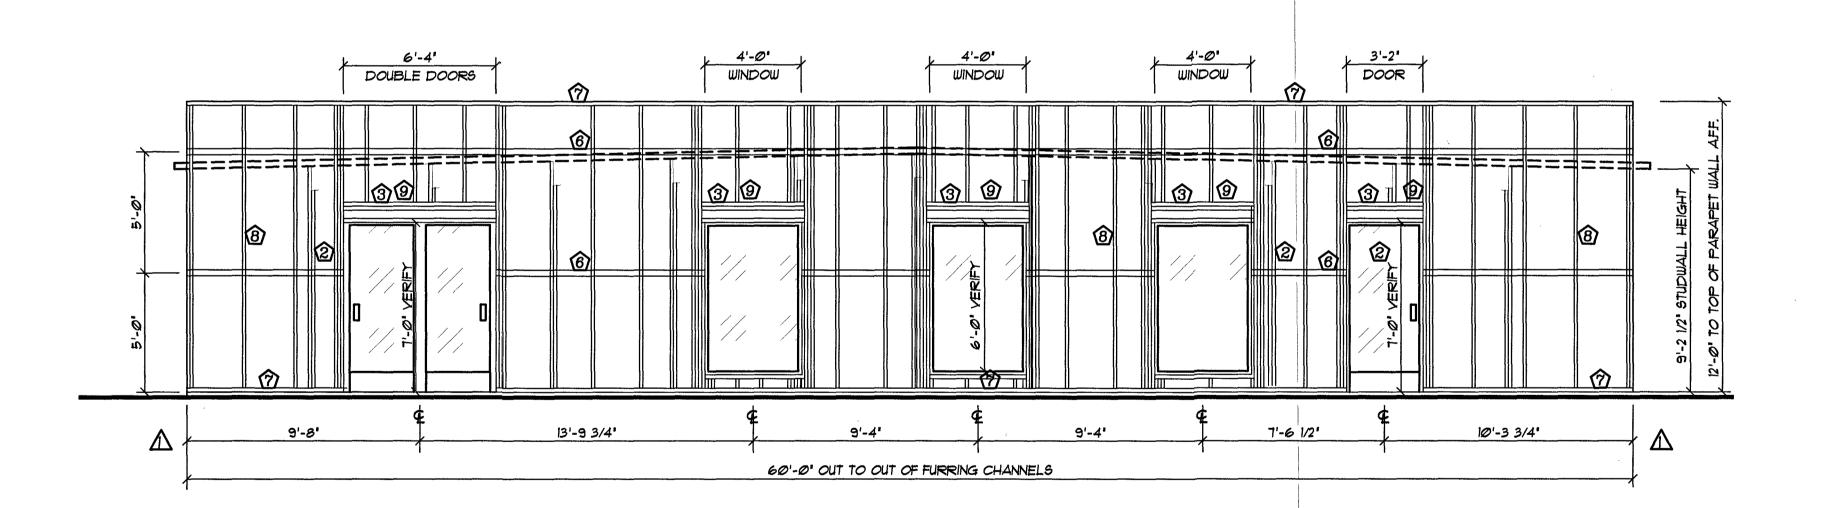

LEGEND:

- 1 METAL STUD TRACK (3 5/8" × 1 1/4" LEG × 18ga) FASTEN TO EACH METAL STUD WITH 2 EACH #10 × 5/8" SDF PER FLANGE
- 2 EACH METAL STUD AT EACH ROOF BEAM LOCATION SIMILAR TO C/601X.
- 3 DH-1 DOUBLE CEE BOXED HEADER 6" (SEE ERC602X) W/ 169a STUDS.
 USE 14GA AT OPENINGS OVER 5'-0" WIDE.
- (1) I EACH METAL STUD (3 5/8" x 1 5/8" x 18ga)
- (3) METAL STUD TRACK ABOVE HEADER (3 5/8" x 1 1/4" x 18ga) FASTEN TO EACH METAL STUD WITH 2 EACH #10 x 5/8" SDF PER FLANGE FASTEN TO TOP OF DH-1 WITH 2 EACH #12 x 7/8" SDF AT 12" O.C.
- 6 STRAP BRACING FOR BLOCKING (SEE DETAIL 'A' ON ERC63IX)
- METAL STUD TRACK (6" x 1 1/4" LEG x 18ga) FASTEN TO EACH METAL STUD WITH 2 EACH *10 x 5/8" SDF PER FLANGE
- (8) I EACH METAL STUD (6' x 2' x 16ga)
- 9 METAL STUD TRACK ABOVE HEADER (6" x 1 1/4" x 18ga) FASTEN TO EACH METAL STUD WITH 2 EACH MO x 5/8" SDF PER FLANGE FASTEN TO TOP OF DH-1 WITH 2 EACH M2 x 7/8" SDF AT 12" O.C.

C FRAMING ELEVATION ENDWALL . . BUILDING "1"

S8 SCALE: 1/4" - 1'-0' (NOTE: YERIFY ALL ROUGH OPENING LOCATIONS AND SIZES)

HATH CAROLL				DATE: 12/9/2024		PF
O SOUTH THE STATE OF THE STATE				DRAWN BY: R. KEATH	BETCO	PF
SEAL 027355				SCALE: AS NOTED	228 COMMERCE BLVD.	OV
THE TO SUPERTY STATES				APPROVED BY:	I	Sł
TO N. SELVIN	LOCATED WINDOWS/DOORS @ OFFICE	3/14/25 DATE	KEM		(000)004 /010	

BETCO, Inc.
228 Commerce Blvd.
Statesville, NC 28625
Limited Engineering License # D-0140

BETCO

PROJECT NAME:

HWY 42 STORE ALL

PROJECT ADDRESS:
HOLLY SPRINGS, NORTH CAROLINA

OWNER:	F	& S LAND DEVELOPMENT LLC.	PROJECT NO.: NC24204
SHEET TITLE:		EDAMING ELEVATIONS	DRAWING NUMBER:
		FRAMING ELEVATIONS BUILDING "1"	S8 of 8