


ENCLOSED GABLE END BUILDING

0'-30' (MAX.) WIDE X 16'-0" EAVE HEIGHT WITH BOX FRAME / (UP TO) 145 M.P.H. WIND ZONE - 30 P.S.F. SNOW LOAD


FOR:

SELECT STEEL BUILDINGS, INC.
2745 STATESVILLE RD.
WILKESBORO, NORTH CAROLINA
TELE: 336-973-0721



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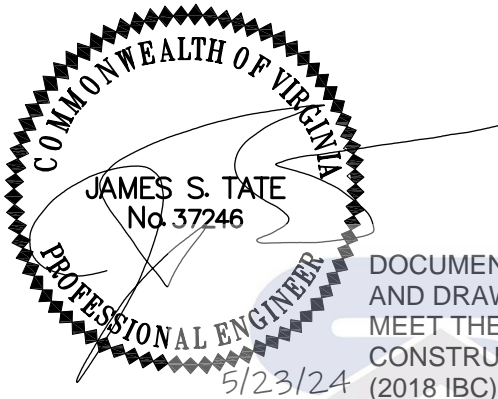
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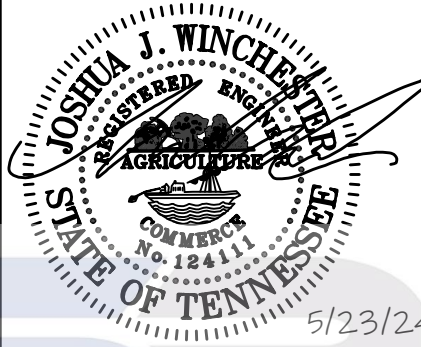
DOCUMENTS DESIGNED AND DRAWN TO
MEET THE 2018 NC BUILDING CODE (2015 IBC)

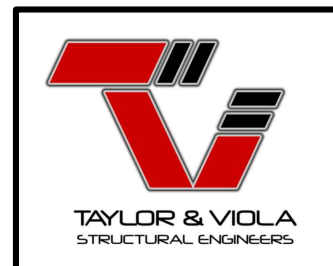

DOCUMENTS DESIGNED AND DRAWN TO
MEET THE 2021 SC BUILDING CODE (2021 IBC)

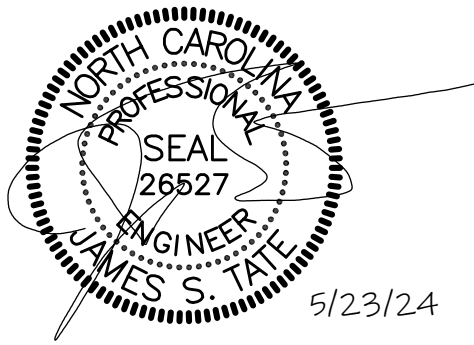

DOCUMENTS DESIGNED
AND DRAWN TO
MEET THE 2018 VA
CONSTRUCTION CODE
(2018 IBC)

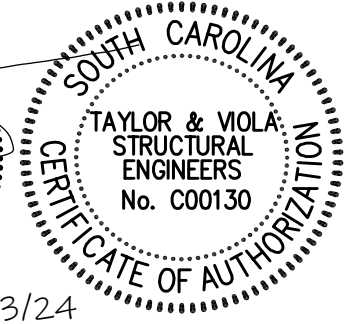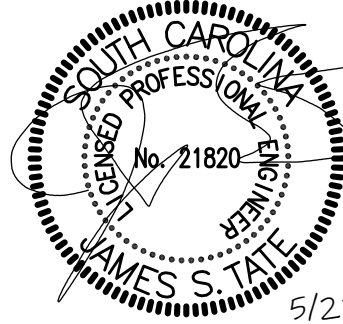

DOCUMENTS DESIGNED AND DRAWN TO
MEET THE 2012 IBC



DOCUMENTS DESIGNED AND DRAWN TO
MEET THE 2018 IBC



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SELECT STEEL
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WILKESBORO, NORTH CAROLINA 28697
TELE: 366-973-0721

DRAWN BY:
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DATE:
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PROJECT NO:
24-511

SHEET NO:
S1

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SHEET NUMBER	SHEET TITLE	SHEET NUMBER	SHEET TITLE
S0	SEALED COVER SHEET	S8	(SOIL) BASE RAIL ANCHORAGE
S1	P.E. SEALS SHEET	S8A	(ASPHALT) BASE RAIL ANCHORAGE
S1A	P.E. SEALS SHEET	S9	TYPICAL BOX EAVE / END WALL FRAMING AND OPENINGS
S1B	P.E. SEALS SHEET	S9A	TYPICAL BOX EAVE / SIDE WALL FRAMING AND OPENINGS
S2	DRAWING INDEX	S10	CONNECTION DETAILS
S3	GENERAL NOTES AND SPECIFICATIONS	S11	CONNECTION DETAILS
S4	SIDE AND END ELEVATIONS	S12	CONNECTION DETAILS
S5	TYPICAL RAFTER / COLUMN FRAME SECTIONS (<16'H / >21' TO <24'W)	S13	CONNECTION DETAILS
S5A	TYPICAL RAFTER / COLUMN FRAME SECTIONS (<16'H / >25' TO <30'W)	S14	BOX EAVE RAFTER / SINGLE & DOUBLE RAFTER LEAN-TO OPTIONS
S5B	TYPICAL FRAME SECTIONS	S14A	BOX EAVE / LACED RAFTER LEAN-TO OPTIONS
S6	BOX EAVE / SINGLE COLUMN SECTION (<14'H)	S14B	LEAN-TO HIP OPTIONS
S6A	BOX EAVE / DOUBLE COLUMN SECTION (<16'H)	S15	LEAN-TO CONNECTION DETAILS / SINGLE COLUMN
S7	BASE RAIL ANCHORGE / SINGLE COLUMN	S15A	LEAN-TO CONNECTION DETAILS / DOUBLE COLUMN
S7A	BASE RAIL ANCHORGE / SINGLE COLUMN (NO SLAB)	S15B	LEAN-TO CONNECTION DETAILS / SINGLE COLUMN / LACED RAFTER
S7B	BASE RAIL ANCHORGE / SINGLE COLUMN (NO SIDING SHELF)	S15C	LEAN-TO CONNECTION DETAILS / DOUBLE COLUMN / LACED RAFTER
S7C	BASE RAIL ANCHORGE / SINGLE COLUMN (NO SLAB / NO SIDING SHELF)	S15D	LEAN-TO / MAIN FRAME CONNECTION DETAILS
S7D	BASE RAIL ANCHORGE / SINGLE COLUMN (CLIP ANGLE ATTACHMENT OPTION)	S15E	LEAN-TO / MAIN FRAME / LACED RAFTER CONNECTION DETAIL
S7E	BASE RAIL ANCHORGE / DOUBLE COLUMN	S15F	LEAN-TO / MAIN FRAME CONNECTION DETAILS
S7F	BASE RAIL ANCHORGE / DOUBLE COLUMN (NO SLAB)	S15G	LEAN-TO / MAIN FRAME / LACED RAFTER CONNECTION DETAIL (FLUSH)
S7G	BASE RAIL ANCHORGE / DOUBLE COLUMN (NO SIDING SHELF)	S15H	END WALL COLUMN / HIP RAFTER CONNECTION DETAIL
S7H	BASE RAIL ANCHORGE / DOUBLE COLUMN (NO SLAB / NO SIDING SHELF)	S16	VERTICAL ROOF / SIDING OPTION
		S16A	VERTICAL ROOF / SIDING OPTION
		S16B	VERTICAL ROOF / SIDING OPTION
		S17	SIDE WALL HEADER OPTIONS
		S17A	END WALL HEADER OPTIONS

SELECT STEEL
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S2

NOTE: THESE DRAWINGS ARE VALID FOR (1) CALENDER YEAR AFTER THE ISSUE DATE LISTED ON THIS SHEET.

DESIGN LOADS:

IMPORTANCE FACTORS WIND (1w) 1.00
 SNOW (1s) 1.00
 SEISMIC (1e) 1.00

DEAD LOADS ROOF 13 P.S.F.
 ROOF COLLATERAL 0 P.S.F.

LIVE LOADS ROOF 20 P.S.F.

GROUND SNOW LOAD: 30 P.S.F. * DRIFT LOAD HAS NOT BEEN CALCULATED

WIND LOAD: BASIC WIND SPEED V 145 M.P.H. (ASCE 7-16)
 EXPOSURE CATEGORY A/B/C

SEISMIC DESIGN CATEGORY ☒ A ☒ B ☒ C ☐ D

PROVIDE THE FOLLOWING SEISMIC DESIGN PARAMETERS:

OCCUPANCY CATEGORY I/II

SPECTRAL RESPONSE ACCELERATION S_s VARIES BASED ON SITE %g S₁ VARIES BASED ON SITE %g

SITE CLASSIFICATION D ☐ FIELD TEST ☒ PRESUMPTIVE ☐ HISTORICAL DATA

BASIC STRUCTURAL SYSTEM (CHECK ONE)

<input type="checkbox"/>	BEARING WALL	<input type="checkbox"/>	DUAL W/ SPECTRAL MOMENT FRAME
<input checked="" type="checkbox"/>	BUILDING FRAME	<input type="checkbox"/>	DUAL W/ INTERMEDIATE R/C OR SPECIAL STEEL
<input type="checkbox"/>	MOMENT FRAME	<input type="checkbox"/>	INVERTED PENDULUM

ANALYSIS PROCEDURE ☐ SIMPLIFIED ☒ EQUIVALANT LATERAL FORCE ☐ MODAL

LATERAL DESIGN CONTROL? ☐ EARTHQUAKE ☒ WIND

SOIL BEARING CAPACITIES:
 PRESUMPTIVE BEARING CAPACITIES: 1,500 P.S.F.

GENERAL NOTES:

1. MAX FRAME SPACING SHALL BE 60"oc UNLESS NOTED OTHERWISE.
2. MAX. END-WALL COLUMN SPACING SHALL BE 60"oc UNLESS NOTED OTHERWISE.
3. TUBE MATERIAL SHALL BE 2-1/2" x 2-1/2" x 14ga. 50 K.S.I. MIN. UNLESS NOTED OTHERWISE.
4. ALL FASTENERS SHALL BE (2) #12 SELF TAPPING AT 9"oc UNLESS NOTED OTHERWISE.
5. 1,500 P.S.F. ASSUMED BEARING CAPACITY UNLESS NOTED OTHERWISE.
6. THESE DRAWINGS ARE NOT APPLICABLE TO PARTIALLY OPEN / ENCLOSED OR OPEN BUILDINGS.
7. THESE DRAWINGS ARE NOT DESIGNED FOR SLEEPING QUARTERS.



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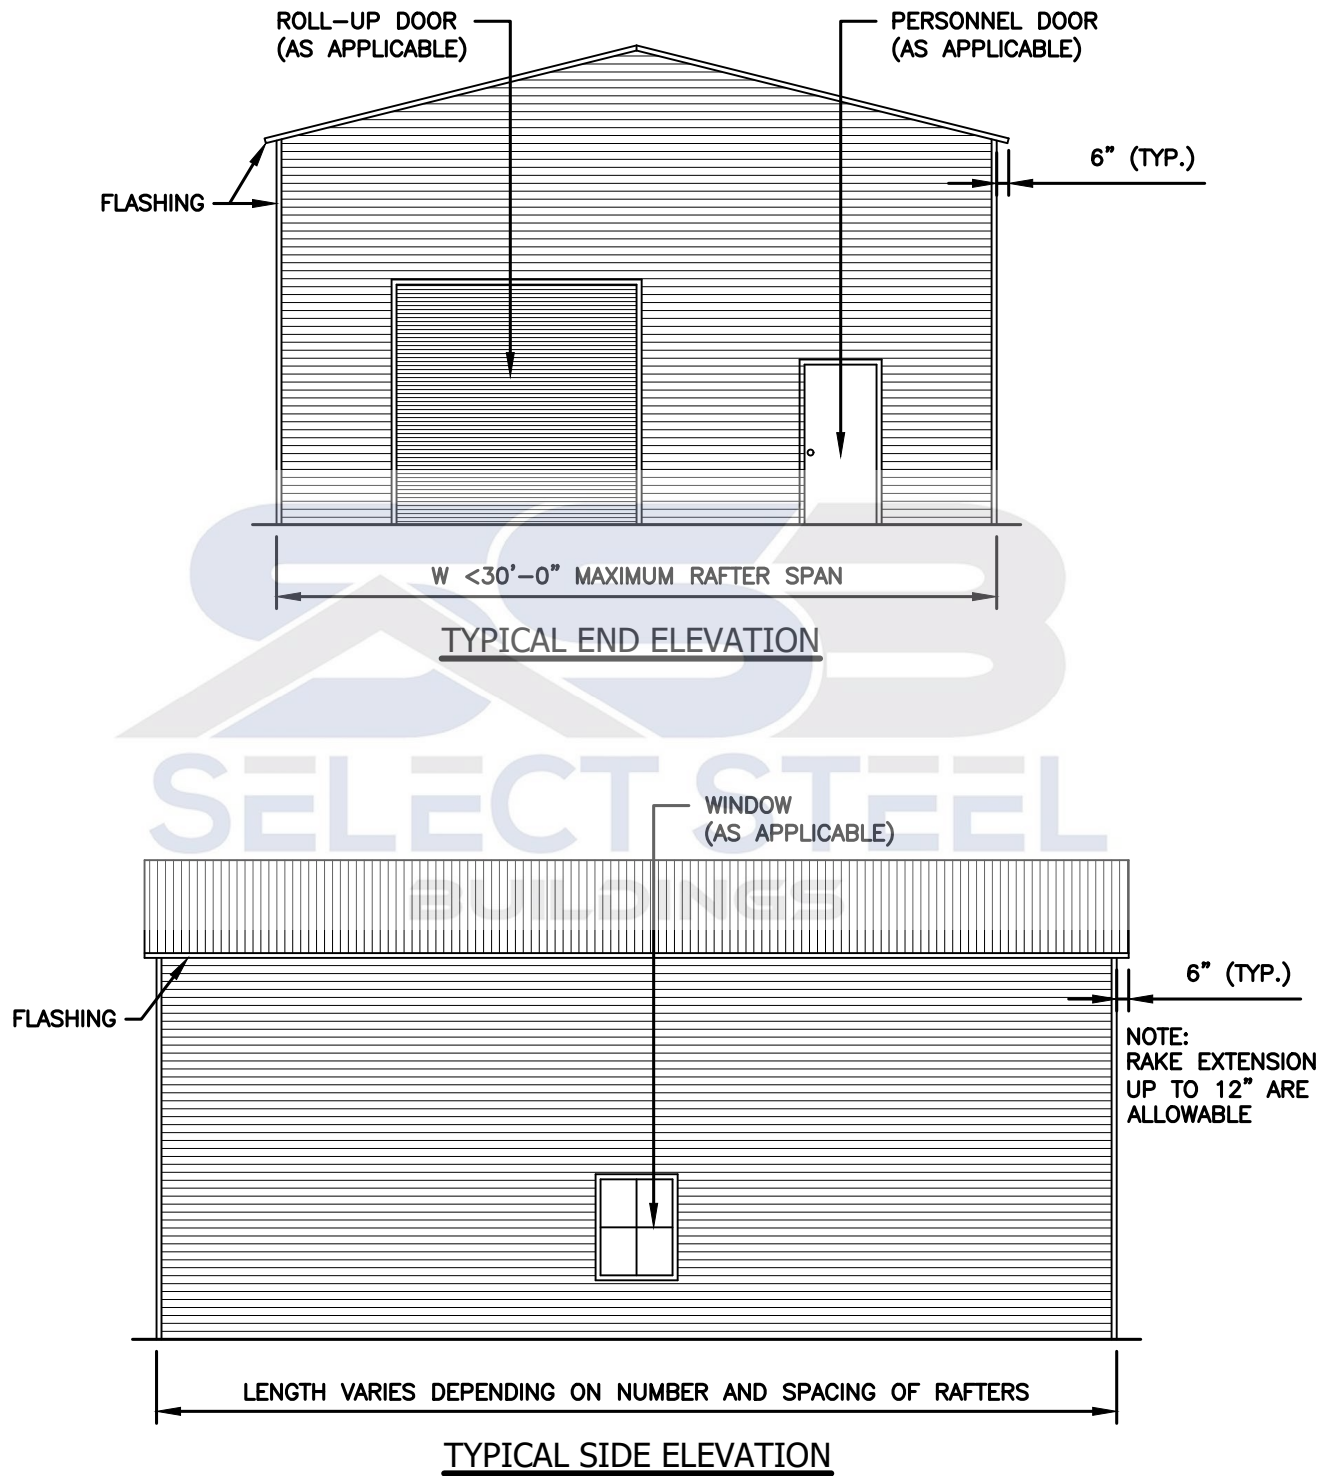
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 S3

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BOX EVE FRAME RAFTER STURCTURE



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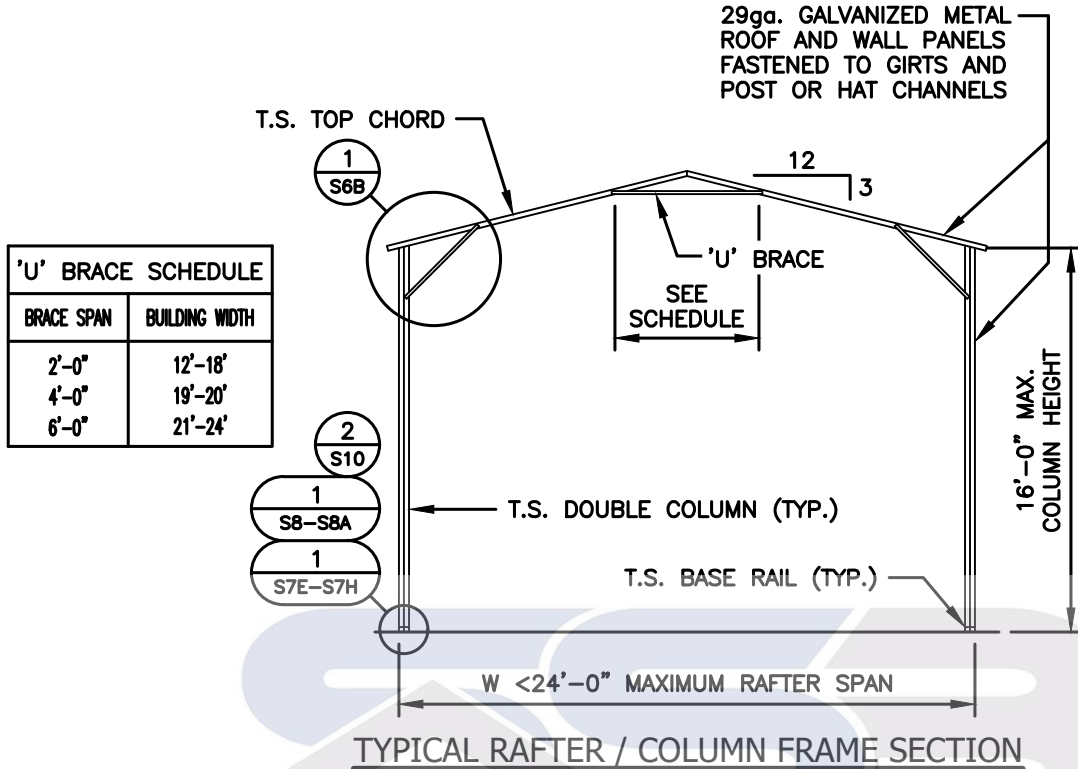
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S4


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(<24' WIDE / <16' HIGH) BOX EVE RAFTER END WALL SECTIONS



NOTE:
H.S.S. 2-1/2"x2-1/2"x14ga. OR 2-1/4"x2-1/4"x12ga.
MATERIAL MAY BE USED FOR TRUSS METAL.

**29ga. GALVANIZED METAL
ROOF AND WALL PANELS
FASTENED TO GIRTS AND
POST OR HAT CHANNELS**

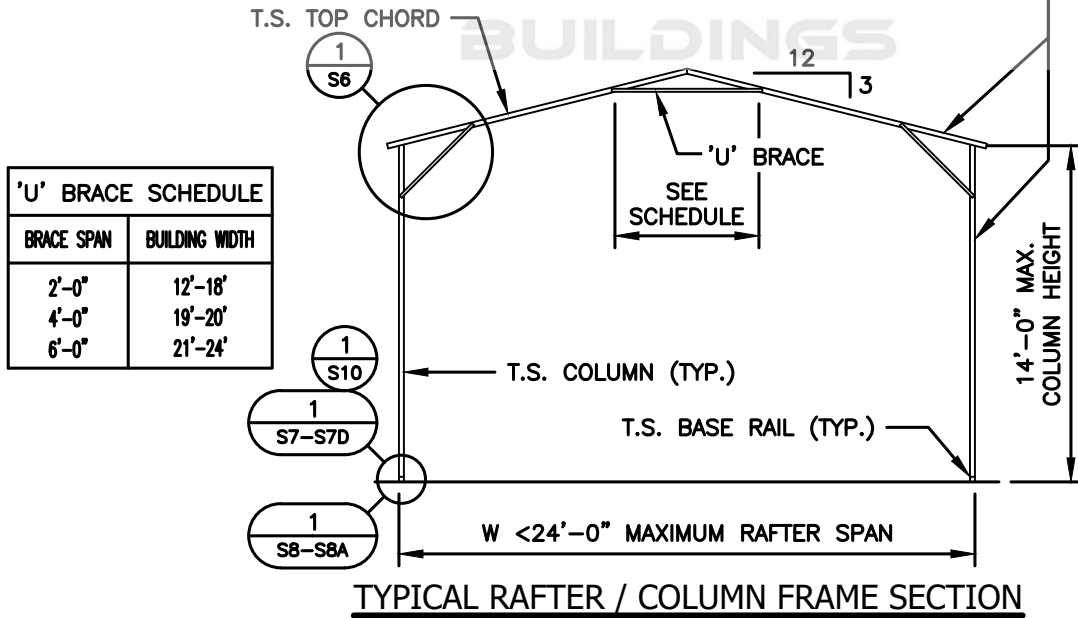

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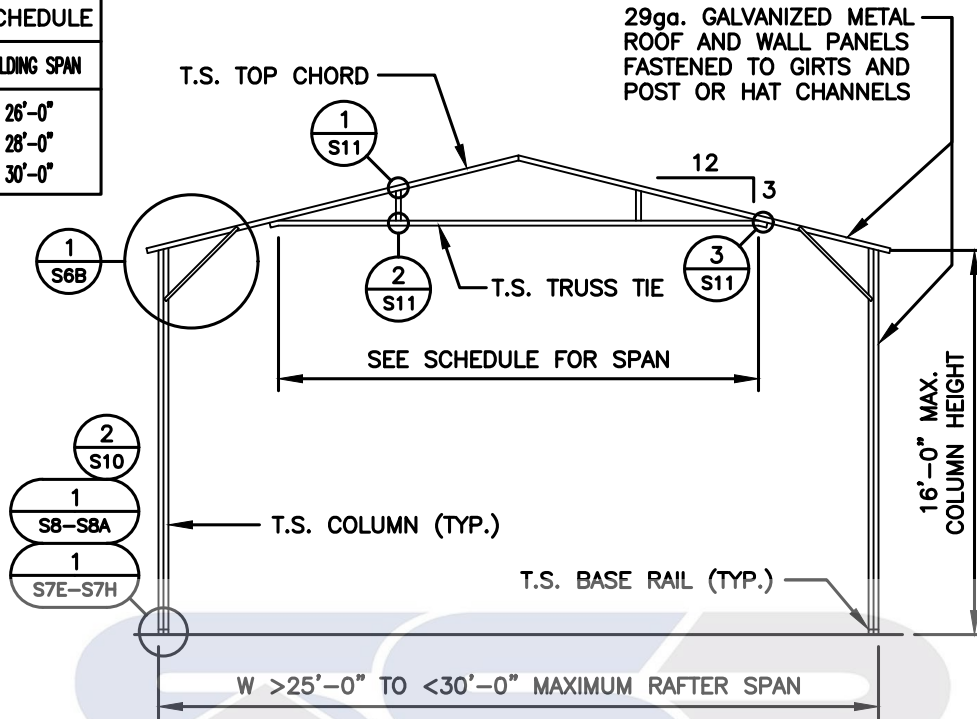
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S5

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(>25' - <30' WIDE / <16' HIGH) BOX EVE RAFTER END WALL SECTIONS


TRUSS TIE SCHEDULE	
BRACE SPAN	BUILDING SPAN
16'-0"	26'-0"
18'-0"	28'-0"
20'-0"	30'-0"



TYPICAL RAFTER / COLUMN FRAME SECTION

TRUSS TIE SCHEDULE	
BRACE SPAN	BUILDING SPAN
16'-0"	26'-0"
18'-0"	28'-0"
20'-0"	30'-0"

NOTE:
H.S.S. 2-1/2"x2-1/2"x14ga. OR 2-1/4"x2-1/4"x12ga.
MATERIAL MAY BE USED FOR TRUSS METAL.

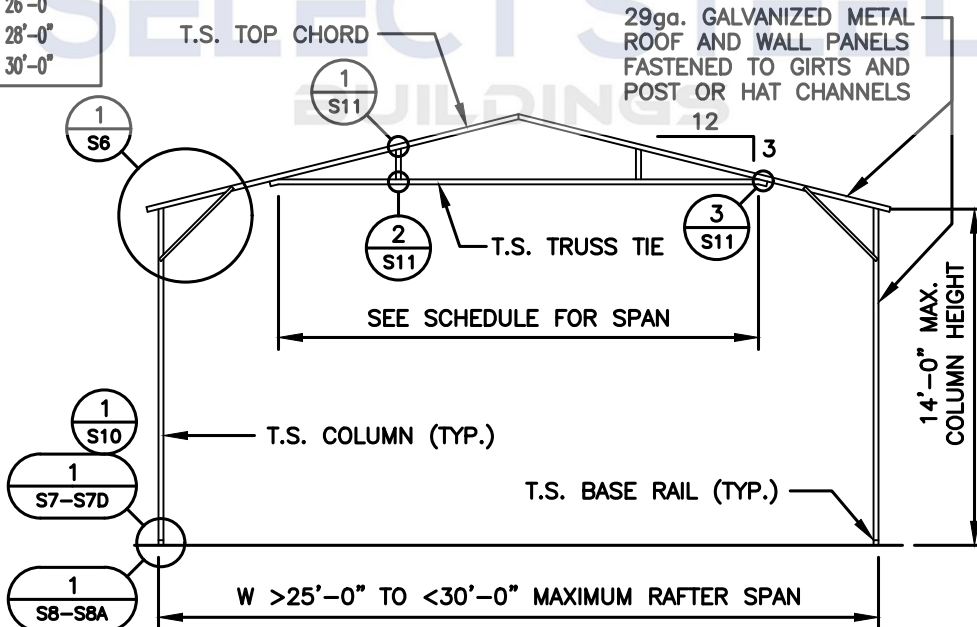

TYPICAL RAFTER / COLUMN FRAME SECTION



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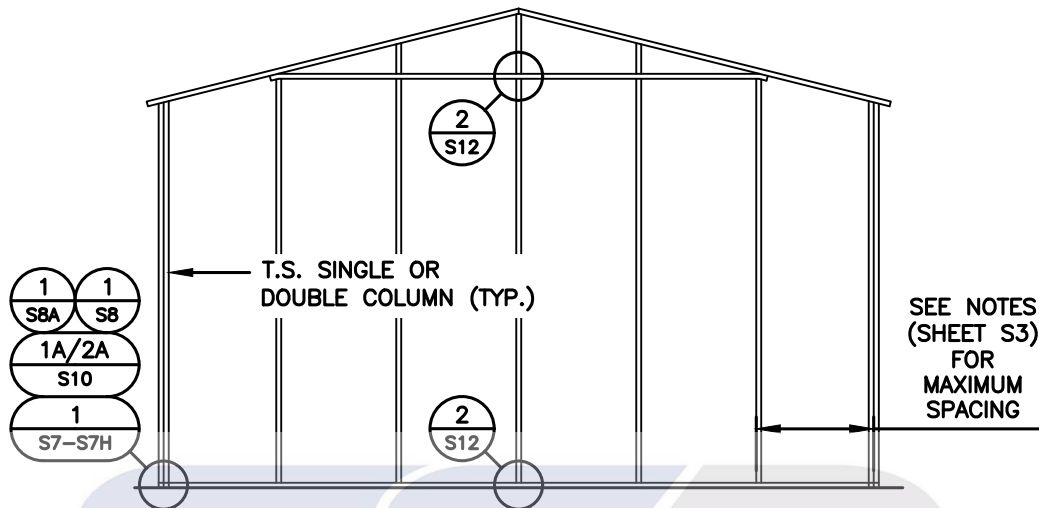
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S5A

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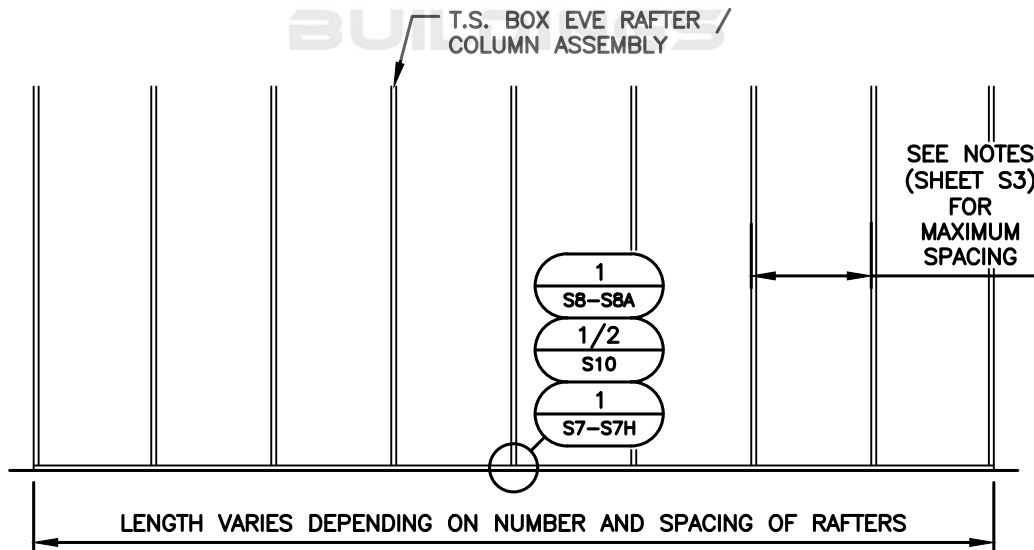
(TYPICAL) SIDE FRAME SECTION



TYPICAL BOX EVE RAFTER / END WALL COLUMN FRAME SECTION

NOTE:

H.S.S. 2-1/2"x2-1/2"x14ga. OR 2-1/4"x2-1/4"x12ga.
MATERIAL MAY BE USED FOR TRUSS METAL.



TYPICAL RAFTER / COLUMN SIDE FRAME SECTION <16'-0"



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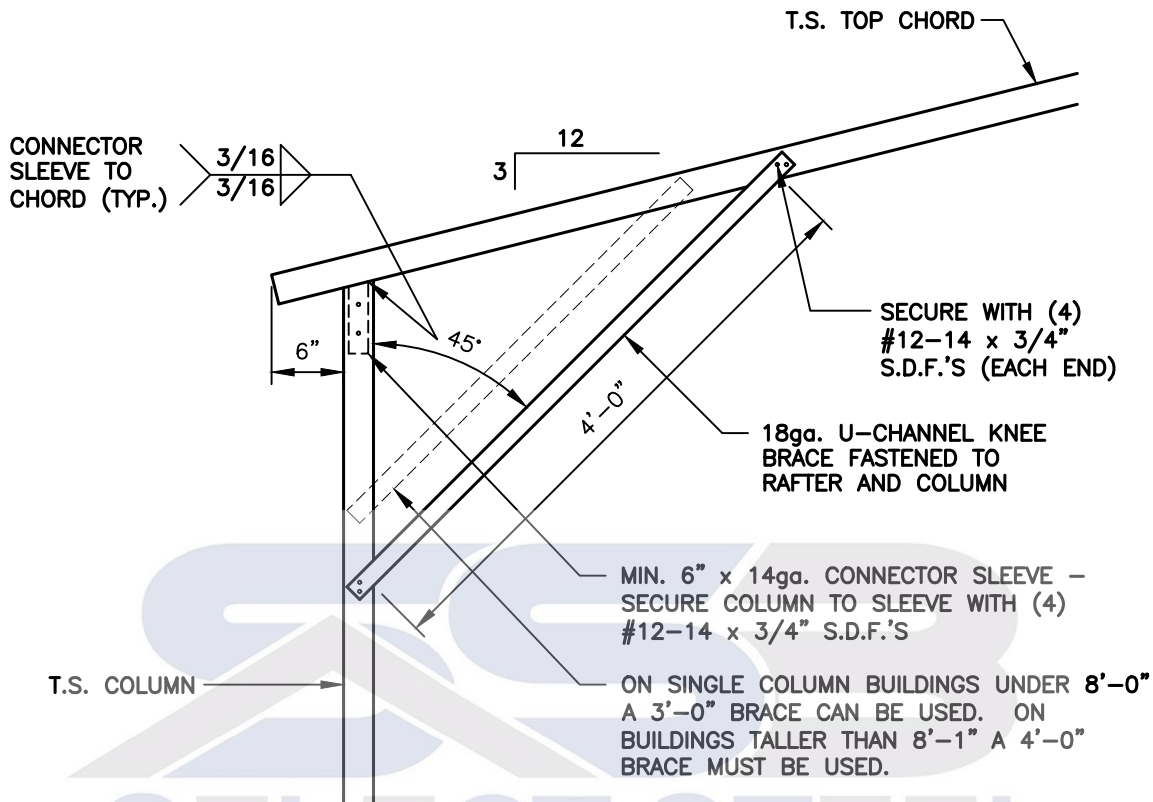
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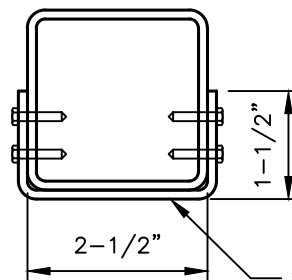
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BOX EAVE / CORNER POST CONNECTION DETAIL FOR HEIGHTS <14'-0"

1
S6

SCALE: 3/4" = 1'-0"



BRACE
SECTION

18ga. U-CHANNEL BRACE FASTENED TO THE COLUMN AND CHORD, WITH #12-14 x 3/4" S.D.F.'S AT EACH END AS SHOWN IN ELEVATION.



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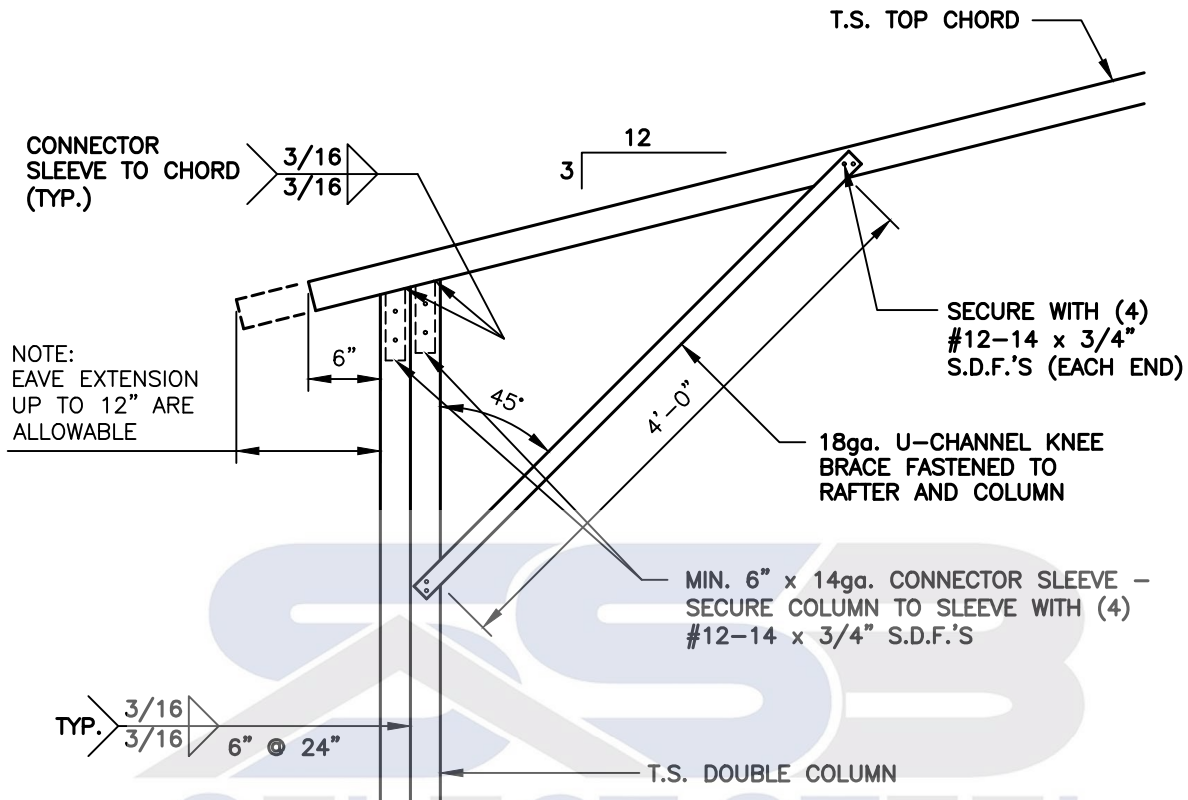
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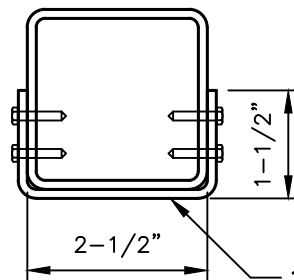
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BOX EAVE / CORNER POST CONNECTION DETAIL FOR HEIGHTS >14'-1" TO <16'-0"

1
S6A

SCALE: 3/4" = 1'-0"



BRACE
SECTION

18ga. U-CHANNEL BRACE FASTENED TO THE COLUMN AND CHORD, WITH #12-14 x 3/4" S.D.F.'S AT EACH END AS SHOWN IN ELEVATION.



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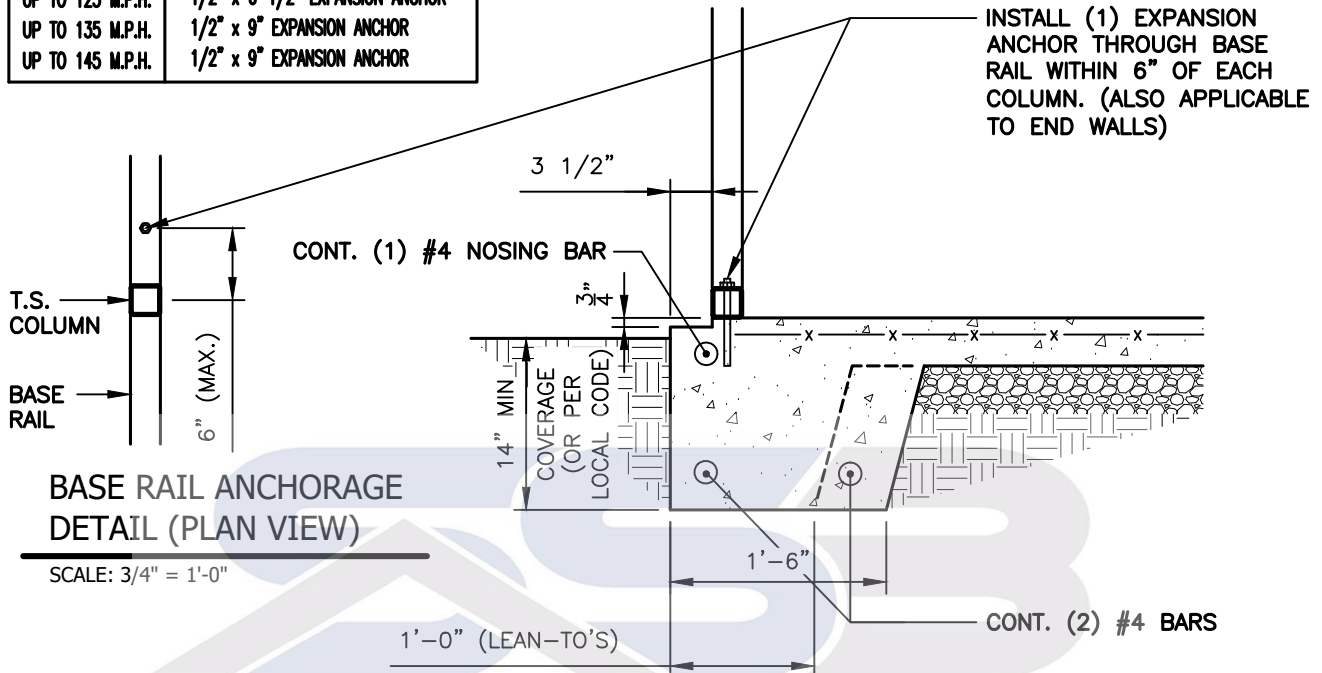
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S6A

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CONCRETE BASE RAIL ANCHORAGE

ANCHORAGE BOLT SCHEDULE	
WIND SPEED	BOLT SIZE
UP TO 115 M.P.H.	1/2" x 6-1/2" EXPANSION ANCHOR
UP TO 125 M.P.H.	1/2" x 6-1/2" EXPANSION ANCHOR
UP TO 135 M.P.H.	1/2" x 9" EXPANSION ANCHOR
UP TO 145 M.P.H.	1/2" x 9" EXPANSION ANCHOR



1
S7

BASE RAIL ANCHORAGE DETAIL

SCALE: 3/4" = 1'-0"

GENERAL NOTES:

ALL CONCRETE MONOLITHIC SLAB DESIGN BASED ON MINIMUM SOIL BEARING CAPACITY OF 2,000 P.S.F.

CONCRETE:

CONCRETE SHALL HAVE A MINIMUM SPECIFIED COMPRESSIVE STRENGTH OF 3,000 P.S.I. AT 28 DAYS.

COVER OVER REINFORCING STEEL:

FOR FOUNDATIONS, MINIMUM CONCRETE COVER OVER REINFORCING BARS SHALL BE PER ACI-318: 3" IN FOUNDATIONS WHERE THE CONCRETE IS CAST AGAINST AND PERMANENTLY IN CONTACT WITH THE EARTH OR EXPOSED TO THE EARTH AND WEATHER AND 1-1/2" ELSEWHERE.

REINFORCING STEEL:

THE TURNDOWN REINFORCING STEEL SHALL BE ASTM A615 GRADE 60. THE SLAB REINFORCEMENT SHALL BE WELDED WIRE FABRIC MEETING ASTM A185 OR FIBERGLASS FIBER REINFORCEMENT.

REINFORCEMENT MAT BE BENT IN THE SHOP OF THE FIELD PROVIDED:

1. REINFORCEMENT IS BENT COLD.
2. THE DIAMETER OF THE BEND, MEASURED ON THE INSIDE OF THE BAR, IS NOT LESS THAN SIX-BAR DIAMETERS.
3. REINFORCEMENT PARTIALLY EMBEDDED IN CONCRETE SHALL NOT BE FIELD BENT.



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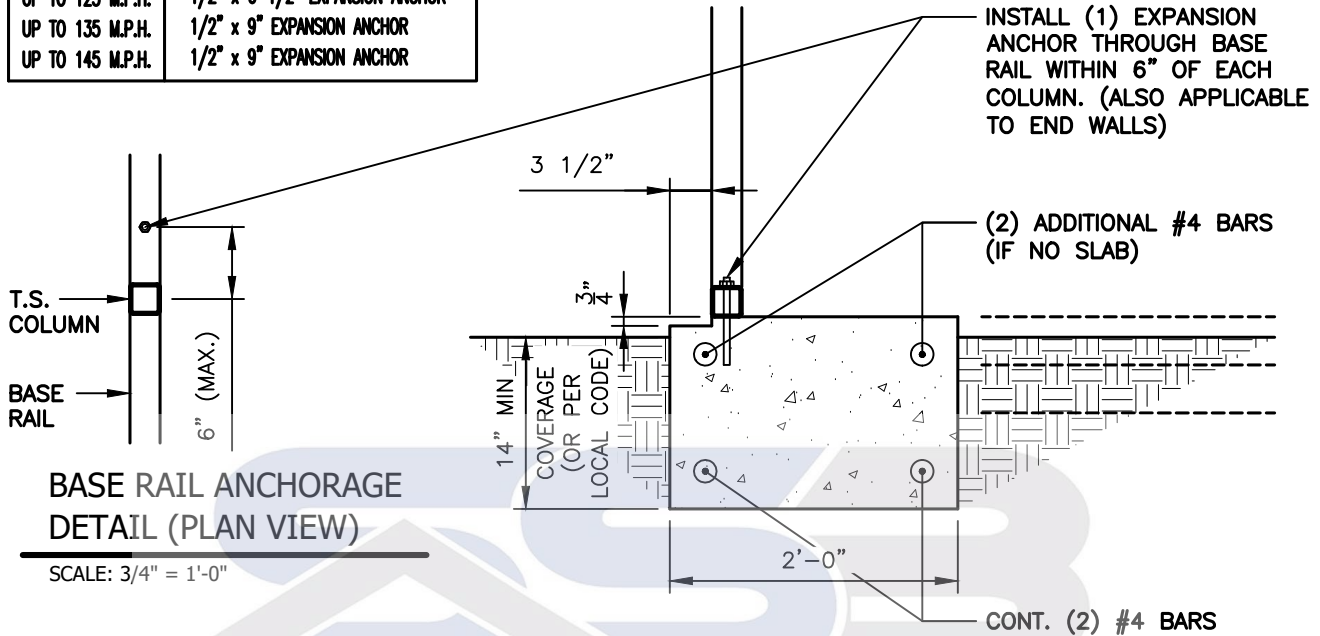
PROJECT NO:
24-511

SHEET NO:
S7

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CONCRETE BASE RAIL ANCHORAGE (NO SLAB)

ANCHORAGE BOLT SCHEDULE	
WIND SPEED	BOLT SIZE
UP TO 115 M.P.H.	1/2" x 6-1/2" EXPANSION ANCHOR
UP TO 125 M.P.H.	1/2" x 6-1/2" EXPANSION ANCHOR
UP TO 135 M.P.H.	1/2" x 9" EXPANSION ANCHOR
UP TO 145 M.P.H.	1/2" x 9" EXPANSION ANCHOR



BASE RAIL ANCHORAGE DETAIL (NO SLAB)

SCALE: 3/4" = 1'-0"

GENERAL NOTES:

ALL CONCRETE MONOLITHIC SLAB DESIGN BASED ON MINIMUM SOIL BEARING CAPACITY OF 2,000 P.S.F.

CONCRETE:

CONCRETE SHALL HAVE A MINIMUM SPECIFIED COMPRESSIVE STRENGTH OF 3,000 P.S.I. AT 28 DAYS.

COVER OVER REINFORCING STEEL:

FOR FOUNDATIONS, MINIMUM CONCRETE COVER OVER REINFORCING BARS SHALL BE PER ACI-318: 3" IN FOUNDATIONS WHERE THE CONCRETE IS CAST AGAINST AND PERMANENTLY IN CONTACT WITH THE EARTH OR EXPOSED TO THE EARTH AND WEATHER AND 1-1/2" ELSEWHERE.

REINFORCING STEEL:

THE TURNDOWN REINFORCING STEEL SHALL BE ASTM A615 GRADE 60. THE SLAB REINFORCEMENT SHALL BE WELDED WIRE FABRIC MEETING ASTM A185 OR FIBERGLASS FIBER REINFORCEMENT.

REINFORCEMENT MAT BE BENT IN THE SHOP OF THE FIELD PROVIDED:

1. REINFORCEMENT IS BENT COLD.
2. THE DIAMETER OF THE BEND, MEASURED ON THE INSIDE OF THE BAR, IS NOT LESS THAN SIX-BAR DIAMETERS.
3. REINFORCEMENT PARTIALLY EMBEDDED IN CONCRETE SHALL NOT BE FIELD BENT.



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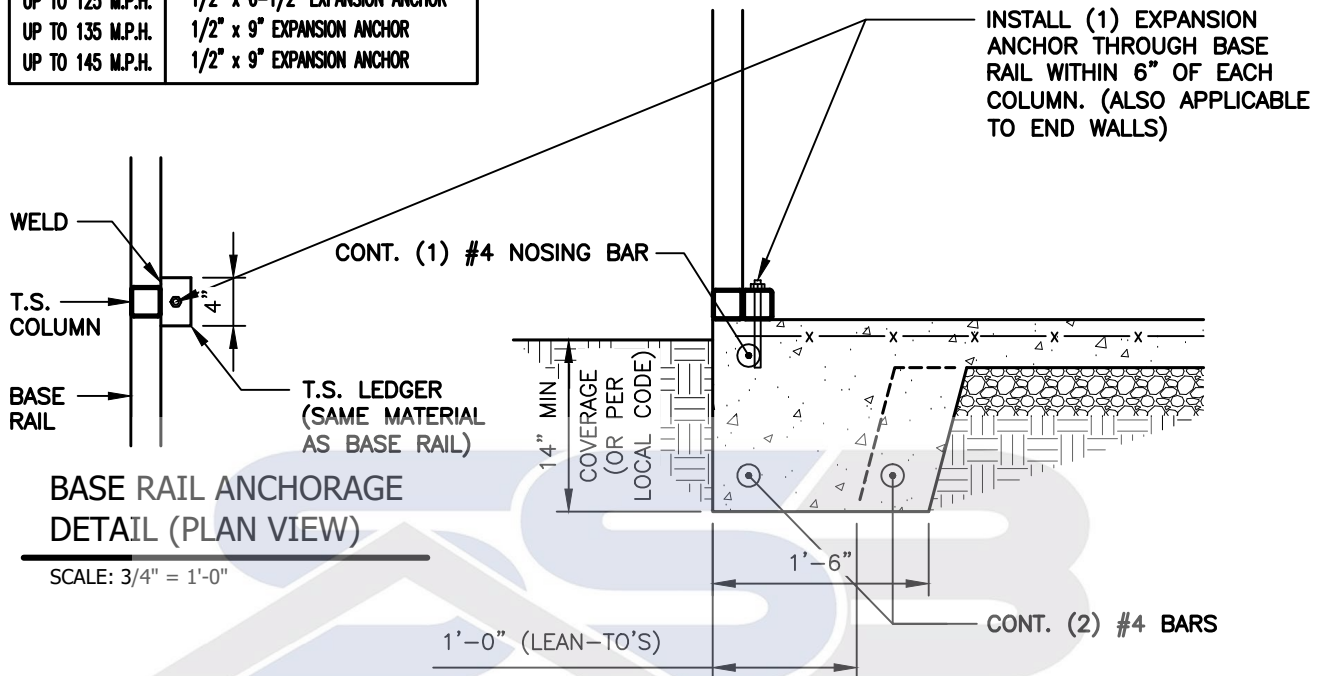
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S7A

NOTE: THESE DRAWINGS ARE VALID FOR (1) CALENDER YEAR AFTER THE ISSUE DATE LISTED ON THIS SHEET.

CONCRETE BASE RAIL ANCHORAGE (NO LEDGE)

ANCHORAGE BOLT SCHEDULE	
WIND SPEED	BOLT SIZE
UP TO 115 M.P.H.	1/2" x 6-1/2" EXPANSION ANCHOR
UP TO 125 M.P.H.	1/2" x 6-1/2" EXPANSION ANCHOR
UP TO 135 M.P.H.	1/2" x 9" EXPANSION ANCHOR
UP TO 145 M.P.H.	1/2" x 9" EXPANSION ANCHOR



1
BASE RAIL ANCHORAGE DETAIL
 S7B SCALE: 3/4" = 1'-0"

GENERAL NOTES:

ALL CONCRETE MONOLITHIC SLAB DESIGN BASED ON MINIMUM SOIL BEARING CAPACITY OF 2,000 P.S.F.

CONCRETE:

CONCRETE SHALL HAVE A MINIMUM SPECIFIED COMPRESSIVE STRENGTH OF 3,000 P.S.I. AT 28 DAYS.

COVER OVER REINFORCING STEEL:

FOR FOUNDATIONS, MINIMUM CONCRETE COVER OVER REINFORCING BARS SHALL BE PER ACI-318: 3" IN FOUNDATIONS WHERE THE CONCRETE IS CAST AGAINST AND PERMANENTLY IN CONTACT WITH THE EARTH OR EXPOSED TO THE EARTH AND WEATHER AND 1-1/2" ELSEWHERE.

REINFORCING STEEL:

THE TURNDOWN REINFORCING STEEL SHALL BE ASTM A615 GRADE 60. THE SLAB REINFORCEMENT SHALL BE WELDED WIRE FABRIC MEETING ASTM A185 OR FIBERGLASS FIBER REINFORCEMENT.

REINFORCEMENT MAT BE BENT IN THE SHOP OF THE FIELD PROVIDED:

1. REINFORCEMENT IS BENT COLD.
2. THE DIAMETER OF THE BEND, MEASURED ON THE INSIDE OF THE BAR, IS NOT LESS THAN SIX-BAR DIAMETERS.
3. REINFORCEMENT PARTIALLY EMBEDDED IN CONCRETE SHALL NOT BE FIELD BENT.



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Telephone: (336) 399-6277

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**SELECT STEEL
BUILDINGS, INC.**

2745 STATESVILLE RD.
WILKESBORO, NORTH CAROLINA 28697
TELE: 366-973-0721

DRAWN BY:
BKS

PROJECT NO:
24-511


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NOTE: THESE DRAWINGS ARE VALID FOR (1) CALENDER YEAR AFTER THE ISSUE DATE LISTED ON THIS SHEET.

CONCRETE BASE RAIL ANCHORAGE (NO LEDGE / NO SLAB)

ANCHORAGE BOLT SCHEDULE	
WIND SPEED	BOLT SIZE
UP TO 115 M.P.H.	1/2" x 6-1/2" EXPANSION ANCHOR
UP TO 125 M.P.H.	1/2" x 6-1/2" EXPANSION ANCHOR
UP TO 135 M.P.H.	1/2" x 9" EXPANSION ANCHOR
UP TO 145 M.P.H.	1/2" x 9" EXPANSION ANCHOR



1
BASE RAIL ANCHORAGE DETAIL (NO SLAB)
 SCALE: 3/4" = 1'-0"

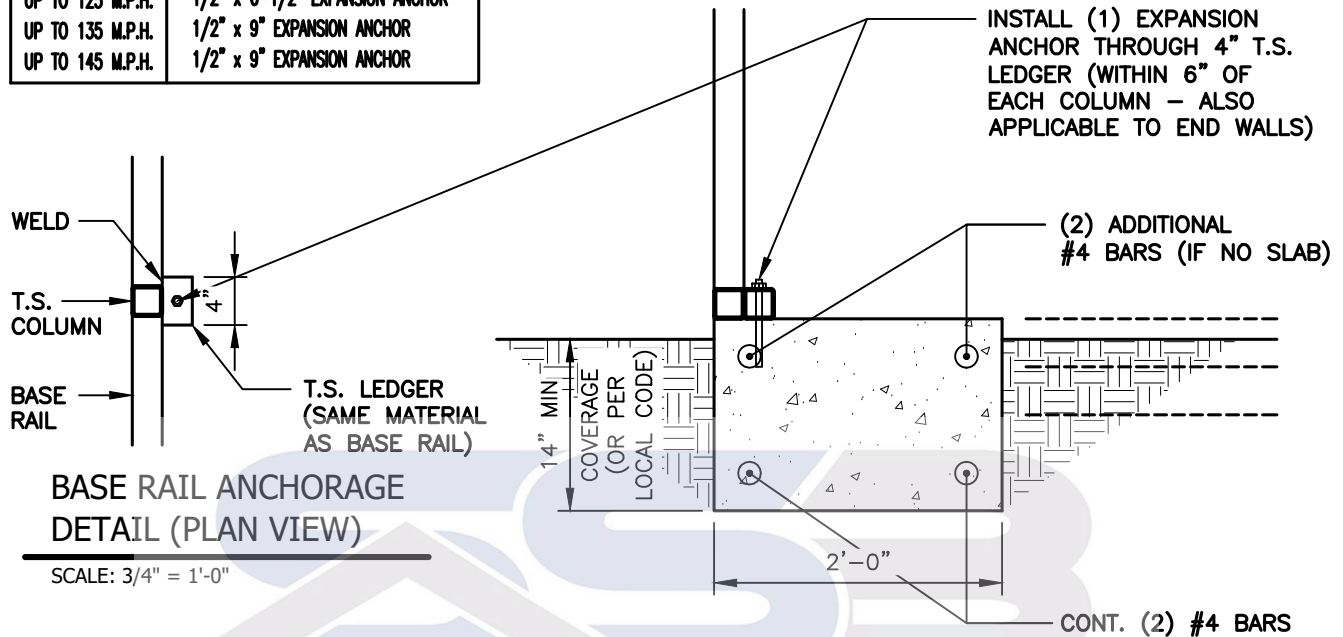GENERAL NOTES:

ALL CONCRETE MONOLITHIC SLAB DESIGN BASED ON MINIMUM SOIL BEARING CAPACITY OF 2,000 P.S.F.

CONCRETE:

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3. REINFORCEMENT PARTIALLY EMBEDDED IN CONCRETE SHALL NOT BE FIELD BENT.



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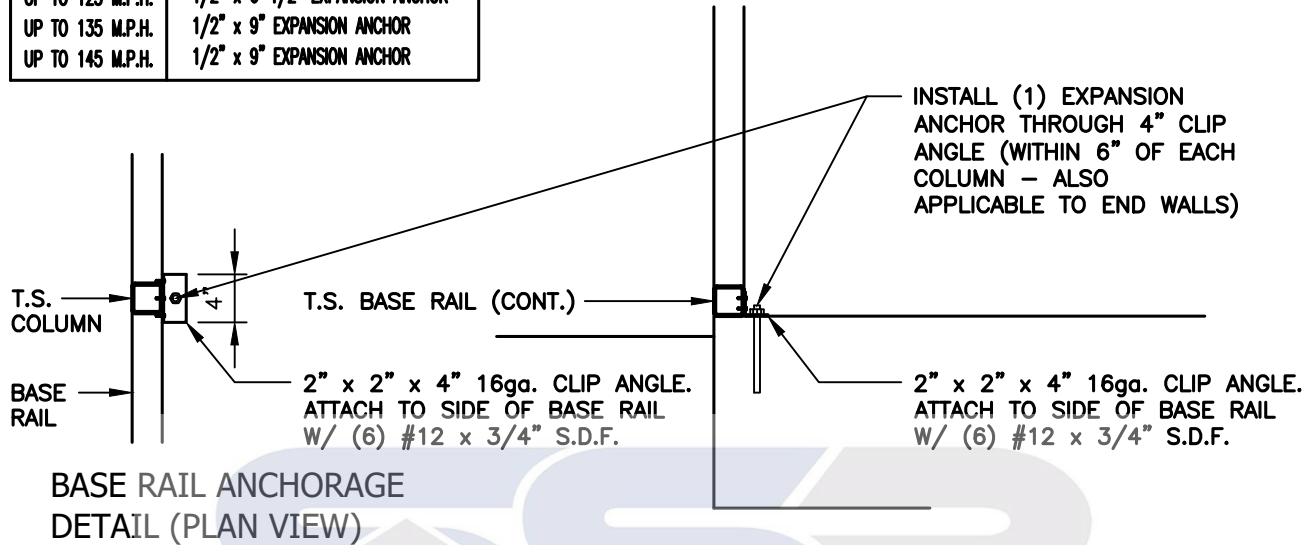
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CONCRETE BASE RAIL ANCHORAGE (CLIP ANGLE ATTACHMENT OPTION)

ANCHORAGE BOLT SCHEDULE	
WIND SPEED	BOLT SIZE
UP TO 115 M.P.H.	1/2" x 6-1/2" EXPANSION ANCHOR
UP TO 125 M.P.H.	1/2" x 6-1/2" EXPANSION ANCHOR
UP TO 135 M.P.H.	1/2" x 9" EXPANSION ANCHOR
UP TO 145 M.P.H.	1/2" x 9" EXPANSION ANCHOR



SCALE: 3/4" = 1'-0"

BASE RAIL ANCHORAGE DETAIL (CLIP ANGLE ATTACHMENT OPTION)

1
S7D

SCALE: 3/4" = 1'-0"



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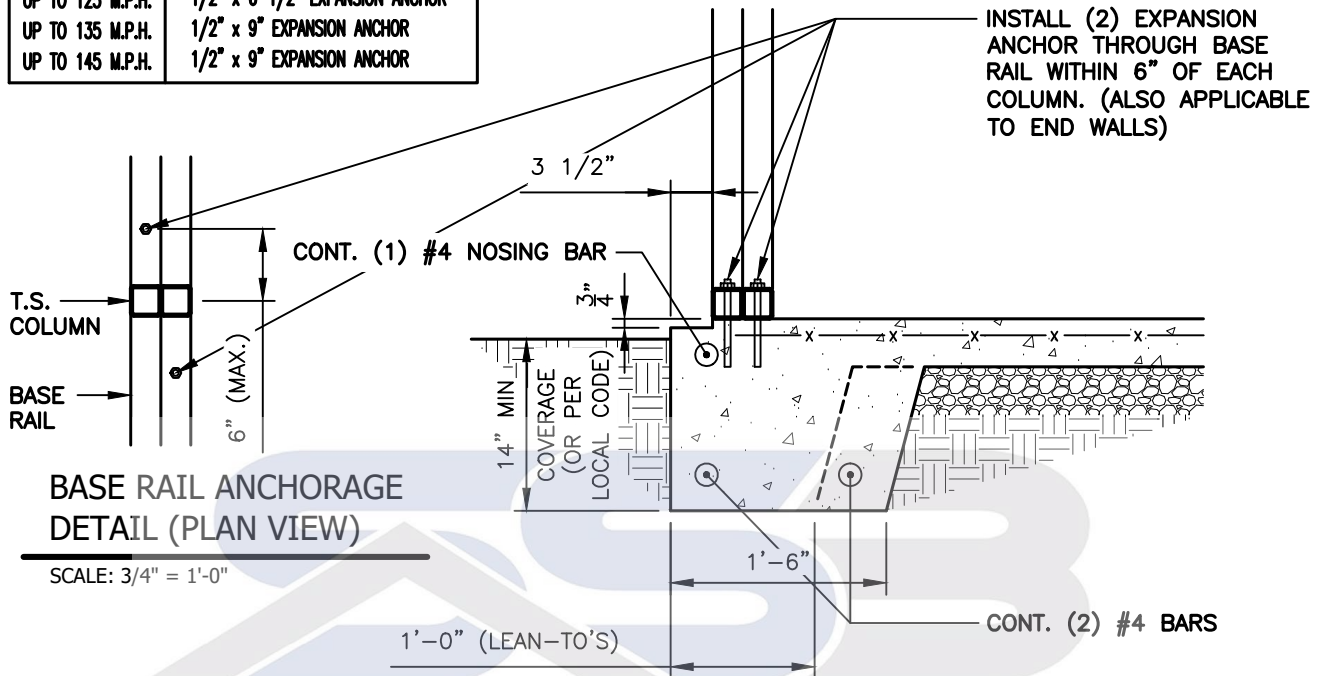
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CONCRETE BASE RAIL ANCHORAGE

ANCHORAGE BOLT SCHEDULE	
WIND SPEED	BOLT SIZE
UP TO 115 M.P.H.	1/2" x 6-1/2" EXPANSION ANCHOR
UP TO 125 M.P.H.	1/2" x 6-1/2" EXPANSION ANCHOR
UP TO 135 M.P.H.	1/2" x 9" EXPANSION ANCHOR
UP TO 145 M.P.H.	1/2" x 9" EXPANSION ANCHOR



**BASE RAIL ANCHORAGE
DETAIL (PLAN VIEW)**

SCALE: 3/4" = 1'-0"



BASE RAIL ANCHORAGE DETAIL

SCALE: 3/4" = 1'-0"

GENERAL NOTES:

ALL CONCRETE MONOLITHIC SLAB DESIGN BASED ON MINIMUM SOIL BEARING CAPACITY OF 2,000 P.S.F.

CONCRETE:

CONCRETE SHALL HAVE A MINIMUM SPECIFIED COMPRESSIVE STRENGTH OF 3,000 P.S.I. AT 28 DAYS.

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REINFORCEMENT MAT BE BENT IN THE SHOP OF THE FIELD PROVIDED:

1. REINFORCEMENT IS BENT COLD.
2. THE DIAMETER OF THE BEND, MEASURED ON THE INSIDE OF THE BAR, IS NOT LESS THAN SIX-BAR DIAMETERS.
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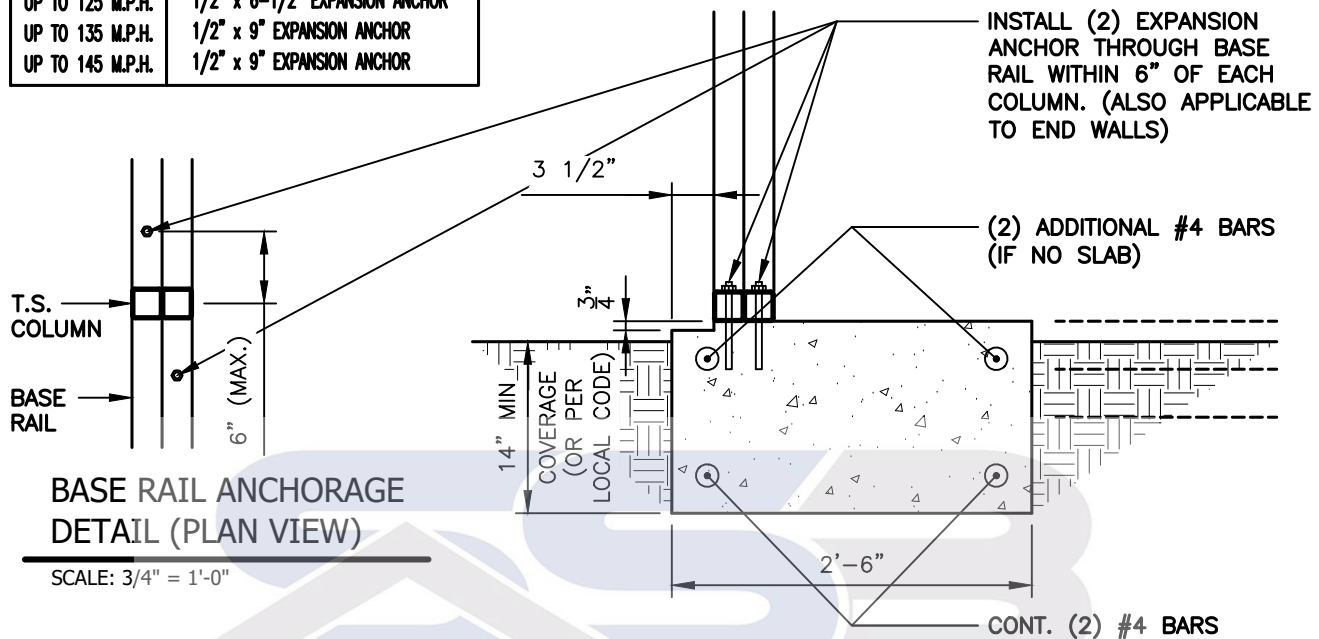
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CONCRETE BASE RAIL ANCHORAGE (NO SLAB)

ANCHORAGE BOLT SCHEDULE	
WIND SPEED	BOLT SIZE
UP TO 115 M.P.H.	1/2" x 6-1/2" EXPANSION ANCHOR
UP TO 125 M.P.H.	1/2" x 6-1/2" EXPANSION ANCHOR
UP TO 135 M.P.H.	1/2" x 9" EXPANSION ANCHOR
UP TO 145 M.P.H.	1/2" x 9" EXPANSION ANCHOR



**BASE RAIL ANCHORAGE
DETAIL (PLAN VIEW)**

SCALE: 3/4" = 1'-0"



BASE RAIL ANCHORAGE DETAIL (NO SLAB)

SCALE: 3/4" = 1'-0"

GENERAL NOTES:

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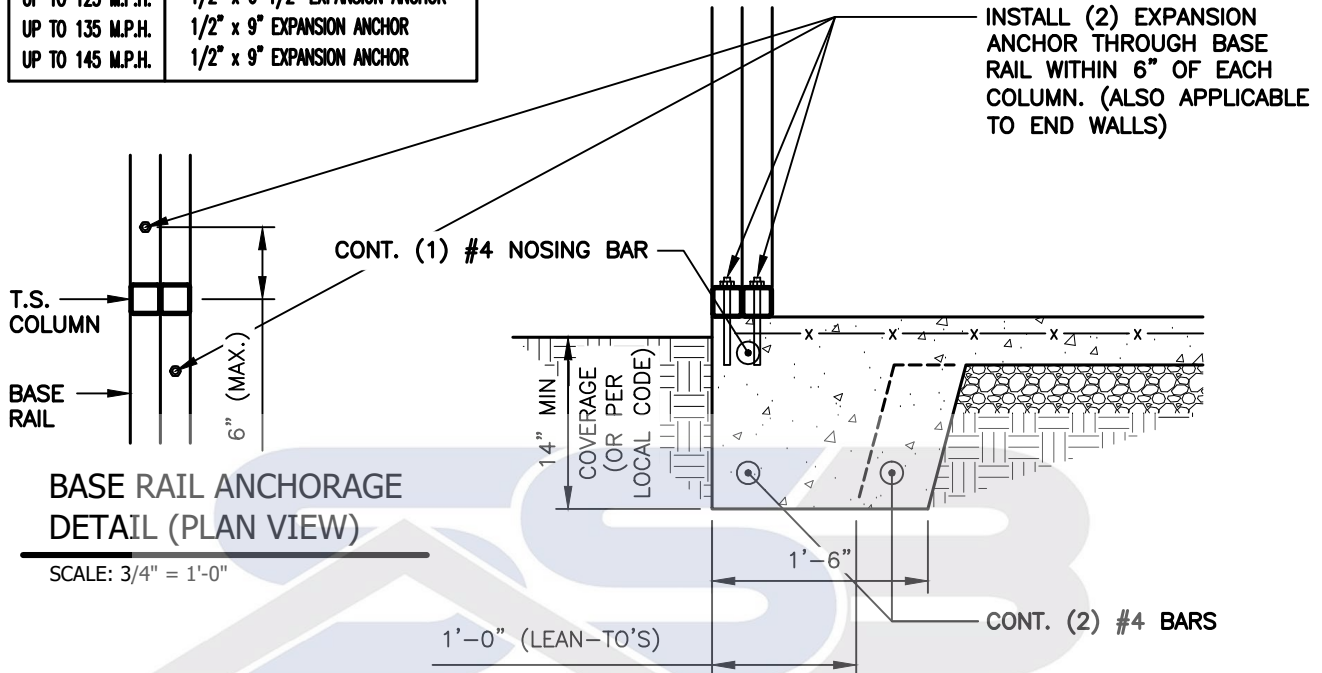
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CONCRETE BASE RAIL ANCHORAGE (NO LEDGE)

ANCHORAGE BOLT SCHEDULE	
WIND SPEED	BOLT SIZE
UP TO 115 M.P.H.	1/2" x 6-1/2" EXPANSION ANCHOR
UP TO 125 M.P.H.	1/2" x 6-1/2" EXPANSION ANCHOR
UP TO 135 M.P.H.	1/2" x 9" EXPANSION ANCHOR
UP TO 145 M.P.H.	1/2" x 9" EXPANSION ANCHOR



**BASE RAIL ANCHORAGE
DETAIL (PLAN VIEW)**

SCALE: 3/4" = 1'-0"



BASE RAIL ANCHORAGE DETAIL

SCALE: 3/4" = 1'-0"

GENERAL NOTES:

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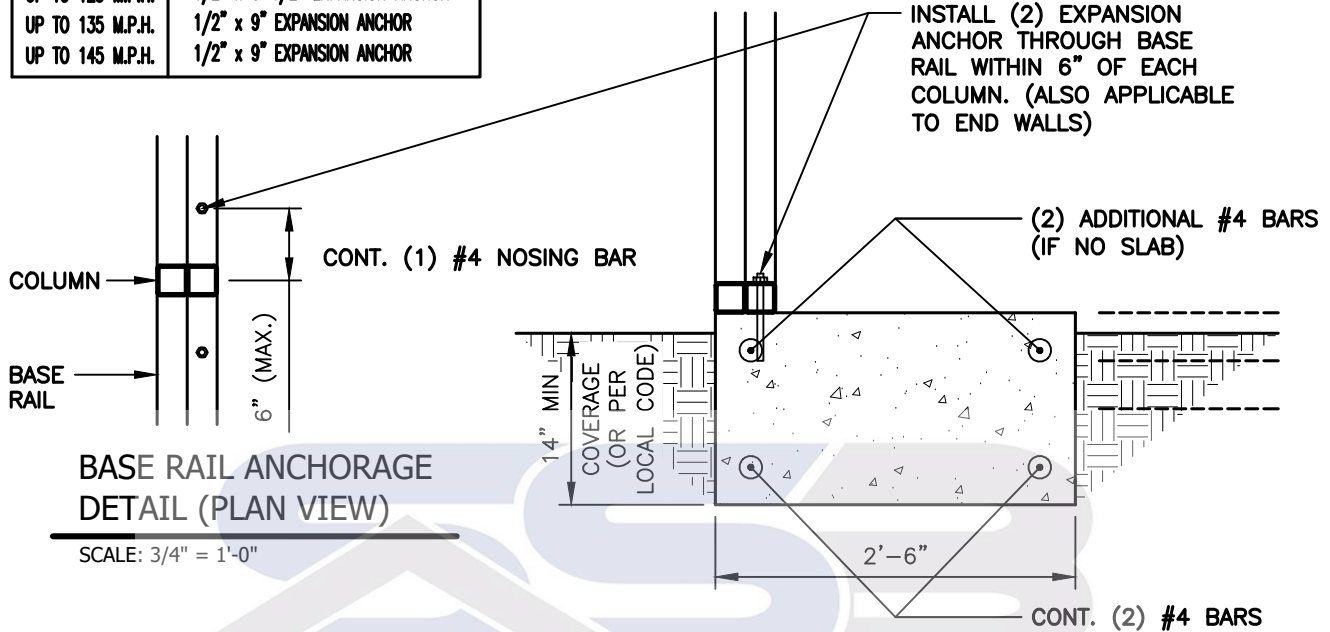
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CONCRETE BASE RAIL ANCHORAGE (NO LEDGE / NO SLAB)

ANCHORAGE BOLT SCHEDULE	
WIND SPEED	BOLT SIZE
UP TO 115 M.P.H.	1/2" x 6-1/2" EXPANSION ANCHOR
UP TO 125 M.P.H.	1/2" x 6-1/2" EXPANSION ANCHOR
UP TO 135 M.P.H.	1/2" x 9" EXPANSION ANCHOR
UP TO 145 M.P.H.	1/2" x 9" EXPANSION ANCHOR



1
S7H

BASE RAIL ANCHORAGE DETAIL

SCALE: 3/4" = 1'-0"

GENERAL NOTES:

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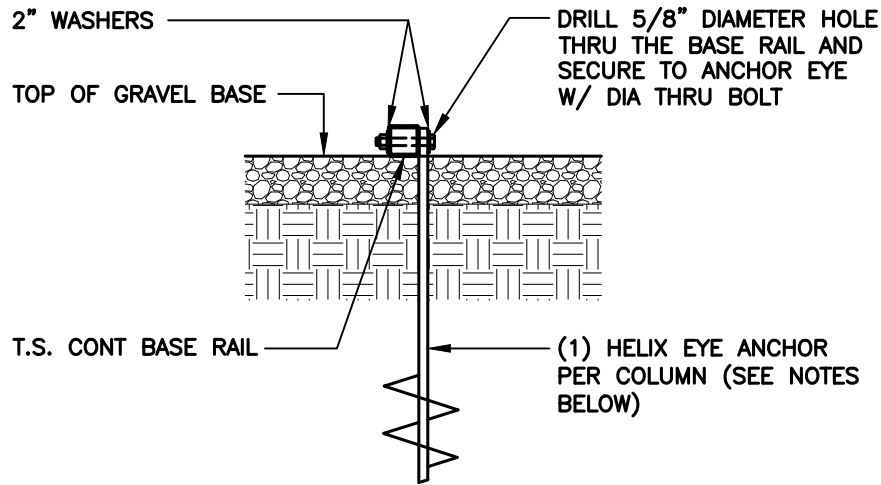
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SOIL NAIL BASE RAIL ANCHORAGE



1
S8

BASE RAIL ANCHORAGE DETAIL

SCALE: 3/4" = 1'-0"

HELIX EMBEDMENT INFORMATION:

FOR VERY DENSE OR CEMENTED SANDS, COARSE GRAVEL, COBBLES, CALICHE, PRELOADED SILT.S. AND CLAYS, USE MIN. (2) 4" HELICES WITH MINIMUM 30" EMBEDMENT OR SINGLE 6" HELIX WITH 50" EMBEDMENT - ONE EACH END BASE RAIL AND 20'-0"oc MAX. WITH #4 REBAR AT 5'-0"oc BETWEEN.

FOR CORAL, USE MIN (2) 4" HELICES WITH MINIMUM 30" EMBEDMENT OR SINGLE 6" HELIX WITH 50" EMBEDMENT - ONE EACH END BASE RAIL AND 20'-0"oc MAX. WITH #4 REBAR AT 5'-0"oc BETWEEN.

FOR MED DENSE COARSE SANDS, SANDY GRAVEL, VERY STIFF SILT.S., AND CLAYS, USE MIN (2) 4" HELICES WITH MINIMUM 30" EMBEDMENT OR SINGLE 6" HELIX WITH 50" EMBEDMENT - ONE EACH END BASE RAIL AND 20'-0"oc MAX. WITH #4 REBAR AT 5'-0"oc BETWEEN.

FOR LOOSE TO MEDIUM DENSE SANDS, FIRM TO STIFF CLAYS AND SILT.S., USE MIN (2) 6" HELICES WITH MINIMUM 50" EMBEDMENT - ONE EACH END BASE RAIL AND 20'-0"oc MAX. WITH #4 REBAR AT 5'-0"oc BETWEEN.

FOR VERY LOOSE TO MEDIUM DENSE SANDS, FIRM TO STIFFER CLAYS AND SILT.S. AND ALLUVIAL FILL, USE MIN (2) 8" HELICES WITH MINIMUM 60" EMBEDMENT - ONE EACH END BASE RAIL AND 20'-0"oc MAX. WITH #4 REBAR AT 5'-0"oc BETWEEN.

NOTE:

IN ALL CASES, IF FROST DEPTH EXCEEDS STATED DEPTH,
ANCHOR SHOULD EXTEND A MIN. OF 12" BELOW FROST LINE.



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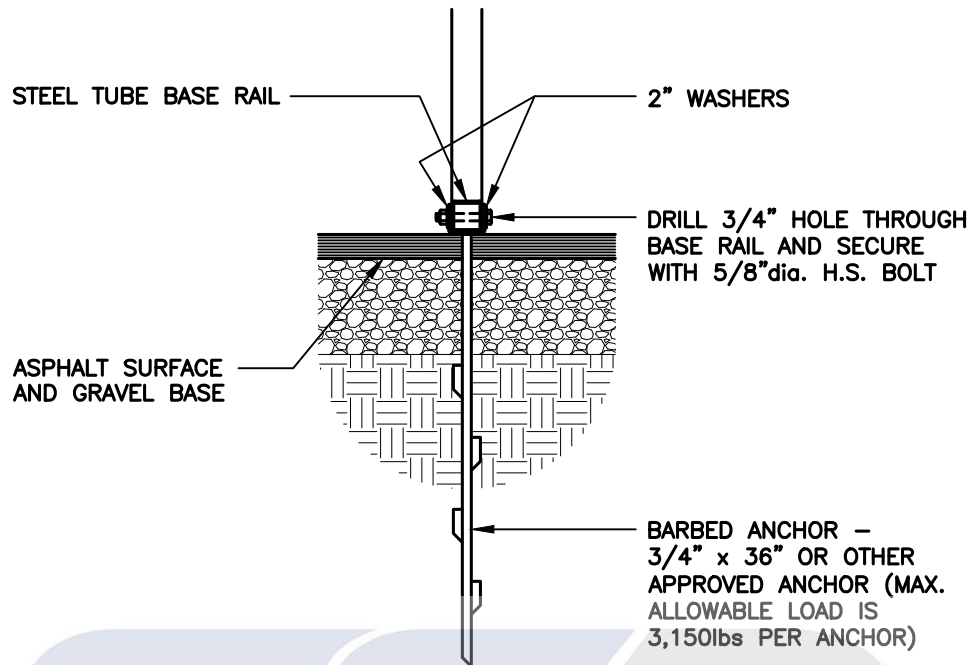
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ASPHALT / BASE RAIL ANCHORAGE DETAIL

SCALE: 3/4" = 1'-0"

SELECT STEEL
BUILDINGS

NOTE:

IN ALL CASES, IF FROST DEPTH EXCEEDS STATED DEPTH,
ANCHOR SHOULD EXTEND A MIN. OF 12" BELOW FROST LINE.



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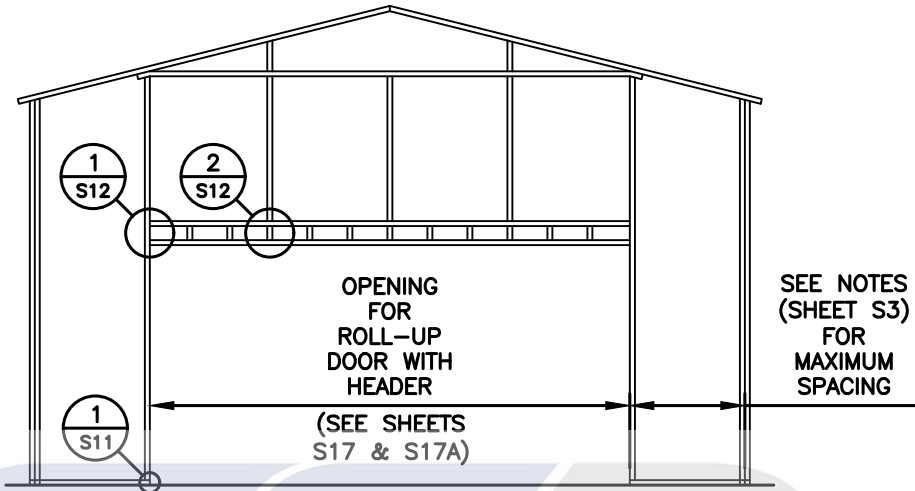
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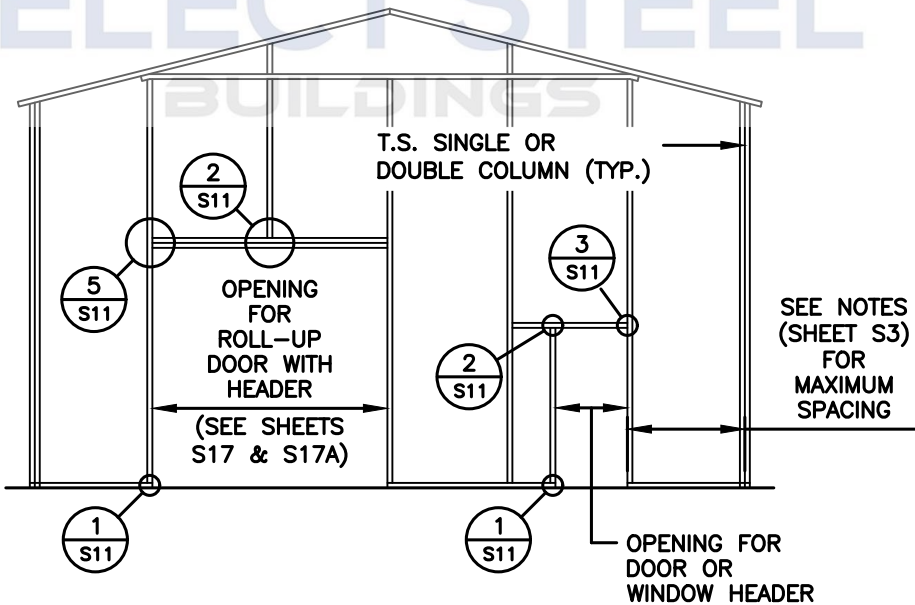
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BOX EVE RAFTER / END WALL OPENINGS



TYPICAL BOX EVE RAFTER END WALL OPENINGS FRAMING SECTION

NOTE:
ROLL UP DOORS SHALL HAVE ONE JAMB
EACH SIDE + ONE FRAME COLUMN BETWEEN
OR SITE SPECIFIC SHALL BE REQ'D.



TYPICAL BOX EVE RAFTER END WALL OPENINGS FRAMING SECTION



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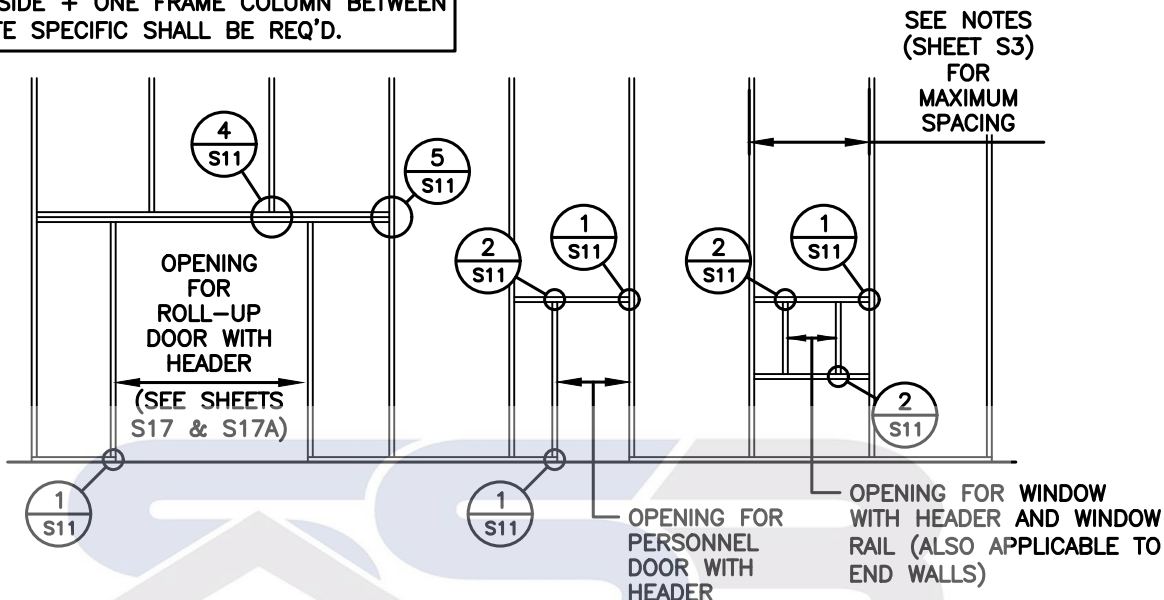
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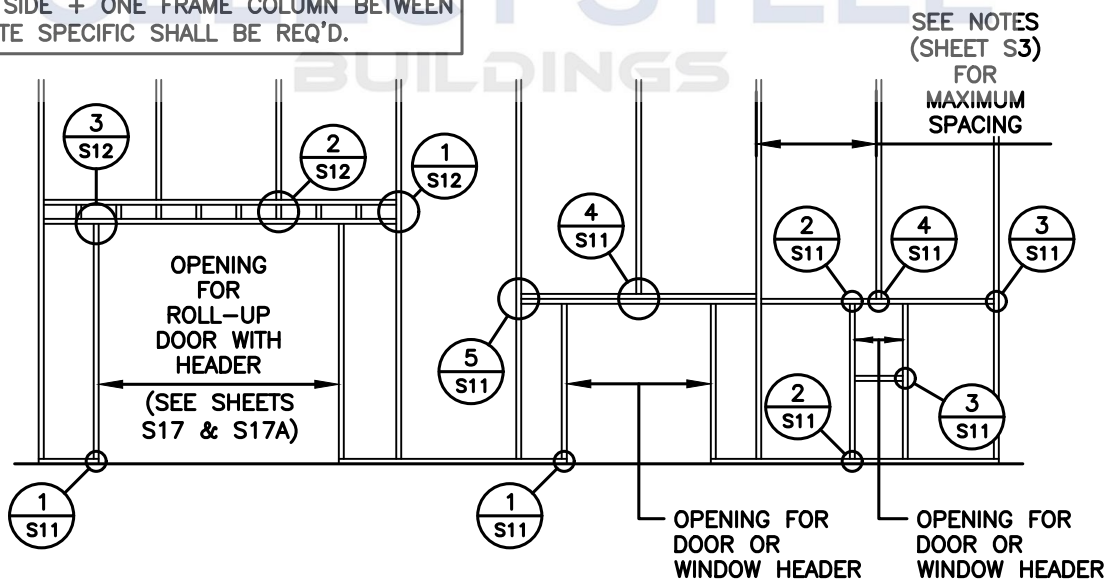
BOX EAVE RAFTER / SIDE WALL OPENINGS FRAMING

NOTE:
ROLL UP DOORS SHALL HAVE ONE JAMB
EACH SIDE + ONE FRAME COLUMN BETWEEN
OR SITE SPECIFIC SHALL BE REQ'D.



TYPICAL SIDE WALL OPENING FRAMING SECTION

NOTE:
ROLL UP DOORS SHALL HAVE ONE JAMB
EACH SIDE + ONE FRAME COLUMN BETWEEN
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TYPICAL SIDE WALL OPENING FRAMING SECTION



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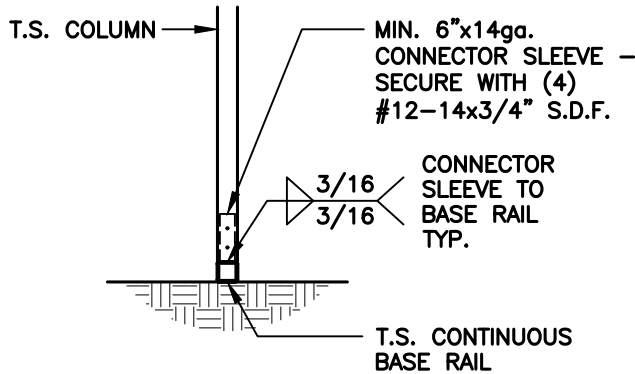
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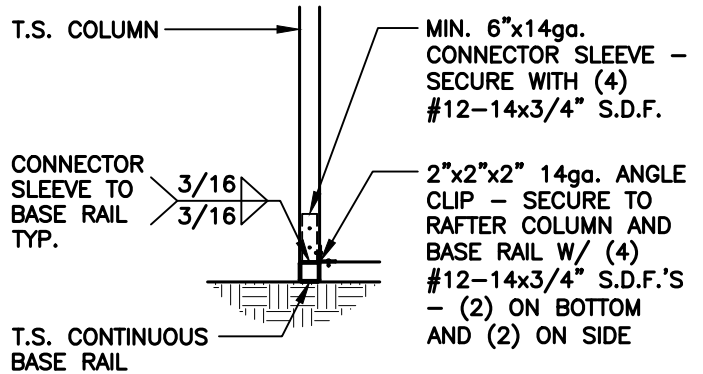
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BASE RAIL CONNECTION DETAILS




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S10
COLUMN / BASE RAIL
CONNECTION DETAIL

SCALE: 1/2" = 1'-0"




1A
S10
END COLUMN / BASE RAIL
CONNECTION DETAIL

SCALE: 1/2" = 1'-0"

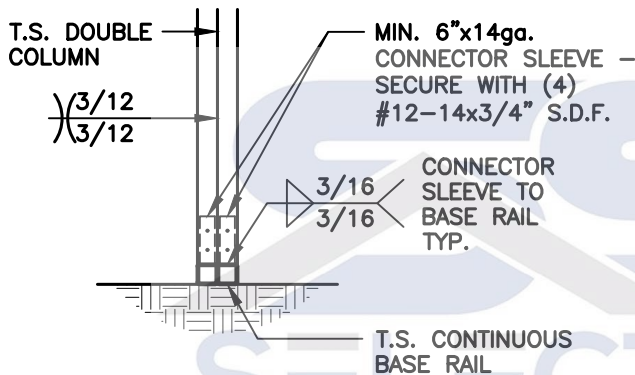

2
S10
COLUMN / BASE RAIL
CONNECTION DETAIL

SCALE: 1/2" = 1'-0"

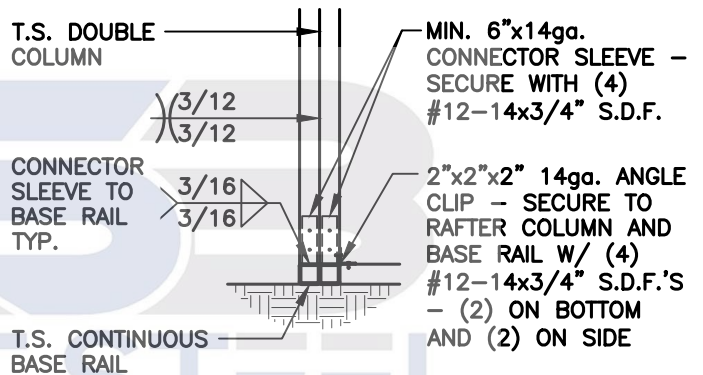

2A
S10
END COLUMN / BASE RAIL
CONNECTION DETAIL

SCALE: 1/2" = 1'-0"



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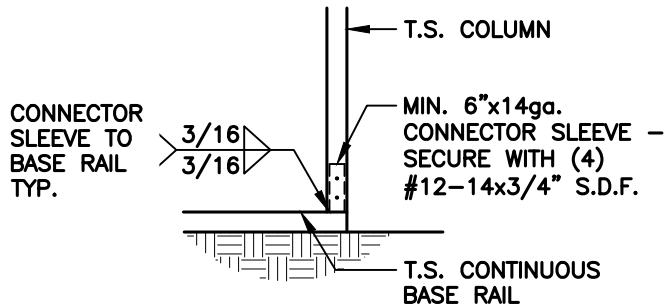
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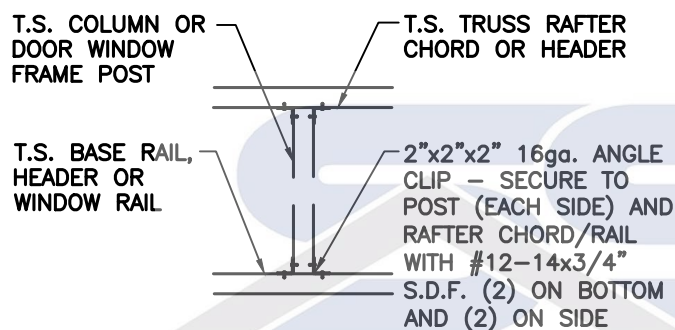
T.S. OPENING CONNECTION DETAILS



**COLUMN / BASE RAIL
CONNECTION DETAIL**

1
S11


SCALE: 1/2" = 1'-0"



**TRUSS / HEADER TO POST
CONNECTION DETAIL**

2
S11


SCALE: 1/2" = 1'-0"

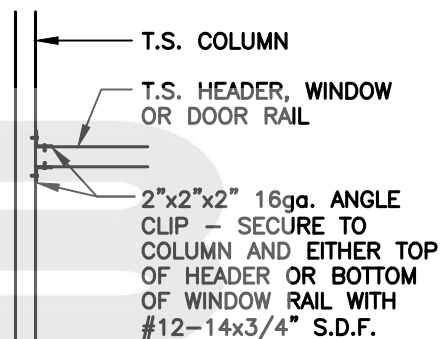

**HEADER / WINDOW OR DOOR RAIL
TO POST CONNECTION DETAIL**

3
S11


SCALE: 1/2" = 1'-0"

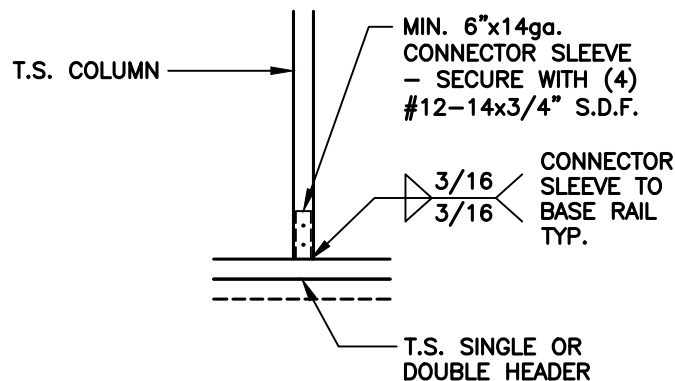

**COLUMN / DOUBLE HEADER
CONNECTION DETAIL**

4
S11

SCALE: 1/2" = 1'-0"

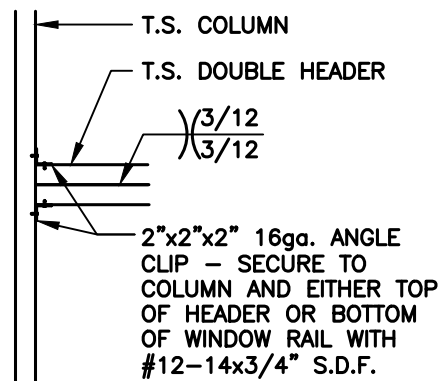

**DOUBLE HEADER / COLUMN
CONNECTION DETAIL**

5
S11

SCALE: 1/2" = 1'-0"



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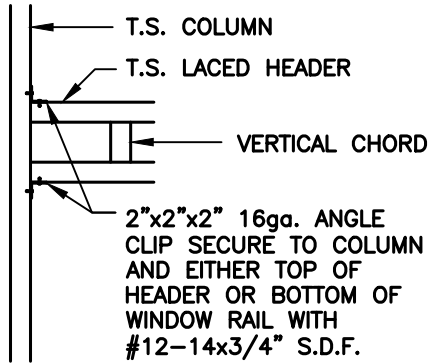
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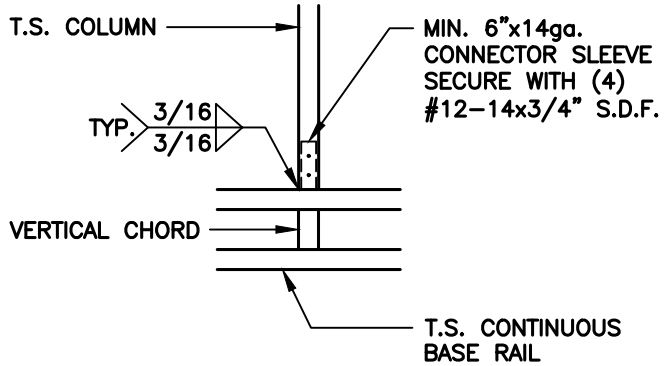
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T.S. OPENING CONNECTION DETAILS



1
S12 COLUMN / LACED HEADER
CONNECTION DETAIL

SCALE: 1/2" = 1'-0"



2
S12 LACED HEADER / COLUMN
CONNECTION DETAIL

SCALE: 1/2" = 1'-0"



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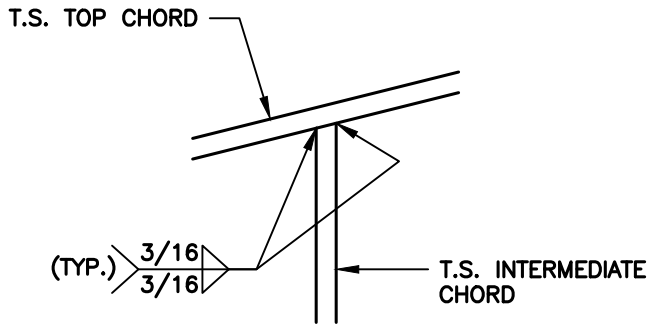
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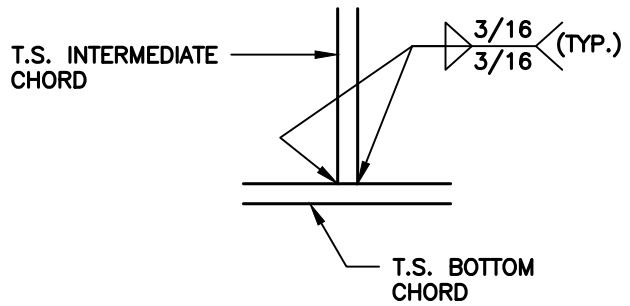
TRUSS CONNECTION DETAILS



**INTERMEDIATE CHORD / TOP
CHORD CONNECTION DETAIL**

1
S13


SCALE: 1/2" = 1'-0"



**INTERMEDIATE CHORD / BOTTOM
CHORD CONNECTION DETAIL**

2
S13

SCALE: 1/2" = 1'-0"

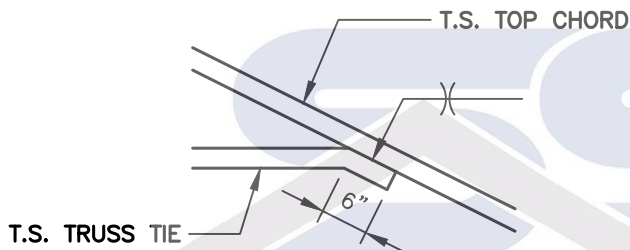

**TRUSS TIE / TOP CHORD
CONNECTION DETAIL**

3
S13

SCALE: 1/2" = 1'-0"



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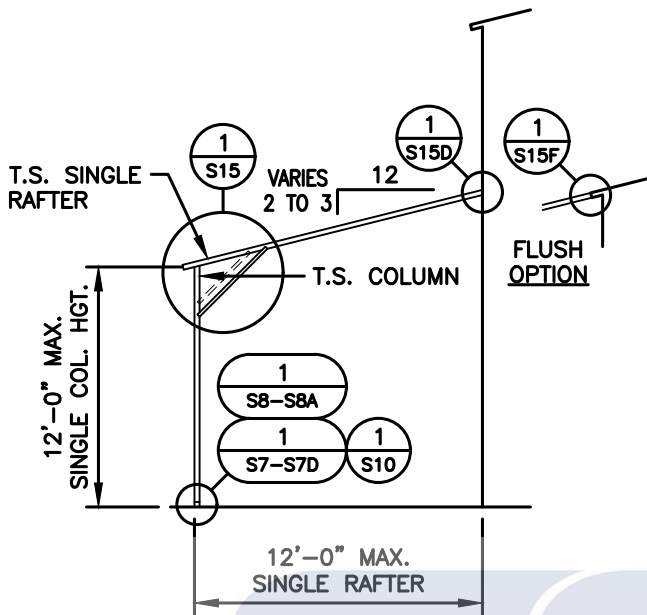
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DATE:
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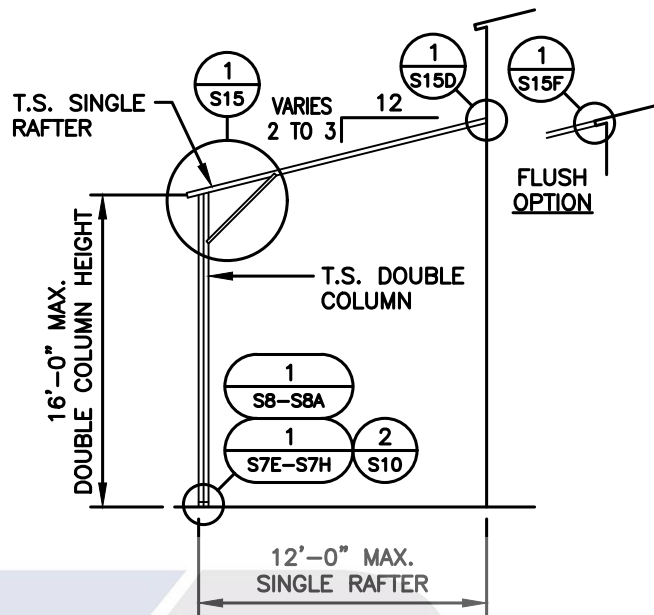
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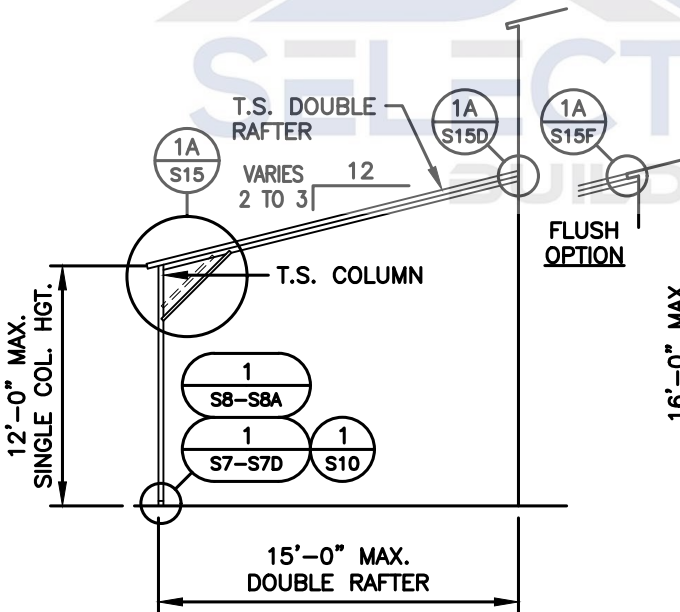
BOX EVE / SINGLE & DOUBLE RAFTER - LEAN-TO OPTIONS




SINGLE RAFTER / SINGLE COLUMN
LEAN-TO FRAMING SECTION



SINGLE RAFTER / DOUBLE COLUMN
LEAN-TO FRAMING SECTION



DOUBLE RAFTER / SINGLE COLUMN
LEAN-TO FRAMING SECTION

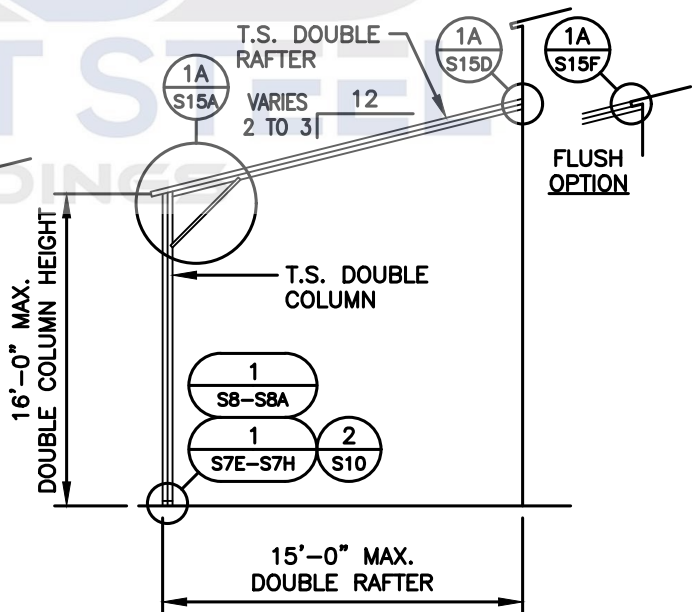

DOUBLE RAFTER / DOUBLE COLUMN
LEAN-TO FRAMING SECTION



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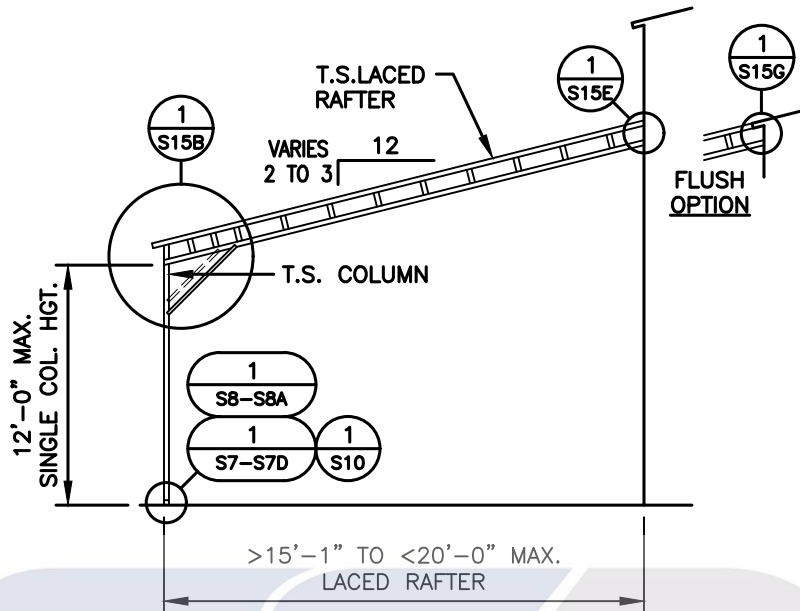
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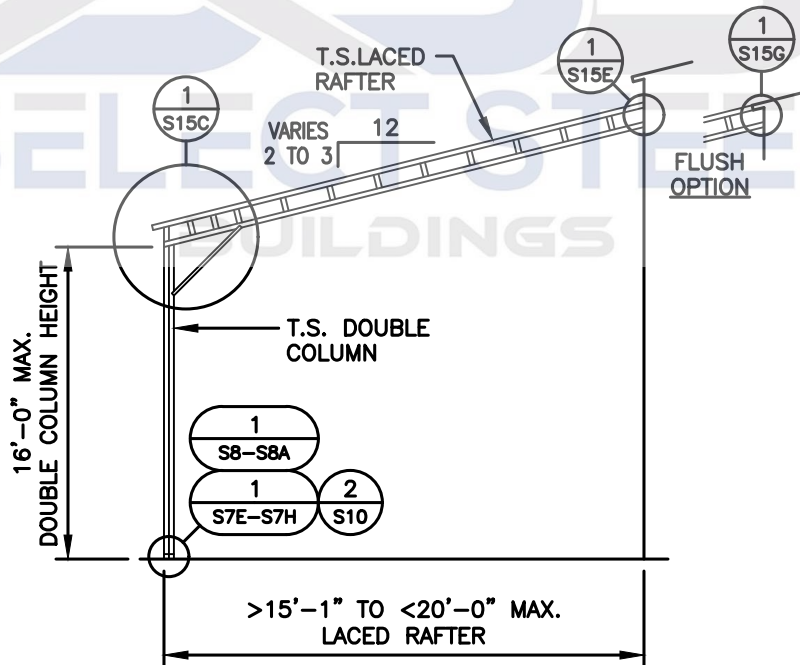
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BOX EVE / LACED RAFTER - LEAN-TO OPTIONS



LACED RAFTER / SINGLE COLUMN LEAN-TO FRAMING SECTION



LACED RAFTER / DOUBLE COLUMN LEAN-TO FRAMING SECTION



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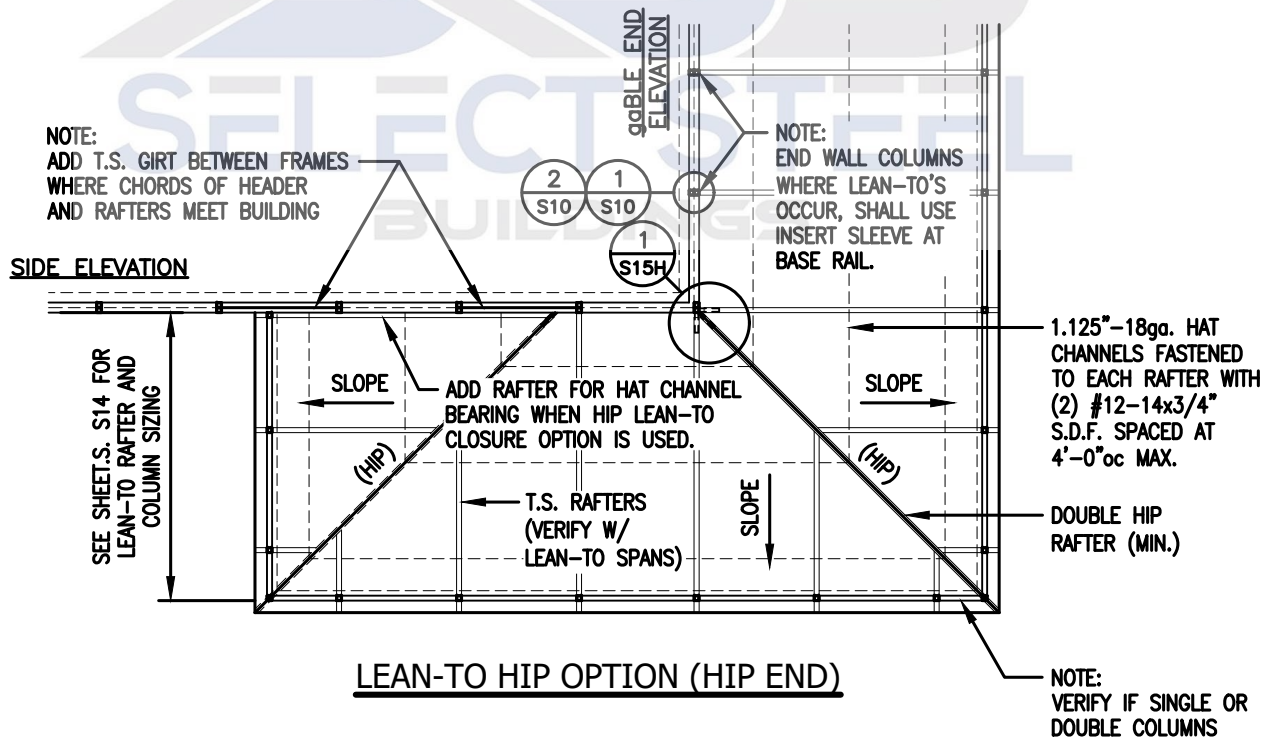
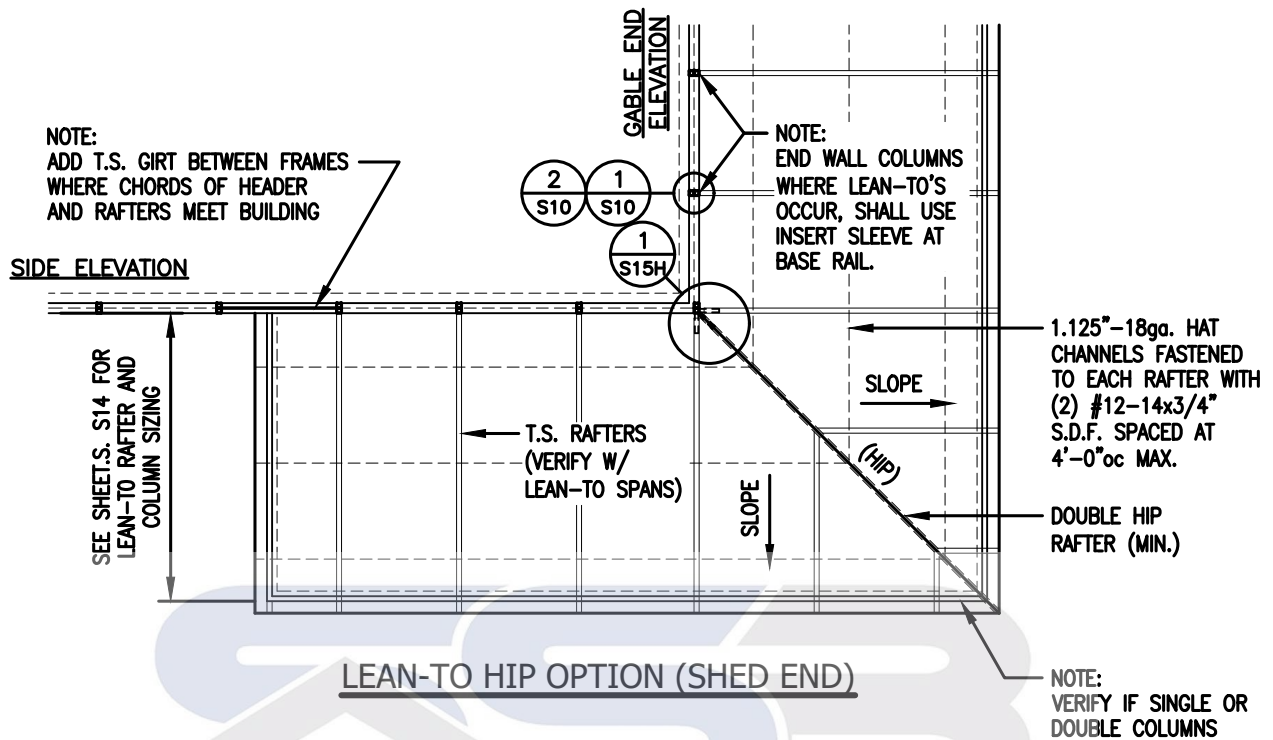
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24-511

DATE:
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S14A

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LEAN-TO 'HIP' OPTIONS



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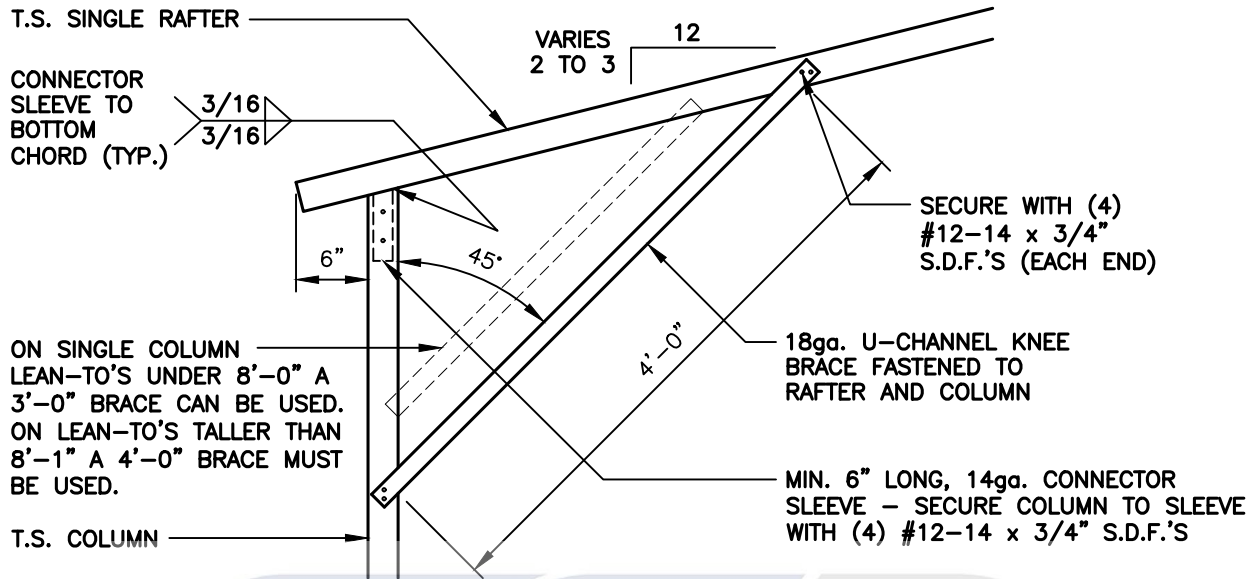
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SHEET NO:
S14B


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LEAN-TO CONNECTION DETAILS - SINGLE COLUMN



1
S15 LEAN-TO SINGLE RAFTER / SINGLE COLUMN CONNECTION DETAIL

SCALE: 3/4" = 1'-0"

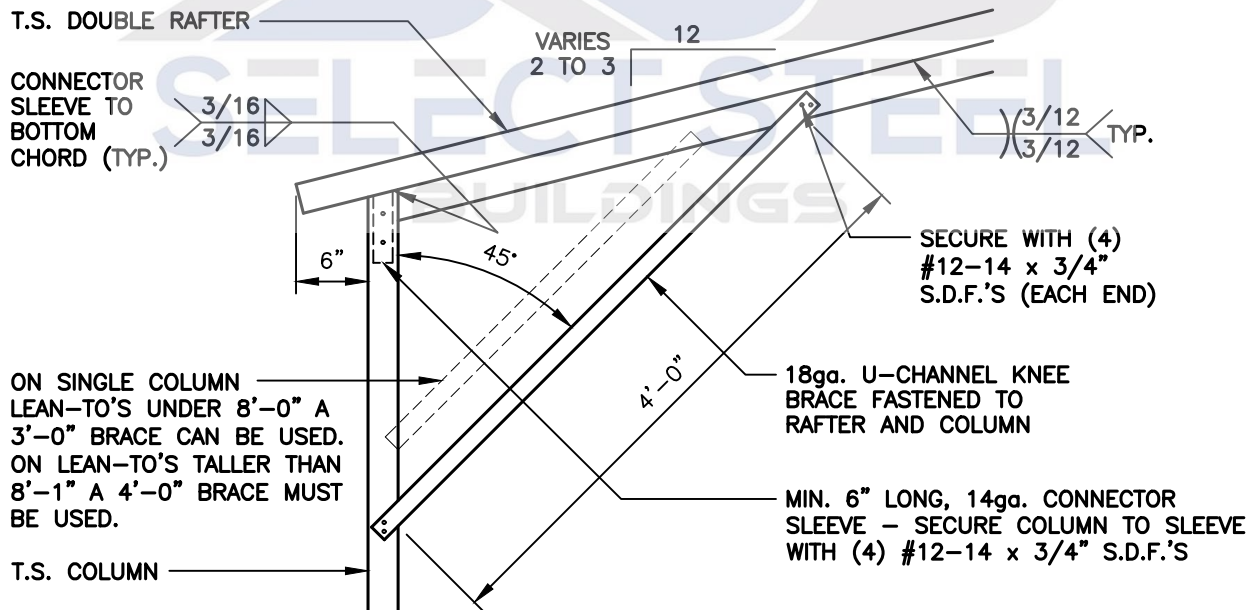

1A
S15 LEAN-TO DOUBLE RAFTER / SINGLE COLUMN CONNECTION DETAIL

SCALE: 3/4" = 1'-0"



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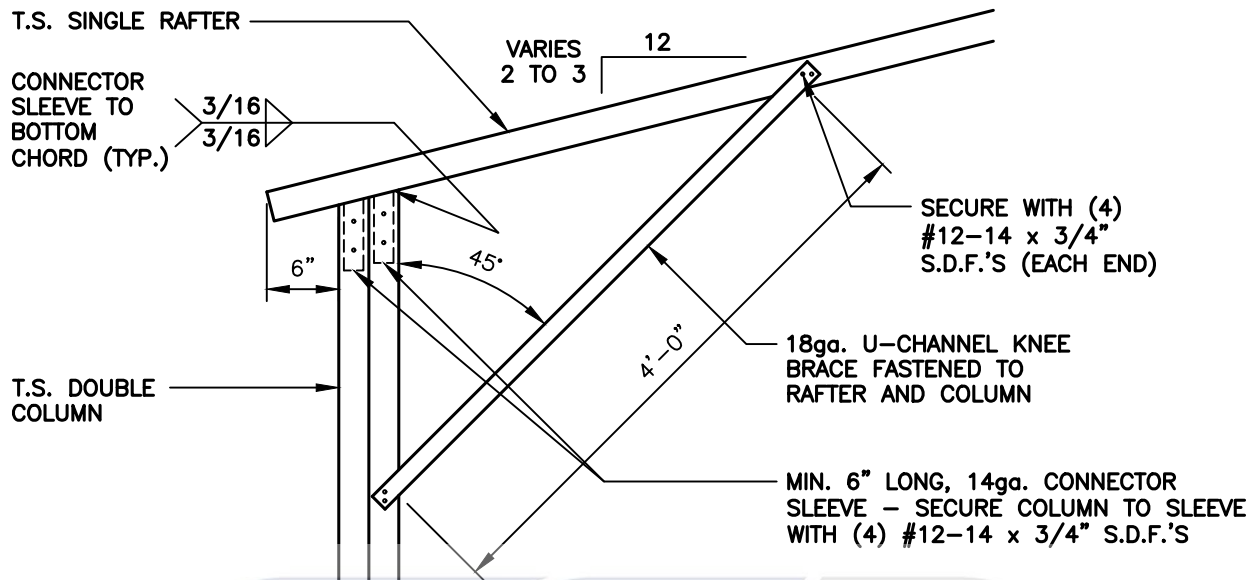
DATE:
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S15

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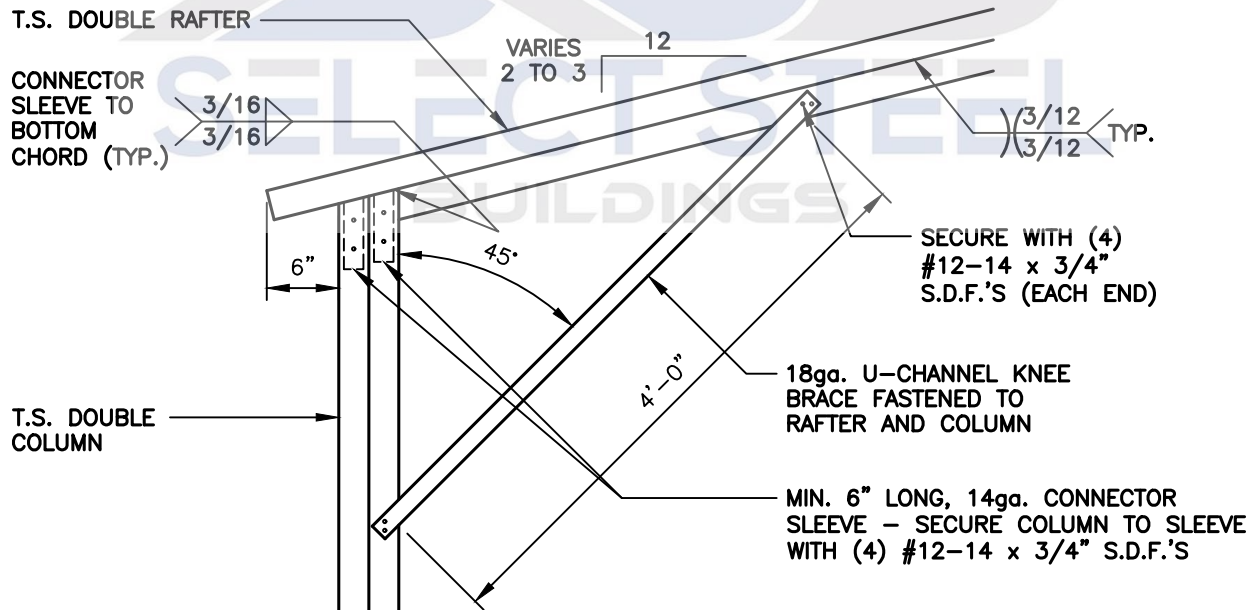
LEAN-TO CONNECTION DETAILS - DOUBLE COLUMN



LEAN-TO SINGLE RAFTER / DOUBLE COLUMN CONNECTION DETAIL

1
S15A

SCALE: 3/4" = 1'-0"



LEAN-TO DOUBLE RAFTER / DOUBLE COLUMN CONNECTION DETAIL

1A
S15A

SCALE: 3/4" = 1'-0"



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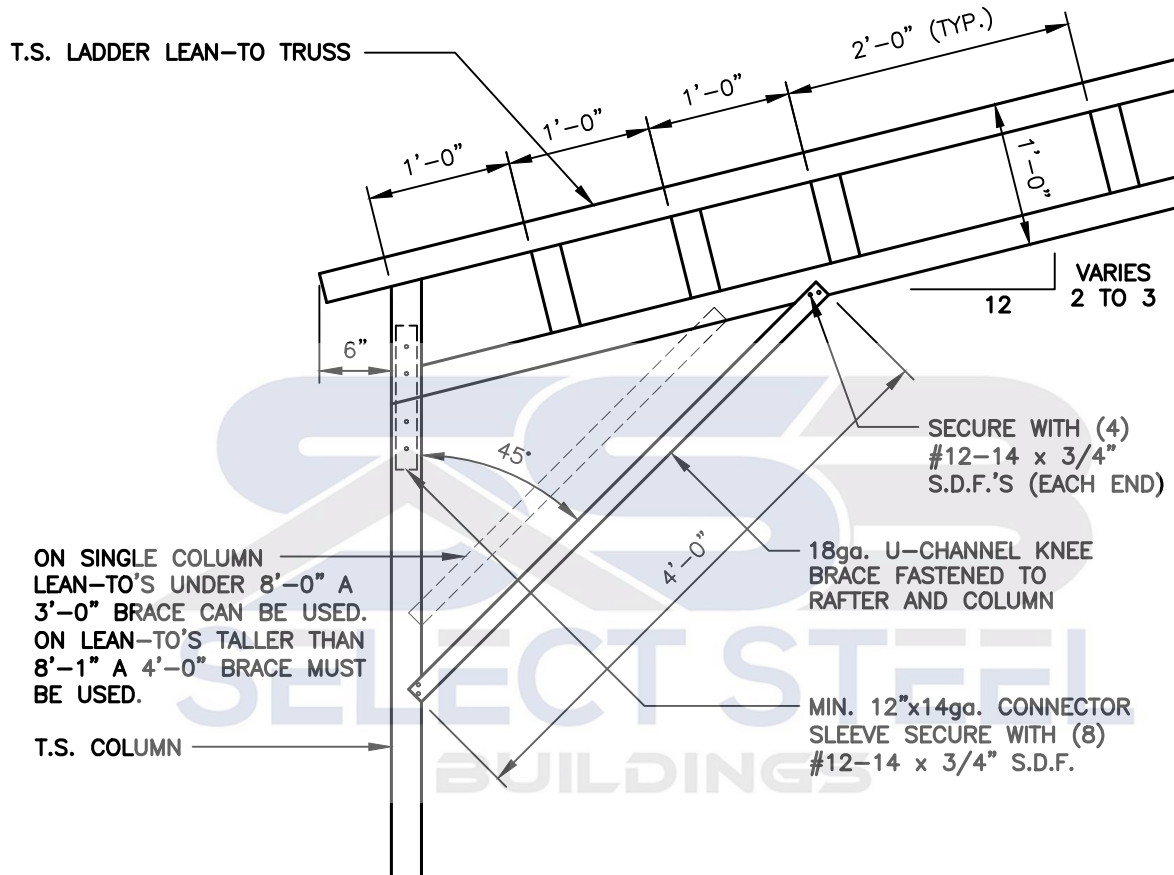
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S15A

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LEAN-TO CONNECTION DETAILS - LACED RAFTER / SINGLE COLUMN



LEAN-TO LACED RAFTER / SINGLE COLUMN
CONNECTION DETAIL

1
S15B

SCALE: 3/4" = 1'-0"



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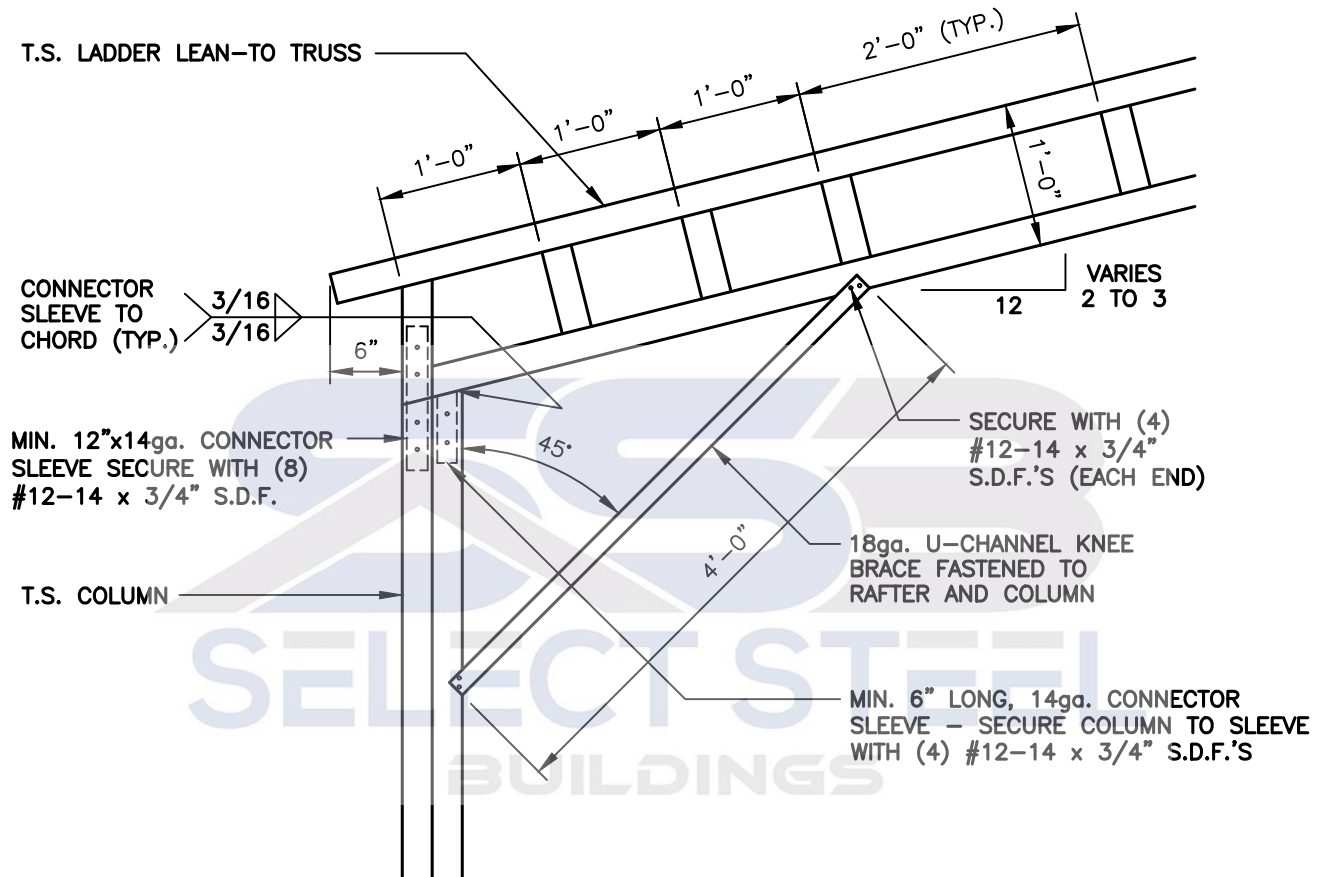
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LEAN-TO CONNECTION DETAILS - LACED RAFTER / DOUBLE COLUMN



LEAN-TO LACED RAFTER / DOUBLE COLUMN
CONNECTION DETAIL



SCALE: 3/4" = 1'-0"



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LEAN-TO / MAIN FRAME CONNECTION DETAILS

2"x2"x2" 14ga. ANGLE CLIP -
SECURE TO COLUMN AND RAFTER
WITH #12-14 x 3/4" S.D.F. (2)
ON TOP AND (2) ON BOTTOM

T.S. SINGLE RAFTER

T.S. MAIN
FRAME COLUMN

LEAN-TO SINGLE RAFTER / BUILDING FRAME CONNECTION DETAIL

1
S15D

SCALE: 3/4" = 1'-0"

2"x2"x2" 14ga. ANGLE CLIP -
SECURE TO COLUMN AND RAFTER
WITH #12-14 x 3/4" S.D.F. (2)
ON TOP AND (2) ON BOTTOM

T.S. DOUBLE RAFTER

TYP. $\frac{3}{12}$ / $\frac{3}{12}$

$\frac{3}{16}$ / $\frac{3}{16}$ CONNECTOR
SLEEVE TO
COLUMN

MIN. 6" LONG, 14ga. CONNECTOR
SLEEVE - SECURE COLUMN TO
SLEEVE WITH (4) #12-14 x 3/4"
S.D.F.'S

T.S. MAIN
FRAME COLUMN

LEAN-TO DOUBLE RAFTER / BUILDING FRAME CONNECTION DETAIL

1A
S15D

SCALE: 3/4" = 1'-0"



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LEAN-TO / MAIN FRAME CONNECTION DETAILS

MIN. 6" LONG, 14ga. CONNECTOR
SLEEVE - SECURE COLUMN TO
SLEEVE WITH (4) #12-14 x 3/4"
S.D.F.'S

T.S. LADDER LEAN-TO TRUSS

3/16
3/16
CONNECTOR
SLEEVE TO
COLUMN

2"x2"x2" 14ga. ANGLE CLIP
SECURE TO COLUMN AND RAFTER
WITH #12-14 x 3/4" S.D.F. (2)
ON TOP AND (2) ON BOTTOM

LEAN-TO SINGLE RAFTER / BUILDING FRAME
CONNECTION DETAIL

1

S15E

SCALE: 3/4" = 1'-0"

SELECT STEEL
BUILDINGS



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LEAN-TO / MAIN FRAME CONNECTION DETAILS

12" LONG 14ga. CONNECTOR
SLEEVE SECURE TO TOP WITH
(8) #12-14 x 3/4" S.D.F.'S

T.S. RAFTER

T.S. MAIN
FRAME COLUMN

LEAN-TO SINGLE RAFTER / BUILDING FRAME
(FLUSH) CONNECTION DETAIL

1

S15F

SCALE: 3/4" = 1'-0"

12" LONG 14ga. CONNECTOR
SLEEVE SECURE TO TOP WITH
(8) #12-14 x 3/4" S.D.F.'S

T.S. DOUBLE RAFTER

TYP. $\frac{3}{12} \left(\frac{3}{12} \right)$

T.S. MAIN
FRAME COLUMN

2"x2"x2" 14ga. ANGLE CLIP
SECURE TO COLUMN AND RAFTER
WITH #12-14 x 3/4" S.D.F. (2)
ON TOP AND (2) ON BOTTOM

LEAN-TO SINGLE RAFTER / BUILDING FRAME
(FLUSH) CONNECTION DETAIL

1A

S15F

SCALE: 3/4" = 1'-0"



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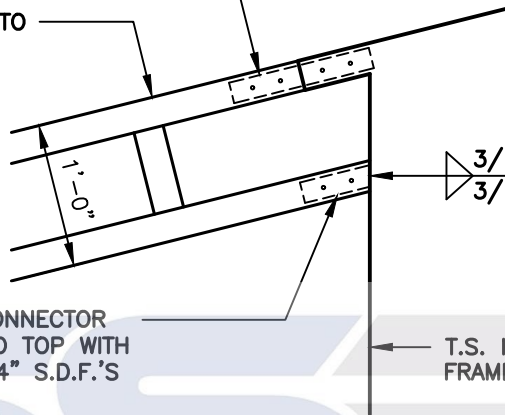
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S15F

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LEAN-TO / MAIN FRAME CONNECTION DETAILS

12" LONG 14ga. CONNECTOR
SLEEVE SECURE TO TOP WITH
(8) #12-14 x 3/4" S.D.F.'S

T.S. LACED LEAN-TO
TRUSS



3/16
3/16
CONNECTOR
SLEEVE TO
COLUMN

6" LONG 14ga. CONNECTOR
SLEEVE SECURE TO TOP WITH
(4) #12-14 x 3/4" S.D.F.'S

T.S. MAIN
FRAME COLUMN

LEAN-TO SINGLE RAFTER / BUILDING FRAME
(FLUSH) CONNECTION DETAIL

1

S15G

SCALE: 3/4" = 1'-0"

SELECT STEEL
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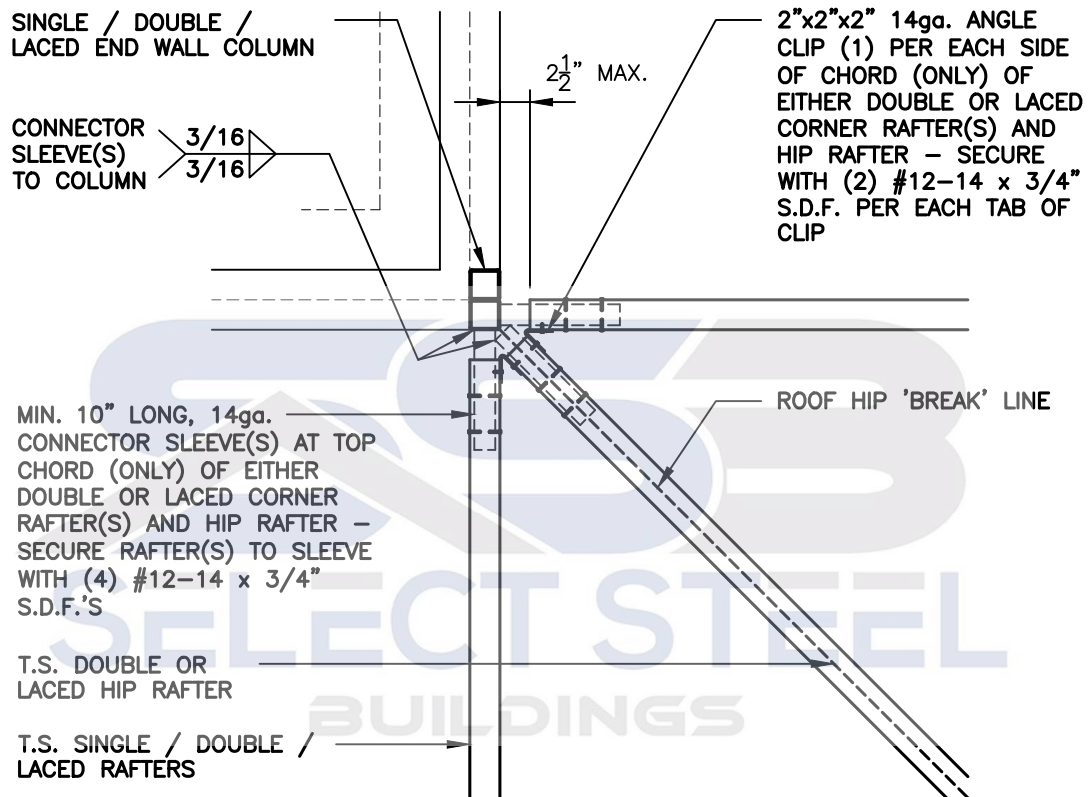
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END WALL COLUMN / HIP RAFTER CONNECTION DETAIL



END WALL COLUMN / HIP RAFTER CONNECTION DETAIL



SCALE: $\frac{3}{4}$ " = 1'-0"



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WILKESBORO, NORTH CAROLINA 28697
TELE: 366-973-0721

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BKS


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05.23.24

PROJECT NO:
24-511

SHEET NO:
S15H

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VERTICAL ROOF / SIDING OPTION

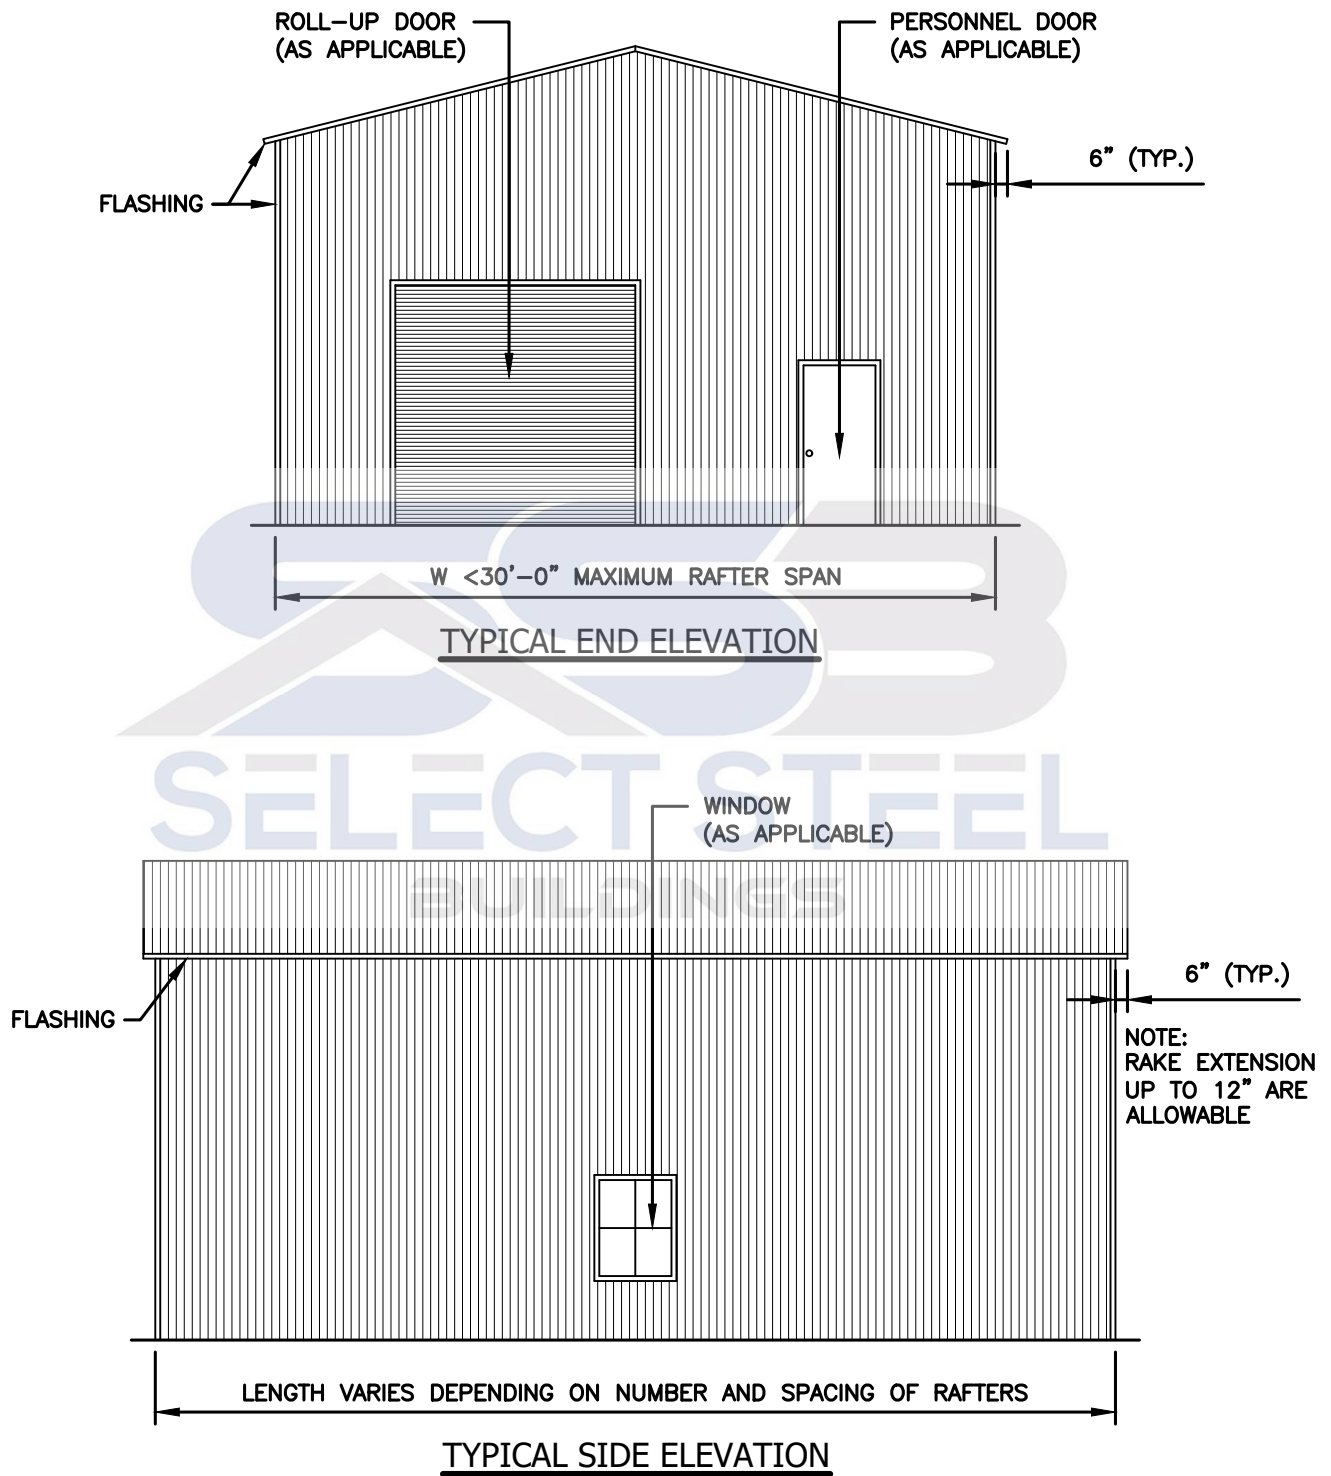

TAYLOR & VIOLA
STRUCTURAL ENGINEERS
P.O.B. 2616 HICKORY NORTH CAROLINA
TELE: 828-328-6331 FAX: 828-322-1801
WWW.TAYLORVIOLA.COM

JCMT Associates, PLLC
211 Stone Drive, Pilot Mountain, NC 27041
Telephone: (336) 399-6277

VI.0

SELECT STEEL
BUILDINGS, INC.

2745 STATESVILLE RD.
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TELE: 366-973-0721

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VERTICAL ROOF / SIDING OPTION

1" MIN. - 18ga. HAT CHANNELS
FASTENED TO EACH RAFTER WITH
(2) #12-14 x 3/4" S.D.F.
SPACED AT 4'-0"oc MAX.

29ga. GALVANIZED METAL
ROOF AND WALL PANELS
FASTENED TO GIRTS AND
POST OR HAT CHANNELS

T.S. SINGLE OR
DOUBLE COLUMN

T.S. GIRT.S.
SPACED AT
5'-0"oc (MAX.)

W >21' TO <30' MAXIMUM RAFTER SPAN

TYPICAL SECTION VERTICAL ROOF / SIDING OPTION

SELECT STEEL
BUILDINGS



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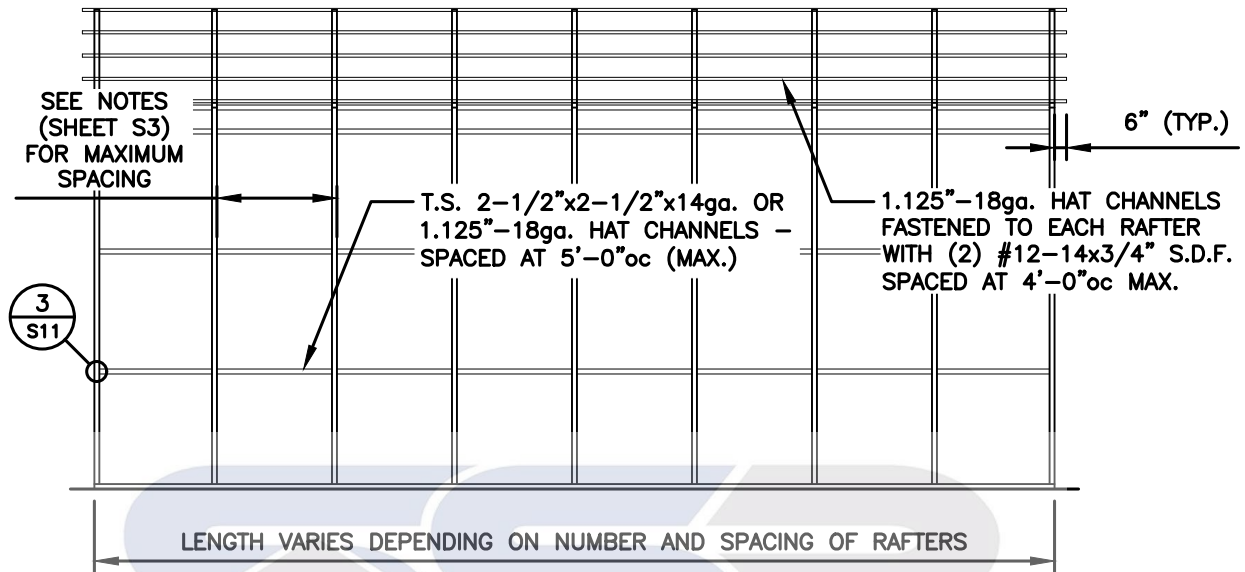
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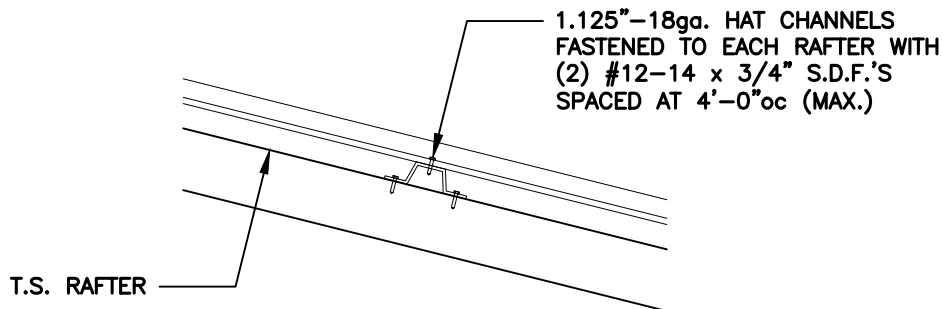
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VERTICAL ROOF / SIDING OPTION



TYPICAL SIDE FRAMING SECTION VERTICAL ROOF / SIDING OPTION

SELECT STEEL
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(TYPICAL) ROOF PANEL ATTACHMENT



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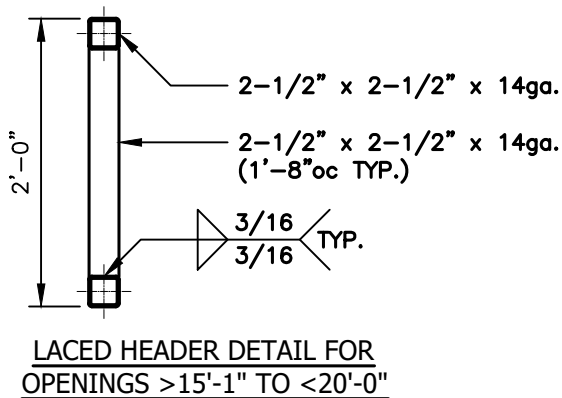
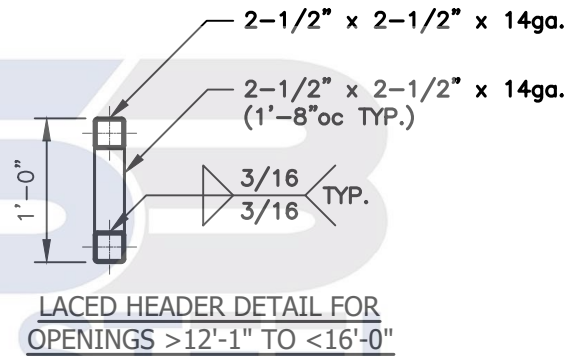
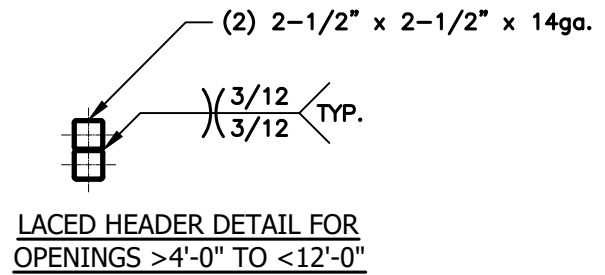
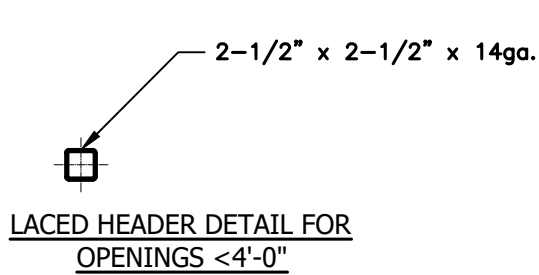
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05.23.24

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SIDE WALL HEADER OPTIONS



GENERAL NOTE:

PROVIDE DOUBLE WYTHE HEADER
ON DOUBLE COLUMNS.



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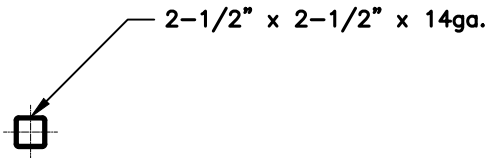
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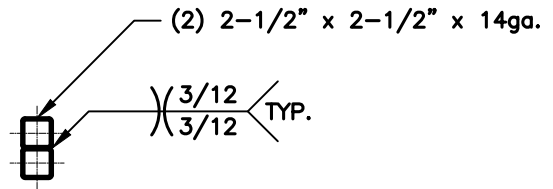
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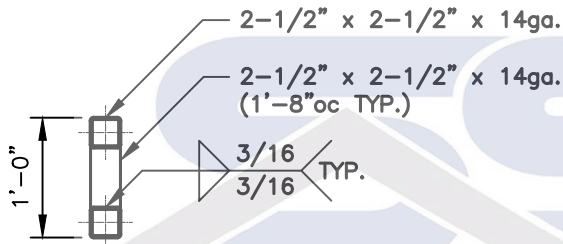
END WALL HEADER OPTIONS



LACED HEADER DETAIL FOR
OPENINGS <7'-0"



LACED HEADER DETAIL FOR
OPENINGS >7'1" TO <16'-0"



LACED HEADER DETAIL FOR
OPENINGS >16'-1" TO <20'-0"

GENERAL NOTE:

PROVIDE DOUBLE WYTHER HEADER
ON DOUBLE COLUMNS



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