

FOUNDATION SCHEDULE			
MARK	SIZE	REINFORCEMENT	
F1	9'-0"x9'-0"x2'-6"	14-#6 BARS E.W. BOT. & 7-#4 BARS E.W. TOP	
F2	10'-0"x10'-0"x3'-0"	18-#6 BARS E.W. BOT. & 8-#4 BARS E.W. TOP	
F3	10'-6"x10'-6"x3'-0"	18-#6 BARS E.W. BOT. & 8-#4 BARS E.W. TOP	

GENERAL NOTES - VEHICLE AND TRAILER COVERED SHELTER FOUNDATION PLAN: . SEE PLAN FOR T.O.F. ELEVATIONS. MAINTAIN A 12" MINIMUM OF COVER OVER ALL T.O.F.'s TYPICAL. GC SHALL COORDINATE ALL T.O.F./T.O.P. ELEVATIONS W/ SITE PLAN.


2. GC SHOULD AVOID LEAVING OPEN TRENCH EXCAVATIONS FOR THE FOOTINGS FOR LONG PERIODS WHEN INCLEMENT WEATHER IS ANTICIPATED. IN GENERAL ALL EXCAVATIONS MADE SHOULD BE POURED ON THE DAY OF THE EXCAVATION IF INCLEMENT WEATHER IS EXPECTED.

3. CONTRACTOR SHALL COORDINATE FOR LOCAL INSPECTING AUTHORITY TO REVIEW AND APPROVE ALL FOOTING TRENCHES PRIOR TO THE PLACEMENT OF ANY FOOTING CONCRETE. IF FOOTINGS FAIL INSPECTION CONTRACTOR SHALL CONTACT THE ENGINEER FOR RECOMMENDATIONS.


6. FOUNDATION DESIGN BASED ON A SOIL BEARING PRESSURE OF 2500 PSF. SEE S&ME PROJECT NO. 22050344 FOR GEOTECHNICAL INFORMATION. ANY AREAS DETERMINED NOT TO PROVIDE THIS STATED SOIL BEARING PRESSURE SHALL BE BROUGHT TO THE ENGINEERS ATTENTION.

7. FOUNDATION DESIGN BASED ON VARCO PRUDEN PRE-ENGINEERED METAL BUILDING DRAWINGS DATED 5-20-2024. IF REVISIONS ARE MADE TO THE REFERENCED PRE-ENGINEERED METAL BUILDING DRAWINGS, CONTACT ENGINEER FOR FOUNDATION DESIGN REVIEW.

TYPICAL

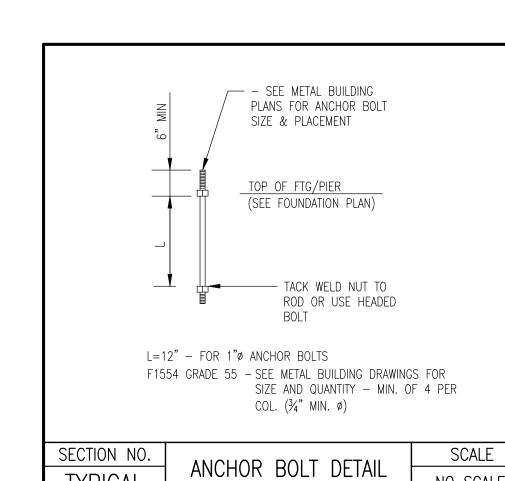



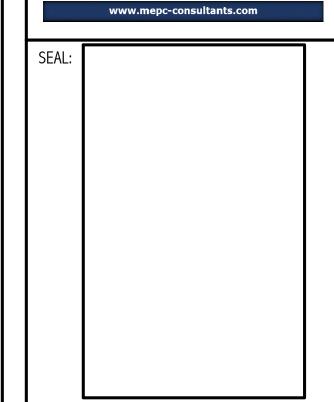

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REVISIONS			
PROGRESS REVIEW #1:	9-17-24		
PROGRESS REVIEW #2:			
PROGRESS REVIEW #3:			
ISSUE FOR CONST.:	9-18-24		
REVISION #1:			
REVISION #2:			
REVISION #3:			
REVISION #4:			
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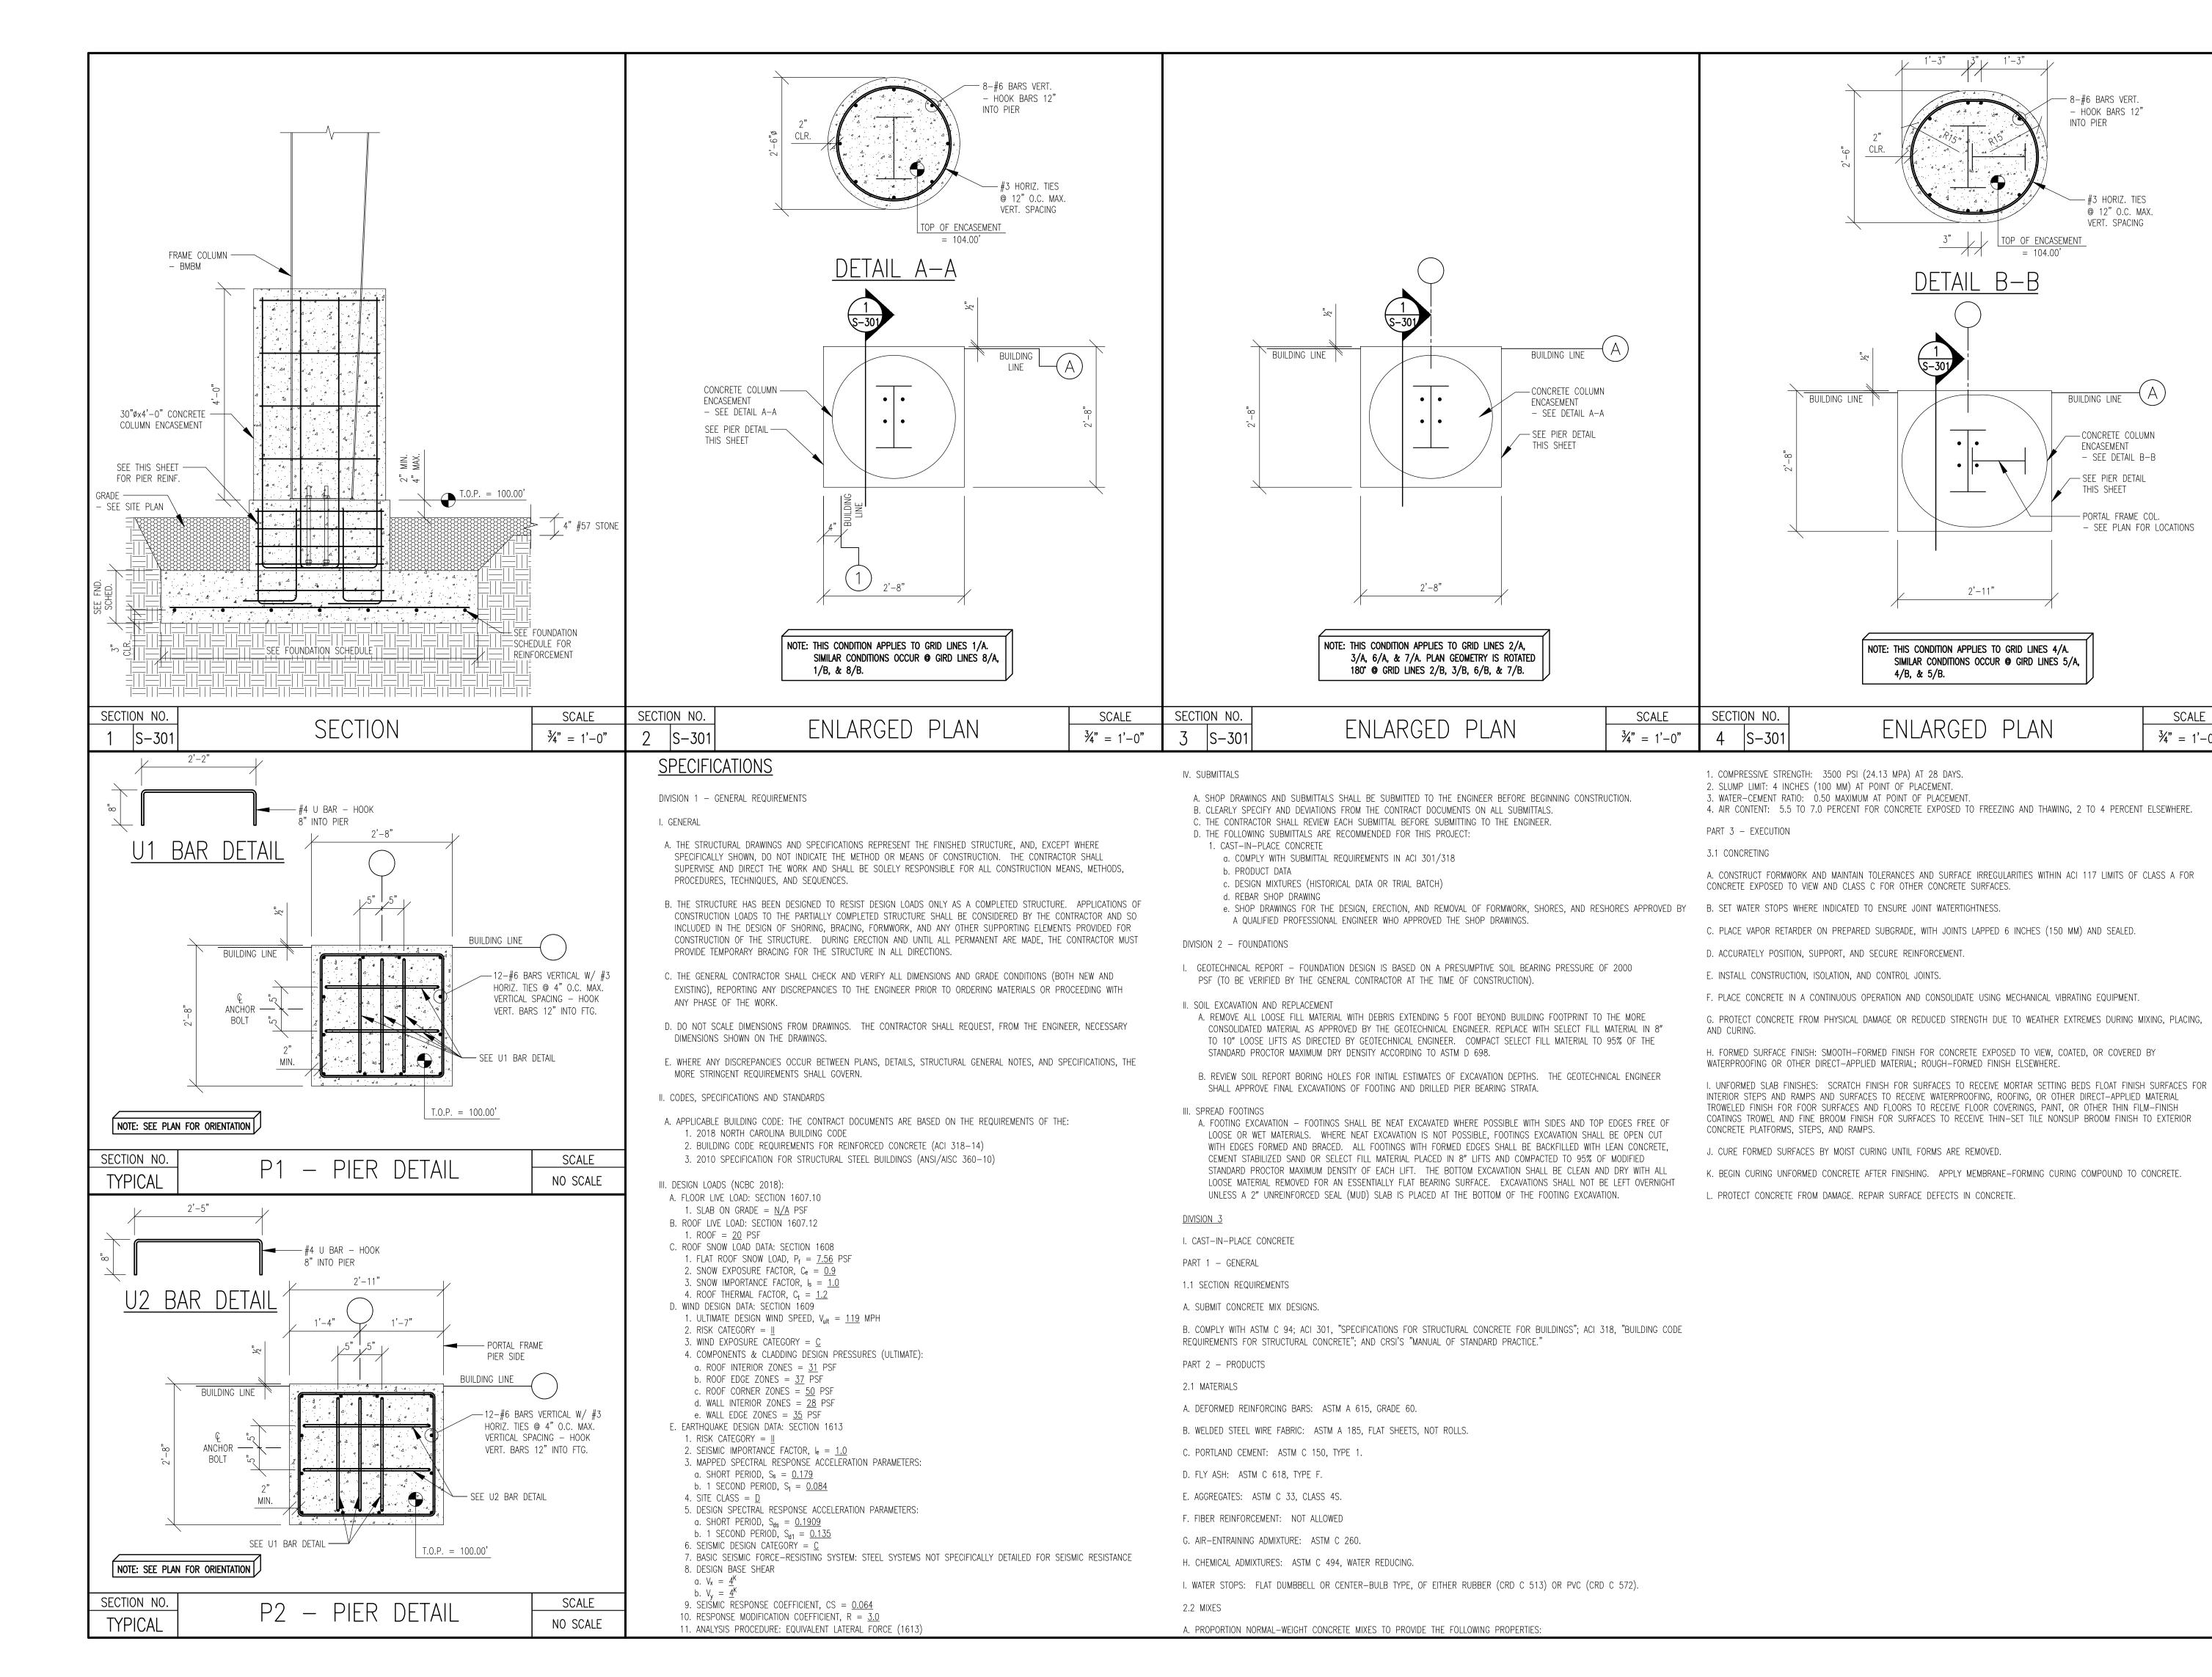
SCALE: 1/8" = 1'-0"FOUNDATION PLAN

115-24 MEPC PROJECT NO.: DATE: 9-18-24 JWM/PCC DESIGN BY:

DRAWN BY: CHECKED BY:

NO SCALE





MOOREFIELD ENGINEERING, PC STRUCTURAL ENGINEERS University Commercial Center

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- HOOK BARS 12" INTO PIER

@ 12" O.C. MAX.

VERT. SPACING

BUILDING LINE (A

— CONCRETE COLUMN

ENCASEMENT - SEE DETAIL B-B

— SEE PIER DETAIL

-PORTAL FRAME COL.

- SEE PLAN FOR LOCATIONS

SCALE

 $\frac{3}{4}$ " = 1'-0"

THIS SHEET

email: office@mepc-consultants.com

www.mepc-consultants.com

REVISIONS PROGRESS REVIEW #1: 9-17-24 PROGRESS REVIEW #2: PROGRESS REVIEW #3: 9-18-24 ISSUE FOR CONST.: REVISION #1 REVISION #2 REVISION #3 REVISION #

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SHE ORO **V** S

SCALE: 3/4" = 1'-0"

SECTIONS, DETAILS &

SPECIFICATIONS MEPC PROJECT NO.:

DATE: 9-18-24 JWM/PCC DESIGN BY: DRAWN BY:

CHECKED BY: