
	FOUNDAT	ION SCHEDULE
MARK	SIZE	REINFORCEMENT
F1	4'-0"x4'-0"x1'-0"	5-#5 BARS E.W.
f'c = 3500psi		

<u>GENERAL NOTES – WELD SHOP FOUNDATION PLAN:</u> I. SEE PLAN FOR T.O.F. ELEVATIONS. MAINTAIN A 12" MINIMUM OF COVER OVER PERIMETER WALL T.O.F.'s TYPICAL. GC SHALL COORDINATE T.O.F. ELEVATIONS W/ SITE PLAN TO DETERMINE IF ADEQUATE FOOTING DEPTH WILL NEED TO BE PROVIDED. 2. COORDINATE FLOOR DRAINS AND ANY SLOPED FLOOR AREA REQUIREMENTS WITH THE PLUMBING DRAWINGS. 3. GC SHALL COORDINATE WITH THE PLUMBING CONTRACTOR FOR ANY STEP DOWNS IN THE T.O.F.'S IF REQUIRED TO ALLOW PLUMBING TO EXIT THE BUILDING. 4. GC SHOULD AVOID LEAVING OPEN TRENCH EXCAVATIONS FOR THE FOOTINGS FOR LONG PERIODS WHEN INCLEMENT WEATHER IS ANTICIPATED. IN GENERAL ALL EXCAVATIONS MADE SHOULD BE POURED ON THE DAY OF THE EXCAVATION IF INCLEMENT WEATHER IS EXPECTED. 5. CONTRACTOR SHALL COORDINATE FOR LOCAL INSPECTING AUTHORITY TO REVIEW AND APPROVE ALL FOOTING TRENCHES PRIOR TO THE PLACEMENT OF ANY FOOTING CONCRETE. IF FOOTINGS FAIL INSPECTION CONTRACTOR SHALL CONTACT THE ENGINEER FOR RECOMMENDATIONS. 6. FOUNDATION DESIGN BASED ON A PRESUMPTIVE SOIL BEARING PRESSURE OF 2000 PSF. GC SHALL HAVE SOIL TESTING FIRM TO VERIFY PRESUMPTIVE BEARING PRESSURE PRIOR TO PLACEMENT OF THE CONCRETE FOOTINGS. ANY AREAS DETERMINED NOT TO PROVIDE THIS STATED SOIL BEARING PRESSURE SHALL BE BROUGHT TO THE ENGINEERS ATTENTION. 7. FOUNDATION DESIGN BASED ON VARCO PRUDEN PRE-ENGINEERED METAL BUILDING DRAWINGS DATED 2-1-2024. IF REVISIONS ARE MADE TO THE REFERENCED PRE-ENGINEERED METAL BUILDING DRAWINGS, CONTACT ENGINEER FOR FOUNDATION DESIGN REVIEW.

(A)-

B

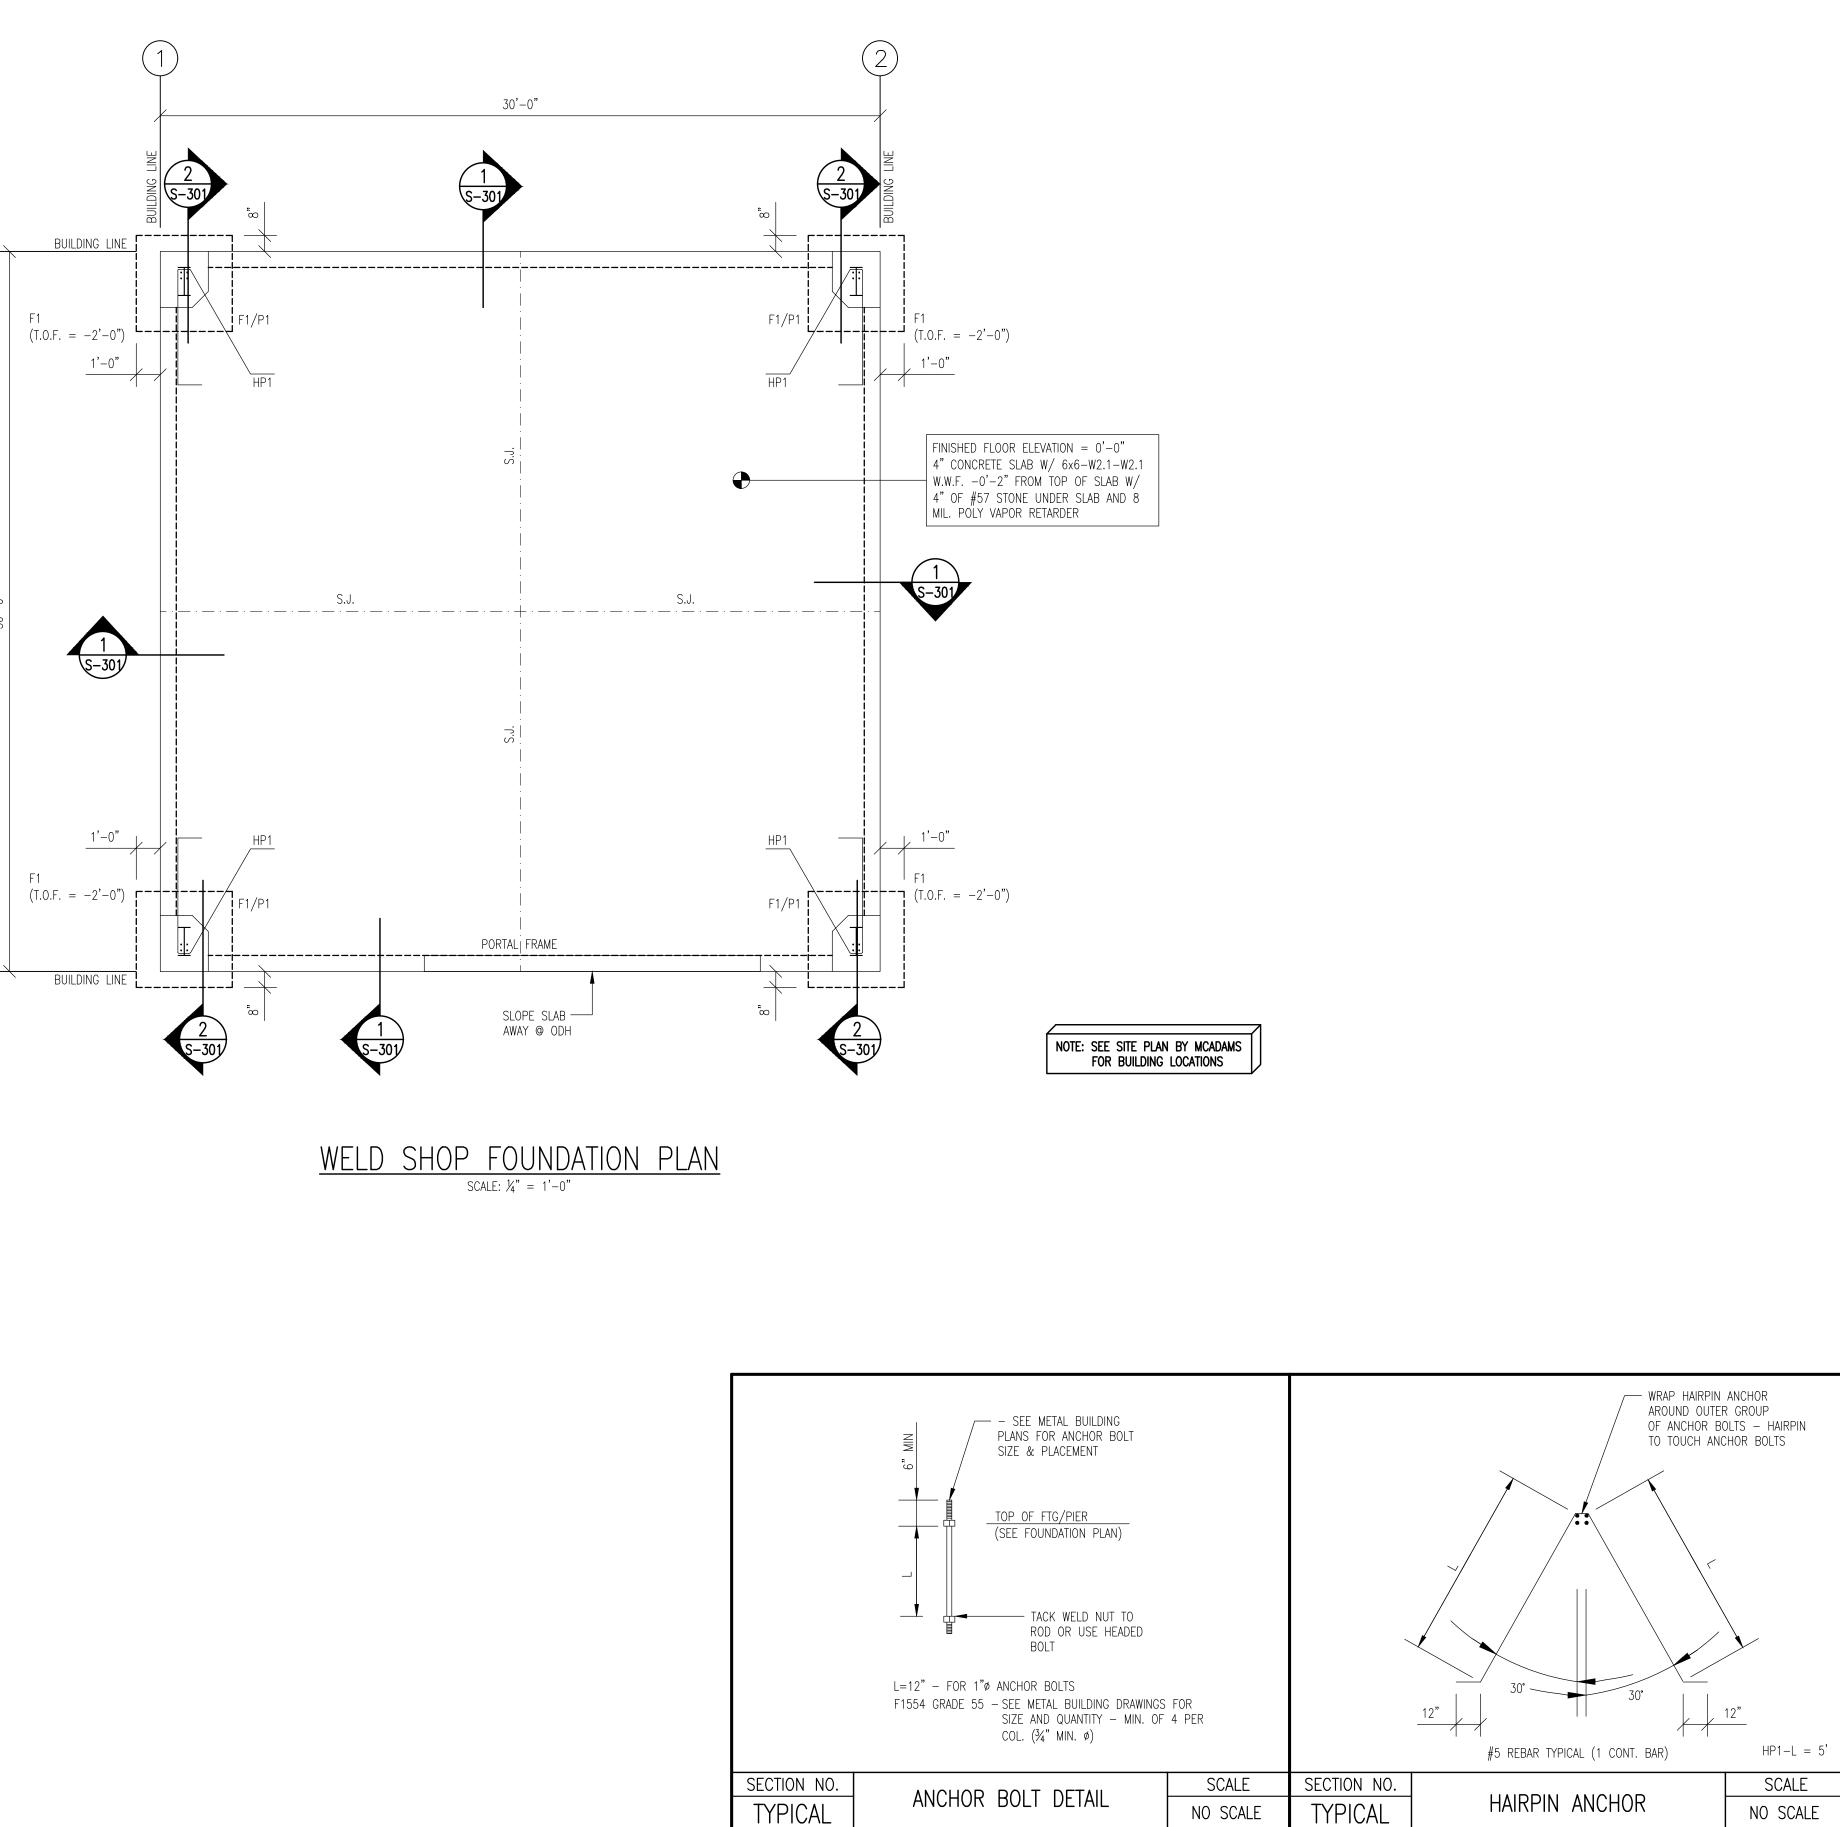

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	PROGRESS REVIEW #2: PROGRESS REVIEW #3:
	ISSUE FOR CONST.: 9–18–24 REVISION #1: REVISION #2:
	REVISION #2: REVISION #3: REVISION #4:
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	CE ENERGY WELD SHOP JONESBORD RD NORTH CAROLINA
	JKE ENERGY N WELD SHOP 269 JONESBORD RD JN, NORTH CAROLINA
	DUKE ENERGY IEW WELD SHOP 1269 JONESBORD RD DUNN, NORTH CAROLINA
	DUKE ENERGY DUKE ENERGY NEW VELD SHOP 1269 JONESBORD RD DUNN, NORTH CAROLINA
	PROTECT NAME DUKE ENERGY DUKE ENERGY D
	PROJECT NAME:
	SCALE: 1/4" = 1'-0" FOUNDATION PLAN
	ESCALE: 1/4" = 1'-0"
	High High SCALE: 1/4" = 1'-0" FOUNDATION PLAN MEPC PROJECT NO.: 115-24
	Here Here MEPC PROJECT NO.: 115-24 DATE: 9-18-24
	Image: Scale: 1/4" = 1'-0" Scale: 1/4" = 1'-0" FOUNDATION PLAN MEPC PROJECT NO.: 115-24 DATE: 9-18-24 DESIGN BY: JWM/PCC
	Image: Scale: 1/4" = 1'-0" Scale: 1/4" = 1'-0" Foundation Plan Mepc project no.: 115-24 Date: 9-18-24 Design by: JWM/Pcc Drawn by: JBL
	Image: Scale: 1/4" = 1'-0" Scale: 1/4" = 1'-0" Foundation Plan Mepc project no.: 115-24 Date: 9-18-24 Design by: JWM/Pcc Drawn by: JBL
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