Ministries Activity Center Addition Mount Pisgah Harnett Original Free Will] **Baptist Church**

145 Prospect Church Road Erwin, NC



INDEX OF DRAWINGS SYMBOLS & MATERIALS LEGEND GENERAL NOTES 1.1 ALL WORK SHALL CONFORM TO AT LEAST THE MINIMUM General Conditions: CONCRETE MASONRY UNIT STANDARDS OF THE NORTH CAROLINA BUILDING CODE (NCBC), 2018 General Liability, Builder's Risk, and Workmen's Compensation Insurances are required: Floor Insurance not required: EDITION AND ALL APPLICABLE LOCAL ORDINANCES. * All Permit Fees are required: PLYWOOD CONCRETE MASONRY UNIT Temporary Utilities: Water, Sanitation, Power, and Telephone: 1.2 DESIGN LOADINGS WHERE APPLICABLE ARE INDICATED WITHIN * Keep Job Site clean and final building cleaned up ready for Owner Occupancy: (SECTION VIEW) RIGID INSULATION THE STRUCTURAL DRAWINGS AND/OR BUILDING CODE SUMMARY. * Construction Staking: * Full Time Job Supervision: CONCRETE 1.3 TO THE BEST OF THE ARCHITECT'S KNOWLEDGE, THE BATT INSULATION ARCHITECTURAL DRAWINGS HAVE BEEN DESIGNED IN ACCORDANCE **BRICK** FOAM INSULATION * Clearing and Grubbing existing area where new construction will be going: WITH THE CURRENT BUILDING CODE. Repair existing ground previously occupied by original Sanctuary to be demolished by Owner: STEEL/METAL * Finish Floor Elevation to match existing finish floor: 1.4 THE CONTRACTOR SHALL NOTIFY THE ARCHITECT OF ANY 'To include all required sedimentation and erosion control required by Harnett County: DISCREPANCIES PRIOR TO CONSTRUCTION. THE All sidewalks, stoops, etc. shown on Civil Site Plan (by others): Sidewalks, Stoops, etc. will be 4" thick, 3000 psi concrete at 28 days with WOOD STONE/GRAVEL CONTRACTOR SHALL REVIEW AND DETERMINE THAT one layer of 6x6x10/10 welded wire fabric: DIMENSIONS ARE COORDINATED BETWEEN ARCHITECTURAL, **EXISTING WALL** Soil Poisoning beneath Building pad per USDA spec's including one year warranty: STUCCO/SAND MECHANICAL, ELECTRICAL, PLUMBING AND STRUCTURAL Removal or Replacement of unsuitable soils, if encountered, will be done under the supervision of the Soils Testing Lab retained by the DRAWINGS BEFORE FABRICATION OR CONSTRUCTION. THE Owner: Contractor to provide a unit price for Architect to approve: ARCHITECT WILL MAKE AVAILABLE UPON REQUEST THE BASE FLOOR PLAN(S) & REFLECTED CEILING PLAN(S) IN AUTOCAD R2000 DWG FORMAT FOR SUB-CONTRACTOR USE IN PREPARATION OF SHOP * All concrete shall be 3,000 psi @ 28 days compressive strength: Floor Slab to be 4" thick with one layer of 6x6x10/10 welded wire reinforcing on 6 mil vapor barrier: DRAWINGS. FILES SHALL BE SENT ONLY UPON RECEIPT OF All necessary reinforcing for footings, control joints, cur-n-seal and perimeter foundation insulation: ARCHITECTS ELECTRONIC RELEASE FORM SIGNED BY INDIVIDUAL INTERIOR ELEVATION WALL SECTION * Concrete pads for new Condenser Units and Dumpster Pad as shown on Civil drawings and Mechanical drawings: REQUESTING THE FILE(S) AND A \$100 PER FILE TRANSFER FEE. · WALL SECTION - ELEVATION IDENTIFICATION IDENTIFICATION 1.5 WHENEVER AMBIGUITY OR CONFLICT WITHIN THESE Masonry and Mortar shall be a match to what is on the existing Sanctuary which remains: CONSTRUCTION DOCUMENTS MAY EXIST, THE MOST SHEET SECTION SHEET ELEVATION APPEARS To include galvanized wall ties, PVC thru wall flashing, and all steel angle lintels above door and window openings, including the curved STRINGENT REQUIREMENT SHALL APPLY AS INTERPRETED APPEARS ON. lintels over the large oval windows: BY THE ARCHITECT. To include 72" high brick screen wall around three sides of Dumpster pad: VICINITY MAP INTERIOR FINISHES 1.6 IF COMPLIANCE WITH TWO OR MORE STANDARDS IS Rough Carpentry:

* Pre-engineered Wood Roof Trusses at 24" o.c. with hurricane clips at each truss, including all bracing both temporary and permanent: SPECIFIED AND THE STANDARDS ESTABLISH DIFFERENT OR — DETAIL IDENTIFICATION CONFLICTING REQUIREMENTS, THE MOST STRINGENT Roof Decking to be one layer of 5/8" OSB Sheathing with hold down clips and covered with one layer of felt, weight of felt to be as approved for warranty by metal roof panel manufacturer: REQUIREMENT SHALL APPLY. - FINISH IDENTIFICATION SHEET DETAIL APPEARS Architectural Wood Work and Trim: * To include the fabrication, supply and installation of all cabinetry and shelving: All exposed cabinet surfaces shall be covered with plastic INTERIOR FINISHES (SPECIAL) laminate. All interior surfaces are to be covered with melamine. Includes plastic laminate covered countertops and backsplashes: PROJECT TEAM Thermal and Moisture Protection: Sound Batts are to be installed in all interior partitions: * Roof Panels are to match what is on their present Sanctuary. Field verify: Aluminum covered fascia and frieze with vented vinyl soffit to match what is on existing Sancturary: Field verify: Exterior walls to receive one layer of 1/2" OSB sheathing with one layer of 15 lb felt and R19 Batt Insulation with Kraft faced vapor **KEYNOTE TAG** * R38 Insulation with Kraft faced Batt Insulation at roof trusses at Thermal Line established by Architect: **REVISION TAG** M/E/P ENGINEER CONSULTANT ARCHITECT: KAIROS PROJECT GROUP, INC. R. WARD WEBB, ARCHITECT, P.A. Page 2, Spec Issues, continued: DOOR TAG 555 FAYETTEVILLE STREET 1659 W. HANRAHAN ROAD SUITE 201 AYDEN, NC. 28513 RALEIGH, NC. 27601 * Hollow Metal Doors flush insulated painted with Hollow Metal Frames. See Plans for locations: PHONE: (252) 531-2711 WINDOW TAG * Wood Doors: Solid Core, Stain Grade, Birch Veneer Doors with Hollow Metal Frames. See Plans for locations: WGARRYOWEN@CS.COM PHONE: (919) 719-3475 EMAIL: * Bronze Aluminum Doors and Frames: To match what is used on the existing Sanctuary. Field Verify: FIRE RATED PARTITION * Finish Hardware: To match that which is used on the existing Sanctuary. Field Verify: SMOKE PARTITION STRUCTURAL ENGINEER: CONTRACTOR: * All walls to receive 5/8" drywall ready for paint or wall covering: Special Drywall required at Fire Barrier: See Plans: NEVILLE ENGINEERING * Ceilings: See Plans for locations of Acoustical Tile versus Drywall. All ceilings to be in finished form: Acoustical ceilings to 110-B CULBRETH RD. be 2'x2' white Class A grid with Omni fissured reveal edge tile. Provide for two ceiling access hatches: CHAPEL HILL, NC. 27516 * Floor Coverings: Provide an Allowance Twenty Six Thousand (\$26,000.00) for Owner selected floor coverings including

* Wall Coverings: Provide an Allowance of Seven Thousand (\$7,000.00) for Owner selected wall covering:

* Provide plastic laminate Corner Guards at all Corridor corners 6' high:

* Window blinds will be provided by Owner:

* Miscellaenous: Provide (4) Recessed 10 lb Fire Extinguishers with cabinets in locations as verified by Fire Marshal:

PHONE: (919) 740-3427

ARCHITECT

RON W. WEBB 1659 W. HANRAHAN ROAD **AYDEN, NC. 28513** TEL: (252) 531-2711

Ministries Activity Center Addition Mount Pisgah Harnett Original Free Will Baptist Church

> 145 Prospect Church Road Erwin, NC.

PROJECT CONSULTANTS



STRUCTURAL

NEVILLE ENGINEERING

CHAPEL HILL, NC 27516



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Plot Date:


Revisions

Mark	Date	Description
	1	

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TITLE SHEET

Drawing No.

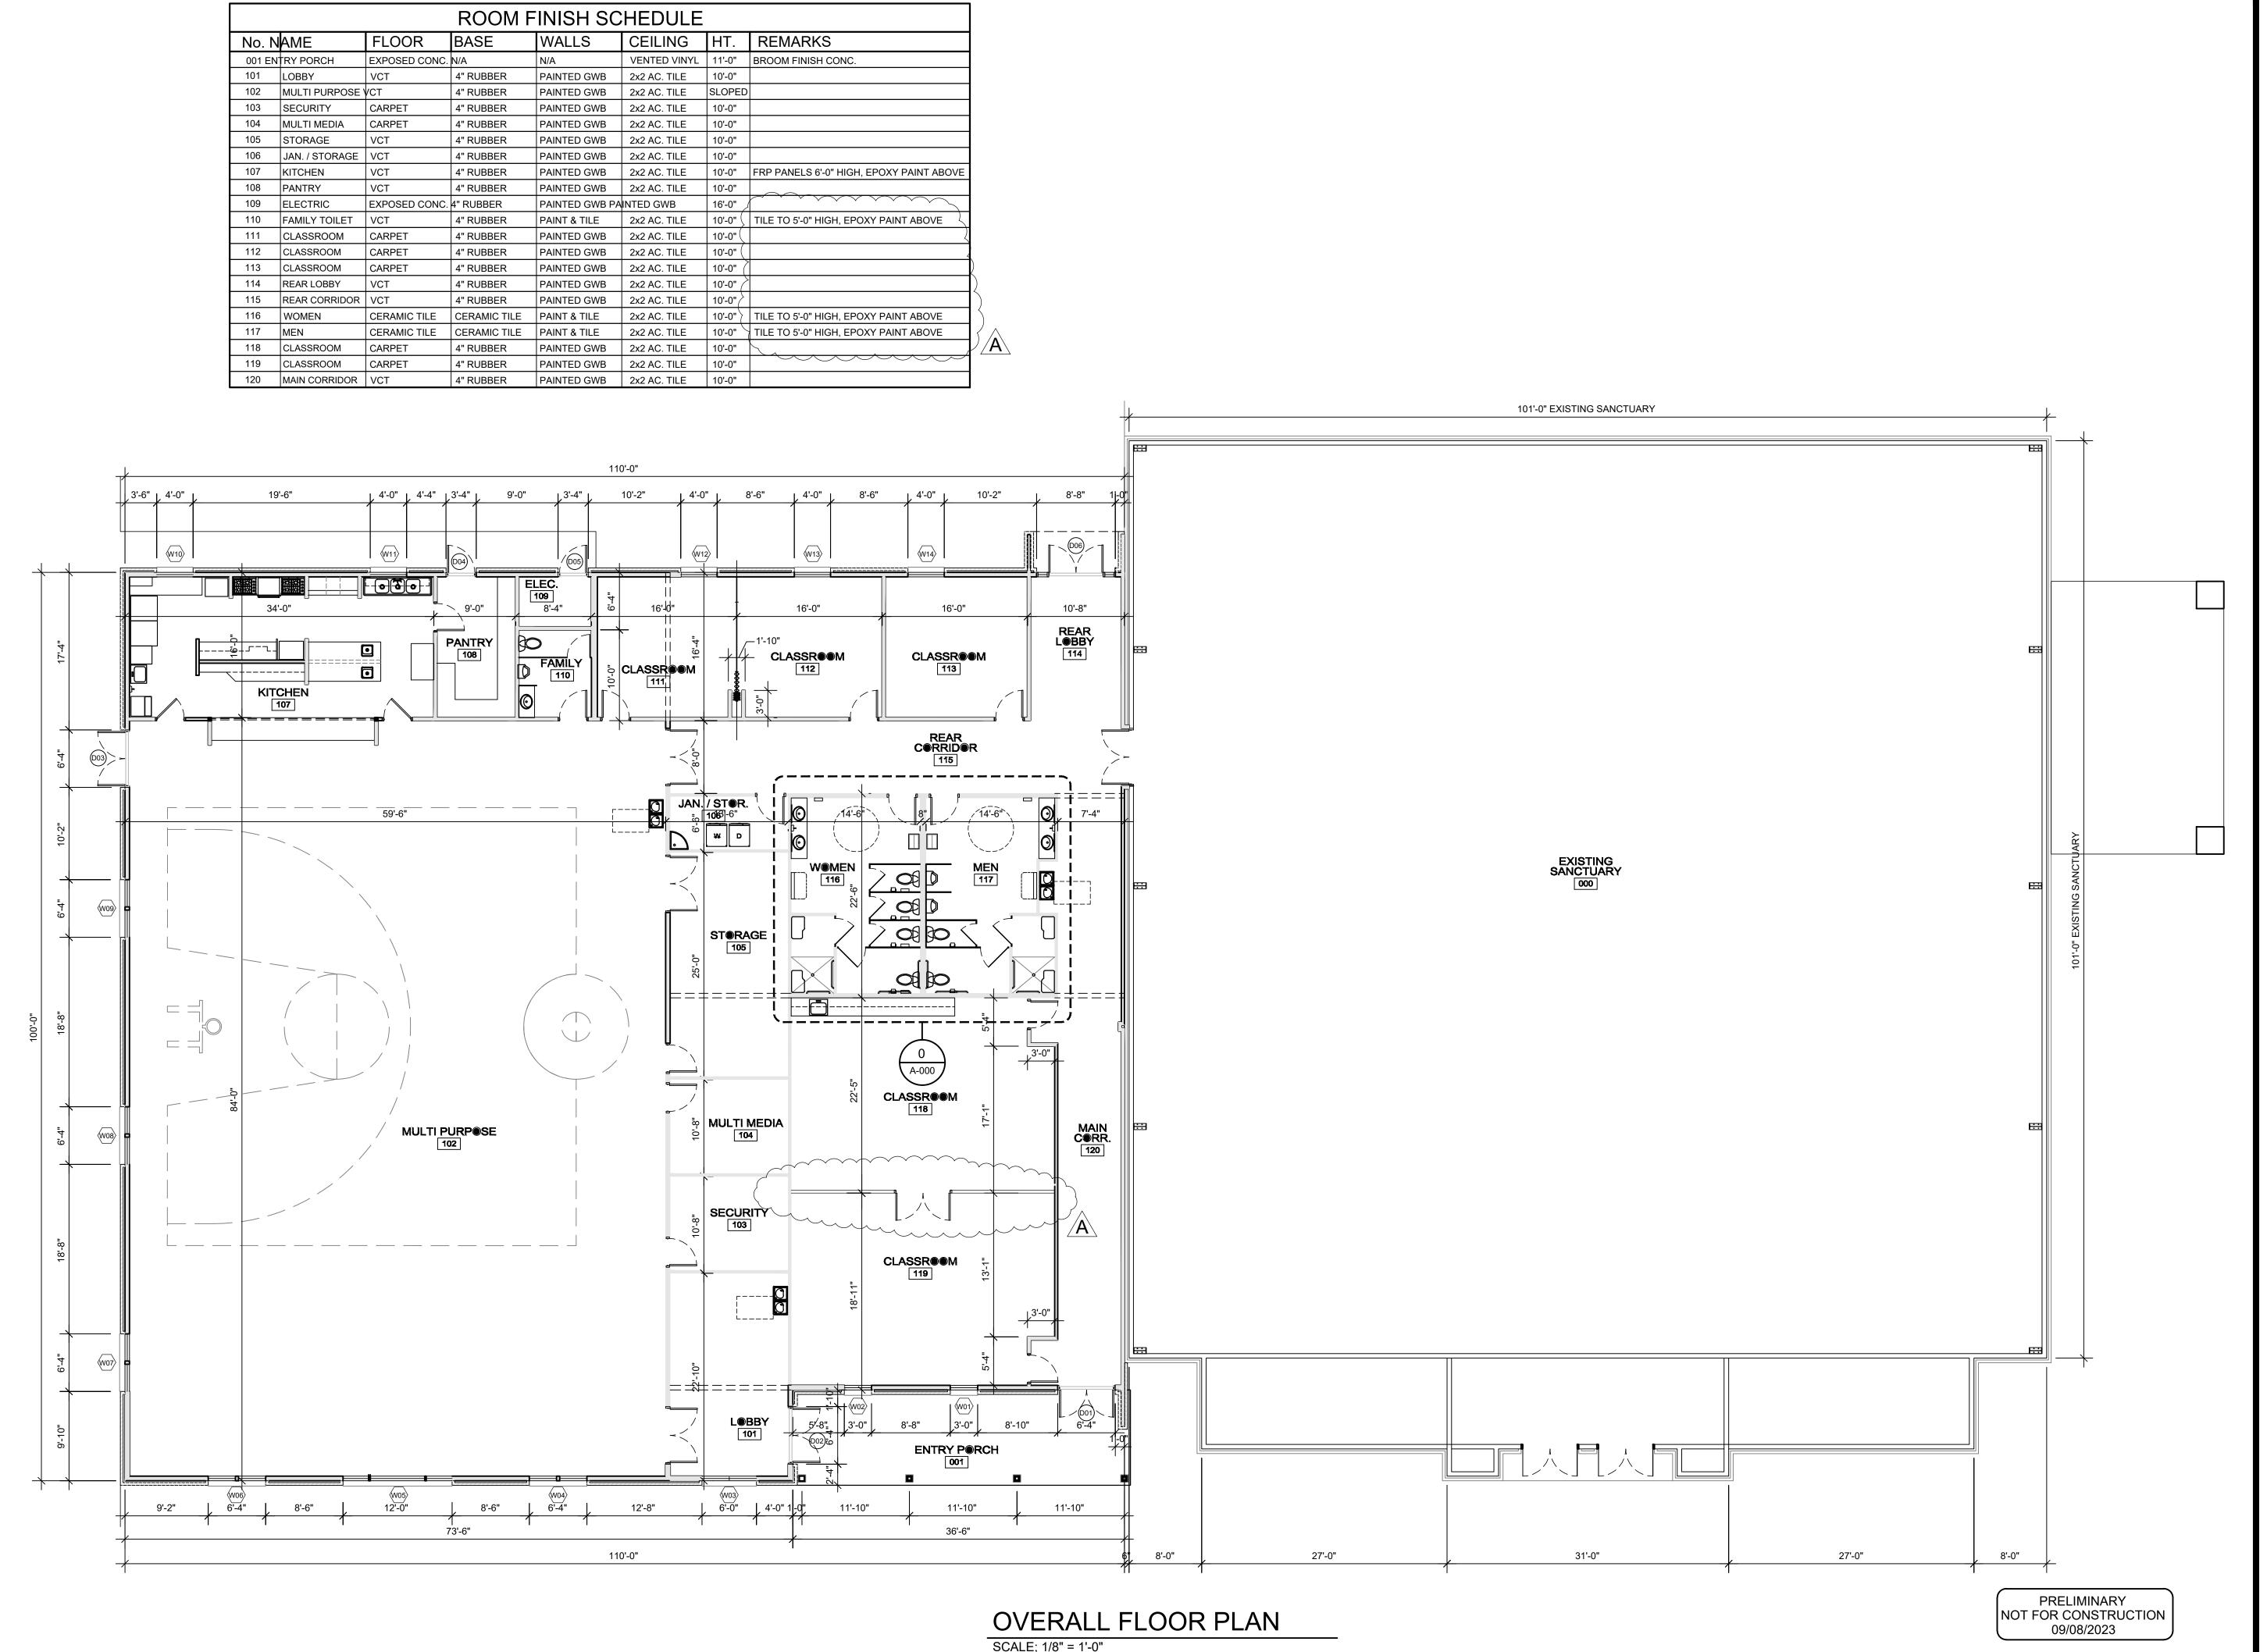

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Ministries Activity
Center Addition
Mount Pisgah Harnett
Original Free Will
Baptist Church

145 Prospect Church Road Erwin, NC.


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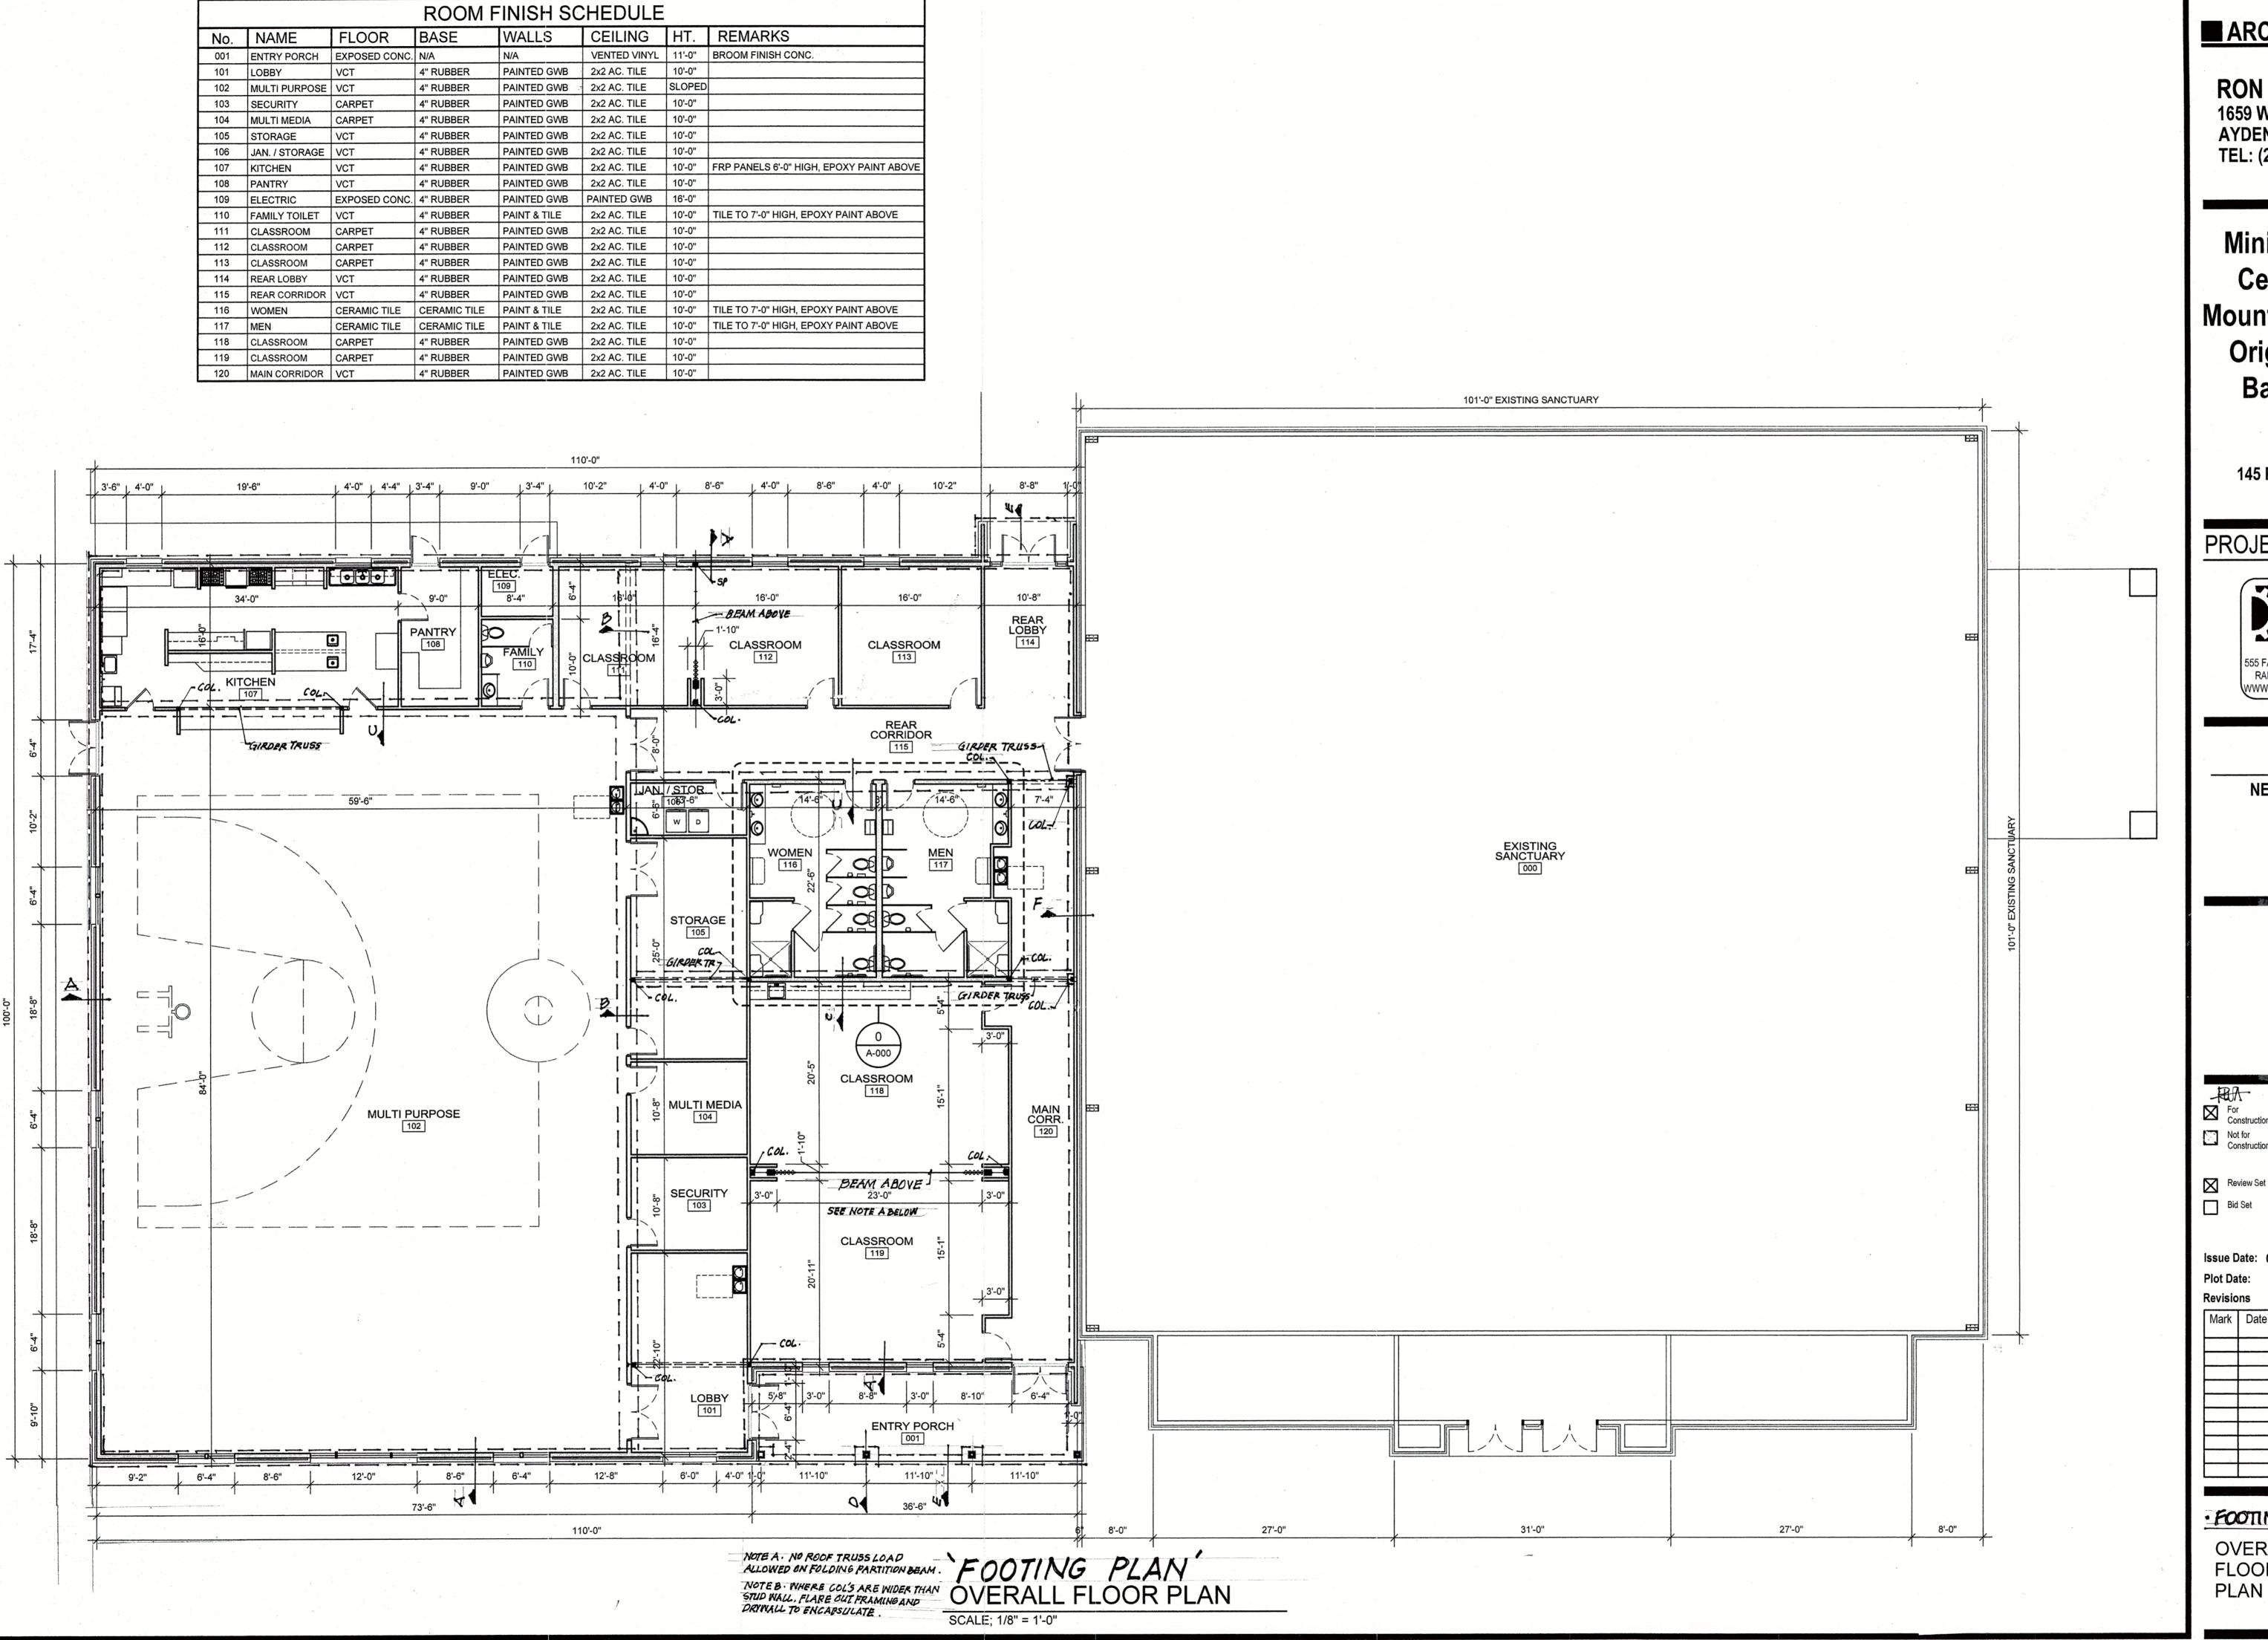
Plot Date:

Revisions

Mark	Date	Description
A	10-28-24	Lowered height of wall tile from 7'-0"
		to 5'-0" in schedule. Removed folding
		partition and added a wall and double
		door. Door type to be determined
		<u> </u>

Drawing No.

OVERALL FLOOR PLAN A1

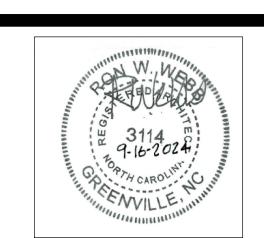

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Ministries Activity Center Addition Mount Pisgah Harnett Original Free Will **Baptist Church**

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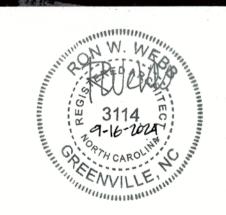
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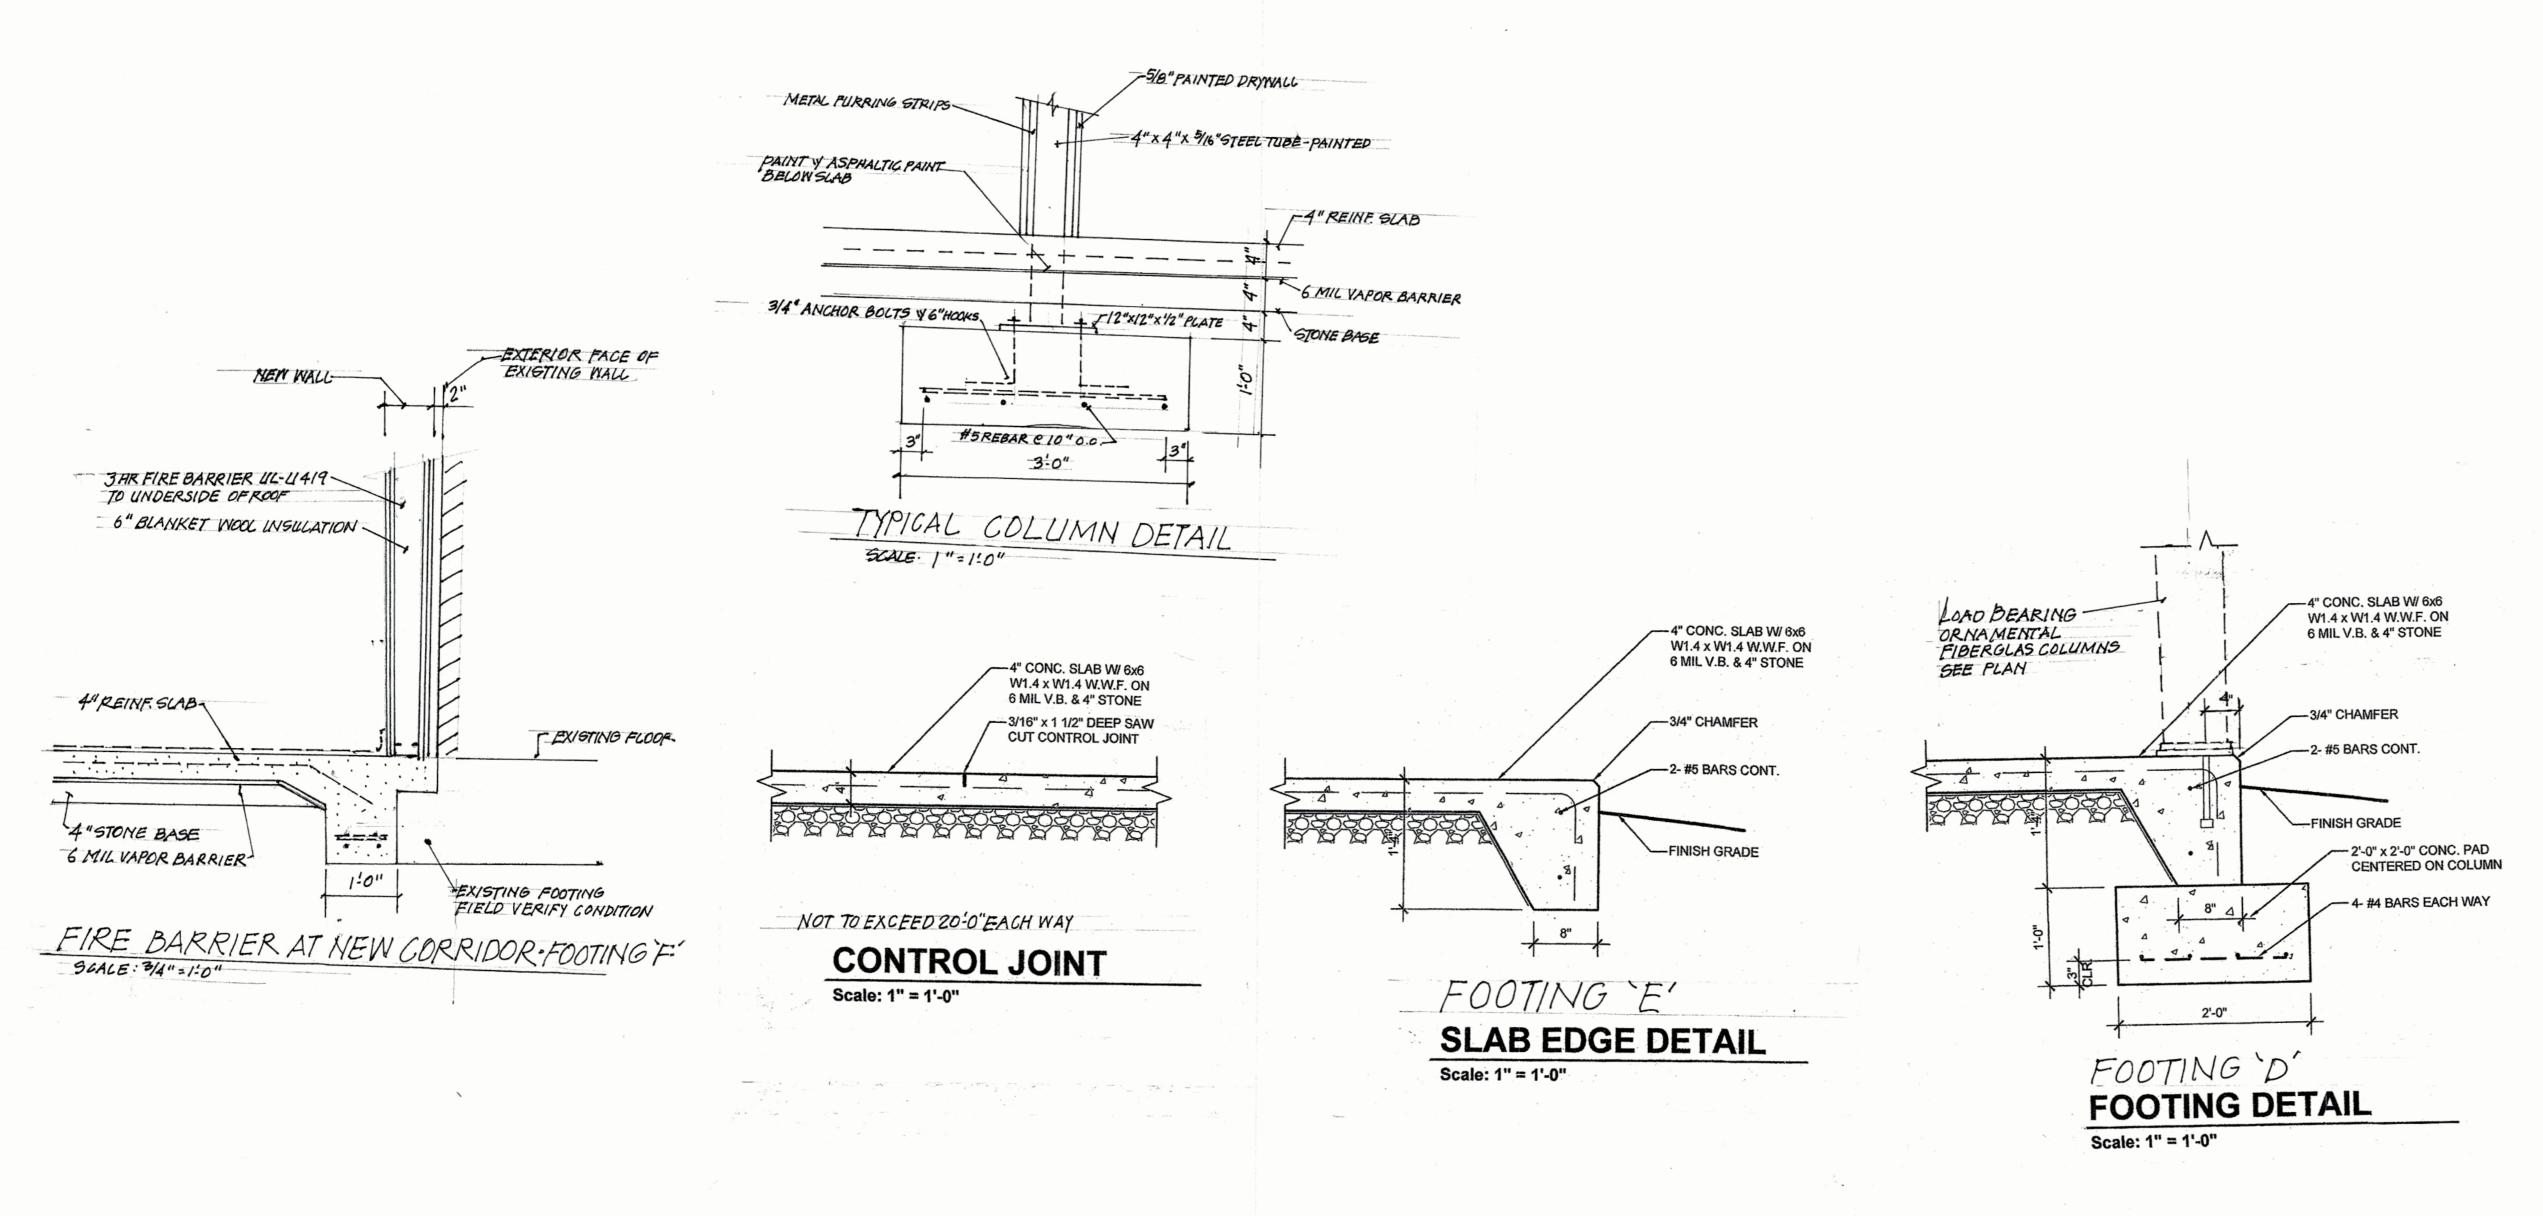
Issue Date: 09/20/2023


Plot Date: Revisions

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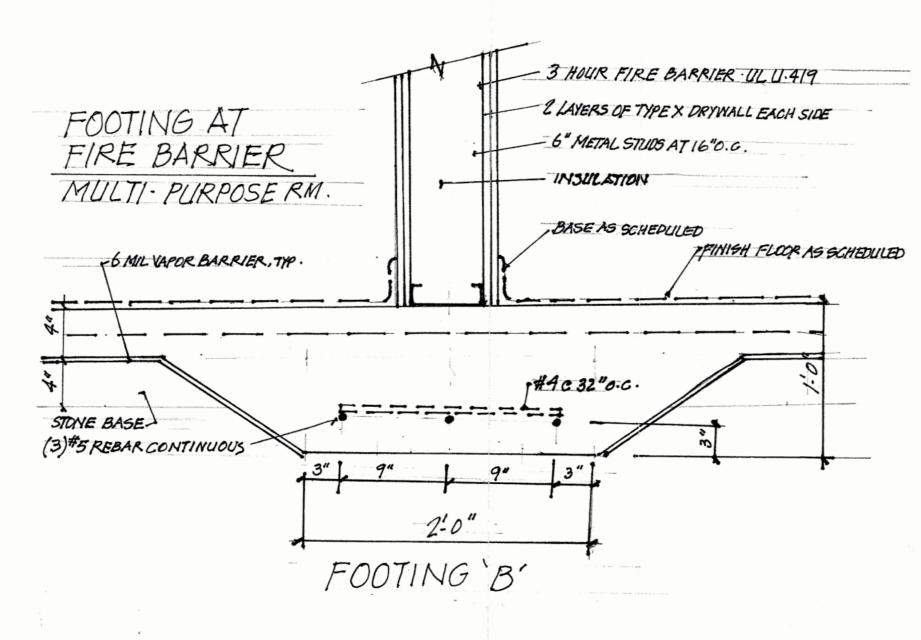
· FOOTING PLAN.


OVERALL FLOOR



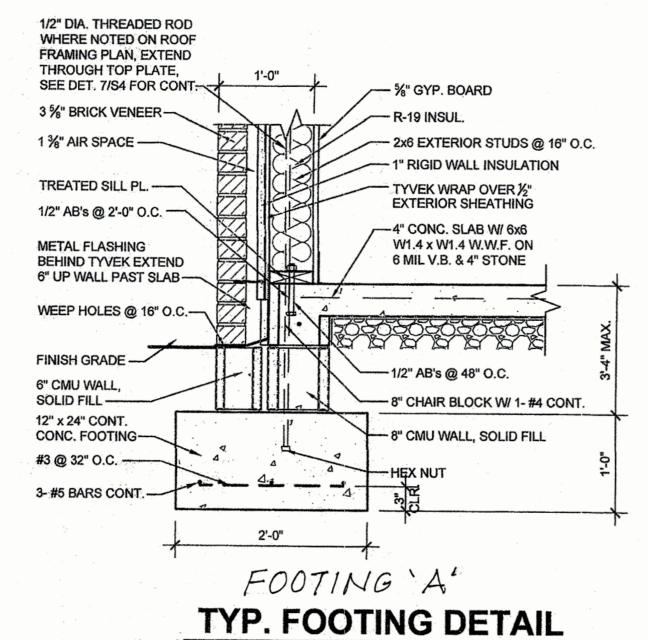

Scale: 1" = 1'-0"



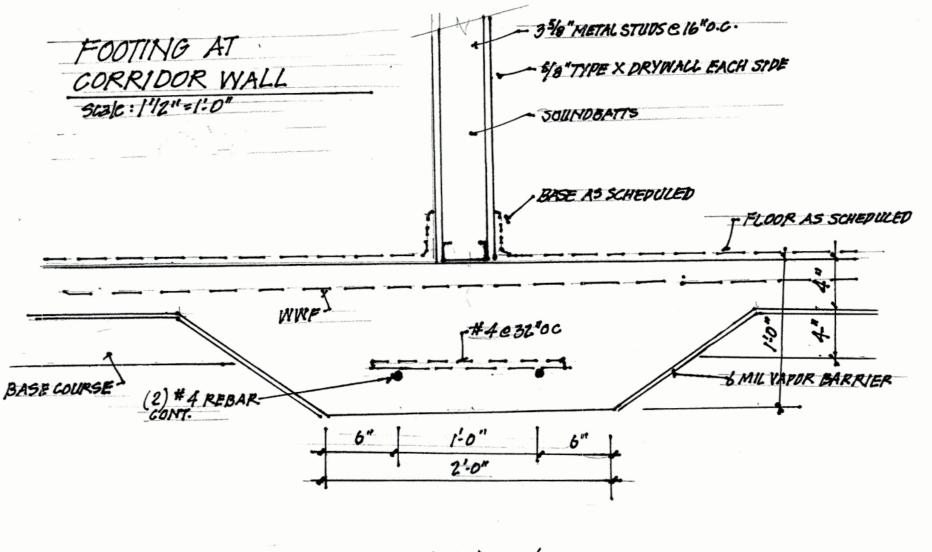

FOOTING C'

ARCHITECT

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Original Free Will
Baptist Church

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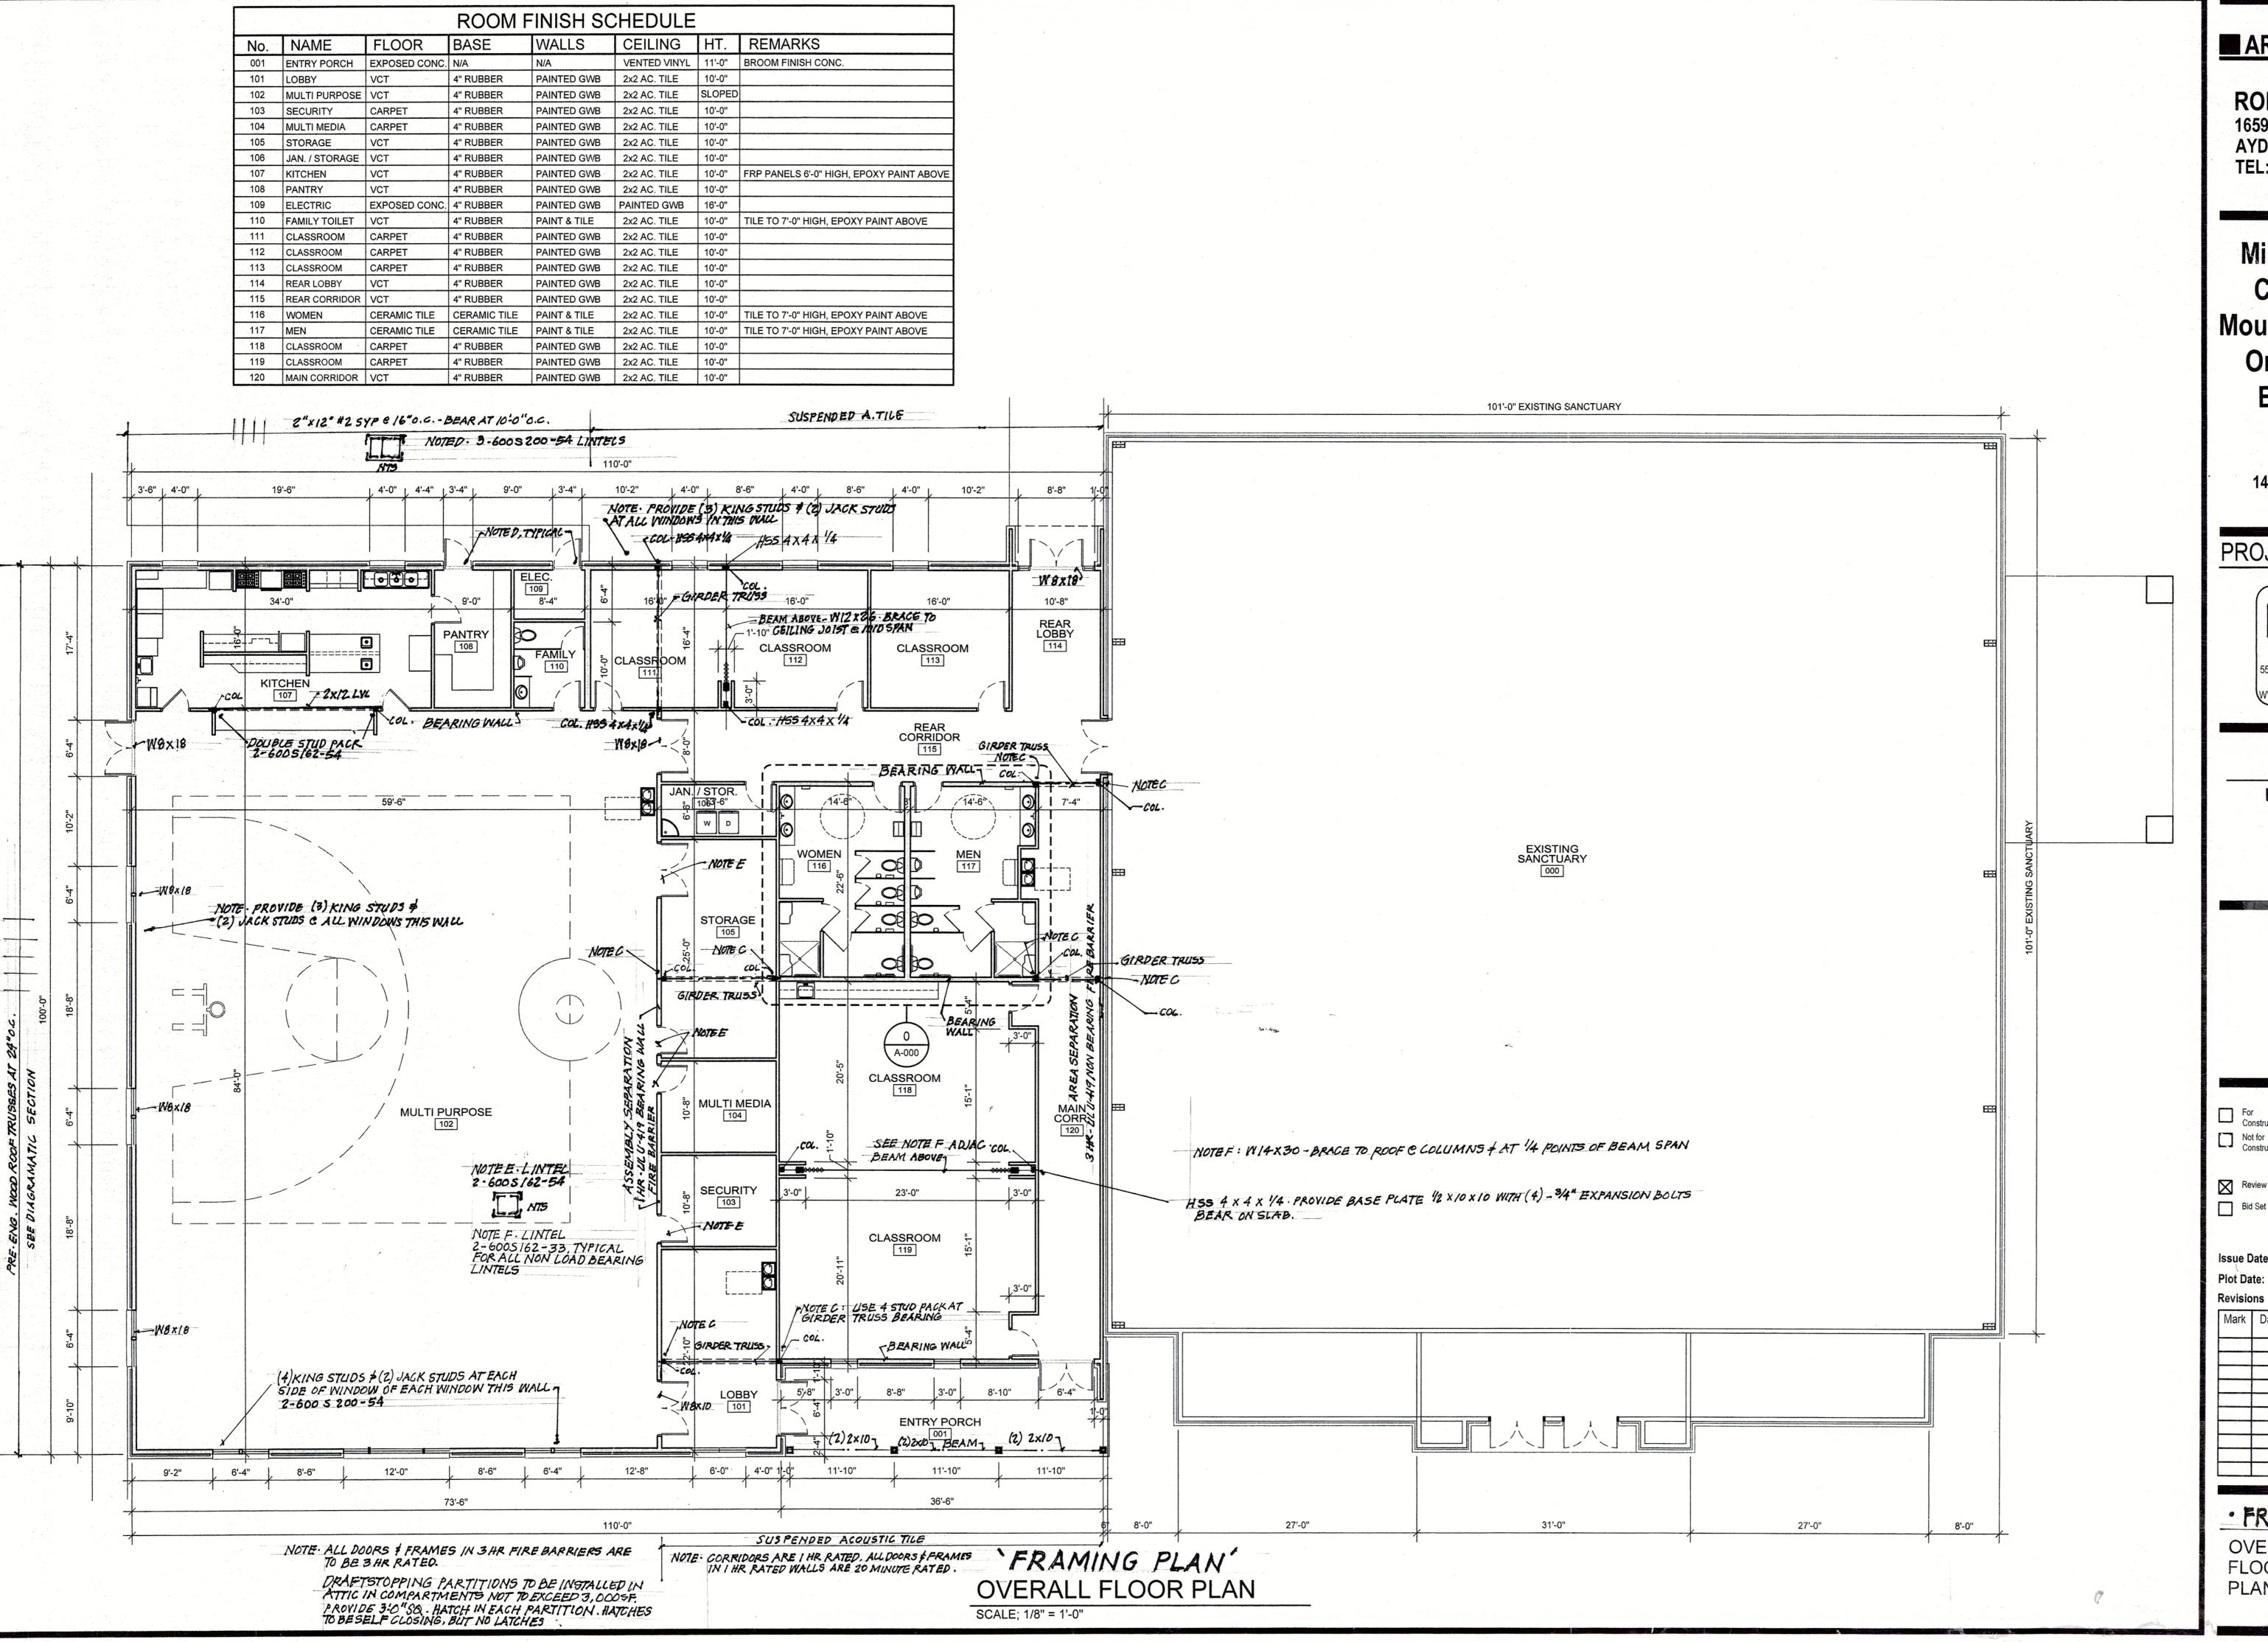
Mark	Date	Description

SHEET NAME

FOUNDATION DETAILS

Drawing No.

A-3



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> 145 Prospect Church Road Erwin, NC.

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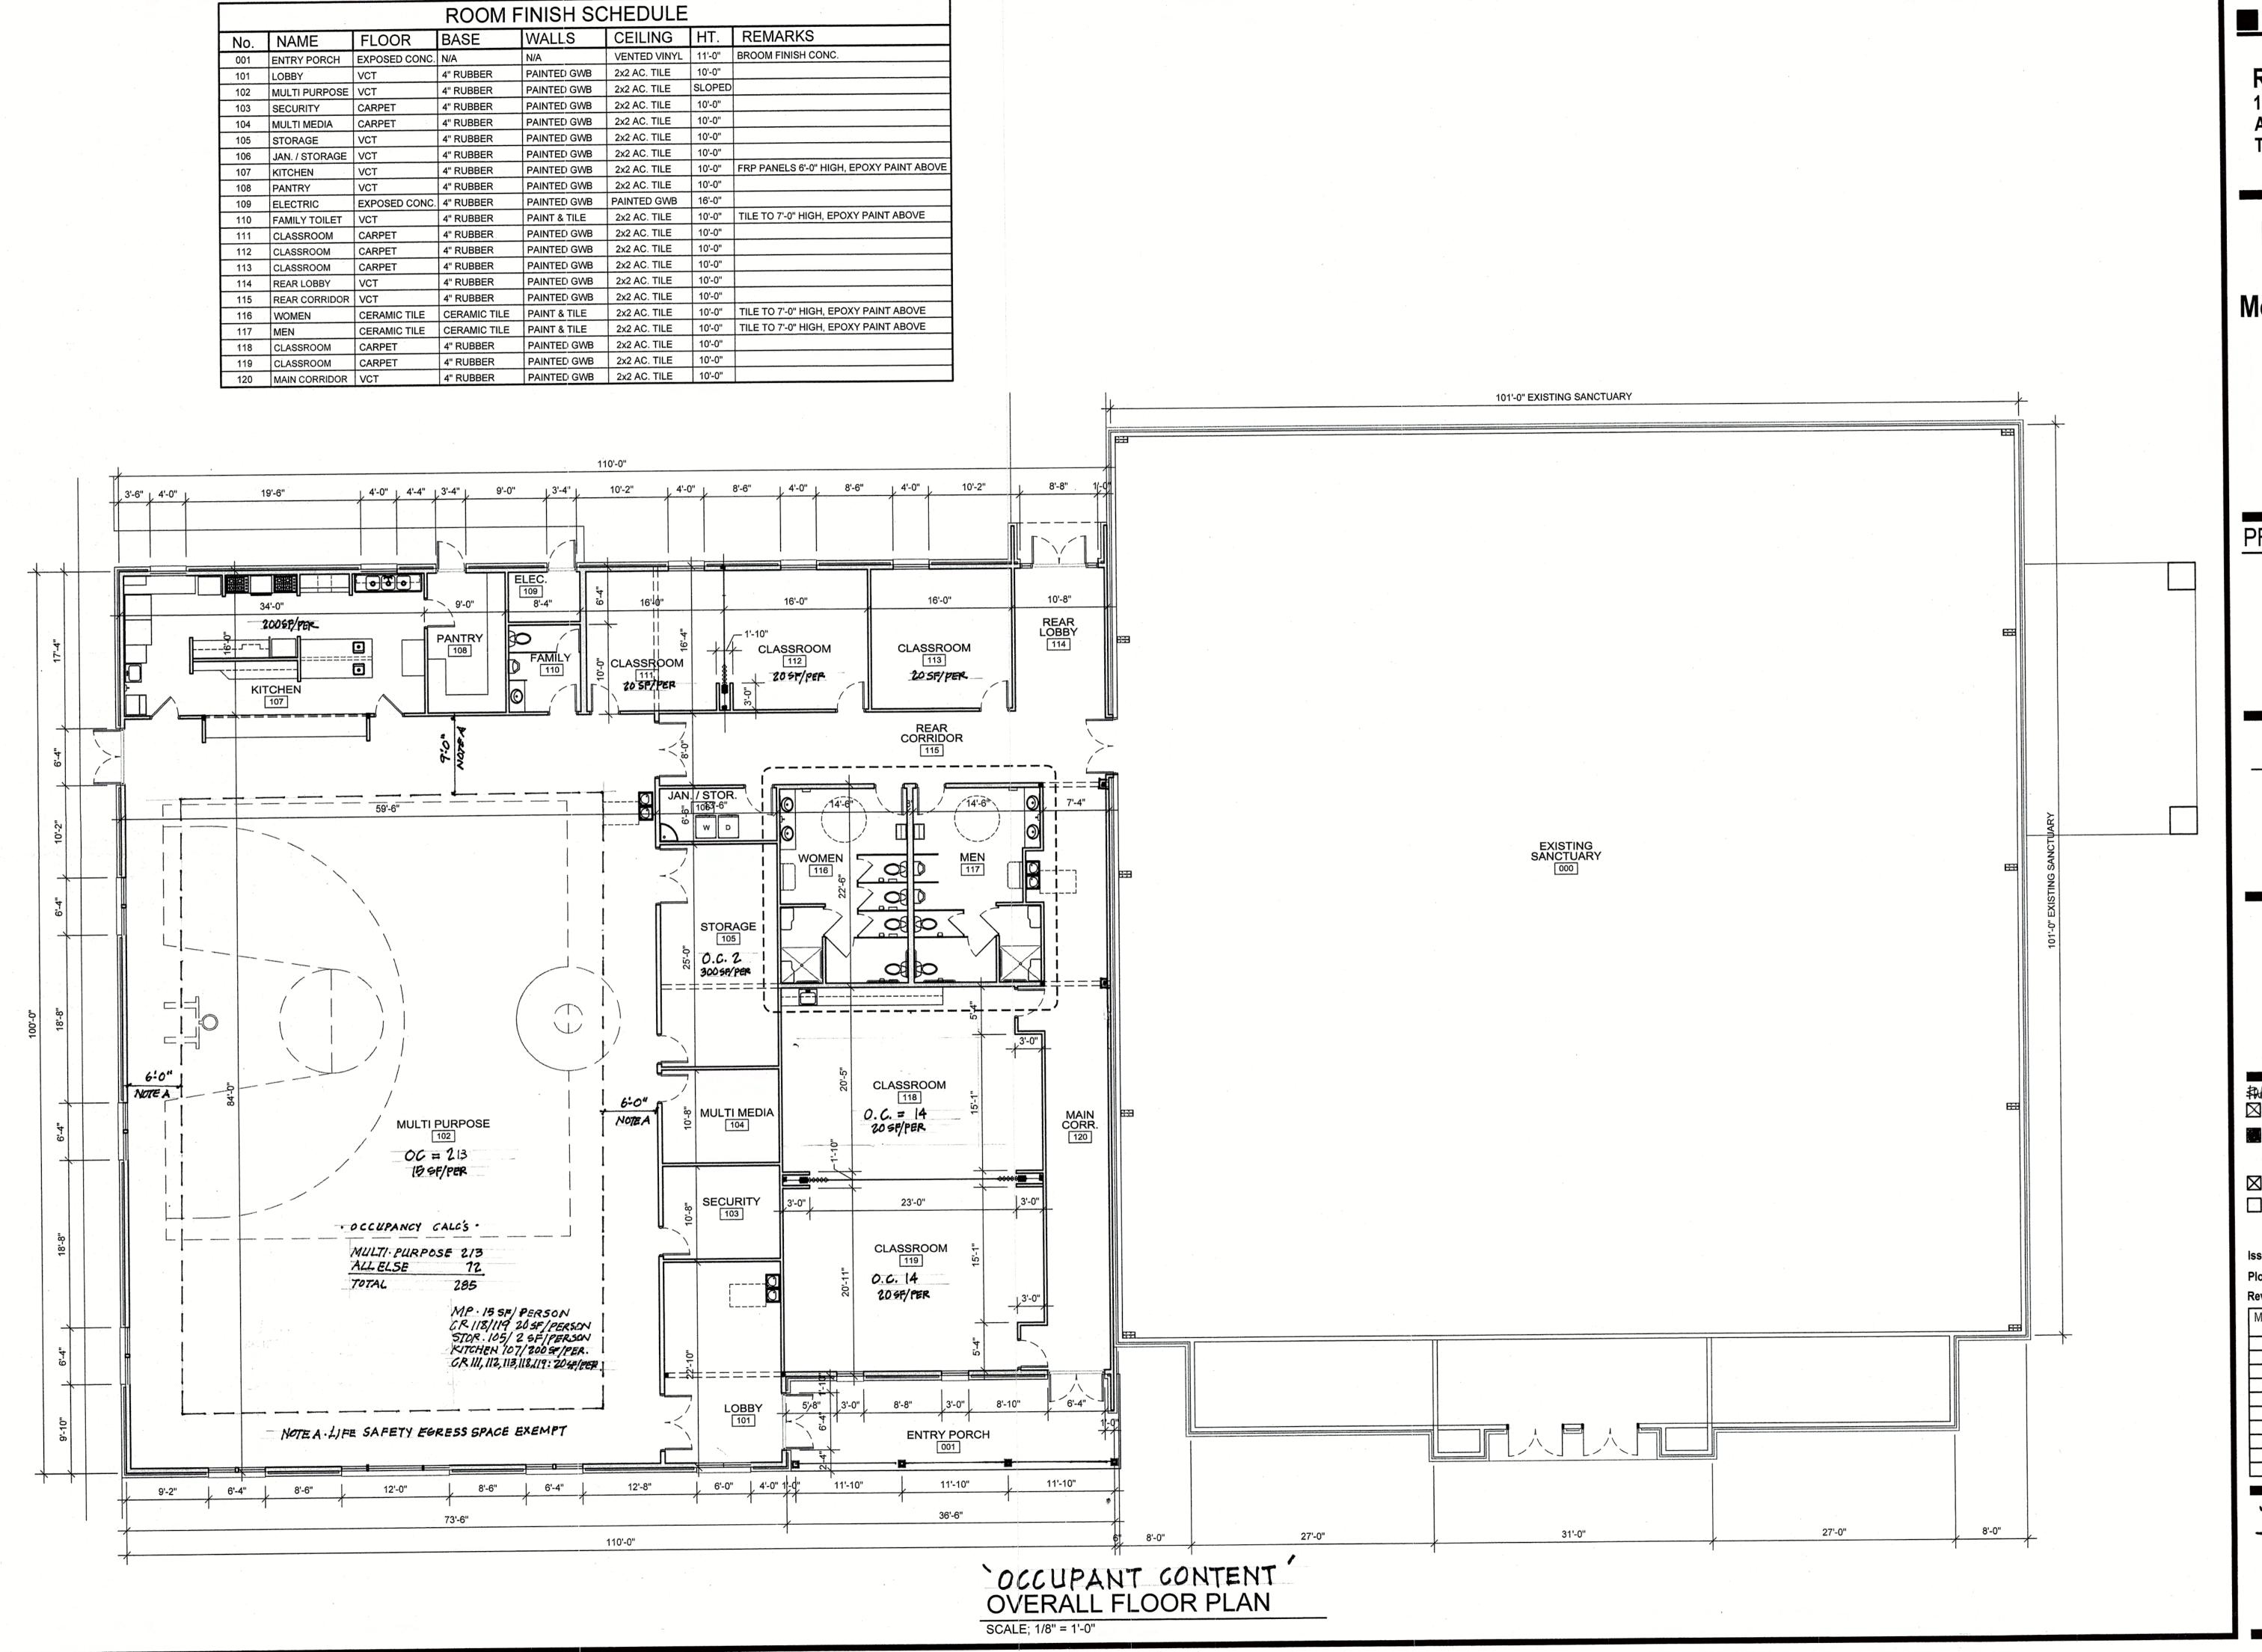
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Mark Date Description

· FRAMING PLAN.

OVERALL FLOOR



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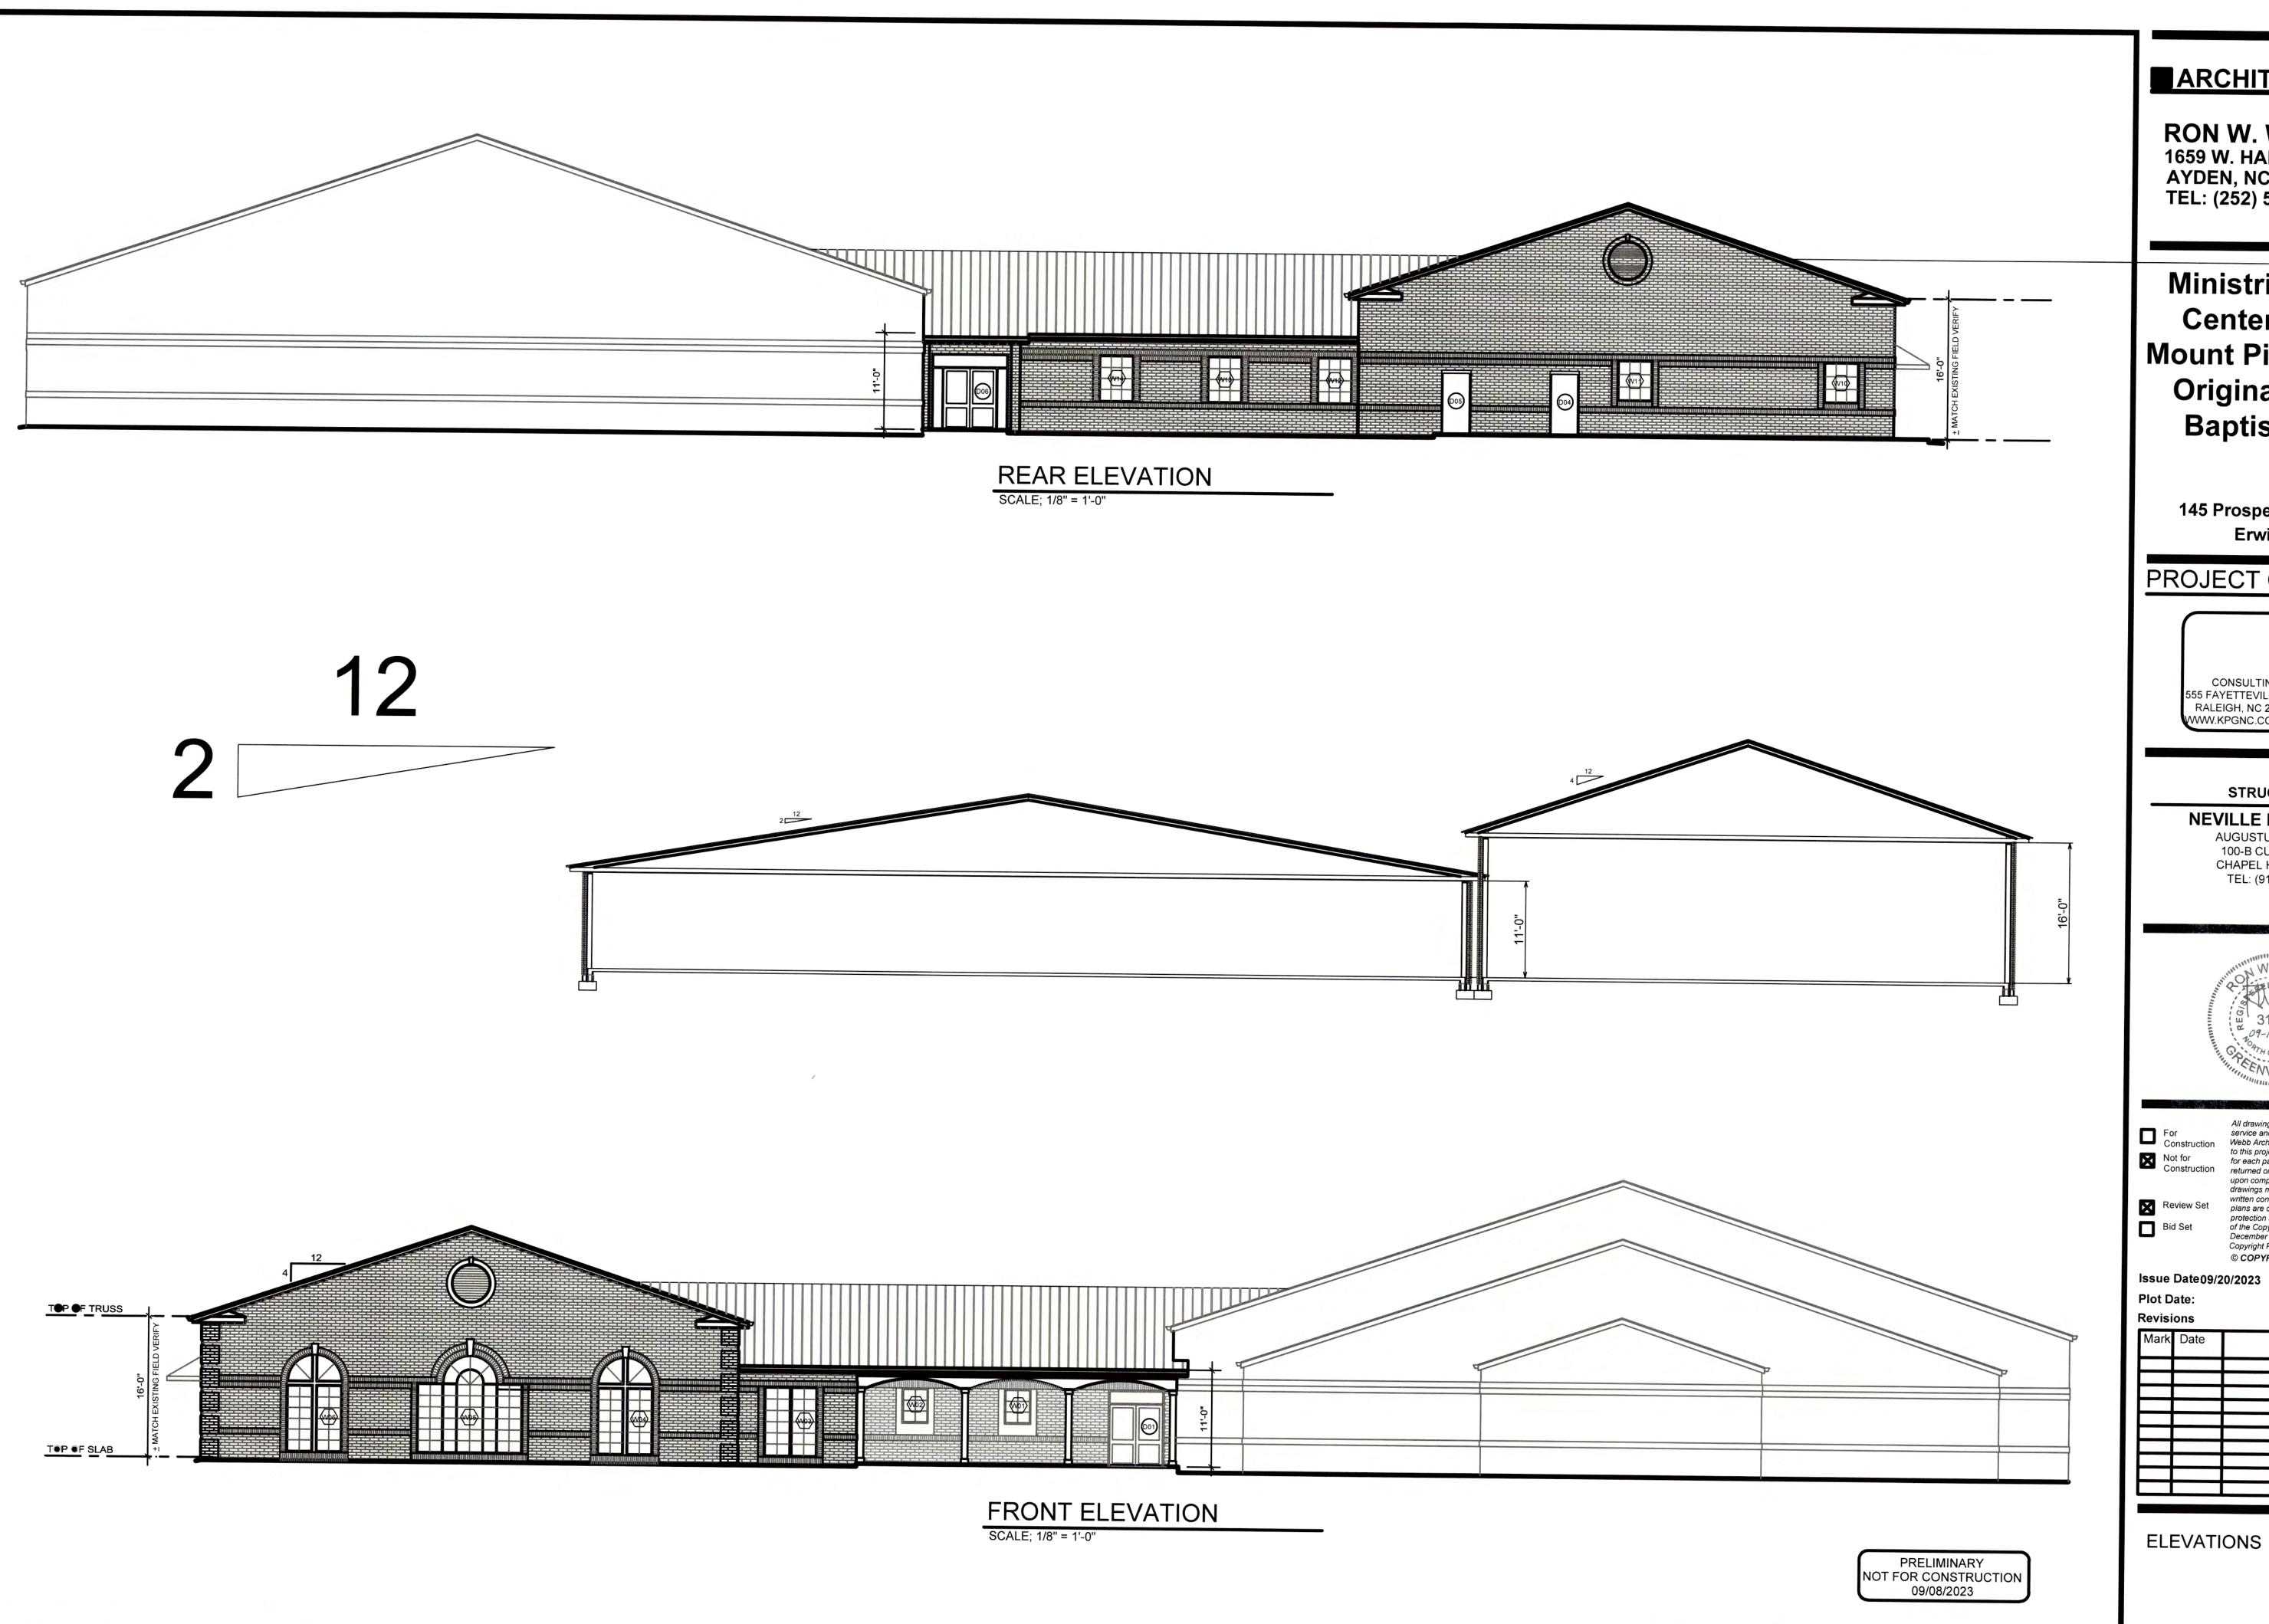
Plot Date:

Revisions

Mark	Date	Description
200		

OCCUPANT CONTENT'

FLOOR PLAN A-5



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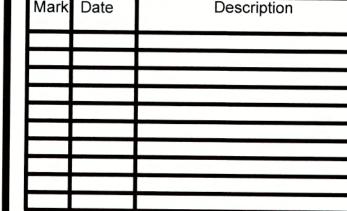
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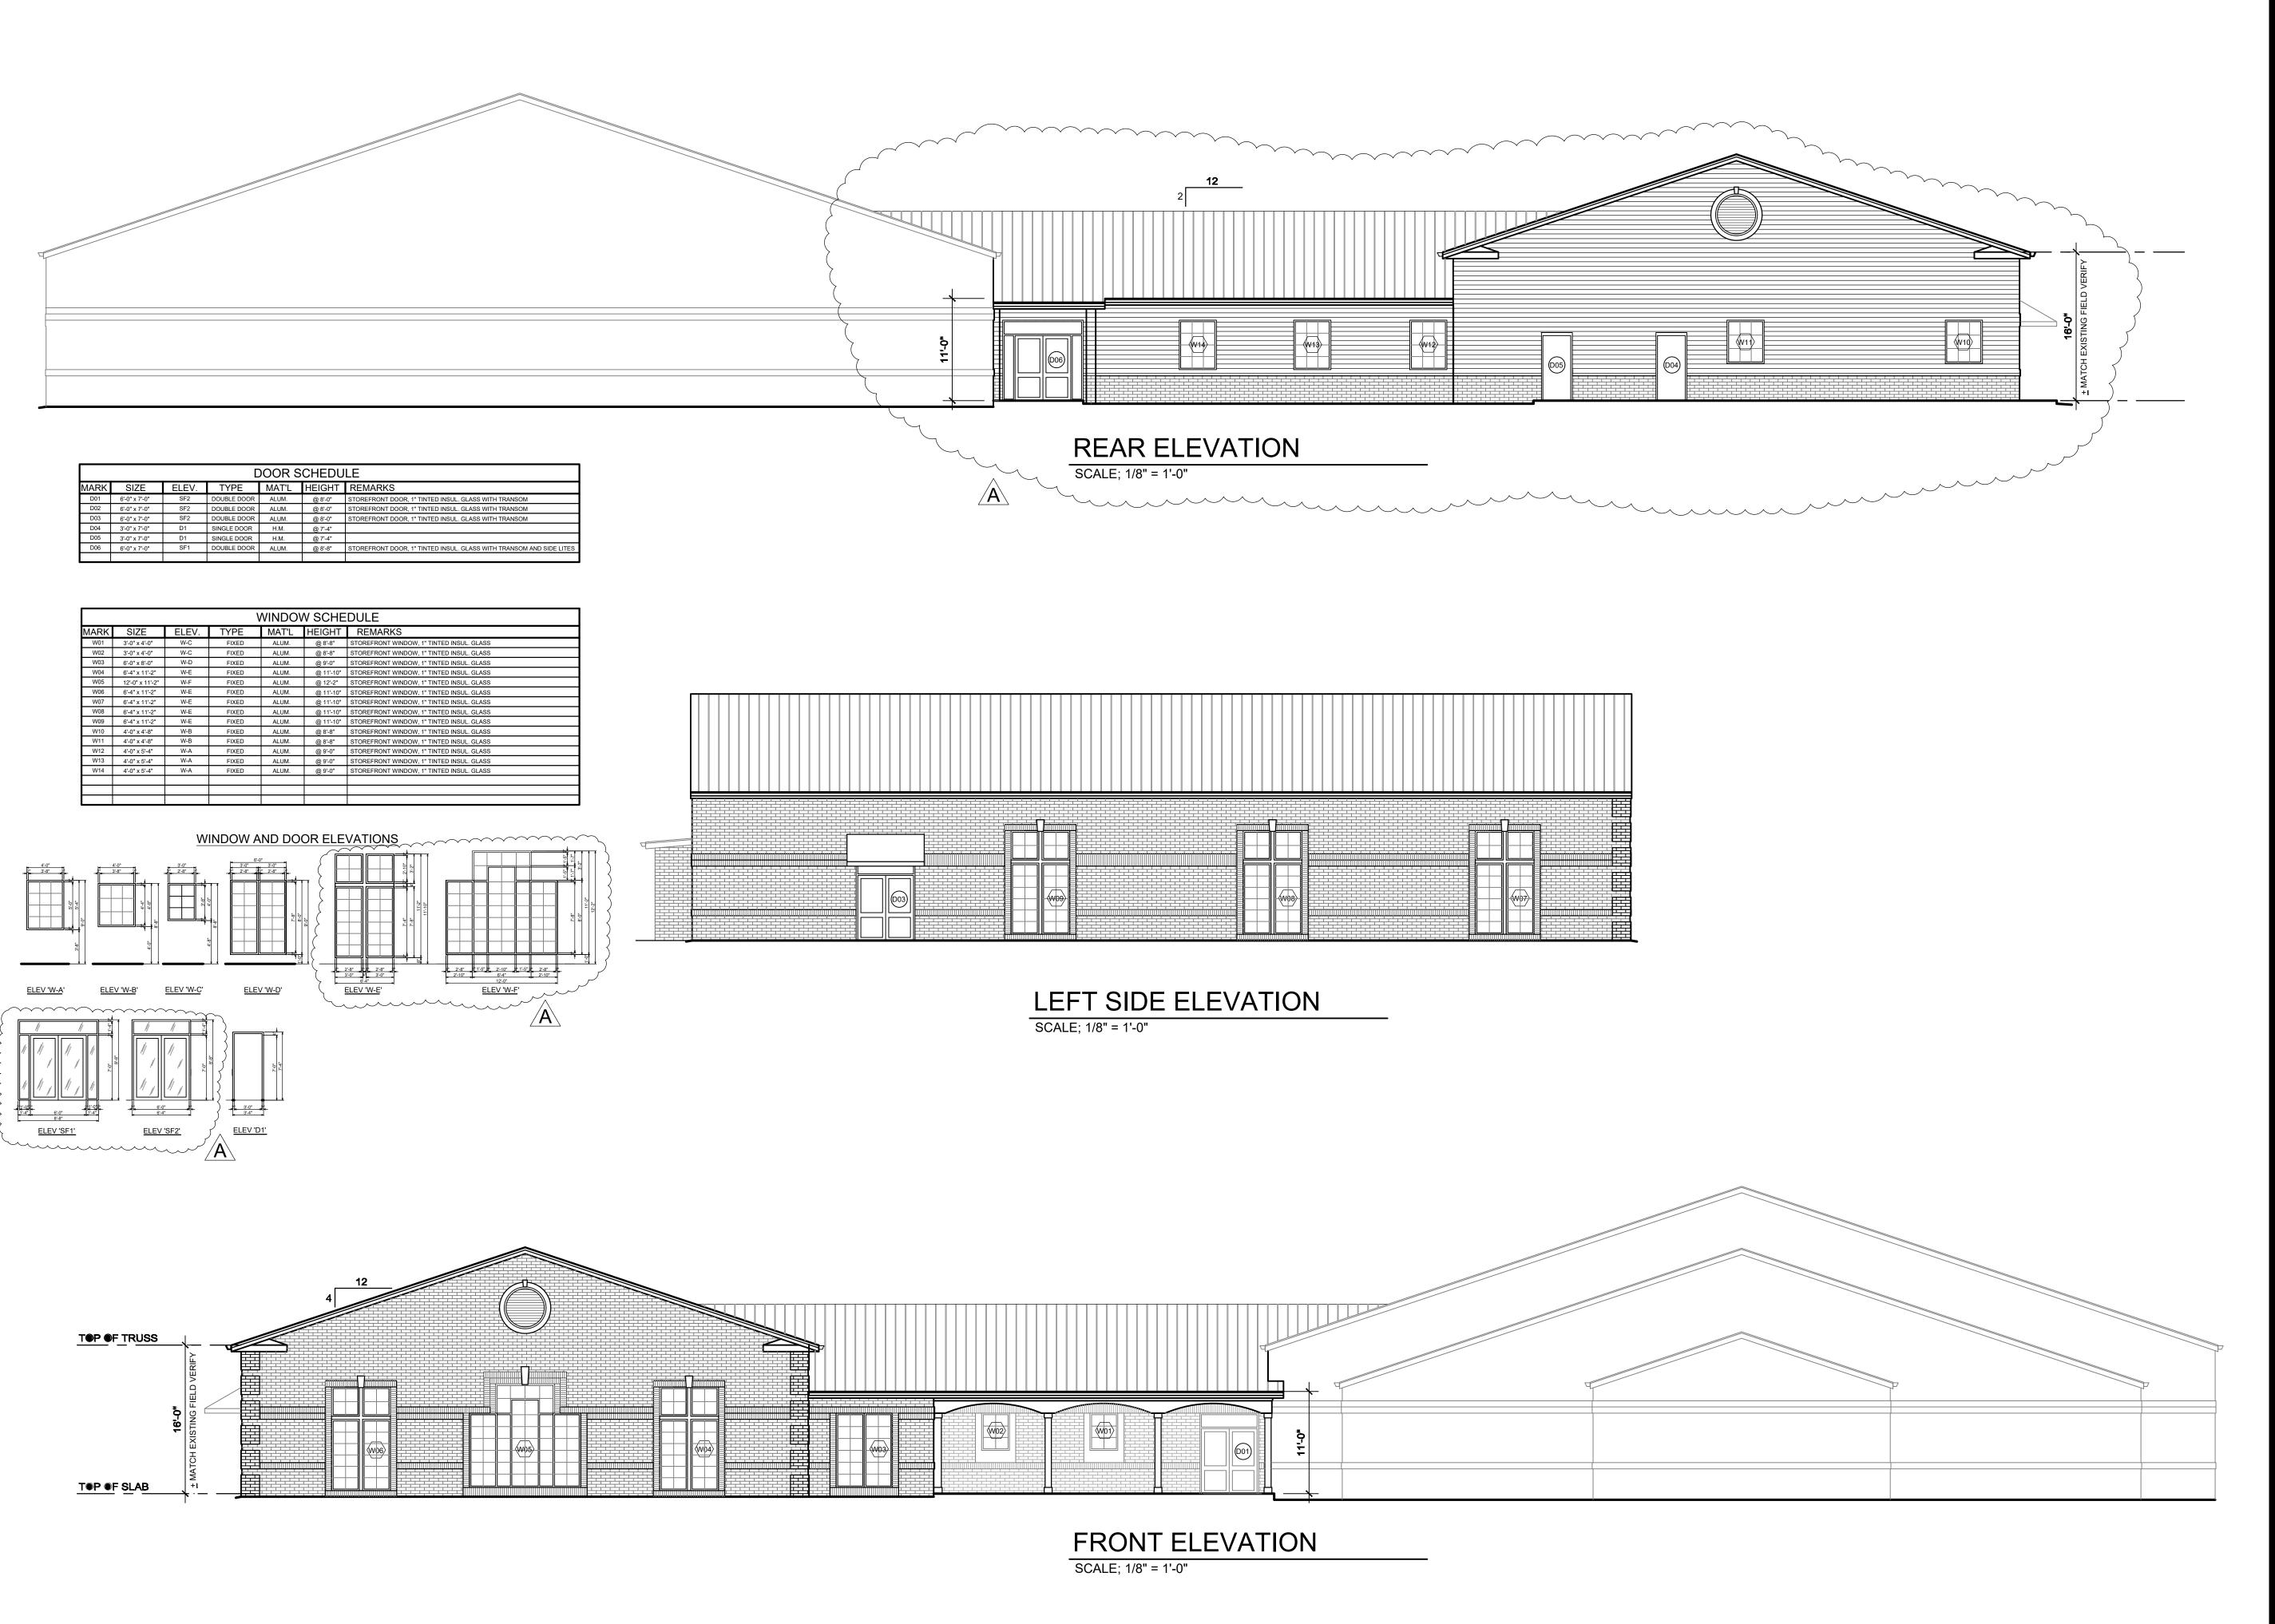


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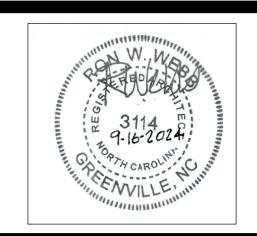
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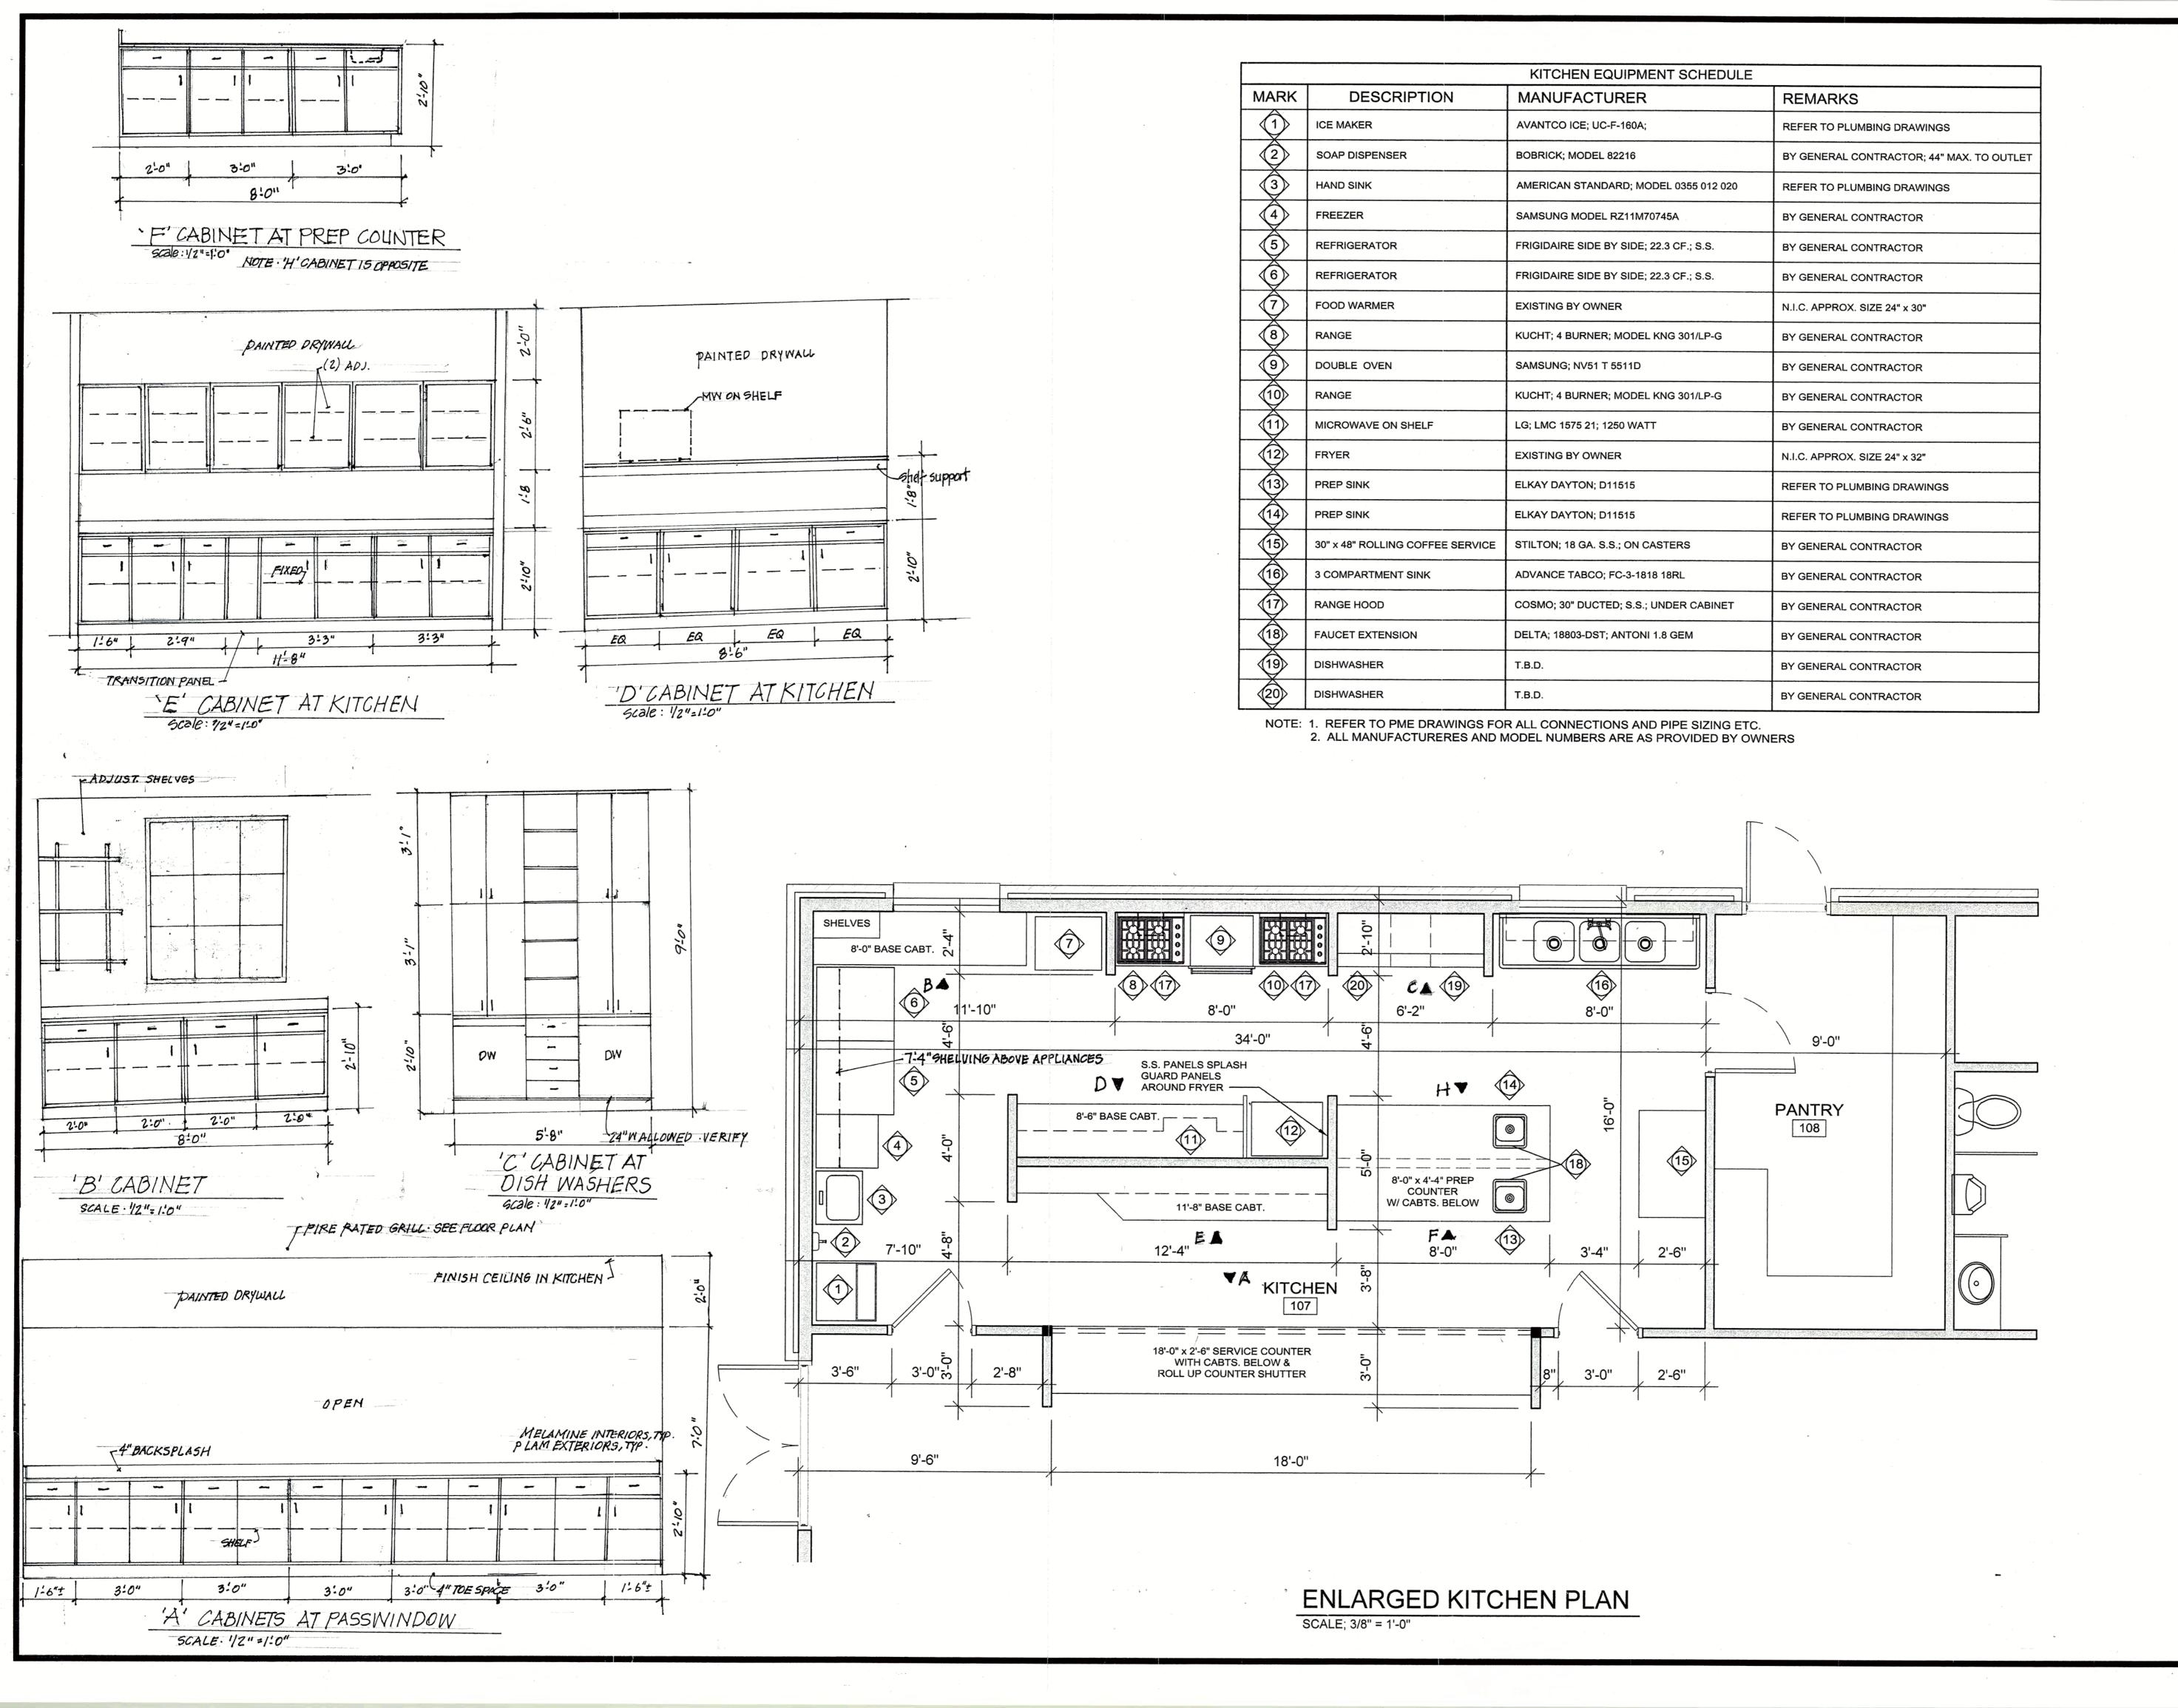
December 1990 and known as Architectural Works Copyright Protection Act of 1990 © COPYRIGHT 2020 Issue Date 09/20/2023

Plot Date:

Revisions

Mar	k Date	Description
A	10-28-24	Revised window types, changed brick veneer to hardie plank siding on rear elevation and removed mid rails from
		storefront doors

ELEVATIONS



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Issue Date: 09/20/2023

Plot Date: Revisions

Mark	Date	Description
-		
-		

ENLARGED KITCHEN PLAN

A-7

P. P. TRUSSES @ 24"0.C. TRUSS MULTI PURPOSE ADDITION (NOTSHOWN) SLAB NOTE SEE FOOTING DETAILS 4" REINF SLAB ON 6 MIL VAPOR BARRIER. 4"STONE BASE DIAGRAMMIC SECTION NOTE SEE ELECTRICAL FOR LIGHTS NOTE A: 5/8" PAINTED DRYWALL ON METAL FURRING STRIPS FRONT TO REAR WALL.

ARCHITECT

RON W. WEBB 1659 W. HANRAHAN ROAD AYDEN, NC. 28513 TEL: (252) 531-2711

Ministries Activity Center Addition Mount Pisgah Harnett Original Free Will Baptist Church

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Plot Date:

Revisions

Drawing No. SHEET NAME ·MISCELLANEOUS · DETAILS · A-8

Classrooms- 20sqft. net- 15x23x2= 690/20= 35 occ. 15x11x2= 330/20= 17 occ. Totals- 209+35+17= 261 Occupants 2018 APPENDIX B

BUILDING CODE SUMMARY FOR ALL COMMERCIAL PROJECTS (EXCEPT 1 AND 2-FAMILY DWELLINGS AND TOWNHOUSES) (Reproduce the following data on the building plans sheet 1 or 2)

					11CH also
	: Mount Pisgah Harnett C		Baptist Church- Life		
	rospect Church Rd., Erwir				de _28339
Owner/Authoriz	ed Agent: Reginald Hinton		#(<u>919</u>) <u>215</u>		rhinton528@gmail.com
Owned By:	☐ Ci	ity/County	Private	☐ Sta	
Code Enforceme	ent Jurisdiction: C	ity	☑ County	Sta	ite
	we want was				
CONTACT:					
DESIGNER	FIRM	NAME	LICENSE #	TELEPHONE #	E-MAIL
Architectural	Ron W. Webb, Architect	Ron W. Webb	51408	252-531-2711	wgarryowen@cs.com
Civil					
Electrical	Karios Project Group	Ben Lewis	3824	919-741-8223	blewis@kpgnc.com
Fire Alarm	Varian Designat Comun	Ben Lewis	3824	919-741-8223	blewis@kpgnc.com
Plumbing Mechanical	Karios Project Group Karios Project Group	Ben Lewis	3824	919-741-8223	blewis@kpgnc.com
Sprinkler-Stand					
Structural	Neville Engineering			919-740-3427	
_	>5' High				
Other	include firms and individ	uals such as truss	preget pre engin	paged interior desi	gners etc.)
("Other should	include firms and individ	uais such as truss,	precasi, pre-engin	icered, interior desi	gilors, etc.)
2018 NC BUIL	DING CODE: New	Building	Addition	Renovation	
		ime Interior Com			
	_			jurisdiction for po	ssible additional
		edures and require			
					ion jurisdiction for
	poss	ible additional pro	cedures and requir	rements	
2018 NC EXIST	TING BUILDING COD	E: EXISTING:	☐ Prescriptive	☐ Repair ☐	Chapter 14
		Alteration:	Level I	Level II	Level III
			☐ Historic Prop	erty [Change of Use
CONSTRU	CTED: (date)	CURRI	ENT OCCUPANO	CY(S) (Ch. 3): _	
RENOVAT			SED OCCUPAN	NCY(S) (Ch. 3):	A3
				III 🗆 IV	
RISK CATEGORY (Table 1604.5): Current: I I III III IV Proposed: I I III III IV					
		Troposeu. [
BASIC BUILD	ING DATA	Troposcu. [J. U. U		

☑ No ☐ Yes Class ☐ I ☐ II ☐ III ☐ Wet ☐ Dry

Special Inspections Required:
No Yes (Contact the local inspection jurisdiction for additional

2018 NC Administrative Code and Policies

✓ No ☐ Partial ☐ Yes

Revised 6/15/2020

□ NFPA 13 □ NFPA 13R □ NFPA 13D

Flood Hazard Area: No Yes

procedures and requirements.)

	Gross Building Area Table	Note to plan reviewer:
Everne (so et)		SUB-TOTAL
FLOOR EXISTING (SQ FT) Std Floor 0	NEW (SQ FT)	0
2 nd Floor 0	0	0
Mezzanine 0	0	0
1st Floor 0	11000	0
Basement 0		0
TOTAL 0	11000	0
	ALLOWABLE AREA	Note to plan reviewer:
rimary Occupancy Classification(s):		Classrooms shown are considered A3 occupancy as accereligious rooms < 100 occupant load. NCSBC Sect. 303.1.4
Assembly A-1 A-2	A-3 A-4 A-5	
Business		
Educational		
Factory F-1 Moderate F	-2 Low	
	I-2 Deflagrate H-3 Combus	t H-4 Health H-5 HPM
Institutional I-1 Condition I 1		
☐ I-2 Condition ☐ 1		
☐ I-3 Condition ☐ 1		٦5
□ I-4		-
Mercantile		
Residential R-1 R-2	R-3 П R-4	
Storage S-1 Moderate		
	Open Enclosed Repair	Garage
	Open	Galage
Utility and Miscellaneous	04.01	4
ccessory Occupancy Classification(s):		
pecial Uses (Chapter 4 – List Code Se	ctions):	
pecial Provisions: (Chapter 5 – List C	ode Sections):	
lixed Occupancy: 🛛 No 🔲 Y	es Separation: Hr.	Exception:
Non-Separated Use (508.3) -	applying the height and area li occupancies to the entire build	ion for the building shall be determined by mitations for each of the applicable ling. The most restrictive type of hall apply to the entire building.
be s	below for area calculations for each that the sum of the ratios of allowable floor area for each use	each story, the area of the occupancy shall the actual floor area of each use divided by e shall not exceed 1.
<u>Actual Area of Occupancy A</u> Allowable Area of Occupancy A	+ <u>Actual Area of Occup</u> Allowable Area of Occu	

STORY NO.	DESCRIPTION AND USE	(A) BLDG AREA PER STORY (ACTUAL)	(B) TABLE 506.24 AREA	(C) AREA FOR FRONTAGE INCREASE ^{1,5}	(D) ALLOWABLE AREA PER STORY OR UNLIMITED ^{2,3}
1	A3- Life Center &	11000	9500	4750	14250
	Classrooms				

¹ Frontage area increases from Section 506.3 are computed thus:

Frontage area increases from Section 500.3 are computed thus:

a. Perimeter which fronts a public way or open space having 20 feet minimum width = 320 (F)

b. Total Building Perimeter = 420 (P)

c. Ratio (F/P) = 76 (F/P)

d. W = Minimum width of public way = 30 (W)

e. Percent of frontage increase $I_f = 100[F/P - 0.25] \times W/30 = 50$ (%)

² Unlimited area applicable under conditions of Section 507.

³ Maximum Building Area = total number of stories in the building x D (maximum3 stories) (506.2).

⁴ The maximum area of open parking garages must comply with Table 406.5.4. ⁵ Frontage increase is based on the unsprinklered area value in Table 506.2.

ALLOWABLE HEIGHT

ALLOWABLE	SHOWN ON PLANS	CODE REFERENCE 1
55	16	
2	1	
		53.573, 61.712, 11.0

Provide code reference if the "Shown on Plans" quantity is not based on Table 504.3 or 504.4. ² The maximum height of air traffic control towers must comply with Table 412.3.1.

³ The maximum height of open parking garages must comply with Table 406.5.4.

2018 NC Administrative Code and Policies

Revised 6/15/2020

FIRE PROTECTION REQUIREMENTS

BUILDING ELEMENT	FIRE	RATING		DETAIL#	DESIGN#	SHEET # FOR	SHEET#
	SEPARATION DISTANCE (FEET)	REQ'D	PROVIDED (W/* REDUCTION)	AND SHEET #	FOR RATED ASSEMBLY	RATED PENETRATION	FOR RATED JOINTS
Structural Frame, including columns, girders, trusses							JOINIS
Bearing Walls							
Exterior							
North	>30'						
East	0	3hr.	3hr.		U419		
West	>30'						
South	>30'						
Interior					-		
Nonbearing Walls and Partitions					=		
Exterior walls							
North							
East						:	
West							
South							
Interior walls and partitions						-	
Floor Construction							
Including supporting beams		N/A					
and joists							
Floor Ceiling Assembly		N/A					
Columns Supporting Floors		N/A					
Roof Construction, including supporting beams and joists		N/A					
Roof Ceiling Assembly		N/A					
Columns Supporting Roof		N/A					
Shaft Enclosures - Exit		N/A					
Shaft Enclosures - Other		N/A					
Corridor Separation		1 hr.	1 hr.		U305- wall	T722.6.2(1)	Ceiling
Occupancy/Fire Barrier Separation	on	N/A				3.2(.)	
Party/Fire Wall Separation	- '	3 hr.	3 hr.		U419		
Smoke Barrier Separation		N/A					
Smoke Partition		N/A					
Tenant/Dwelling Unit/ Sleeping Unit Separation		N/A					
ncidental Use Separation		N/A					

NCSBC T722.6.2(1)- For ceiling- 2 layers 5/8" Type X= 80 minutes. 60 minutes required.

2018 NC Administrative Code and Policies

2018 NC Administrative Code and Policies

Local Jurisdiction

ARCHITECT

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Ministries Activity Center Addition Mount Pisgah Harnett Original Free Will **Baptist Church**

> 145 Prospect Church Road Erwin, NC.

Project Consultants



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NEVILLE ENGINEERING

AUGUSTUS NEVILLE, PE 100-B CULBRETH RD. CHAPEL HILL, NC 27516 TEL: (919) 740-3427



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NAME

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Revised 6/15/2020

PERCENTAGE OF WALL OPENING CALCULATIONS

LIFE SAFETY SYSTEM REQUIREMENTS

LIFE SAFETY PLAN REQUIREMENTS

Maximum calculated occupant load capacity each exit door can accommodate based on egress width (1005.3)

A separate schematic plan indicating where fire rated floor/ceiling and/or roof structure is provided for

ALLOWABLE AREA

No Limit

Duct detectors in units

Revised 6/15/2020

Revised 6/15/2020

>2000 cfm

ACTUAL SHOWN ON PLANS

DEGREE OF OPENINGS

PROTECTION (TABLE 705.8)

Unprotected, Non sprinkler

☐ No ☑ Yes

☐ No ☑ Yes

☑ No ☐ Yes

Exterior wall opening area with respect to distance to assumed property lines (705.8)

Location of doors with delayed egress locks and the amount of delay (1010.1.9.7)

The square footage of each smoke compartment for Occupancy Classification I-2 (407.5)

Note any code exceptions or table notes that may have been utilized regarding the items above

ACCESSIBLE DWELLING UNITS (SECTION 1107)

> ACCESSIBLE PARKING (SECTION 1106)

> > (TABLE 2902.1)

 NEW
 2
 4
 1
 2
 2
 2
 1
 2
 3
 3

 REQ'D
 2
 3
 0
 0
 1
 1
 0
 0
 1
 1

SPECIAL APPROVALS

Special approval: (Local Jurisdiction, Department of Insurance, OSC, DPI, DHHS, etc., describe below)

OT OR PARKING AREA TOTAL # OF PARKING SPACES # OF ACCESSIBLE SPACES PROVIDED

PROVIDED

REQUIRED

ACCESSIBLE ACCESSIBLE TYPE A TYPE A TYPE B

UNITS UNITS UNITS UNITS UNITS ACCESSIBLE

REQUIRED PROVIDED REQUIRED PROVIDED PROVIDED

96" SPACES

PLUMBING FIXTURE REQUIREMENTS

Note to plan reviewer.

Occupancy Use for each area as it relates to occupant load calculation (Table 1004.1.2)

☐ No ☐ Yes ☑ Partial _

FIRE SEPARATION DISTANCE

(FEET) FROM PROPERTY LINES

Emergency Lighting:

Life Safety Plan Sheet #:

Occupant loads for each area

☑ Exit access travel distances (1017)

Clear exit widths for each exit door

Actual occupant load for each exit door

purposes of occupancy separation

2018 NC Administrative Code and Policies

Location of doors with panic hardware (1010.1.10)

Location of doors equipped with hold-open devices Location of emergency escape windows (1030) ☐ The square footage of each fire area (202)

Exit sign locations (1013)

Dead end lengths (1020.4)

Smoke Detection Systems:

Carbon Monoxide Detection: No Yes

Fire and/or smoke rated wall locations (Chapter 7)

Assumed and real property line locations (if not on the site plan)

Common path of travel distances (Tables 1006.2.1 & 1006.3.2(1))

Location of doors with electromagnetic egress locks (1010.1.9.9)

Exit Signs:

Fire Alarm:

2018 APPENDIX B BUILDING CODE SUMMARY FOR ALL COMMERCIAL PROJECTS

STRUCTURAL DESIGN (PROVIDE ON THE STRUCTURAL SHEETS IF APPLICABLE) **DESIGN LOADS:**

Snow (I_s) Seismic (I_E)

Ground Snow Load:

Exposure Category ____ D ___ mph (ASCE-7) Wind Load:

SEISMIC DESIGN CATEGORY: A B C D Provide the following Seismic Design Parameters: Risk Category (Table 1604.5) I II III IV Spectral Response Acceleration S_S XX.X %g

Data Source: Field Test Presumptive Historical Data Basic structural system Bearing Wall ☐ Dual w/Special Moment Frame ☐ Building Frame Dual w/Intermediate R/C or Special Steel ☐ Moment Frame ☐ Inverted Pendulum Analysis Procedure: ☐ Simplified ☐ Equivalent Lateral Force ☐ Dynamic

Architectural, Mechanical, Components anchored? Yes No LATERAL DESIGN CONTROL: Earthquake ☐ Wind ☑

SOIL BEARING CAPACITIES:

Field Test (provide copy of test report) ____ To be provided Presumptive Bearing capacity Pile size, type, and capacity

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2018 APPENDIX B BUILDING CODE SUMMARY FOR ALL COMMERCIAL PROJECTS MECHANICAL DESIGN

(PROVIDE ON THE MECHANICAL SHEETS IF APPLICABLE)

Note to plan reviewer: SEE MECHANICAL DRAWINGS FOR MECHANICAL SUMMARY INFORMATION MECHANICAL SYSTEMS, SERVICE SYSTEMS AND EQUIPMENT

Thermal Zone

winter dry bulb: summer dry bulb:

Interior design conditions winter dry bulb: summer dry bulb: relative humidity:

Building heating load:

Building cooling load:

Mechanical Spacing Conditioning System

Unitary description of unit: heating efficiency: cooling efficiency: size category of unit:

Size category. If oversized, state reason.: Chiller Size category. If oversized, state reason.:

List equipment efficiencies:

2018 NC Administrative Code and Policies

Revised 6/15/2020

2018 APPENDIX B BUILDING CODE SUMMARY FOR ALL COMMERCIAL PROJECTS

ELECTRICAL DESIGN (PROVIDE ON THE ELECTRICAL SHEETS IF APPLICABLE)

ELECTRICAL SUMMARY

Note to plan reviewer:
SEE ELECTRICAL DRAWINGS FOR ELECTRICAL SUMMARY

ELECTRICAL SYSTEM AND EQUIPMENT

Method of Compliance: Energy Code Performance

lamp type required in fixture

number of lamps in fixture ballast type used in the fixture ☐ Prescriptive ☐ Prescriptive

ASHRAE 90.1 Performance Lighting schedule (each fixture type)

number of ballasts in fixture total wattage per fixture total interior wattage specified vs. allowed (whole building or space by space) total exterior wattage specified vs. allowed

Additional Efficiency Package Options (When using the 2018 NCECC; not required for ASHRAE 90.1)

> C406.2 More Efficient HVAC Equipment Performance C406.3 Reduced Lighting Power Density

C406.4 Enhanced Digital Lighting Controls

C406.5 On-Site Renewable Energy

C406.6 Dedicated Outdoor Air System C406.7 Reduced Energy Use in Service Water Heating **ARCHITECT**

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Issue Date09/20/2023 Plot Date:

Mark	Date	Description
-		

Neville Engineering

919-740-3427

213 River Birch Lane Chapel Hill, NC 27514 neveng@aol.com

December 6, 2024

Mr. Ron Webb, Architect Ayden, NC

Re: Structural Metal Studs

Mount Pisgah Free Will Baptist Church

Erwin, NC

Dear Ron,

I am pleased to provide this design for the structural metal studs for the referenced project. I have enclosed a print of the framing plan with the type of stud to be used marked with numbers 1 thru 3.

Studs for the left end wall and rear wall are marked Type 1 and are to be 600S200-54 at 16" on center.

Studs for the front wall are marked Type 2 and are to be 600S200-54 at 10" on center and are to be braced at the bottom of the roof trusses by connecting to the trusses and adding diagonal bracing from the bottom chord of the truss to the roof. Provide 4 king studs at each side of the window and door openings.

Studs in the other locations are marked Type 3 and are to be 600\$137-33 at 16" on center.


Please contact me if you have questions.


Sincerely,

Augustus Neville

DEAL OF THE STATE OF THE STATE

Structural Metal Studi

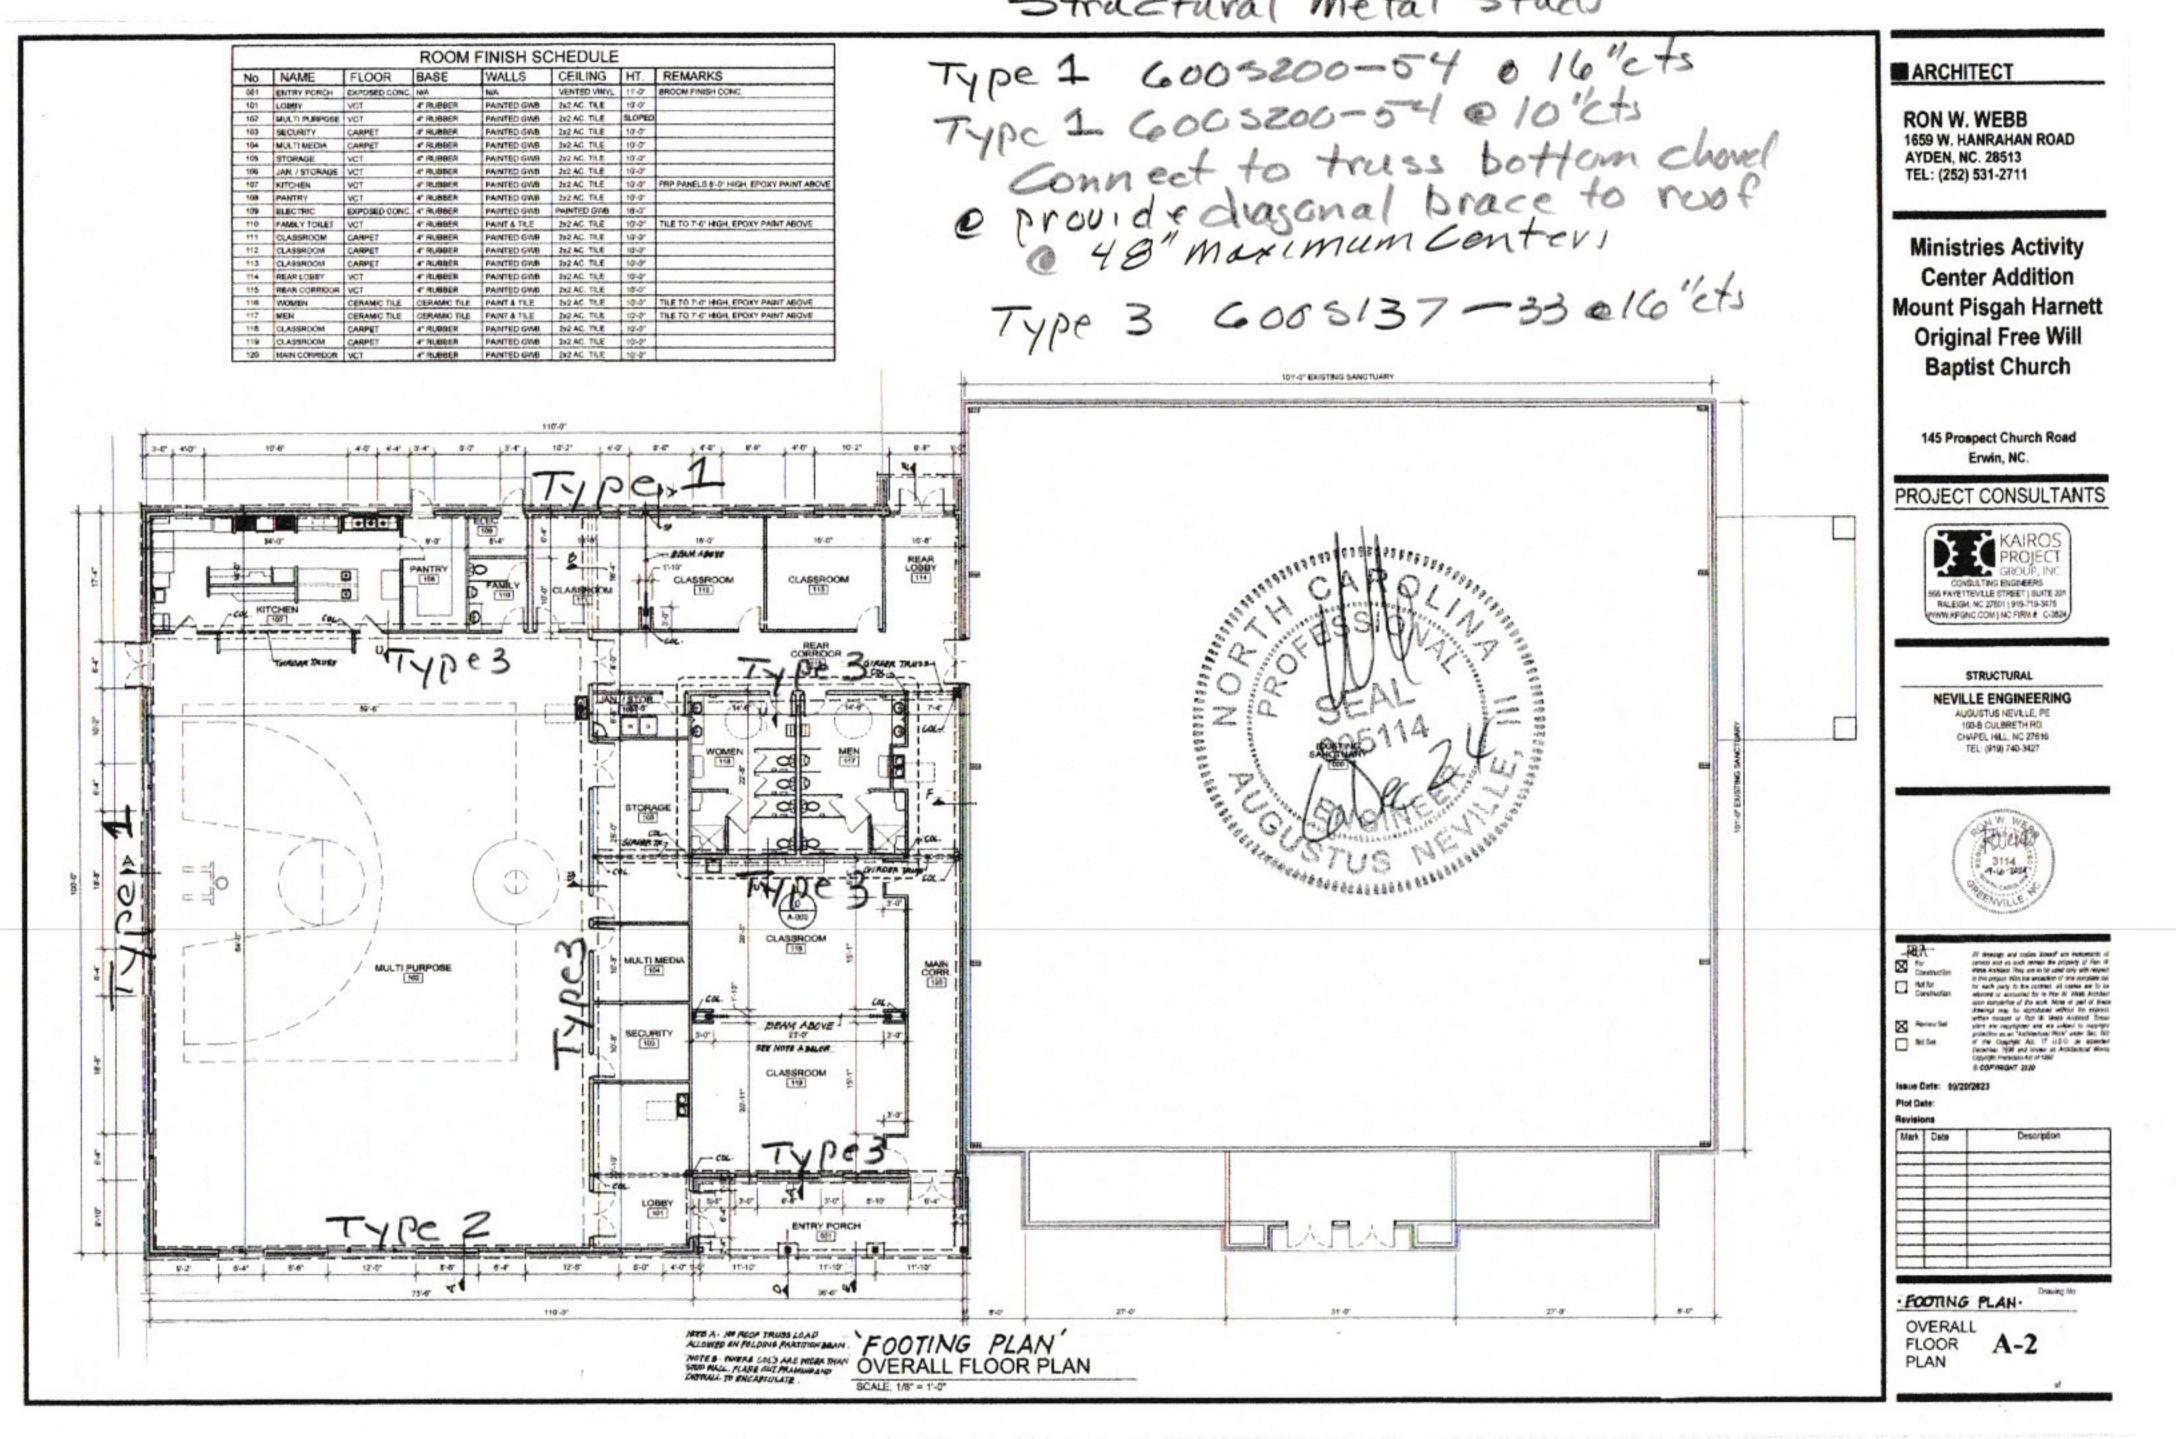

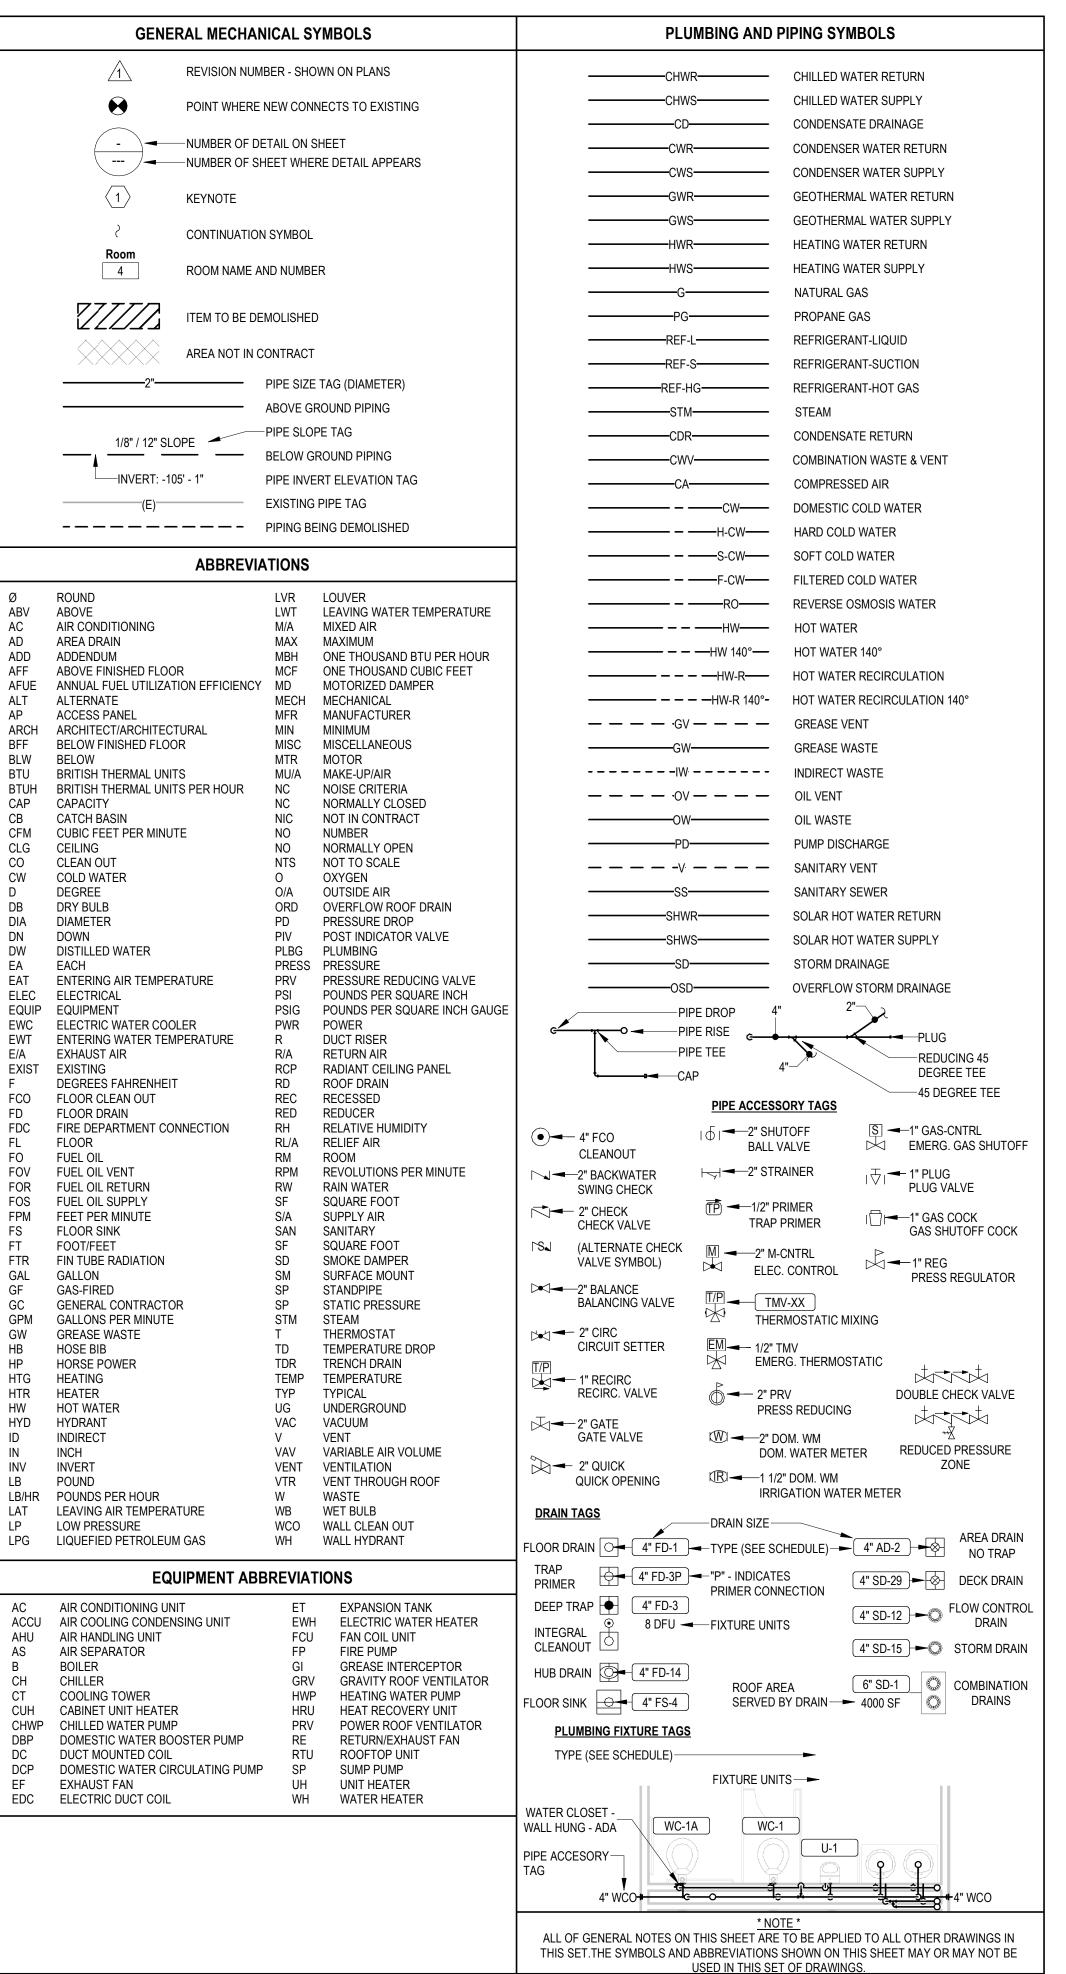

PLUMBING NOTES

- A. ALL WORK SHALL BE DONE IN ACCORDANCE WITH THE LATEST EDITION OF THE STATE CODE AS WELL AS ALL LOCAL AND OTHER APPLICABLE CODES.
- B. ALL WORK SHALL BE PERFORMED BY EXPERIENCED AND SKILLED CRAFTSMEN.
- C. FIELD VERIFY ALL NEW WATER, WASTE, AND VENT PIPING CONNECTIONS AND PROVIDE NEW CONNECTIONS AS REQUIRED FOR PROPERLY OPERATING SYSTEMS.
- D. FIELD VERIFY LOCATION AND INVERTS OF SITE UTILITIES PRIOR TO INSTALLATION.
- E. ROUTE DOMESTIC WATER, FIRE PROTECTION, SANITARY SEWER, AND STORM SEWER SERVICES TO SITE UTILITIES 5'-0" FROM BUILDING UNLESS NOTED OTHERWISE. REFER TO CIVIL PLANS.
- F. WASTE AND VENT PIPING BELOW FLOOR AND THROUGH FLOOR SHALL BE 2" MINIMUM.
- PROVIDE CLEANOUT IN ACCESSIBLE LOCATION AT THE BASE OF ALL PLUMBING RISERS.
- H. WATER LINES BELOW GRADE SHALL BE TYPE "K" COPPER (NO JOINTS BELOW GRADE) AND ABOVE GRADE TYPE "L". SUPPORT AS REQUIRED AND SHALL BE HYDROSTATICALLY TESTED FOR TWO HOURS AT 100 PSIG. ALL WATER PIPING AT WATER FIXTURES SHALL BE PROVIDED WITH 18" AIR CHAMBERS OR SHOCK ARRESTORS. STOPS SHALL BE PROVIDED ON HOT AND COLD-WATER LINES. WATER PIPING SHALL BE INSULATED WITH 1" CLOSED CELL RUBBER. THE ENTIRE WATER SYSTEM SHALL BE DISINFECTED PRIOR TO PLACING INTO SERVICE. PEX/PVC MAY NOT BE SUBSTITUTED FOR THE COPPER FOR DOMESTIC WATER PIPING.
- SANITARY SEWER LINES SHALL BE PVC AND SLOPED TOWARD DRAINAGE DIRECTION AT A MINIMUM OF 1/4" PER FOOT FOR 2-1/2" AND SMALLER PIPING. SLOPE SHALL BE 1/8" PER FOOT FOR PIPING SIZES 3" 6".
- J. WHERE APPLICABLE, ANY DEVICE THAT SHALL SERVE A SPECIAL FUNCTION SUCH AS PROCESSING OR ICE STORAGE, AND CONNECTS TO WATER SUPPLY AND DRAIN, SHALL BE PROTECTED AGAINST BACKFLOW WITH APPROVED BACKFLOW PREVENTION DEVICE.
- K. PROVIDE PRESSURE REDUCING VALVE IF STREET PRESSURE EXCEEDS 80 PSIG.
- SHOULD WATER PRESSURE BE TOO LOW TO PROPERLY CYCLE FLUSH VALVE FIXTURES, A BOOSTER PUMP SHALL BE REQUIRED. SUFFICIENT WATER PRESSURE IS ASSUMED FOR PROPER PLUMBING OPERATION.
- M. THE PLUMBING CONTRACTOR SHALL PROVIDE ALL OPENINGS REQUIRED FOR THE PLUMBING WORK AND SHALL INSTALL FIRE RATED SLEEVES WHEREVER PENETRATIONS OF RATED WALLS OR FLOORS ARE MADE. THE PATCHING SHALL BE BY THE PLUMBING CONTRACTOR. THE PLUMBING CONTRACTOR SHALL REVIEW ALL UTILITY SITE PLANS AND ARCHITECTURAL SITE PLANS FOR WORK BY OTHERS.
- N. LOCATION OF UTILITIES (WASTE AND WATER LINES, MANHOLES, ETC...) THAT ARE TO BE CONNECTED TO ARE ASSUMED. IT SHALL BE THE RESPONSIBILITY OF THE PLUMBING CONTRACTOR TO VERIFY THESE LOCATIONS AND MAKE THE FINAL CONNECTION AS REQUIRED.
- O. ALL FLOOR DRAINS AND TRENCH DRAINS, IF APPLICABLE, SHALL BE PROVIDED WITH TRAP PRIMERS.

PLUMBING SHEET INDEX

- P000 PLUMBING TITLE SHEET
 P100 PLUMBING DOMESTIC WATER
- P100 PLUMBING DOMESTIC WATER PLAN
 P101 PLUMBING SANITARY PLAN
- P200 PLUMBING DETAILS AND SCHEDULES

WEBB MT PISGAH

■ ARCHITECT

RON W. WEBB

AYDEN, NC. 28513

TEL: (252) 531-2711

1659 W. HANRAHAN ROAD

145 PROSPECT CHURCH RD ERWIN, NC 28339

PROJECT CONSULTANTS



120 SOMMERVILLE PARK ROAD RALEIGH, NC 27603 NC FIRM # C-3824



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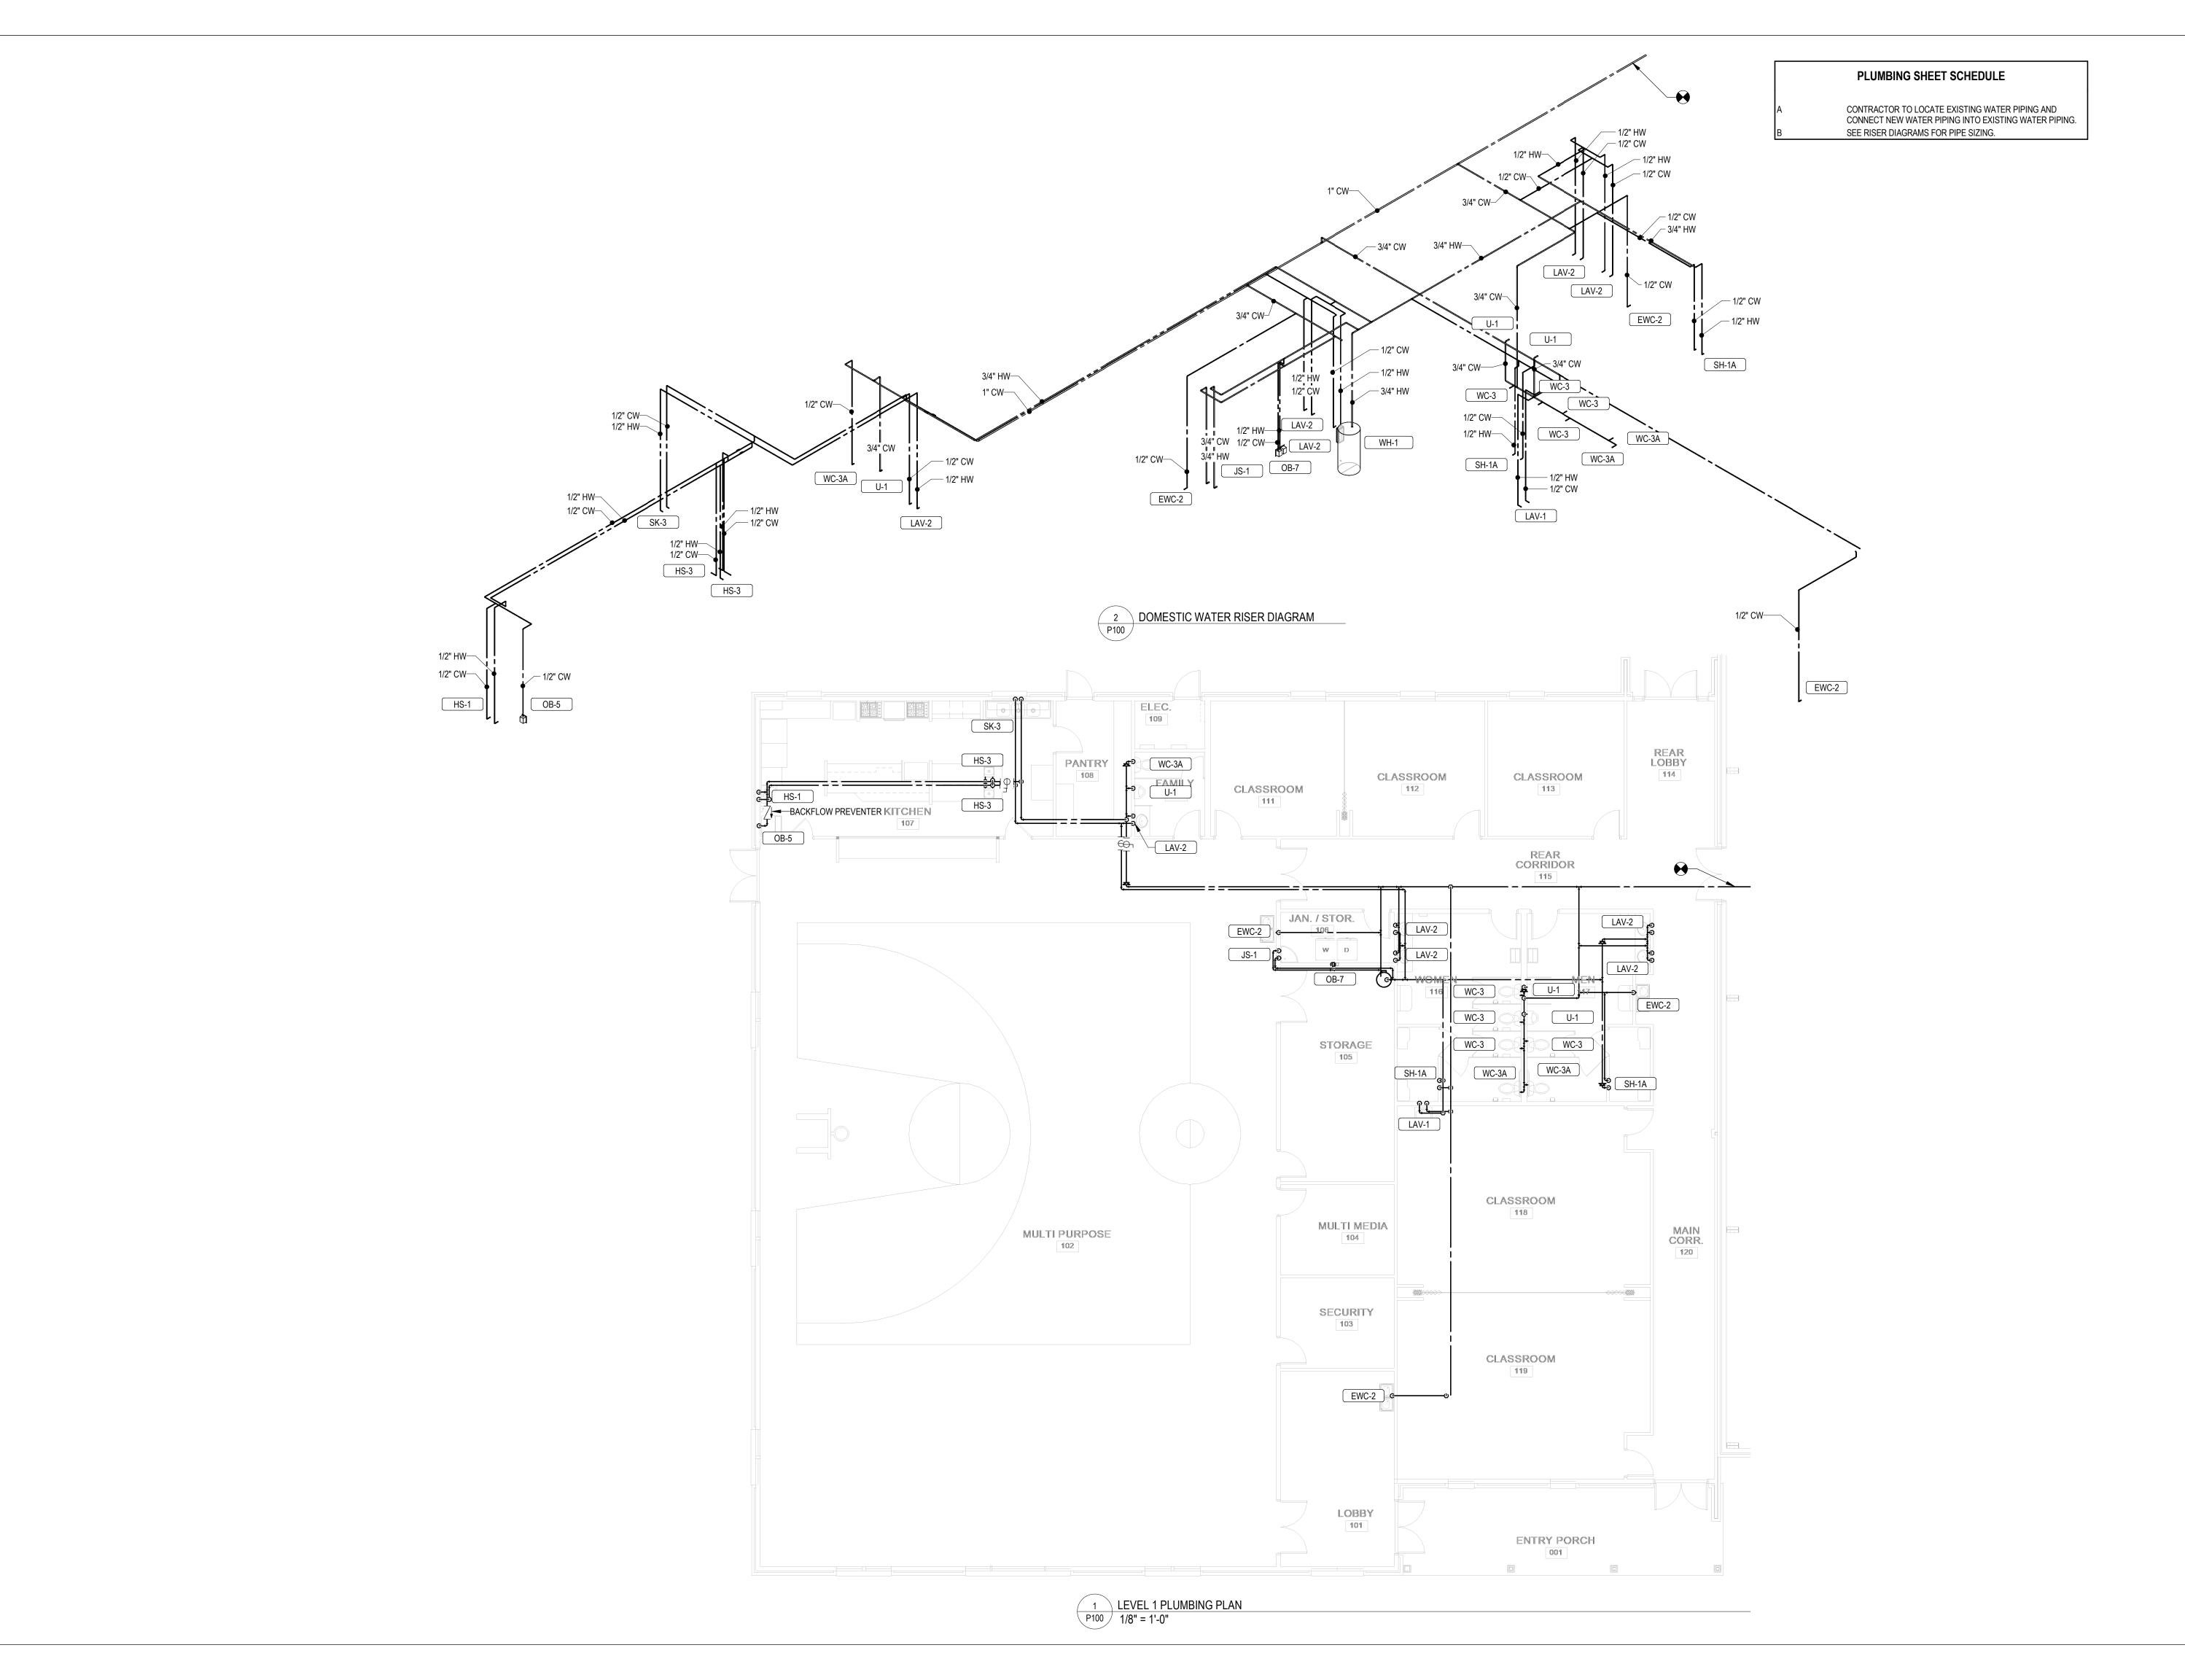
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Mark	Date	Description

Drawing No.

PLUMBING TITLE SHEET

P000



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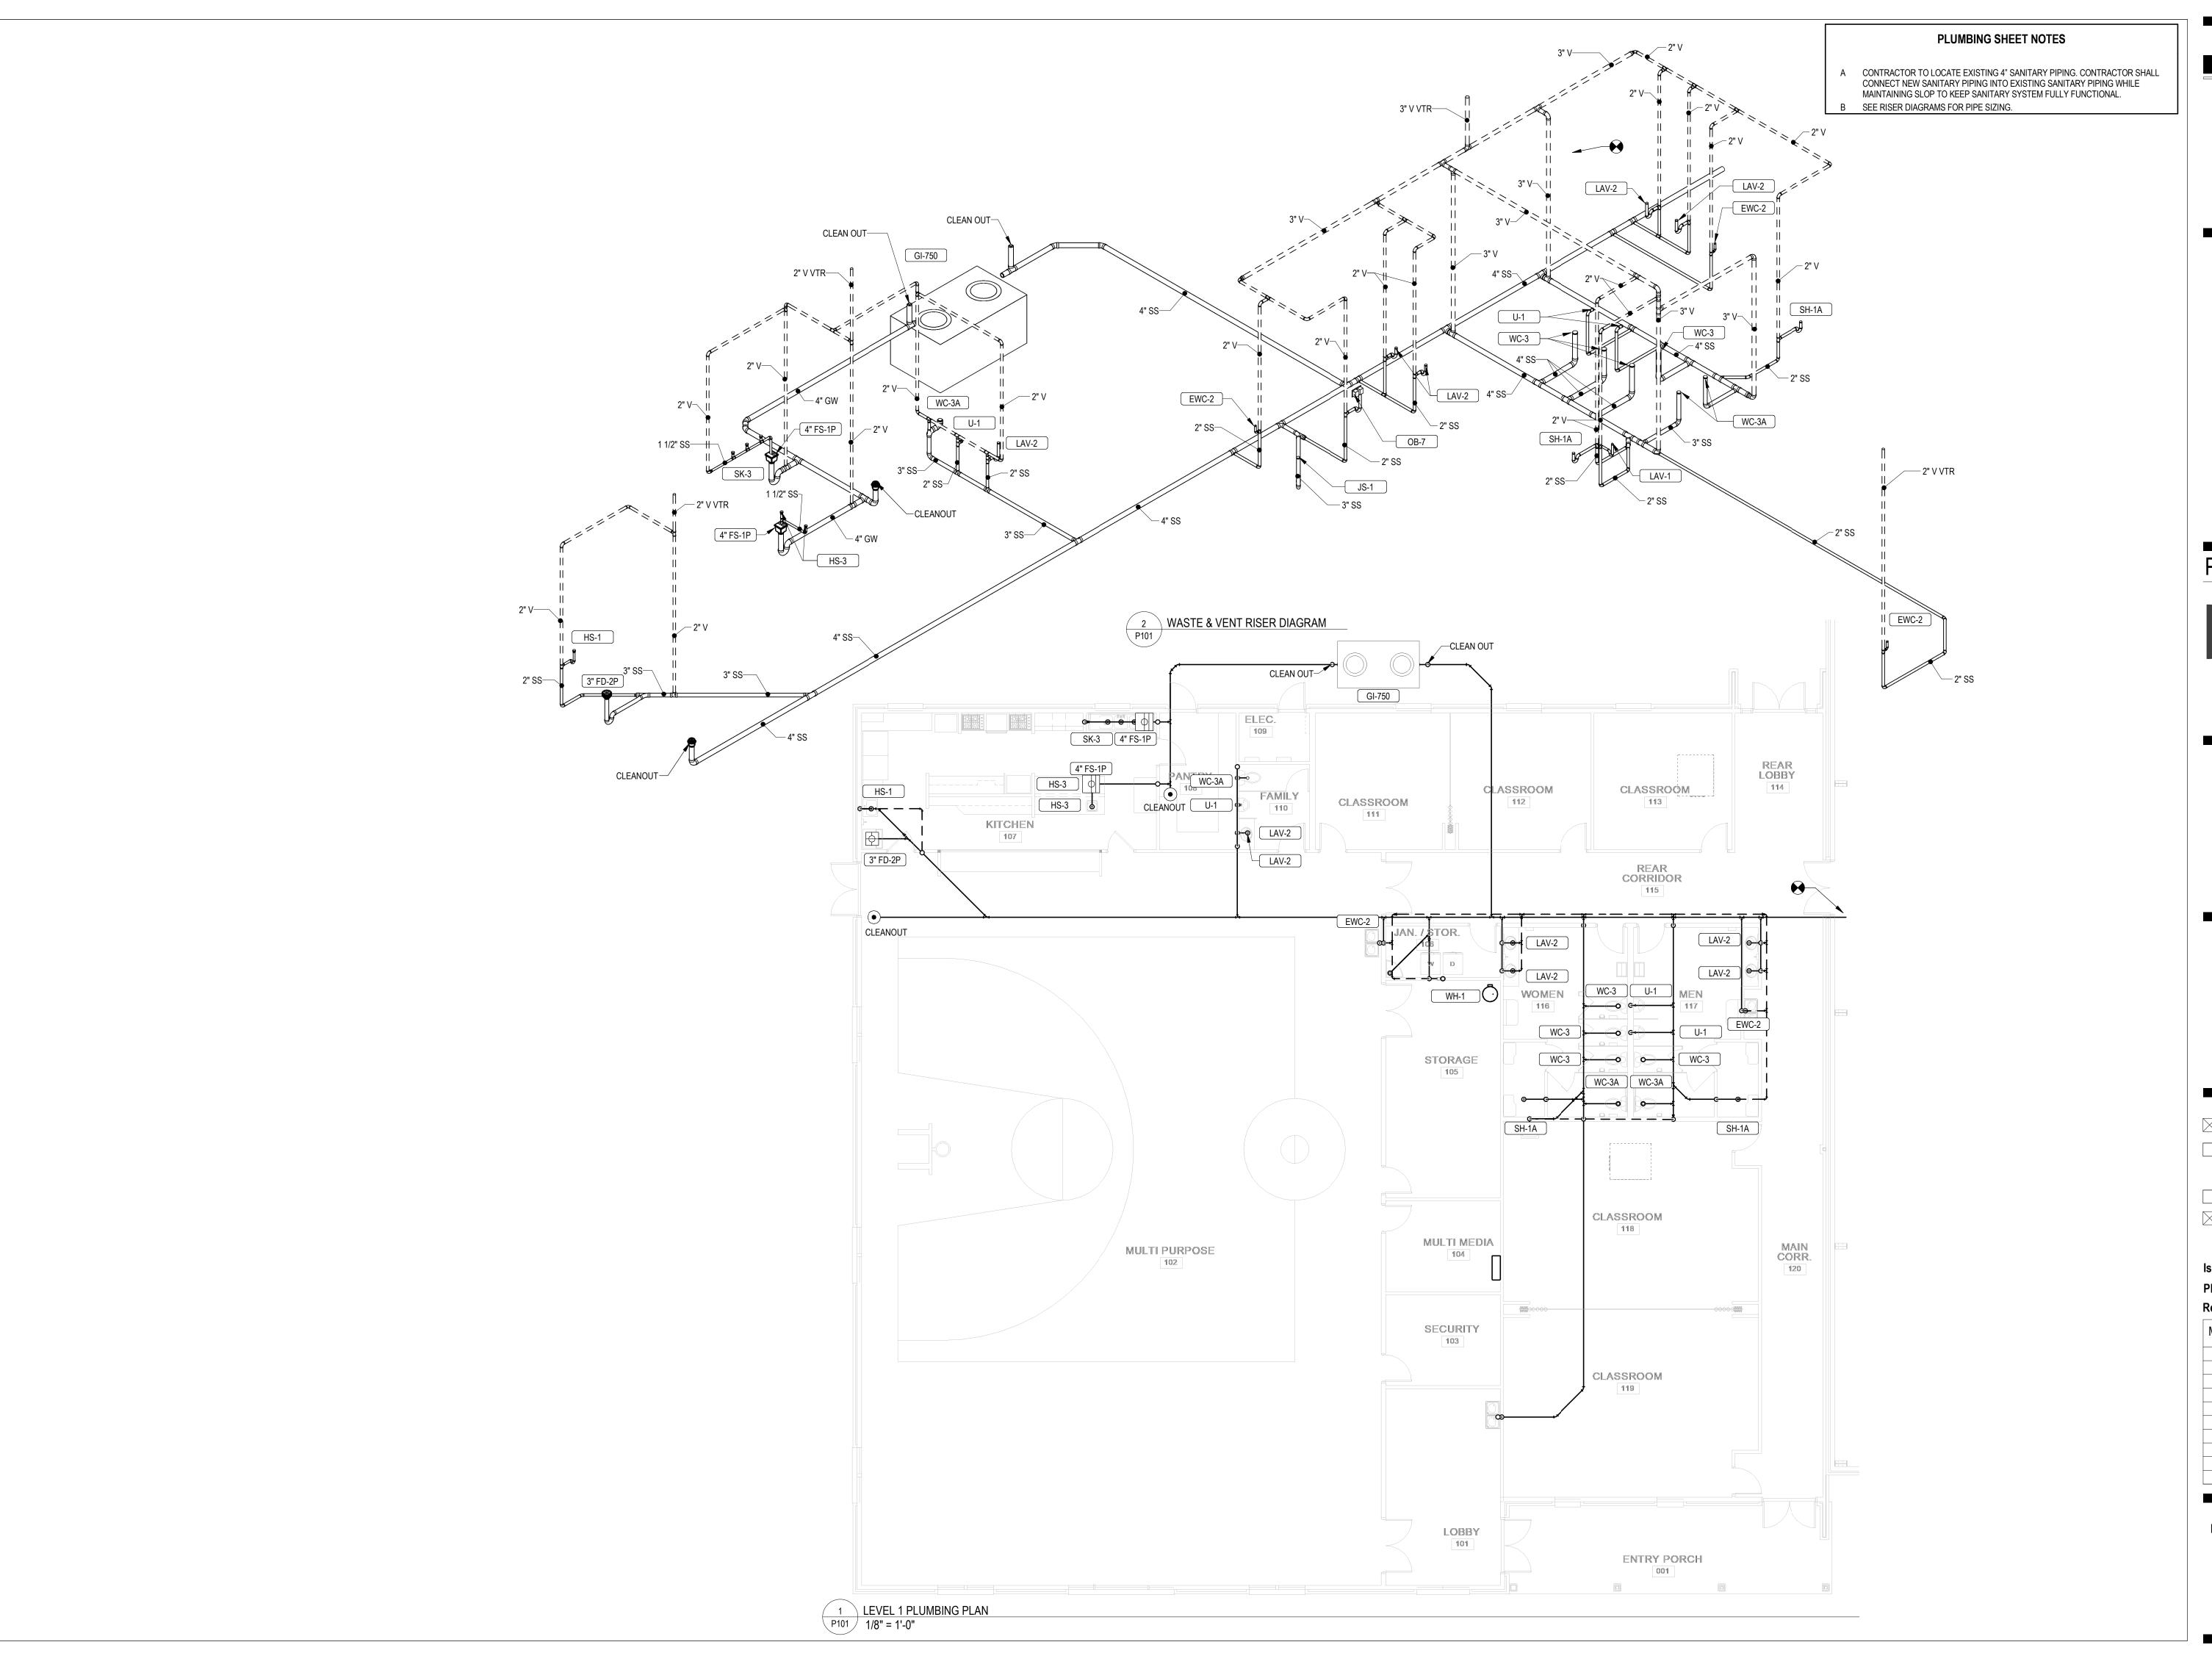
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Drawing No PLUMBING DOMESTIC WATER PLAN

P100



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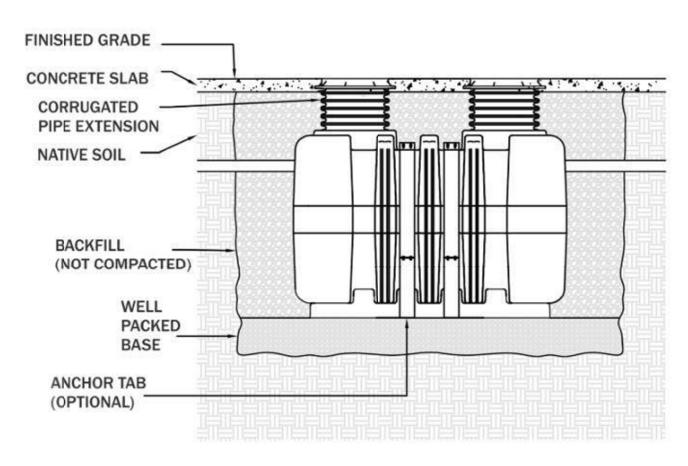
PLUMBING SANITARY PLAN


											DOMEST		UKE SC	HEDULE	:								
ID	DESCRIPTION	MANUFACTURER	MODEL Q1	MATERIAL DESCRIPTION	FINISH	MANUFACTURER	TRI	M TYPE	MOTION SENSOR CONTROL	WATER FLOW	FLON TIMER DURATION (SEC)	W FIXTURE CWT	HWT	MAX. MWT	FLUSH VOL. PER FLUSH			INDIRECT N WASTE E PIPE SIZE	VENT PIPE R			SPECIFICATION	REMA
	WATER COOLER - DUAL HEIGHT	ELKAY		GALVANIZED STEE		III/ UTO TO TO TELL	model	2	No	0.1 GPM	15	40 °F		40 °F	120011	T EIXT EGGI	2"	I I I I I I I I I I I I I I I I I I I		1/2"	THE GILL	TWO LEVEL WALL HUNG WATER COOLER WITH BOTTLE FILLING STATION. THE UNIT SHALL BE COMPLETE WITH CABINET, MOUNTING FRAME, SELF CLOSING EASY TOUCH SIDE AND FRONT PUSHBAR CONTROLS, FLEXIGUARD SAFETY BUBBLER, REFRIGERATING SYSTEM, AIR COOLED, 120 VOLT, 60 CYCLE, SINGLE PHASE POWER CONNECTION, FULLY AUTOMATIC, COMPLETE AND READY TO OPERATE.	T.C.II
HS-1	HAND SINK	ELKAY	EHS-18X 1	STAINLESS STEE	STAINLESS STEEL	ELKAY	INCLUDED	MANUAL	No	0.5 GPM	0	40 °F	120 °F	105 °F			2"		1 1/2"	1/2"	1/2"	SINGLE COMPARTMENT, WALL HUNG, 18 GAUGE, WITH STRAINER AND FAUCET INCLUDED, P-TRAP, TAILPIECES, SUPPLIES AND STOPS. PROVIDE WITH HAWS MODEL NO. 7620 FAUCET MOUNTED EYEWASH AXION EYEPOD.	
HS-3	HAND SINK	ELKAY	D11515 2	STAINLESS STEE	STAINLESS STEEL	ELKAY	LKD24898BH C	MANUAL	No	0.5 GPM	0	40 °F	120 °F	105 °F			2"		1 1/2"	1/2"	1/2"	DAYTON STAINLESS STEEL 15" X 15" X 5-3/16", SINGLE BOWL DROP-IN BAR SINK. SINK IS MANUFACTURED FROM 23 GAUGE 300 SERIES STAINLESS STEEL WITH A SATIN FINISH, CENTER DRAIN PLACEMENT, AND BOTTOM ONLY PADS	
JS-1	JANITOR SINK	FIAT	MSB-2424 1	MOLDED STONE		CHICAGO FAUCET CO	897-CP	MANUAL	No	2.5 GPM	0	40 °F	120 °F	105 °F			3"		2"	3/4"	3/4"	SERVICE BASIN WITH CAP ON TWO SIDES, WITH CHROME PLATED 3" DRAIN AND CAST IRON TRAP. FAUCET SHALL INCLUDE PAIL HOOK AND ATMOSPHERIC VACUUM BREAKER SPOUT. FURNISH 5'-0" LENGTH OF 5-PLY GARDEN HOSE AND FITTINGS.	
AV-1	LAVATORY - WALL HUNG	AMERICAN STANDARD	LUCERNE 1	WHITE VITREOUS CHINA	WHITE	CHICAGO FAUCET CO	116.976.AB.1	ELECTRONIC	Yes	0.5 GPM	12	40 °F	120 °F	105 °F			2"		1 1/2"	1/2"	1/2"	WALL HUNG LAVATORY WITH BACKSPLASH, FAUCET HOLES ON 4" CENTERS. DECK-MOUNTED FAUCET WITH SENSOR, WATER TURBINE POWER WITH VANDAL RESISTANT SPRAY, EXTERNAL ASSE 1070 COMPLIANT THERMOSTATIC MIXING VALVE, GRID DRAIN, LOOSE KEY ANGLE STOPS AND SUPPLIES. INSULATE WATER AND WASTE WITH INSULATION KIT.	
AV-2	LAVATORY - COUNTER	AMERICAN STANDARD	CADET 5	WHITE VITREOUS CHINA	WHITE	CHICAGO FAUCET CO	116.976.AB.1	ELECTRONIC	Yes	0.5 GPM	12	40 °F	120 °F	105 °F			2"		1 1/2"	1/2"	1/2"	COUNTERTOP LAVATORY, SELF-RIMMING, FAUCET HOLES ON 4" CENTERS. DECK-MOUNTED FAUCET SENSOR, WATER TURBINE POWER WITH VANDAL RESISTANT SPRAY, EXTERNAL ASSE 1070 COMPLIANT THERMOSTATIC MIXING VALVE, GRID DRAIN, LOOSE KEY ANGLE STOPS AND SUPPLIES. INSULATE WATER AND WASTE WITH INSULATION KIT.	
OB-5	ICE MAKER OUTLET BOX	SIOUX CHIEF	696-RG1010MF 1	ABS PLASTIC	WHITE				No	0.5 GPM	0	40 °F	120 °F	105 °F						1/2"		FULLY RECESSED FIRE RATED ICE MAKER SUPPLY BOX WITH COVER. PROVIDE 1/4 TURN BALL VALVES AND WATER HAMMER ARRESTORS IN BOX.	
OB-7	WASHING MACHINE OUTLET BOX	SIOUX CHIEF	696-RG2303WF 1	ABS PLASTIC	WHITE				No	0.5 GPM	0	40 °F	120 °F	105 °F			2"		2"	1/2"	1/2"	FULLY RECESSED FIRE RATED WASHING MACHINE SUPPLY BOX WITH COVER. PROVIDE 1/4 TURN BALL VALVES AND WATER HAMMER ARRESTORS IN BOX. PROVIDE A 2" TRAPPED STANDPIPE IN CONCEALED WALL SPACE.	
SH-1A	SHOWER STALL - ADA	BY OTHERS	BY OTHERS 2			SYMMONS	C-96-500-B30- V	MANUAL	No	1.0 GPM	300	40 °F	120 °F	105 °F			2"		1 1/2"	1/2"	1/2"	THE INDIVIDUAL SHOWER STALL IS SPECIFIED IN ANOTHER DIVISION. PROVIDE A SHOWER DRAIN AS SPECIFIED IN "SOIL, WASTE AND VENT PIPING SYSTEMS." SHOWER SYSTEM WITH ASSE 1016 COMPLIANT TYPE "T/P" THERMOSTATIC/PRESSURE BALANCING COMBINATION VALVE WITH ADJUSTABLE STOP SCREW TO LIMIT HANDLE TURN. CONCEALED 3-PORT DIVERTER VALVE WITH LEVER HANDLE WITH ARM AND FLANGE, INTEGRAL STOPS, AND IN-LINE VACUUM BREAKER. HAND SHOWER SYSTEM WITH STANDARD HAND SHOWER, 60" FLEXIBLE METAL HOSE, AND 48" SLIDE BAR FOR HAND SHOWER MOUNTING. PROVIDE MANUFACTURER'S FLOW RATE RESTRICTOR ON SHOWERHEAD.	
U-1	URINAL	AMERICAN STANDARD	WASHBROOK 3	B WHITE VITREOUS CHINA	WHITE	SLOAN	8186	BATTERY	Yes			40 °F		40 °F	0.125 gal	0.125 gal	2"		1 1/2"	3/4"		WALL HUNG URINAL WITH WASHOUT ACTION, TOP SPUD, SIZE 18" WITH INTEGRAL EXTENDED SHIELDS SUPPORTED BY THROUGH GOING BOLTS AND C.P. NUTS. SOLAR POWERED SENSOR ACTIVATED FLUSHOMETER.	
NC-3	WATER CLOSET - FLOOR - TANK TYPE	AMERICAN STANDARD	CADET 4	WHITE VITREOUS CHINA	WHITE	TANK TYPE			No			40 °F		40 °F	1.28 gal	1.28 gal	4"		2"	1/2"		ELONGATED FLOOR MOUNTED TANK TYPE WATER CLOSET, WITH CHURCH 295CT ELONGATED OPEN FRONT SEAT. PROVIDE A 1/4" BRASS BALL VALVE AT WALL CONNECTION.	
VC-3A	WATER CLOSET - FLOOR - PRESSURE ASSISTED TANK TYPE - ADA	AMERICAN STANDARD	CADET RIGHT 3 HEIGHT	WHITE VITREOUS CHINA	WHITE	AMERICAN STANDARD	2467.016	MANUAL	No			40 °F		40 °F	1.6 gal	1.6 gal	3"		2"	1/2"		ELONGATED FLOOR MOUNTED PRESSURE ASSISTED TANK TYPE WATER CLOSET, WITH CHURCH 295CT ELONGATED OPEN FRONT SEAT. PROVIDE A 1/4" BRASS BALL VALVE AT WALL CONNECTION. INSTALL AT ADA COMPLIANT HEIGHT.	

FIXTURE TYPE	QUANTITY	PIPE DIAMETER	GPM/FIXTURE	FIXTURE RATING	GPM
Pot sink (3 comp)	1	1 1/2	13	1.00	13
Meat & Vegetable prep sink	2	1 1/2	13	0.10	2.6
Pre-rinse sink			0		0
Wok			ė	9	0
Other	(t)		Î	X 1.	0
Dishwasher	30		50.		8
Can wash / Mop sink					0
Total					23.6
ease Interceptor Size = flow rate	te x 30 minutes	s =			708

	ELECTRIC WATER HEATER SCHEDULE																						
	LOCATION							ELECTRIC I	HEAT EXCHANGER	₹		H	EATING ELEN	MENT									
						HEATING	FLO	OW	STORA	\GE	MAX TEMP						UNIT						
ID	NAME	NO.	MANUFACTURER	MODEL NO.	TYPE	CAP	DESIGN	MIN	RECOVERY	VOL	RISE	QTY	POWER	SCR	EF	ASME	WEIGHT	FLA	MCA	MOCP	VOLT	PH	REMARKS
WH-1	Space	235	AO SMITH	DEN-40	STORAGE	0.0 kW			0.0 gal/h	40.0 gal	80 °F	2	0.0 kW	Yes	0.9	Yes	447 lb	8.3 A	10.4 A	15.0 A	208 V	3	PROVIDE ASSE 1017 COMPLIANT MIXING
																							VALVE; POWERS SERIES LFSH OR EQUAL.

							GREASE	INTE	RCEPTOR	SCHEDU	JLE								
							COVER			CAPA	CITY	INSTALLATION	PIP	E CONNECT	TIONS		DIMENSIO	NS	
													INLE						
	ID					MATERIAL			DESIGN				T	OUTL	.ET				
T	YPE	MANUFACTURER	MODEL	QTY	TYPE	DESCRIPTION	DESCRIPTION	DIA	FLOW	LIQUID	SOLIDS	ARRANGEMENT	DIA	INVERT	DIA	LENGTH	WIDTH	HEIGHT	REMARK
G	il-750	MIFAB	SUPER-750	1	GRAVITY	HIGH DENSITIY POLYETHYLENE	CAST IRON	2' - 0"	250.0 GPM	750.0 gal	77.0 gal	ABOVE GRADE	4"	-3"	4"	9' - 3"	5' - 4"	4' - 5 5/8"	




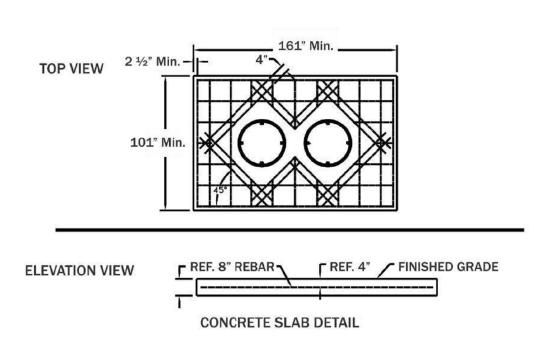



			PIPE	SIZE	DFU D	EMAND	CWFU [DEMAND	HWFU [DEMAND	WSFU [DEMAN
ID	FIXTURE DESCRIPTION	QTY	CW	HW	UNIT	TOTAL	UNIT	TOTAL	UNIT	TOTAL	UNIT	TOT
EWC-2	WATER COOLER - DUAL HEIGHT	3	1/2"		0.5	1.5	0.5	1.5	0	0	0.5	1.9
HS-1	HAND SINK	1	1/2"	1/2"	2	2	1.125	1.125	1.125	1.125	1.5	1.5
HS-3	HAND SINK	2	1/2"	1/2"	2	4	1.125	2.25	1.125	2.25	1.5	3
JS-1	JANITOR SINK	1	3/4"	3/4"	3	3	2.25	2.25	2.25	2.25	3	3
LAV-1	LAVATORY - WALL HUNG	1	1/2"	1/2"	1	1	0.75	0.75	0.75	0.75	1	1
LAV-2	LAVATORY - COUNTER	5	1/2"	1/2"	1	5	0.75	3.75	0.75	3.75	1	5
OB-5	ICE MAKER OUTLET BOX	1	1/2"	1/2"	0	0	0.5	0.5	0	0	0.5	0.
OB-7	WASHING MACHINE OUTLET BOX	1	1/2"	1/2"	3	3	3	3	3	3	4	4
SH-1A	SHOWER STALL - ADA	2	1/2"	1/2"	2	4	1.5	3	1.5	3	2	4
SK-3	3-COMPARTMENT SINK	1	1/2"	1/2"	4	4	1.5	1.5	1.5	1.5	2	2
U-1	URINAL	3	3/4"		2	6	4	12	0	0	4	1:
WC-3	WATER CLOSET - FLOOR - TANK TYPE	4	1/2"		4	16	2.5	10	0	0	2.5	10
WC-3A	WATER CLOSET - FLOOR - PRESSURE ASSISTED TANK TYPE - ADA	3	1/2"		4	12	2.5	7.5	0	0	2.5	7.
and total: 2	28		1		ı	61.5		49.125		17.625	I	55

			WASTE	DFU D	EMAND
ID	FIXTURE DESCRIPTION	QTY	SIZE	UNIT	TOTAL
EWC-2	WATER COOLER - DUAL HEIGHT	3	1 1/4"	0.5	1.5
FD-2	FLOOR DRAIN	1	3"	6	6
FS-1	FLOOR SINK	2	4"	6	12
HS-1	HAND SINK	1	2"	2	2
HS-3	HAND SINK	2	2"	2	4
JS-1	JANITOR SINK	1	3"	3	3
LAV-1	LAVATORY - WALL HUNG	1	1 1/2"	1	1
LAV-2	LAVATORY - COUNTER	5	2"	1	5
OB-7	WASHING MACHINE OUTLET BOX	1	2"	3	3
SH-1A	SHOWER STALL - ADA	2	2"	2	4
SK-3	3-COMPARTMENT SINK	1	2"	4	4
U-1	URINAL	3	2"	2	6
WC-3	WATER CLOSET - FLOOR - TANK TYPE	4	4"	4	16
WC-3A	WATER CLOSET - FLOOR - PRESSURE ASSISTED TANK TYPE - ADA	3	3"	4	12
Frand total: 3	=				79.5



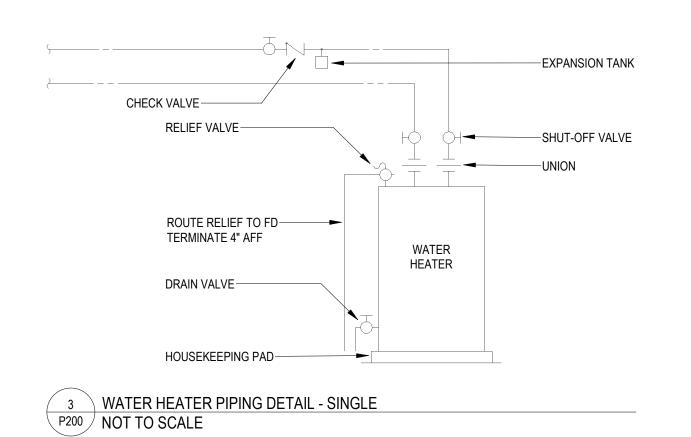

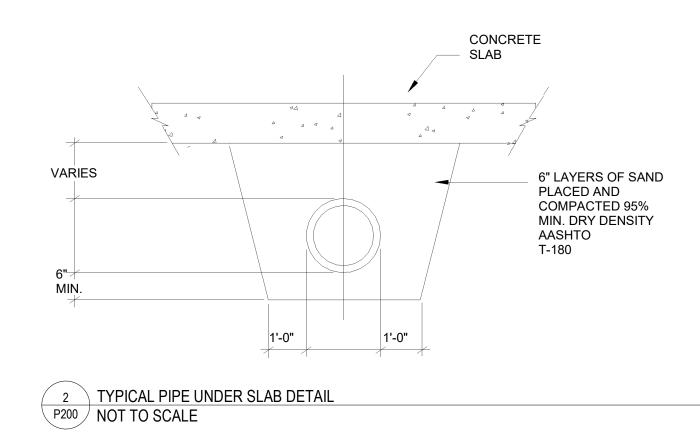

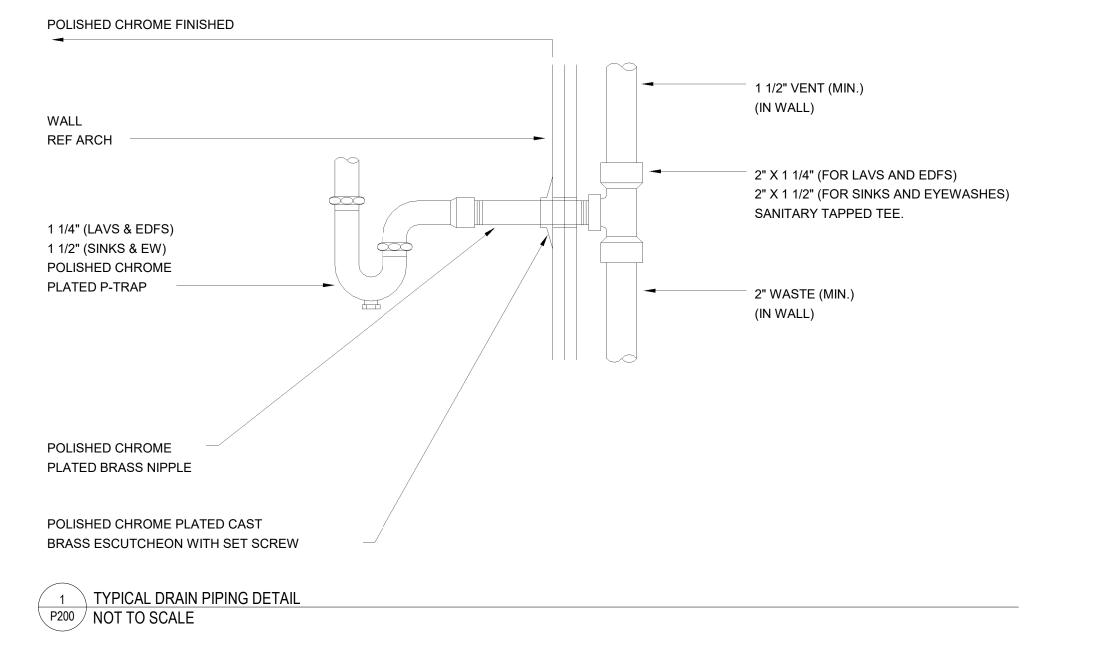

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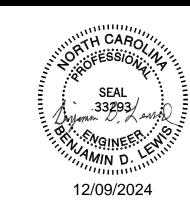
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145 PROSPECT CHURCH RD ERWIN, NC 28339

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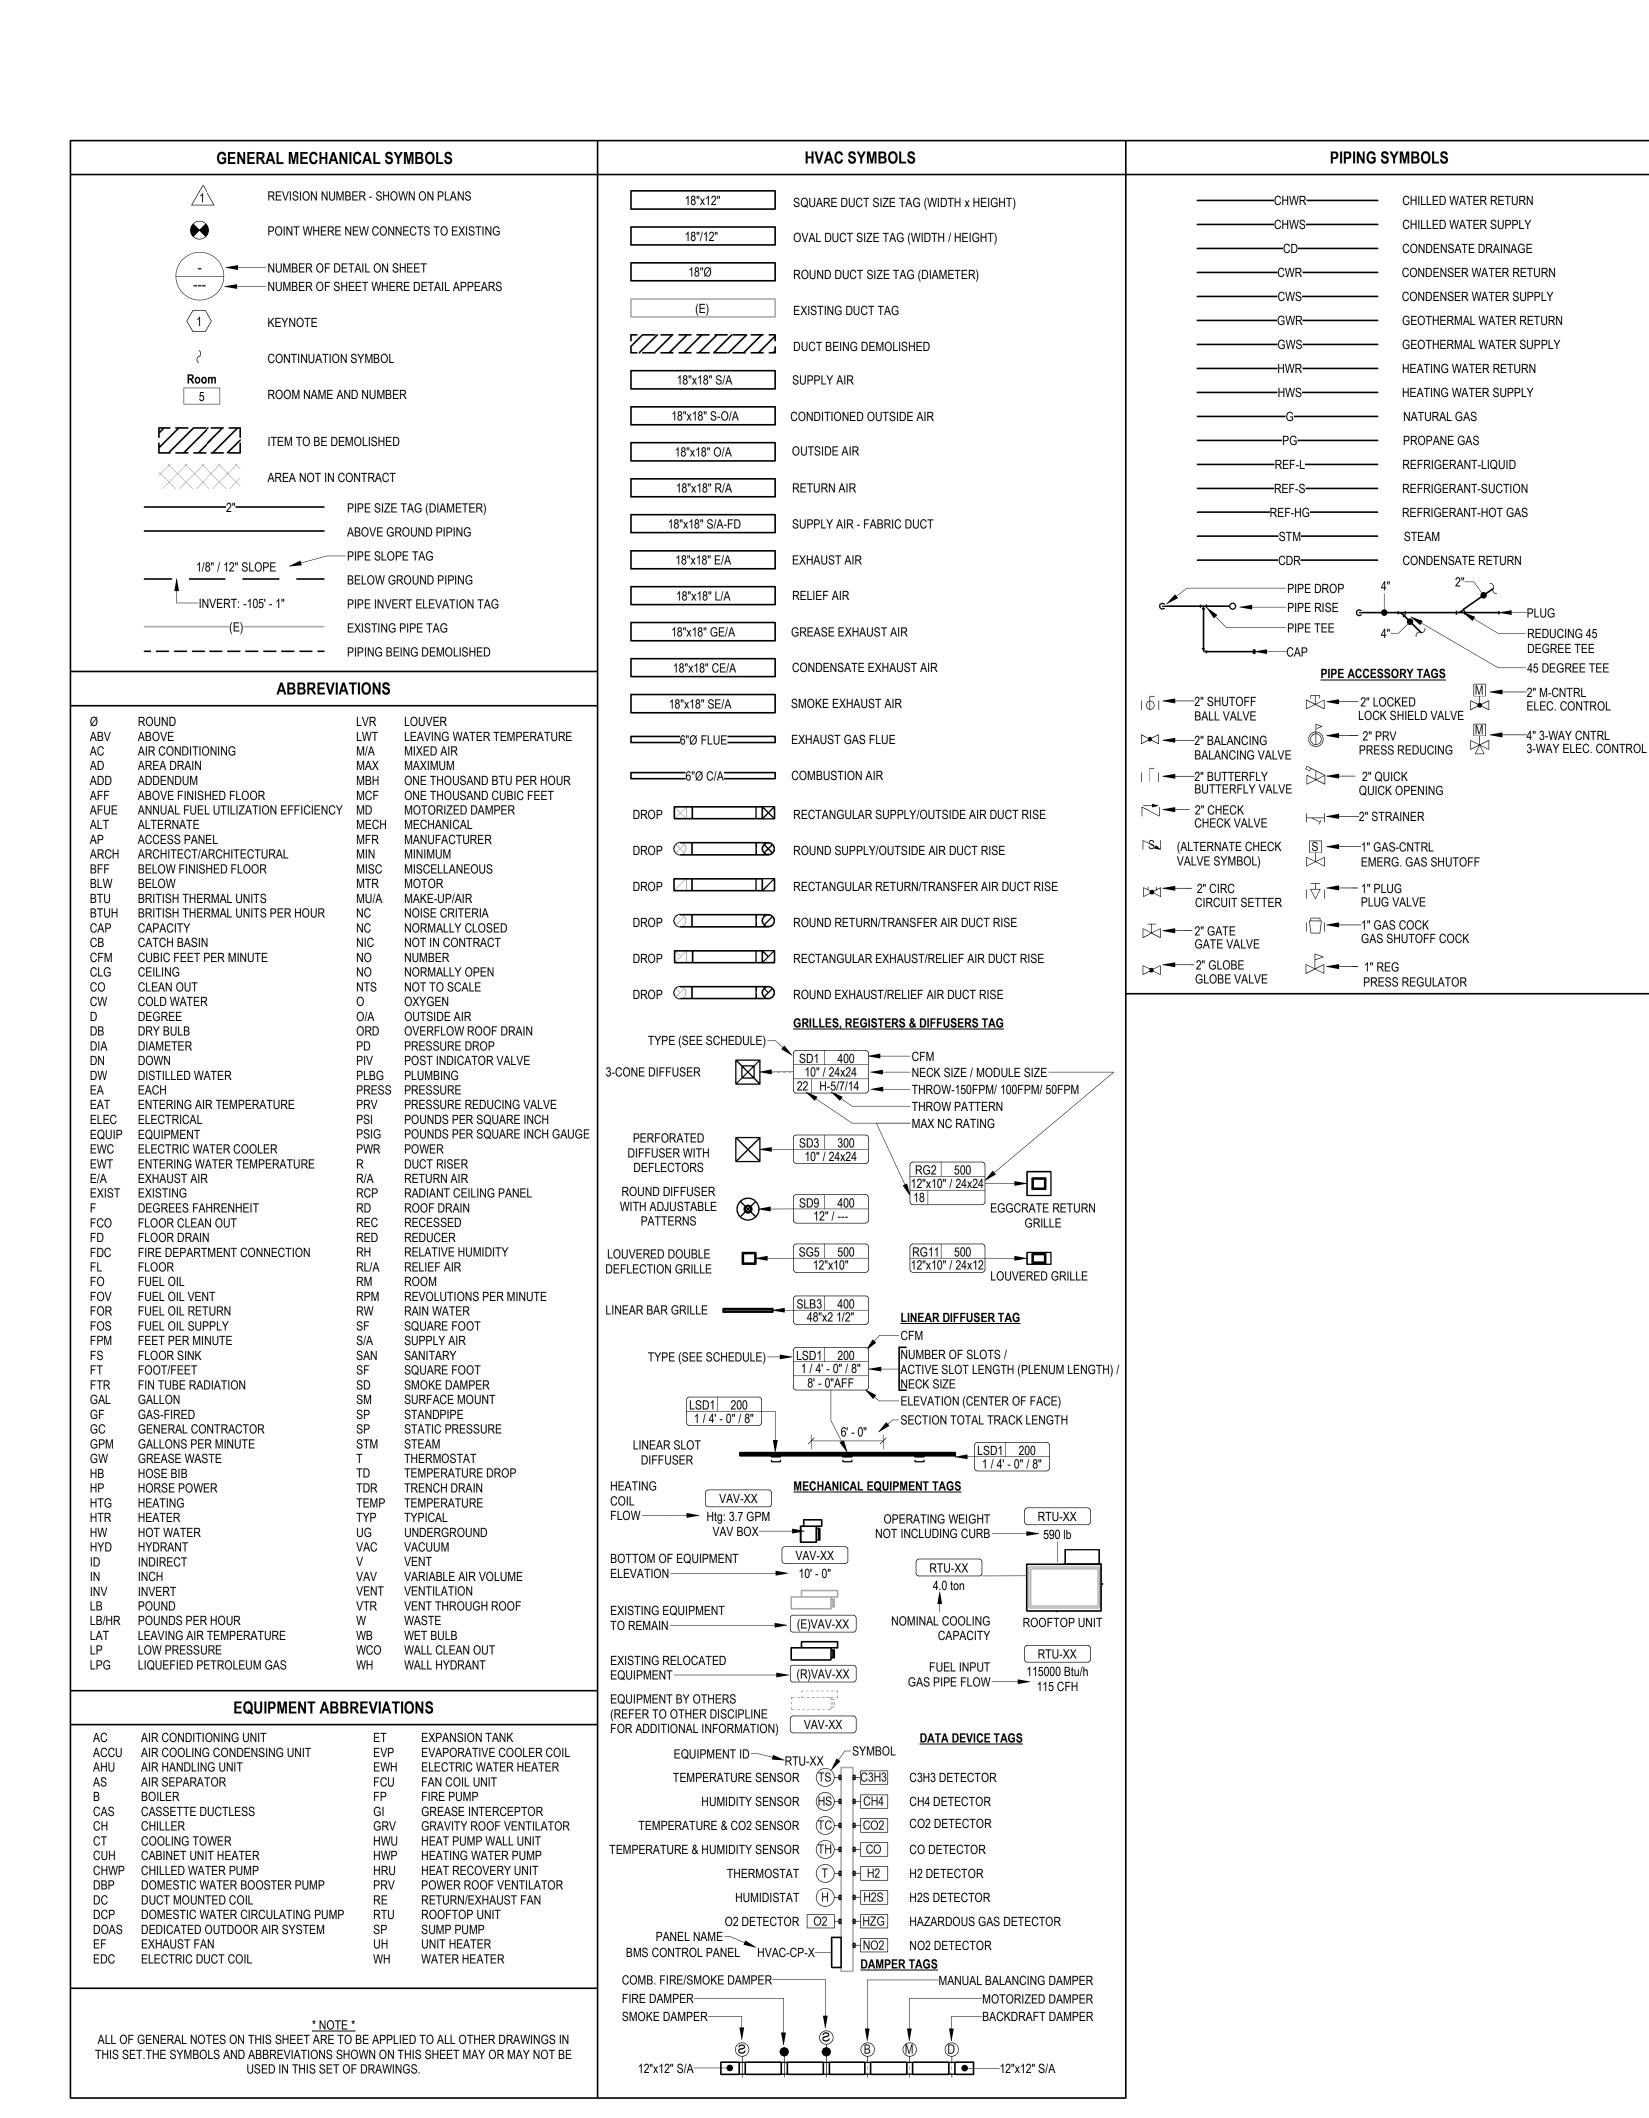
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PLUMBING DETAILS AND SCHEDULES

P200



MECHANICAL NOTES

- MECHANICAL PLANS ARE INTENDED TO PROVIDE INFORMATION FOR INSTALLATION OF A COMPLETE OPERATING MECHANICAL SYSTEM. PROVIDE ALL ESSENTIAL LABOR. MATERIALS AND DEVICES REQUIRED TO PRODUCE A QUALITY END PRODUCT.
- CONTRACTOR SHALL REVIEW AND BECOME FAMILIAR WITH THE WORK OF ALL TRADES FOR PURPOSES OF COORDINATION AND ROUTING. CONTRACTOR SHALL PROVIDE REQUIRED PLANNING, COORDINATION AND SEQUENCING OF HVAC INSTALLATION WITH BUILDING COMPONENTS AND OTHER TRADES.
- ALL WORK SHALL COMPLY WITH LOCAL, STATE, AND NATIONAL CODES. WORKMANSHIP SHALL MEET OR EXCEED INDUSTRY STANDARDS.
- FABRICATE AND INSTALL DUCT PER SMACNA STANDARDS FOR 2-INCH WC WITH GALVANIZED METAL (26 GUAGE MINIMUM). ALL RADIUS ELBOWS AND TEES SHALL HAVE CENTERLINE RADIUS OF 1.5 X DUCT WIDTH. ALL SQUARE ELBOWS AND TEES SHALL HAVE TURNING VANES. PRIOR TO FABRICATION, MECHANICAL CONTRACTOR SHALL FIELD VERIFY STRUCTURAL OBSTRUCTIONS AND CEILING SPACE LIMITATIONS AND MAKE NECESSARY DUCT MODIFICATIONS INCLUDING CHANGING OF ASPECT RATIOS, ADDING OFFSETS, AND SHIFTING LOCATIONS. PROTECT DUCT BY STORING IN A CLEAN AND DRY ENVIRONMENT PRIOR TO INSTALLATION. COVER ENDS OF EXPOSED WORK AT THE END OF EVERY SHIFT.
- ALL DUCT JOINTS, SEAMS AND BRANCH TAKEOFFS SHALL BE SEALED AIR-TIGHT WITH DUCT SEALANT EQUAL TO HARDCAST IRON-GRIP OR FOIL-GRIP TAPE EQUAL TO HARDCAST
- ROUND RUNOUTS SHALL HAVE SPIN-INS WITH DAMPERS, RECTANGULAR BRANCH DUCTS SHALL HAVE 45 DEGREE TAPS WITH AIR EXTRACTORS AND ALL TEES SHALL HAVE SPLITTER DAMPERS. PROVIDE ANY OTHER DEVICES REQUIRED TO BALANCE AIR SYSTEM.
- FLEX DUCT SHALL HAVE METALIZED VAPOR BARRIER WITH MIN. R-VALUE OF 5.0. BOTH ENDS SHALL BE SECURED WITH NYLON BANDS AND METALIZED DUCT TAPE PER MFG'S RECOMMENDATIONS AND IN ACCORDANCE WITH U.L. 181B.
- RIGID ROUND AND RECTANGULAR DUCT SHALL BE EXTERNALLY INSULATED WITH 2-INCH THICK 3/4 LB. DENSITY FIBERGLASS BLANKET WITH FSK VAPOR BARRIER AND A MIN. R-VALUE OF 6.5. STAPLE AND SEAL ALL JOINTS WITH 4-INCH-WIDE METALIZED DUCT TAPE EQUAL TO SHURFLEX SF-683.
- COORDINATE THE EXACT LOCATION OF ALL CEILING DIFFUSERS, REGISTERS, AND GRILLES WITH NEW AND EXISTING LIGHTING. PROVIDE DIFFUSERS AND REGISTERS WITH 4-WAY BLOW PATTERN UNLESS OTHERWISE NOTED. INSULATE AND SEAL ALL GRILLE AND DIFFUSER NECKS TO MAINTAIN VAPOR BARRIER AND ELIMINATE CONDENSATION.
- CONDENSATE DRAINS SHALL BE SUPPLIED FOR ALL COOLING EQUIPMENT. CONTRACTOR SHALL ENSURE PROPER INSTALLATION AND DRAINAGE AS REQUIRED BY FEDERAL, STATE, AND LOCAL CODES. CONDENSATE TRAPS FOR ALL AC UNITS SHALL BE SIZED AS RECOMMENDED BY UNIT MFG. CONDENSATE PIPING AND TRAPS SHALL BE SCHEDULE 40 PVC ROUTED TO EXTERIOR OR STORM DRAIN. INSULATE INTERIOR PIPING WITH 1/2-INCH-THICK UNICELLULAR INSULATION.
- REFRIGERANT PIPING SHALL BE TYPE ACR COPPER WITH SILVER SOLDERED JOINTS. INSTALI PER EQUIPMENT INSTALLATION INSTRUCTIONS. INSULATION SHALL BE 1-INCH-THICK MINIMUM.
- GAS PIPING SHALL BE A-53 SCHEDULE 40 BLACK STEEL WITH MALLEABLE FITTINGS. PIPING BELOW GRADE SHALL HAVE FRP COATING AND ABOVE GRADE SHALL BE PRIMED AND PAINTED. BOND ALL GAS PIPING ABOVE GRADE AND WITHIN BUILDING. PROVIDE MAGNETIC MARKER TAPE 12-INCHES ABOVE ALL BELOW GRADE PIPING.
- ALL PIPING SHALL BE SUPPORTED AND SECURED WITH SUITABLE HANGERS, STRAPS OR PIPE STANDS. SUPPORT WITH NO DROOPS OR SAGS. ALL HANGERS AND ATTACHMENTS SHALL BE PLATED, GALVANIZED OR PAINTED. PROVIDE ISOLATION ON PIPING OF DISSIMILAR MATERIALS.
- POWER WIRING, DISCONNECTS AND STARTERS NOT FURNISHED WITH HVAC EQUIPMENT AND FINAL CONNECTIONS SHALL BE BY THE E.C.
- CONTROL WIRING, RELAYS AND INTERLOCKING DEVICES SHALL BE PROVIDED BY THE M.C.
- UL LISTED DUCT SMOKE DETECTORS SHALL BE FURNISHED, INSTALLED AND TESTED BY THE M.C. THE E.C. SHALL PROVIDE 120V POWER TO EACH DUCT SMOKE DETECTOR WHERE REQUIRED. THE M.C. SHALL PROVIDE REMOTE ALARM/TEST STATIONS FOR EACH DUCT SMOKE
- TEMPERATURE CONTROLS FOR EACH HEATING-COOLING SYSTEM SHALL CONSIST OF AN ELECTRONIC PROGRAMMABLE HEATING-COOLING THERMOSTAT WITH HEAT-OFF-COOL-AUTO SYSTEM SWITCH AND AUTO-ON FAN SWITCH. MOUNT THERMOSTATS 48-INCHES ABOVE FINISHED FLOOR AND A MINIMUM 8" FROM ANY OTHER SWITCHING DEVICES.
- INSTALL EQUIPMENT TO FACILITATE SERVICING. MAINTENANCE AND REPAIR IN ACCORDANCE WITH MANUFACTURER'S INSTALLATION INSTRUCTIONS. AS WELL AS SPECIFIC INSTRUCTIONS ON PLANS. PROVIDE A 4" HOUSEKEEPING PAD FOR EACH PIECE OF MECHANICAL EQUIPMENT. COORDINATE SIZES WITH MECHANICAL EQUIPMENT SELECTED.
- PROVIDE FLEX CONNECTORS AT ALL DUCT TO EQUIPMENT CONNECTIONS NOT HAVING INTERNALLY ISOLATED FANS.
- CONTRACTOR SHALL BALANCE AIR SYSTEM TO QUANTITIES INDICATED ON PLANS AND

PROVIDE TYPE WRITTEN REPORT WITH O AND M MANUALS.

- ALL EQUIPMENT AND SYSTEMS SHALL BE WASHED, MECHANICAL AREAS CLEANED AND PAINTED SURFACES TOUCHED UP TO MATCH FACTORY APPLIED FINISHES. ALL DUCT SYSTEMS AND AIR HANDLERS SHALL BE VACUUMED AND WIPED CLEAN ON THE INSIDE PRIOR TO TURNING THE PROJECT OVER TO THE OWNER. SYSTEMS THAT HAVE NOT BEEN ADEQUATELY PROTECTED DURING INSTALLATION WILL REQUIRE CLEANING AGAIN AT THE END OF THE PROJECT.
- CONTRACTOR SHALL INSTALL A NEW SET OF PLEATED FILTERS BEFORE TURNING BUILDING
- CONTRACTOR SHALL PROVIDE BUILDING OWNER WITH A COMPLETE OPERATING AND MAINTENANCE MANUAL INCLUDING EQUIPMENT BASIC DATA, CONTROL INFORMATION, ROUTINE MAINTENANCE ACTIONS AND SERVICE AGENCIES' NAME, PHONE NUMBER, AND ADDRESS.

HVAC SHEET INDEX

- M000 HVAC TITLE SHEET
- M101 HVAC FLOOR PLAN M301 HVAC SCHEDULES
- M302 HVAC SCHEDULES
- M401 HVAC DETAILS

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■ ARCHITECT

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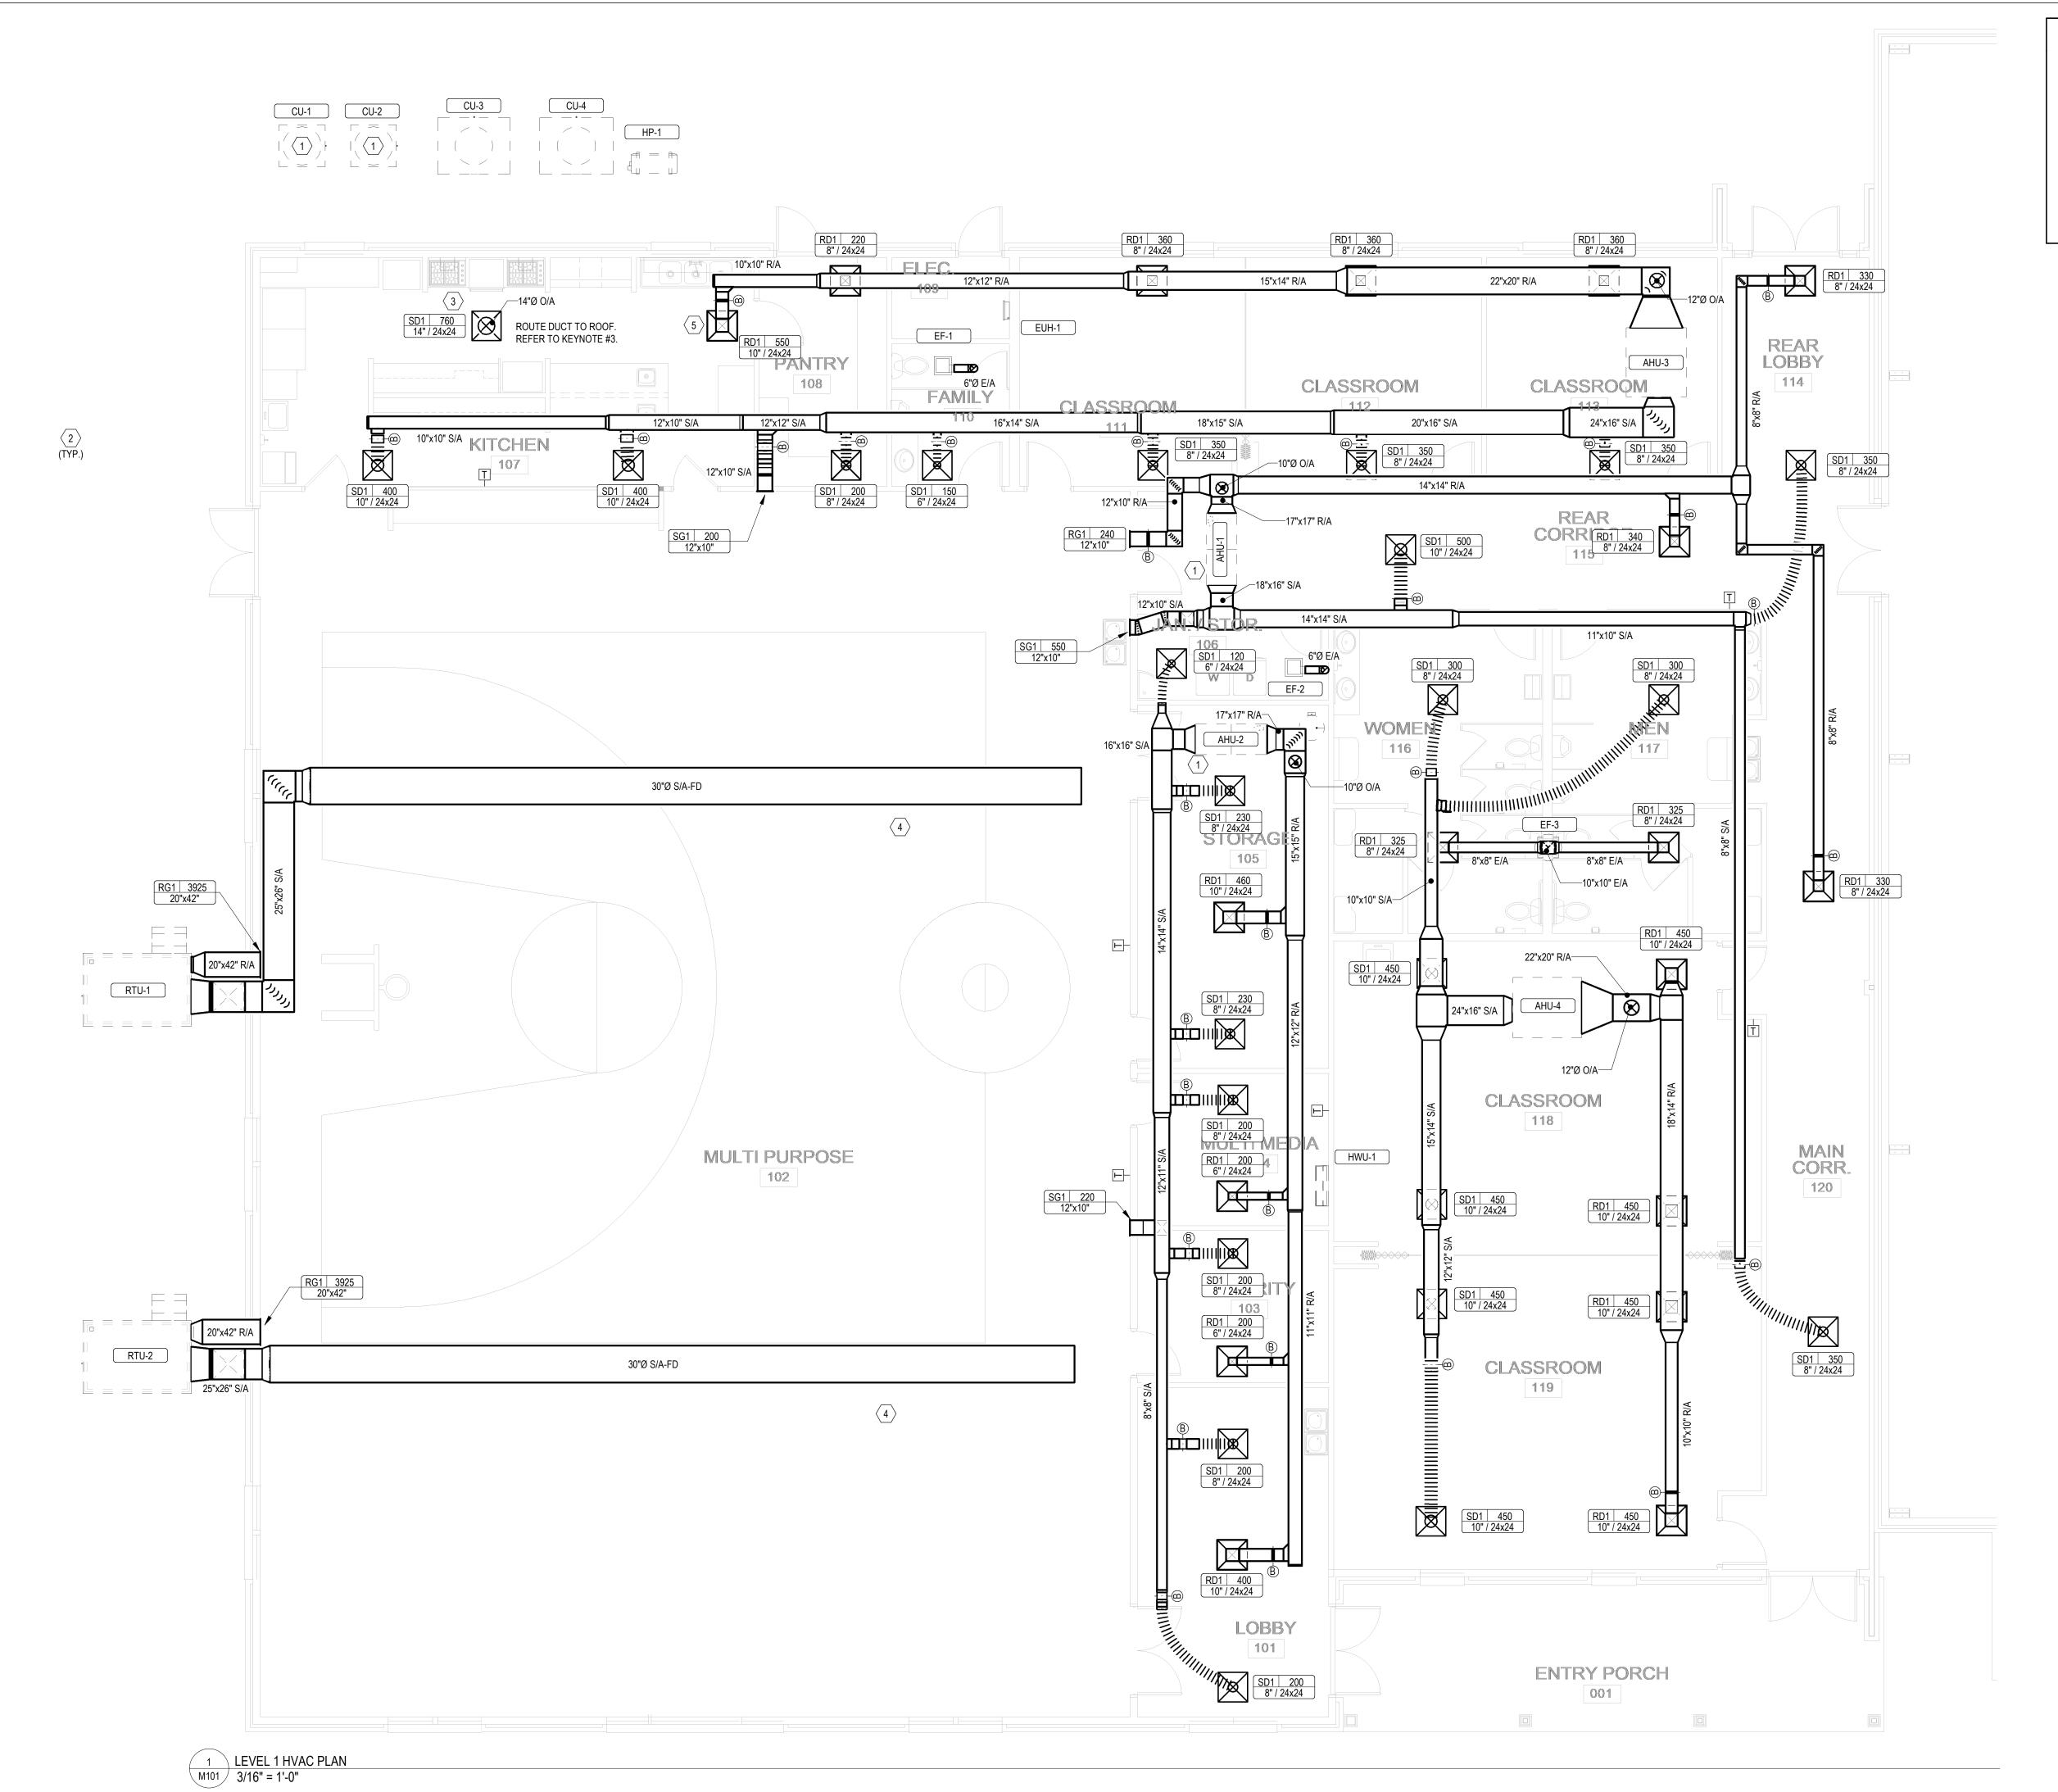
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HVAC TITLE SHEET





KEYNOTES

- EXISITING PIECE OF EQUIPMENT. CONTRACTOR TO LOCATE CURRENT EXISTING LOCATION AND SAVE PIECE OF EQUIPMENT, STORE IN A SAFE AND CLEAN ENVIORNMENT. CONTRACTOR TO THEN LOCATE TO NEW LOCATIONS SHOWN ON PLAN AND CONNECT/ASSEBMLE ACCORDINGLY.
- CONTRACTOR TO COORDINATE WITH OWNER ON FINAL LOCATION PLACEMENTS FOR OUTDOOR UNIT EQUIPMENT.
- CONTRACTOR TO INSTALL MOTORIZED DAMPER ON OUTDOOR AIR INTAKE DUCT COORDINATE WITH ELECTRICAL CONTRACTOR SUCH THAT THE DAMPER OPENS WHEN KITCHEN HOODS ARE TURNED ON, AND CLOSES WHEN HOODS ARE TURNED
- ALL FABRIC DUCT SHALL HAVE ORFICE DISPERSION OUTLETS, SET AT ORIENTATIONS OF 4:30 AND 7:30.
- RETURN DUCT SHALL MAINTAIN A DISTANCE OF AT LEST 10' FROM ANY KITCHEN APPLIANCE AND RANGE HOODS.

■ ARCHITECT

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HVAC FLOOR PLAN

2018 NC MECHANICAL CODE - VENTILATION CALCULATIONS

					OCCUPANCY	BASED	AREA	BASED	BREATHING ZONE	ZONE AIR		EVILALICE DATE
ROOM NAME	OCCUPANCY CLASS	AREA (Az)	OCCUPANCY DENSITY (PEOPLE / 1000 FT^2)		CFM / PERSON (Rp)	CFM (Rp*Pz)	CFM / SF (Ra)	CFM (Ra*Az)	OUTDOOR AIRFLOW (Vb = Rp*Pz + Ra*Az)		ZONE OUTDOOR AIRFLOW (Voz = Vbz /Ez)	EXHAUST RATE (CFM)
MULTI PURPOSE	SPORTS (PLAY AREA)	4969	0	0	0	0	0.3	1490.7	1490.7	0.8	1864	0
REAR CORRIDOR	PUBLIC SPACES (CORRIDORS)	336	0	0	0	0	0.06	20.16	20.16	0.8	26	0
MAIN CORRIDOR	PUBLIC SPACES (CORRIDORS)	498	0	0	0	0	0.06	29.88	29.88	0.8	38	0
REAR LOBBY	PUBLIC SPACES (CORRIDORS)	158	0	0	0	0	0.06	9.48	9.48	0.8	12	0
TOTALS>		5961		0							1940	0

OUTDOOR AIR INTAKE FLOW RATE: 1940 0 EXHAUST FLOW RATE PLUS 8% FOR PRESSURIZATION 1940 FINAL VENT. AIR REQUIREMENT (GREATER OF THE ABOVE):

BALANCE RTU-1 TO PROVIDE 870 CFM OF OUTSIDE AIR. BALANCE RTU-2 TO PROVIDE 870 CFM OF OUTSIDE AIR. BALANCE AHU-1 TO PROVIDE 360 CFM OF OUTSIDE AIR.

2018 NC MECHANICAL CODE - VENTILATION CALCULATIONS

ZONE 2

					OCCUPANCY	BASED	AREA	BASED	BREATHING ZONE	ZONE AIR		
ROOM NAME	OCCUPANCY CLASS	AREA (Az)	OCCUPANCY DENSITY (PEOPLE / 1000 FT^2)	OCCUPANCY (Pz)	CFM / PERSON (Rp)	CFM (Rp*Pz)	CFM / SF (Ra)	CFM (Ra*Az)	OUTDOOR AIRFLOW (Vb = Rp*Pz + Ra*Az)	DISTRIBUTION	1 (VO) - VD2 (F2)	EXHAUST RATE (CFM)
JANITOR/STORAGE	ASHRAE62.1-2019-JC	115	0	0	10	0	0	0	0	0.8	0	115
STORAGE	RETAIL STORES (STORAGE ROOMS)	208	0	0	0	0	0.06	12.48	12.48	0.8	16	0
MULTIMEDIA	EDUCATION (MEDIA CENTER)	134	25	4	10	40	0.12	16.08	56.08	0.8	71	0
SECURITY	CORRECTIONAL (GUARD STATIONS)	208	15	4	5	20	0.06	12.48	32.48	0.8	41	0
LOBBY	OFFICES (MAIN ENTRY LOBBY)	290	10	3	5	15	0.06	17.4	32.4	0.8	41	0
TOTALS>		955		11							169	115
				_								

169

124.2

169

OUTDOOR AIR INTAKE FLOW RATE: EXHAUST FLOW RATE PLUS 8% FOR PRESSURIZATION FINAL VENT. AIR REQUIREMENT (GREATER OF THE ABOVE):

BALANCE AHU-2 TO PROVIDE 340 CFM OF OUTSIDE AIR

2018 NC MECHANICAL CODE - VENTILATION...

ROOM NAME	OCCUPANCY CLASS	AREA	OCCUPANCY DENSITY (PEOPLE / 1000	OCCUPANCY	OCCUPANCY	BASED	AREA B	ASED	BREATHING ZONE OUTDOOR AIRFLOW (Vb = Rp*Pz	ZONE AIR DISTRIBUTION	ZONE OUTDOOR AIRFLOW	EXHAUST RATE
ROOM NAME	OCCOPANCY CLASS	(Az)	FT^2)	(Pz)	CFM / PERSON	CFM	CFM / SF	CFM	+ Ra*Az)	EFFECTIVENESS	(Voz = Vbz /Ez)	(CFM)
WOMEN'S BR	PUBLIC SPACES (TOILET	305	0	0	0	0	0	0	0	0.8	0	200
MEN'S BR	PUBLIC SPACES (TOILET	292	0	0	0	0	0	0	0	0.8	0	200
CLASSROOM	EDUCATION (CLASSROOM	603	35	22	7.5	165	0	0	165	0.8	207	0
CLASSROOM	EDUCATION (CLASSROOM	603	35	22	7.5	165	0	0	165	0.8	207	0
TOTALS>		1803		0							414	400

414 OUTDOOR AIR INTAKE FLOW RATE: EXHAUST FLOW RATE PLUS 8% FOR PRESSURIZATION 432 432 FINAL VENT. AIR REQUIREMENT (GREATER OF THE ABOVE):

BALANCE RTU-5 TO PROVIDE CFM OF OUTSIDE AIR

2018 NC MECHANICAL CODE - VENTILATION...

DOOM NAME	OCCUPANOV CLASS	AREA	OCCUPANCY DENSITY (PEOPLE / 1000	OCCUPANCY	OCCUPANCY	BASED	AREA E	BASED	BREATHING ZONE OUTDOOR AIRFLOW (Vb = Rp*Pz	ZONE AIR DISTRIBUTION	ZONE OUTDOOR	EXHAUST RATE
ROOM NAME	OCCUPANCY CLASS	(Az)	FT^2)	(Pz)	CFM / PERSON	CFM	CFM / SF	CFM	+ Ra*Az)	EFFECTIVENESS	AIRFLOW (Voz = Vbz /Ez)	(CFM)
CLASSROOM	EDUCATION (CLASSROO	243	35	9	7.5	67.5	0	0	67.5	0.8	85	0
CLASSROOM	EDUCATION (CLASSROO	243	35	9	7.5	67.5	0	0	67.5	0.8	85	0
CLASSROOM	EDUCATION (CLASSROO	238	35	9	7.5	67.5	0	0	67.5	0.8	85	0
FAMILY	EDUCATION (DAY CARE)	77	25	2	10	20	0.18	13.86	33.86	0.8	43	0
PANTRY	ASHRAE 62.1-2019	135	2	1	5	5	0.06	8.1	13.1	0.8	17	0
KITCHEN	FOOD & BEVERAGE	520	0	0	0	0	0	0	0	0.8	0	364
TOTALS>		1456		30							315	364

OUTDOOR AIR INTAKE FLOW RATE: EXHAUST FLOW RATE PLUS 8% FOR PRESSURIZATION 393.12 FINAL VENT. AIR REQUIREMENT (GREATER OF THE ABOVE): 394

BALANCE RTU-6 TO PROVIDE CFM OF OUTSIDE AIR

■ ARCHITECT

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120 SOMMERVILLE PARK ROAD RALEIGH, NC 27603 NC FIRM # C-3824



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HVAC SCHEDULES

Drawing No.

									PA	CKAGED	ROOFTO	P UNIT	SCHED	ULE									
						SUPPLY AIR	OUTSIDE AIR	EXHAUST	SECONDARY FAN		RESSOR GERANT			UNIT	DIMENSION	NS	IINIT						
ID	DESCRIPTION	MANUFACTURER	MODEL NO.	QTY	ARRANGEMENT	FLOW	FLOW	AIRFLOW	EXHAUST	TYPE	CHARGE	SEER	EER	LENGTH	WIDTH	HEIGHT	WEIGHT	FLA	MCA	MOCP	VOLT	PH	REMARKS
RTU-1	ROOFTOP UNIT	CARRIER	50FCQM12A55-0A0A0	1	HORIZONTAL	4000 CFM	870 CFM	795 CFM	Yes	R-410A	21 lb	14.3	11	7' - 4 1/8"	4' - 11 1/2"	4' - 1 3/8"	955 lb	21.7 A	86.0 A	90.0 A	208 V	3	PROVIDE 10KW OF AUXILLARY HEAT. EQUAL OR EQUIVALENT IS ACCEPTABLE.
RTU-2	ROOFTOP UNIT	CARRIER	50FCQM12A55-0A0A0	1	HORIZONTAL	4000 CFM	870 CFM	795 CFM	Yes	R-410A	21 lb	14.3	11	7' - 4 1/8"	4' - 11 1/2"	4' - 1 3/8"	955 lb	21.7 A	86.0 A	90.0 A	208 V	3	PROVIDE 10KW OF AUXILLARY HEAT. EQUAL OR EQUIVALENT IS ACCEPTABLE.

							ELEC	TRIC UNIT	Γ HEATER	SCH	EDULE										
							ELECTRIC HEA			HE	ATING ELEM	MENT	U	NIT DIMENSION	NS						
								AIRSIDE													
							DESIGN									AFF	UNIT				
ID	MANUFACTURER	MODEL NO.	QTY	TYPE	ARRANGEMENT	CAP	FLOW	EAT(db)	LAT(db)	QTY	POWER	SCR	LENGTH	WIDTH	HEIGHT	ELEVATION	WEIGHT	FLA	VOLT	PH	REMARKS
EUH-1	BERKO	FRC	1	CABINET	RECESSED MOUNT	5118 Btu/h	100 CFM	55.0 °F	102.4 °F	1	1.5 kW	No	3 7/8"	1' - 2 5/16"	1' - 6 1/4"	1' - 0"	25 lb	12.5 A	120 V	1	

							SPLIT	SYSTEM AIR SO	OURCE HE	EAT PU	MP							
				NOMINAL	COMPRESSOR			UNIT DIMENSIONS									INTERLOCK	
ID	MANUFACTURER	MODEL NO.	QTY	COOLING	REFRIGERANT TYPE	EER	LENGTH	WIDTH	HEIGHT	UNIT WEIGHT	FLA	MCA	МОСР	VOLT	PH	FREQ	ID	REMARKS
CU-1	UNKNOWN	UNKNOWN	1	4.00 ton	-	0	2' - 10 1/4"	3' - 1 1/4"	3' - 9 1/8"	0 lb	0.0 A	0.0 A	15.0 A	0 V	0	0 Hz	AHU-1	EXISTING EQUIPMENT ON SITE.
CU-2	UNKNOWN	UNKNOWN	1	4.00 ton	-	0	2' - 10 1/4"	3' - 1 1/4"	3' - 9 1/8"	0 lb	0.0 A	0.0 A	15.0 A	0 V	0	0 Hz	AHU-2	EXISTING EQUIPMENT ON SITE.
CU-3	CARRIER	38AUQM07A0A5	1	6.00 ton	R-410A	11	4' - 11 13/32"	3' - 9 29/32"	3' - 6 3/8"	444 lb	20.0 A	25.0 A	30.0 A	208 V	3	60 Hz	AHU-3	
CU-4	CARRIER	38AUQM07A0A5	1	6.00 ton	R-410A	11	4' - 11 13/32"	3' - 9 29/32"	3' - 6 3/8"	444 lb	20.0 A	25.0 A	30.0 A	208 V	3	60 Hz	AHU-4	
HP-1	CARRIER	38MARBQ09AA3	1	0.75 ton	R-410A	16.2	11 15/16"	2' - 6 1/8"	1' - 9 13/16"	75 lb	0.0 A	15.0 A	15.0 A	208 V	1	60 Hz	HWU-1	

						A	IR HANDLI	NG UNI	Γ SUMMAF	RY SCHEDU	LE							
				VENTILATION	SUPPLY FAN	RETURN/EXHAUST FAN			UNIT DIMENS	IONS							INTERLOCK	
				DESIGN	DESIGN	AIRFLOW	NET COOLING				UNIT						CONDENSING	
ID	MANUFACTURER	MODEL NO.	QTY	AIRFLOW	AIRFLOW	DESIGN	CAP	LENGTH	WIDTH	HEIGHT	WEIGHT	FLA	MCA	MOCP	VOLT	PH	UNIT ID	REMARKS
AHU-1	UNKNOWN	UNKNOWN	1	360 CFM	1600 CFM	1240 CFM	0 Btu/h	0"	0"	0"	0 lb	0.0 A	0.0 A	0.0 A	0 V	0		EXISTING EQUIPMENT ON SITE.
AHU-2	UNKNOWN	UNKNOWN	1	340 CFM	1600 CFM	1260 CFM	0 Btu/h	0"	0"	0"	0 lb	0.0 A	0.0 A	0.0 A	0 V	0		EXISTING EQUIPMENT ON SITE.
AHU-3	Carrier	40RFQA07A2A5	1	550 CFM	2400 CFM	1850 CFM	72000 Btu/h	4' - 1"	2' - 4 3/16"	4' - 8 1/16"	380 lb	6.4 A	8.0 A	15.0 A	208 V	3	CU-3	PROVIDE 5KW OF AUXILLARY HEAT.
AHU-4	Carrier	40RFQA07A2A5	1	600 CFM	2400 CFM	1800 CFM	72000 Btu/h	4' - 1"	2' - 4 3/16"	4' - 8 1/16"	380 lb	6.4 A	8.0 A	15.0 A	208 V	3	CU-4	PROVIDE 5KW OF AUXILLARY HEAT.

COOLING COIL UNIT DIMENSIONS UNIT	
ID DESCRIPTION MANUFACTURER MODEL NO. QTY ARRANGEMENT NOMINAL CAP LENGTH WIDTH HEIGHT WEIGHT MCA VOLT PH	REMARKS
HWU-1 Heat Pump Indoor Unit High Wall Ductless System Carrier Corporation 40MAQB09B3 1 WALL-MOUNT 0.75 ton 2' - 8 7/8" 7 13/16" 11 1/32" 20 lb 0.2 A 208 V 1	POWERED FROM OUTDOOR HEAT PUMP UNIT.

						EXH	IAUST F	AN SCI	HEDUL	.E							
						FA	N	UNIT	T DIMENSI	ONS							
						DESIGN	DRIVE				UNIT						
ID	DESCRIPTION	MANUFACTURER	MODEL NO.	QTY	TYPE	AIRFLOW	TYPE	LENGTH	WIDTH	HEIGHT	WEIGHT	FLA	MCA	MOCP	VOLT	PH	REMARKS
EF-1	CEILING FAN	GREENHECK	SP-110-VG	1	CEILING	70 CFM	DIRECT	10 1/2"	11 3/8"	7 5/8"	12 lb	0.2 A	0.3 A	15.0 A	120 V	1	EQUAL OR EQUIVALENT IS ACCEPTABLE.
EF-2	CEILING FAN	GREENHECK	SP-110-VG	1	CEILING	70 CFM	DIRECT	10 1/2"	11 3/8"	7 5/8"	12 lb	0.2 A	0.3 A	15.0 A	120 V	1	EQUAL OR EQUIVALENT IS ACCEPTABLE.
EF-3	POWER ROOF VENTILATOR	GREENHECK	G-095	1	DOWNBLAST	650 CFM	DIRECT	1' - 5"	1' - 5"	1' - 2 5/8"	29 lb	1.5 A	1.9 A	15.0 A	208 V	1	EQUAL OR EQUIVALENT IS ACCEPTABLE.

				GRILLES,	REGI	STERS AND DIFFUSERS	SCHEDULE	
						INSTALLATION		
ID	MANUFACTURER	MODEL	MATERIAL	FINISH	QTY	TYPE	SPECIFICATION	NOTES
RD1	Titus	PAR-AA	ALUMINUM	WHITE ENAMEL	18	LAY-IN INSTALLATION	PERFORATED DIFFUSER WITH FACE MOUNTED DEFLECTORS	
RG1	Titus	350FL	ALUMINUM	WHITE ENAMEL	3	SURFACE MOUNT INSTALLATION		
SD1	Titus	TMS-AA	ALUMINUM	WHITE ENAMEL	24	LAY-IN INSTALLATION	HIGH PERFORMANCE 3-CONE DIFFUSER	
SG1	Titus	301FL	ALUMINUM	WHITE ENAMEL	3	SURFACE MOUNT INSTALLATION		

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HVAC SCHEDULES

Drawing No.

2018 APPENDIX B

BUILDING CODE SUMMARY FOR ALL COMMERCIAL PROJECTS


MECHANICAL DESIGN (PROVIDE ON THE MECHANICL SHEETS IF APPLICABLE)


MECHANICAL SUMMARY


MECHANICAL SYSTEMS, SERVICE SYSTEMS AND EQUIPMENT


Thermal Zone	3A	
winter dry bulb: _	22 F	
summer dry bulb:		
Interior design conditions		
winter dry bulb: _	68 F	
summer dry bulb:		
relative humidity:	50%	
Building heating load:	107,500 BTU	
Building cooling load:	489,000 BTU	
Mechanical Spacing Cond	litioning System	
Unitary	• •	
description of v	SEE PLANS	
heating efficien		
e e	•	
cooling efficien	•	
size category of	t unit:	
Boiler	TO 1 1	N/A
Size category.	If oversized, state reason.:	N/A
Size category. Chiller	If oversized, state reason.: If oversized, state reason.:	N/A N/A


List equipment efficiencies:

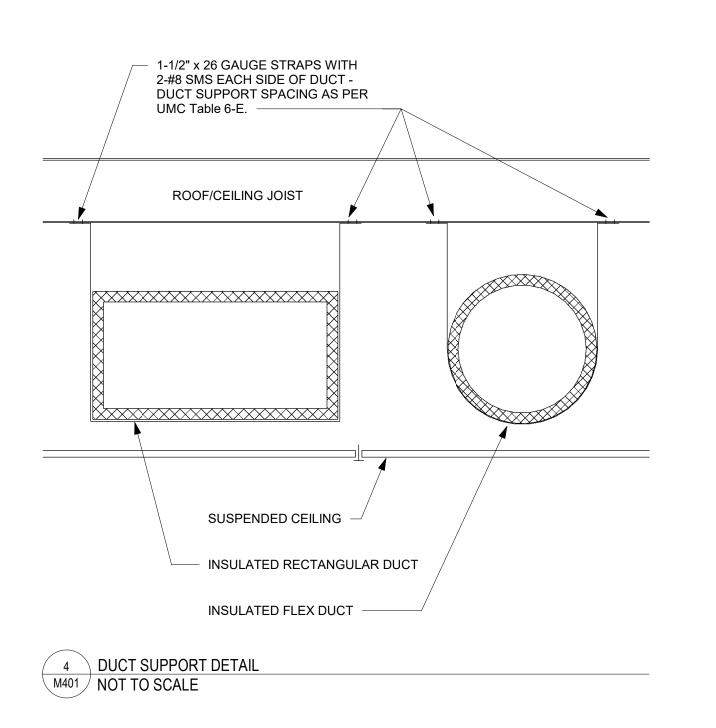


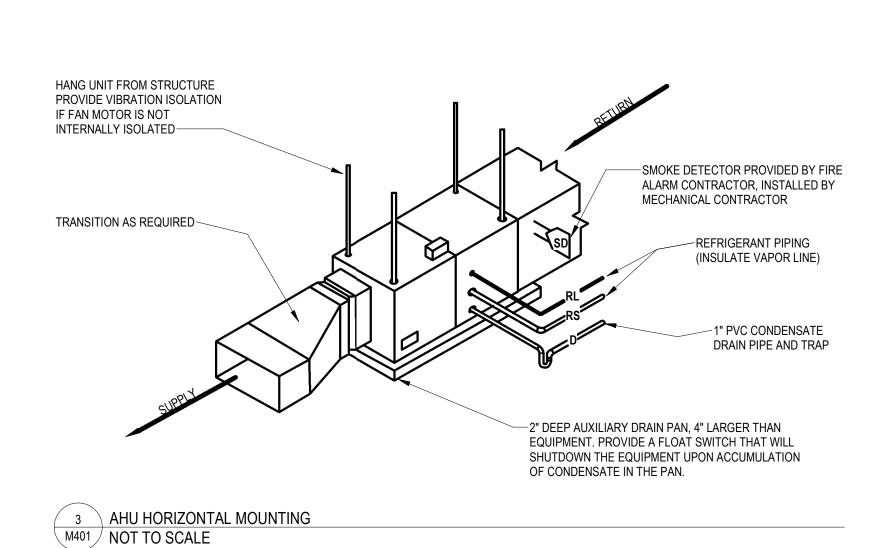

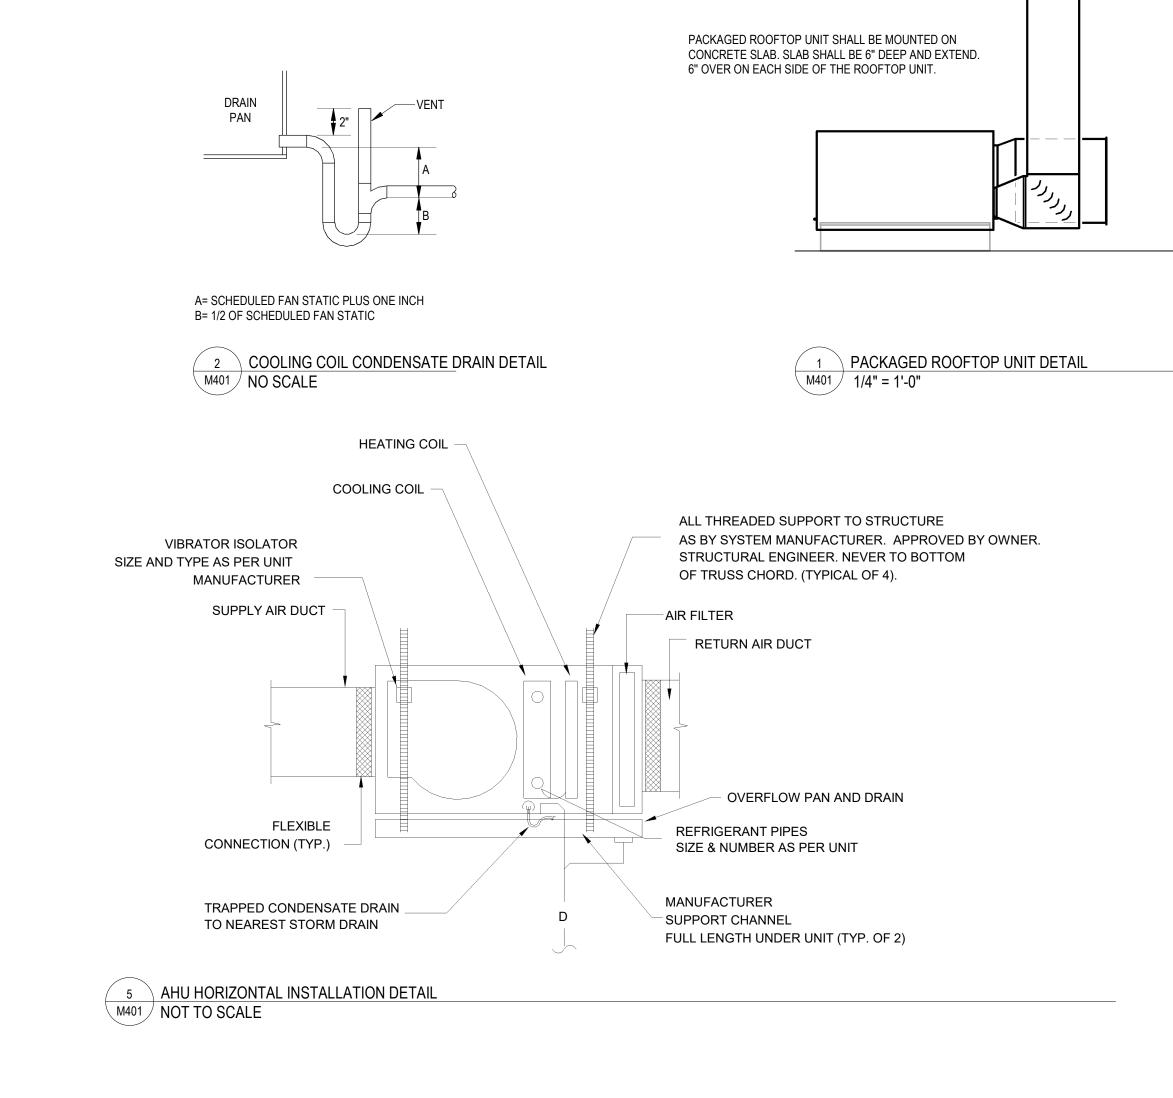

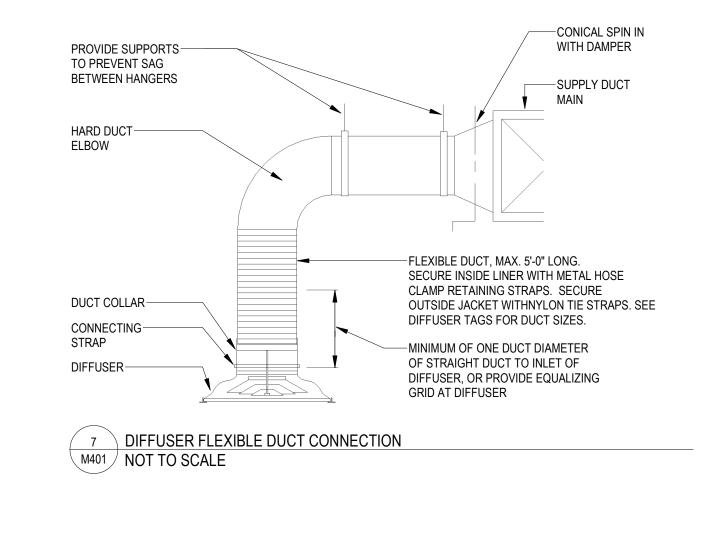


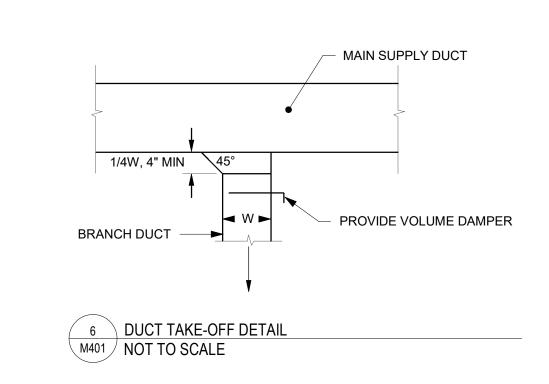

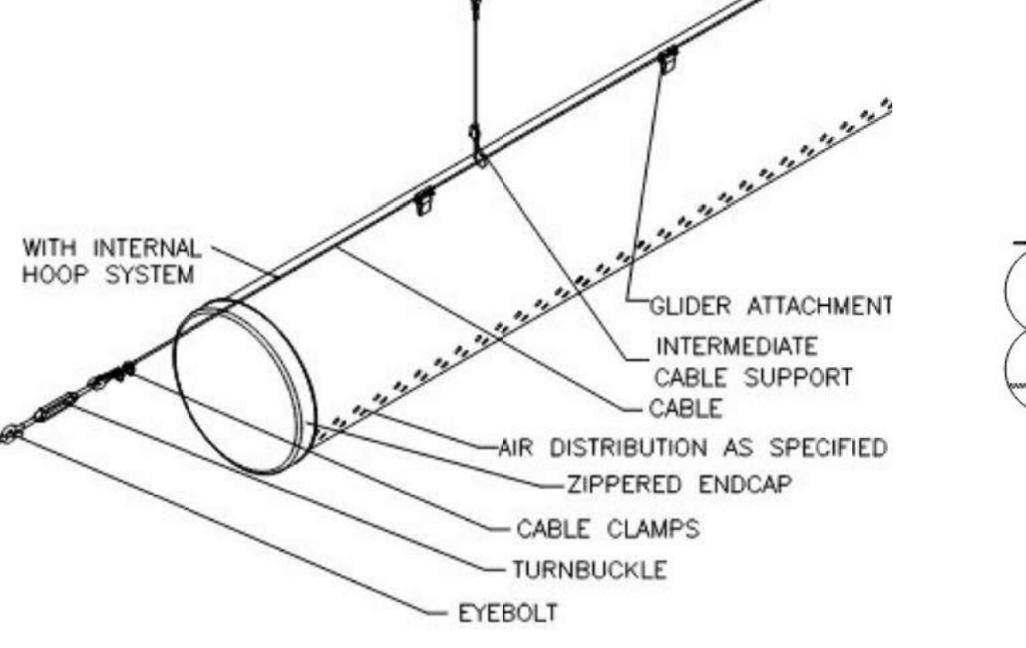


11 FABRIC DUCT SUSPENSION DETAIL


M401 NOT TO SCALE

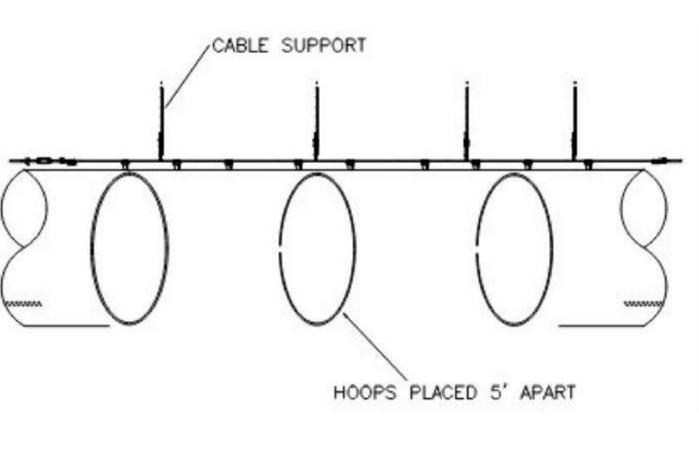

10 FABRIC DUCT HOOP SECTION DETAIL M401 NOT TO SCALE M401 NOT TO SCALE

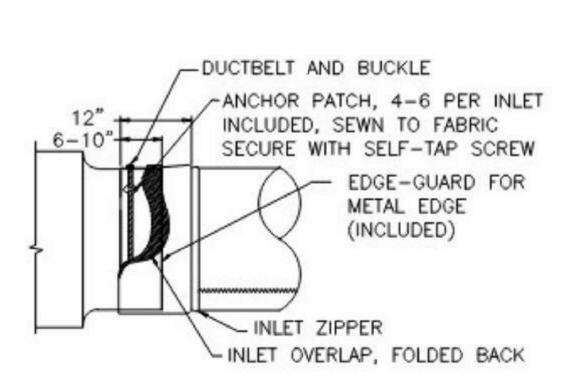

FABRIC DUCT INLET ATTACHMENT DETAIL

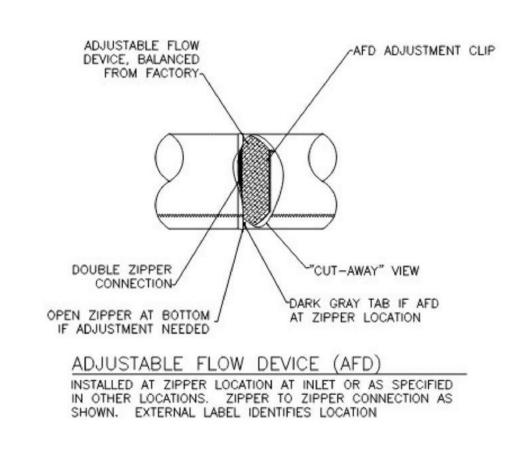

8 FABRIC DUCT ADJUSTABLE FLOW DETAIL M401 NOT TO SCALE

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HVAC DETAILS




LOW VOLTAGE

M/C MOMENTARY CONTACT

MECHANICAL CONTRACTOR

MAXIMUM

MAG.S MAGNETIC STARTER

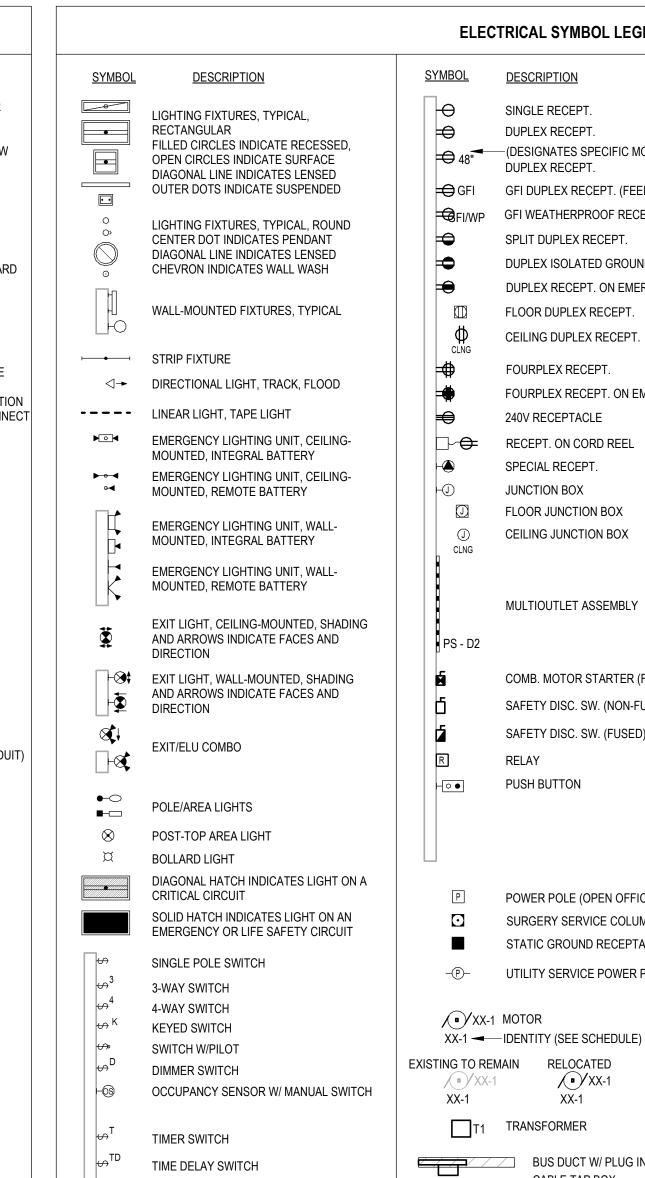

TIME CONTROL SWITCH

FIRE ALARM BELL

HED

—(S)

FIRE ALARM PULL STATION

FIRE ALARM HORN W/STROBE

FIRE ALARM BELL W/STROBE

FIRE ALARM CHIME W/STROBE

FIRE ALARM DOOR HOLDER

FIRE ALARM DOOR CLOSER

SPRINKLER FLOW SWITCH

THERMAL DETECTOR

DUCT SMOKE DETECTOR

CEILING SMOKE DETECTOR

FIRE ALARM SHUT DOWN RELAY

SPRINKLER VALVE TAMPER SWITCH

FIRE ALARM SPEAKER W/STROBE

ELECTRICAL SYMBOL LEGEND <u>SYMBOL</u> **DESCRIPTION** SYMBOL DESCRIPTION Ю SINGLE RECEPT TELEPHONE OUTLET DUPLEX RECEPT \Rightarrow FLOOR TELEPHONE OUTLET (DESIGNATES SPECIFIC MOUNTING HEIGHT) VOICE/DATA OUTLET DUPLEX RECEPT. -# OF VOICE AND # OF DATA OUTLETS GFI DUPLEX RECEPT. (FEED THROUGH) FOR EXAMPLE 1V2D = 1 VOICE, 2 DATA GFI WEATHERPROOF RECEPT. FLOOR DATA OUTLET SPLIT DUPLEX RECEPT. CEILING DATA OUTLET DUPLEX ISOLATED GROUND RECEPT. H(M) MICROPHONE OUTLET DUPLEX RECEPT. ON EMERG. CIRCUIT CATV OUTLET \square FLOOR DUPLEX RECEPT. $+ \otimes$ TV OUTLET CEILING DUPLEX RECEPT. VOLUME CONTROL FOURPLEX RECEPT. DOOR BELL DOOR BUZZER FOURPLEX RECEPT. ON EMERG. CIRCUIT H DOOR CHIME 240V RECEPTACLE DOOR SIGNAL RECEPT. ON CORD REEL AUTO DOOR PUSH PAD SPECIAL RECEPT. ELECTRIC STRIKE JUNCTION BOX MAGNETIC LOCK FLOOR JUNCTION BOX COMBINATION LOCK CEILING JUNCTION BOX DOOR CONTACT HCR CARD READER SECURITY KEYPAD ⊢MD-**►** MOTION DETECTOR MULTIOUTLET ASSEMBLY NURSE CALL EMERG. STATION NURSE CALL CODE BLUE STATION NURSE CALL DUTY STATION COMB. MOTOR STARTER (FUSED) NURSE CALL STAFF STATION SAFETY DISC. SW. (NON-FUSED) NURSE CALL PATIENT STATION SAFETY DISC. SW. (FUSED) NURSE CALL DOME LIGHT (1-COLOR) NURSE CALL DOME LIGHT (2-COLORS) **PUSH BUTTON ELECTRICAL SHEET INDEX** SHEET DESCRIPTION E000 ELECTRICAL TITLE SHEET E101 ELECTRICAL POWER PLAN E201 ELECTRICAL LIGHTING PLAN POWER POLE (OPEN OFFICE STYLE) E301 ELECTRICAL SCHEDULES SURGERY SERVICE COLUMN E401 | ELECTRICAL DETAILS E501 ELECTRICAL SYSTEMS PLAN STATIC GROUND RECEPTACLE FIRE ALARM PLAN E602 FIRE ALARM DETAILS UTILITY SERVICE POWER POLE SHEET COUNT: 8

DEMOLISHED

(1) XX-1

RELOCATED

(•) XX-1

BUS DUCT W/ PLUG IN DISCONNECT

XX-1

CABLE TAP BOX

TRANSFORMER

ELECTRICAL SYMBOL NOTES LIGHTING FIXTURE TAG DESCRIPTORS 1d TOP VALUE: FIXTURE TYPE ID. BOTTOM VALUE, NUMBER: CIRCUIT NUMBER, REFER TO DRAWINGS FOR BOTTOM VALUE, LOWERCASE LETTER: SWITCH DESIGNATION. ABSENCE OF A SWITCH ID INDICATES FIXTURE IS CONTROLLED BY THE ONLY SWITCH IN THE SPACE. "x" IN PLACE OF THE SWITCH ID INDICATES NIGHT LIGHT, UNSWITCHED. EXIT LIGHTS. STEM INDICATES WALL MOUNTING. NO STEM INDICATES CEILING MOUNTING. SHADED AREA INDICATES ILLUMINATED FACE(S). ARROW INDICATES DIRECTIONAL ARROW ON ILLUMINATED FACE(S). THE CIRCUIT DESIGNATION IS INDICATED BY A NUMBER. EXAMPLE: THE WALL MOUNTED EXIT LIGHT TYPE "E1" WITH SINGLE FACE AND DIRECTIONAL ARROW IS CONNECTED TO CIRCUIT 1. DEVICES. THE CIRCUIT DESIGNATION IS INDICATED BY A NUMBER. THE SWITCH DESIGNATION IS INDICATED BY A LOWER CASE LETTER. EXAMPLE: SPLIT DUPLEX RECEPTACLE IS CONNECTED TO CIRCUIT 1 AND ONE RECEPTACLE OUTLET IS CONTROLLED BY SWITCH "d". THE CONTROL DEVICE DESIGNATION IS INDICATED BY A LOWER CASE LETTER. EXAMPLE: SINGLE POLE SWITCH "d" TO CONTROL LIGHTING FIXTURES INDICATED WALL BOX DIMMER WITH SIZE AS INDICATED AT DEVICE. EXAMPLE: 600 WATT WALL BOX DIMMER TO CONTROL LIGHTING FIXTURES INDICATED BY "e". SEE SPECIFICATIONS FOR WATTAGE IF NOT INDICATED. SPECIAL CONNECTIONS. THE EQUIPMENT IS INDICATED BY A NUMBER IN A CIRCLE. SEE THE MOTOR AND EQUIPMENT SCHEDULE FOR THE LOAD DESCRIPTION AND TYPE OF CONNECTION. THE CIRCUIT DESIGNATION IS INDICATED BY NUMBER(S) ADJACENT TO THE SYMBOL. EXAMPLE: EQUIPMENT NO ELEC-1; 1 PHASE CONNECTION TO CIRCUITS 2, 4. PANELBOARDS. PANELBOARD DOORS MAY BE SHOWN TO INDICATE OPENING SIDE OF RECESSED PANELBOARDS. SEE PANELBOARD IDENTIFICATION FOR DESIGNATION CODES. ──FLOOR CLEARANCE AREA MOTOR CONNECTIONS. THE MOTOR IS INDICATED BY A NUMBER WITHIN OR CHARACTERS ADJACENT TO THE MOTOR SYMBOL. SEE THE MOTOR AND EQUIPMENT SCHEDULE FOR THE MOTOR DESCRIPTION AND ELECTRICAL TRANSFORMERS. THE TRANSFORMER TYPE IS INDICATED BY A NUMBER FOLLOWING THE UPPER CASE LETTER "T". SEE THE TRANSFORMER SCHEDULE OR THE SINGLE LINE DIAGRAM FOR THE TRANSFORMER DESCRIPTION AND REQUIREMENTS. EXAMPLE: TRANSFORMER TYPE "T1". CONDUIT IN CEILING, FLOOR OR WALL AS REQUIRED BY FIELD CONDITIONS CONDUIT IN FLOOR CONDUIT SHOWN WITHOUT SLASH MARKS SHALL CONTAIN 1 # 12 CONDUCTOR PER PHASE, NEUTRAL, AND GROUND IN 1/2" CONDUIT UNLESS SPECIFIC EQUIPMENT REQUIRES A DIFFERENT SIZE. CONDUIT SHOWN SHALL CONTAIN 1 # 10 CONDUCTOR PER PHASE IN ELECTRICAL CODE SIZED MINIMUM CONDUIT UNLESS A CONDUCTOR AND CONDUIT SIZE IS SHOWN ADJACENT. HOME RUN TO BRANCH CIRCUIT PANELBOARD. THE PANELBOARD DESIGNATION IS SHOWN ADJACENT TO THE HOME RUN ARROW AS A NUMERATOR AND THE CIRCUIT DESIGNATION IS SHOWN AS THE DENOMINATOR. CIRCUIT BREAKER SIZES (AMPS/NUMBER OF POLES) ARE SHOWN IN THE PANELBOARD SCHEDULE WITH THE CORRESPONDING PANELBOARD AND CIRCUIT DESIGNATION. EXAMPLE: HOME RUN TO PANELBOARD P4N-102; CIRCUITS 1, 3, 5. GRAPHICAL REPRESENTATION OF PHASING, TYPICAL FOR ALL SYMBOLS. ITEM TO BE REMOVED **■** EXISTING TO REMAIN EXISTING TO BE REMOVED AREA NOT IN **₩** $\times\!\!\times\!\!\times\!\!\times$ CONTRACT **REVISION NUMBER - SHOWN ON PLANS** - NUMBER OF DETAIL ON SHEET √ --- NUMBER OF SHEET WHERE DETAIL APPEARS. KEYED NOTE (SEE SCHEDULE) ROOM NAME AND NUMBER

PANELBOARD IDENTIFICATION 1. EQUIPMENT DESIGNATION: -L = LIGHTING P = POWER D = DISTRIBUTION S = SWITCHBOARD M = MOTOR CONTROL CENTER -<u>5. PANEL NO. DESIGNATION:</u> R = RELAY PANEL 01 = PANELBOARD #1 02 = PANELBOARD #2 2. VOLTAGE DESIGNATION 03 = PANELBOARD #3 1 = 120/240V - 1PH 2 = 240V - 3PH 3 = 208Y/120V - 3PH4 = 480Y/277V - 3PH -4. FLOOR DESIGNATION: 5 = 120/208 - 1PH B = BASEMENT 6 = SPECIAL G = GROUND 1 = FIRST FLOOR 3. SYSTEM DESIGNATION: 2 = SECOND FLOOR N = NORMALE = EMERGENCY C = POWER CONDITIONED U = UNINTERRUPTIBLE POWER SOURCE

ELECTRICAL NOTES

- ELECTRICAL PLANS ARE INTENDED TO PROVIDE INFORMATION FOR INSTALLATION OF A COMPLETE ELECTRICALSYSTEM. PROVIDE ALL ESSENTIAL LABOR, MATERIALS & DEVICES REQUIRED TO PRODUCE A QUALITY END PRODUCT.
- CONTRACTOR SHALL REVIEW & BECOME FAMILIAR WITH THE WORK OF ALL TRADES FOR PURPOSES OF COORDINATION AND ROUTING. CONTRACTOR SHALL PROVIDE REQUIRED PLANNING, COORDINATION AND SEQUENCING OF ELECTRICAL INSTALLATION WITH BUILDING COMPONENTS AND OTHER TRADES.
- ALL WORK SHALL COMPLY WITH THE NATIONAL ELECTRICAL CODE (NEC). WORKMANSHIP SHALL MEET OR EXCEED INDUSTRY STANDARDS.
- ELECTRICAL CONTRACTOR SHALL PROVIDE ALL DISCONNECTS, STARTERS, DEVICES AND ELECTRICAL COMPONENTS UNLESS SPECIFICALLY NOTED AS PROVIDED BY OTHERS.
- ELECTRICAL CONTRACTOR SHALL PROVIDE ALL LINE AND LOAD SIDE WIRING INCLUDING ALL TERMINATIONS TO EQUIPMENT PROVIDED UNDER OTHER TRADES. POWER WIRING TO CONTROL DEVICES SHALL BE PROVIDED BY E.C.. INTERLOCK WIRING SHALL BE PROVIDED BY THE CONTRACTOR INSTALLING THE CONTROL DEVICE.
- ALL WIRING, PANELBOARDS, DEVICES AND OTHER LIKE MATERIALS SHALL BE UL LISTED & LABELED. ALL MATERIALS SHALL MEET THE NE FOR THE INTENDED USE AND INSTALLED IN ACCORDANCE WITH THE NEC.
- PROVIDE THHN/THWN COPPER WIRE. PROVIDE A MINIMUM WIRE SIZE OF #12. ALL WIRE #8 AND LARGER SHALL BE STRANDED. CONDUCTORS AND CONDUIT ON PLANS AND SCHEDULES REFLECT AMPACITIES PER NEC 310-16 75C RATING. CONTRACTOR SHALL VERIFY ALL TERMINATIONS, LUGS, ETC. ARE RATED FOR USE PER NEC 110-4C. OTHERWISE, PROVIDE CONDUCTOR AND CONDUIT SIZED PER LOWEST TEMPERATURE RATING OF ANY TERMINATION WITHIN A CIRCUIT. PROVIDE CABLE OR CONDUIT AND WIRE AS REQUIRED TO ACHIEVE CIRCUITING SHOWN. SIZE CONDUCTORS PER NEC AMPACITY AND WIRE FILL CRITERIA. PROVIDE DEDICATED NEUTRAL AND GROUND CONDUCTORS FOR CIRCUITING, UNLESS NOTED OTHERWISE. INCREASE BRANCH CIRCUIT AND/OR FEEDER CONDUCTORS INCLUDING EQUIPMENT GROUNDING CONDUCTORS PROPORTIONALLY FOR NO MORE THAN 3% VOLTAGE DROP ON BRANCH CIRCUITS AND 2% ON FEEDERS PER ENERGY CODE.
- PROVIDE M.C. CABLE FOR ALL SINGLE PHASE BRANCH CIRCUITS 30 AMPS AND SMALLER. PROVIDE CONDUIT FOR ALL OTHER WIRING. EMT OR RIGID SHALL BE USED WHERE EXPOSEDTO PHYSICAL DAMAGE. CONDUIT ABOVE GRADE SHALL BE STEEL. CONDUIT BELOW GRADEMAY BE PVC CHANGING TO STEEL IN THE ELBOW TURNING UP. EMT SHALL NOT BE USED IN DIRECT CONTACT WITH THE EARTH OR WHERE EXPOSED TO SEVERE PHYSICAL DAMAGE. FITTINGS ON STEEL CONDUIT SHALL BE COMPRESSION TYPE.
- NONMETALLIC-SHEATHED CABLE MAY BE UTILZED WHERE COMPLIANT WITH LATEST EDITION OF THE NATIONAL ELECTRIC CODE SECTION 334. E.C. SHALL VERIFY WITH LOCAL AHJ'S THAT NONMETALLIC-SHEATHED CABLE SHALL BE ACCEPTABLE FOR USE PRIOR TO CONSTRUCTION.
- CONDUCTORS OPERATING AT 50 VOLTS OR GREATER SHALL BE IN RACEWAY. RACEWAY WITHIN THE STRUCTURE ABOVE THE FLOOR SLAB SHALL BE METAL. RACEWAY BELOW THE FLOOR SLAB AND UNDERGROUND RACEWAY OUTSIDE THE STRUCTURE SHALL BE PVC. LOW VOLTAGE CABLES OR CONDUCTORS OPERATING AT LESS THAN 50 VOLTS SHALL BE IN METAL RACEWAY WHERE INSTALLED WITHIN WALLS OR INACCESSIBLE SPACES. LOW VOLTAGE CABLES MAY BE RUN IN CABLE TRAY WHERE NOTED. LOW VOLTAGE CABLES MAY BE RUN IN CABLE SUPPORT HOOKS ABOVE ACCESSIBLE CEILINGS WHERE NOTED. LOW VOLTAGE CABLE SHALL BE PLENUM RATED IN PLENUM SPACES.
- PROVIDE ONE-INCH EMPTY CONDUITS EXTENDING ABOVE CEILING FOR ALL TELEPHONE AND DATA OUTLETS SHOWN ON PLANS. PROVIDE PROTECTIVE BUSHINGS ON ENDS OF CONDUIT. ALL CABLING IS PROVIDED BY OTHERS.
- PROVIDE 3/4-INCH EMPTY CONDUITS TERMINATING ABOVE THE CEILING FOR ALL HVAC THERMOSTATS. JUNCTION BOXES SHALL MATCH ORIENTATION OF THERMOSTATS PROVIDED BY M.C.. MOUNT JUNCTION BOXES 48-INCHES A.F.F. UNLESS NOTED OTHERWISE. PROVIDE PROTECTIVE BUSHINGS ON ENDS OF CONDUIT. ALSO, PROVIDE DOUBLE GANG BOX AT 84" AFI OVER THERMOSTATS OR WHERE SHOWN ON PLANS FOR REMOTE ALARM/TEST STATIONS OF HVAC DUCT SMOKE DETECTORS (NOT REQUIRED IF CENTRAL FIRE ALARM SYSTEM EXISTS).
- PANELBOARDS FOR SERVICE ENTRANCE SHALL BE SERVICE ENTRANCE RATED. PROVIDE NEMA 3R PANELBOARDS WHERE LOCATED OUTSIDE. PROVIDE NEUTRAL AND GROUNDING BARS IN ALL PANELBOARDS UNLESS NOTED OTHERWISE. GROUND ALL SERVICE ENTRANCE PANELS IN ACCORDANCE WITH THE NEC.
- PROVIDE TYPEWRITTEN PANEL SCHEDULES IN EACH PANEL INDICATING THE LOAD DESCRIPTION FOR EACH BREAKER. LABEL PANELS ON PANEL FACE WITH PHENOLIC LABELS INDICATING PANEL NUMBER OR LETTER DESIGNATION, VOLTAGE AND PHASE.
- PROVIDE FUSED AND NON-FUSED DISCONNECT SWITCHES AS INDICATED ON PLANS. DISCONNECTS LOCATED OUTSIDE SHALL BE NEMA-3R. PROVIDE REJECTION CLIPS IN FUSED
- PROVIDE HORSEPOWER RATED STARTERS AND DISCONNECTS WHEN CONNECTED TO MOTORS. STARTERS SHALL BE PROVIDED WITH OVERLOAD SIZED-TO-MATCH MOTOR
- PROVIDE LIGHTING AS SCHEDULED IN THE FIXTURE SCHEDULE OR OTHERWISE NOTED ON PLANS. LIGHTING INSTALLED IN SUSPENDED CEILINGS SHALL BE SUPPORTED INDEPENDENTLY OF THE CEILING GRID SYSTEM.
- PROVIDE EMERGENCY AND EXIT LIGHTS AS SHOWN ON PLANS. POWER SHALL BE PROVIDED FROM LIGHTING CIRCUITS ON THE UNSWITCHED LEG OF THE CIRCUIT SUCH THAT POWER TO THE EMERGENCY AND EXIT LIGHTS IS NOT DISCONNECTED WHEN NORMAL LIGHTING IS OFF. EXTERIOR EMERGENCY LIGHTS SHALL BE WIRED SUCH THAT PHOTOCELL AND/OR TIME CLOCK OPERATION DOES NOT DISCONNECT POWER TO BATTERIES.
- COORDINATE LOCATIONS OF DEVICES WITH ARCHITECTURAL ELEVATIONS AND DETAILS. ARCHITECTURAL ELEVATIONS AND DETAILS TAKE PRECEDENCE OVER LOCATIONS SHOWN ON ELECTRICAL DRAWINGS.
- RECEPTACLES SHALL BE 20 AMP, 120V UNLESS NOTED OTHERWISE
- RECEPTACLES ABOVE COUNTERTOPS AND ADJACENT TO SINKS & LAVATORIES SHALL BE
- RECEPTACLES INSTALLED OUTSIDE SHALL BE GROUND FAULT WITH "IN USE" WEATHERPROOF
- WALL SWITCHES SHALL BE SINGLE POLE, 20 AMP, 120/277V.
- PROVIDE STANDARD SIZE WALL PLATES FOR ALL DEVICES AND BLANK WALL PLATES FOR JUNCTION BOXES. WALL PLATES SHALL BE HIGH IMPACT, SMOOTH NYLON, COLOR TOMATCH
- UL LISTED DUCT SMOKE DETECTORS SHALL BE FURNISHED, INSTALLED & TESTED BY THE M.C.. THE E.C. SHALL PROVIDE 120V POWER TO EACH DUCT SMOKE DETECTOR WHERE REQUIRED. THE M.C. SHALL PROVIDE REMOTE ALARM/TEST STATIONS FOR EACH DUCT SMOKE
- IT IS THE RESPONSIBILITY OF THIS CONTRACTOR TO COORDINATE INSTALLATION OF ELECTRICAL SYSTEMS AND THOSE REQUIRING ELECTRICAL CONNECTIONS TO MAINTAIN NEC REQUIRED CLEARANCES, INCLUDED BY NOT LIMITED TO AREAS ABOVE ACCESSIBLE CEILINGS.
- . FIELD COORDINATE FINAL MECHANICAL AND EQUIPMENT LOCATIONS ALONG WITH CONNECTION REQUIREMENTS AND CONTROL WIRING PRIOR TO ROUGH-IN. ADJUST CORRESPONDING CIRCUIT BREAKER RATINGS AND BRANCH CIRCUITING ACCORDINGLY.
- B. THE CONTRACTOR IS RESPONSIBLE FOR MAKING FINAL WIRING TERMINATIONS TO PRE-INSTALLED RECEPTACLES IN OFFICE FURNITURE. CONTRACTOR IS RESPONSIBLE FOR WIRING AND INSTALLING VOICE/DATA DEVICES IN OFFICE FURNITURE. COORDINATE PLACEMENT OF DEVICES WITH FURNITURE LAY-OUT.
- . SECURITY SYSTEM TO BE PROVIDED UNDER SEPARATE CONTRACT. IT IS THE RESPONSIBILITY OF THIS CONTRACTOR TO PROVIDE CONDUIT PROVISIONS, BACK BOXES, ROUGH-INS, SLEEVES AND POWER TO HEAD END EQUIPMENT FOR EXACT REQUIREMENTS PRIOR TO START OF WORK.
- DD. TV OUTLETS, VOLUME CONTROLS, NURSE CALL DOME LIGHTS, NURSE CALL DEVICES, TELEPHONE OUTLETS, DATA OUTLETS, AND FIRE ALARM DEVICES SHALL CONSIST OF A BACK BOX WTIH CONDUIT STUBBED ABOVE THE ACCESSIBLE CEILING, SEE STUB UP DETAIL.VERIFY SIZE OF BACK BOX REQUIRED WITH DEVICE TO BE INSTALLED. LOCATE BACK BOXES 6" FROM ADJACENT POWER RECEPTACLE INTENDED FOR COMPUTER USE

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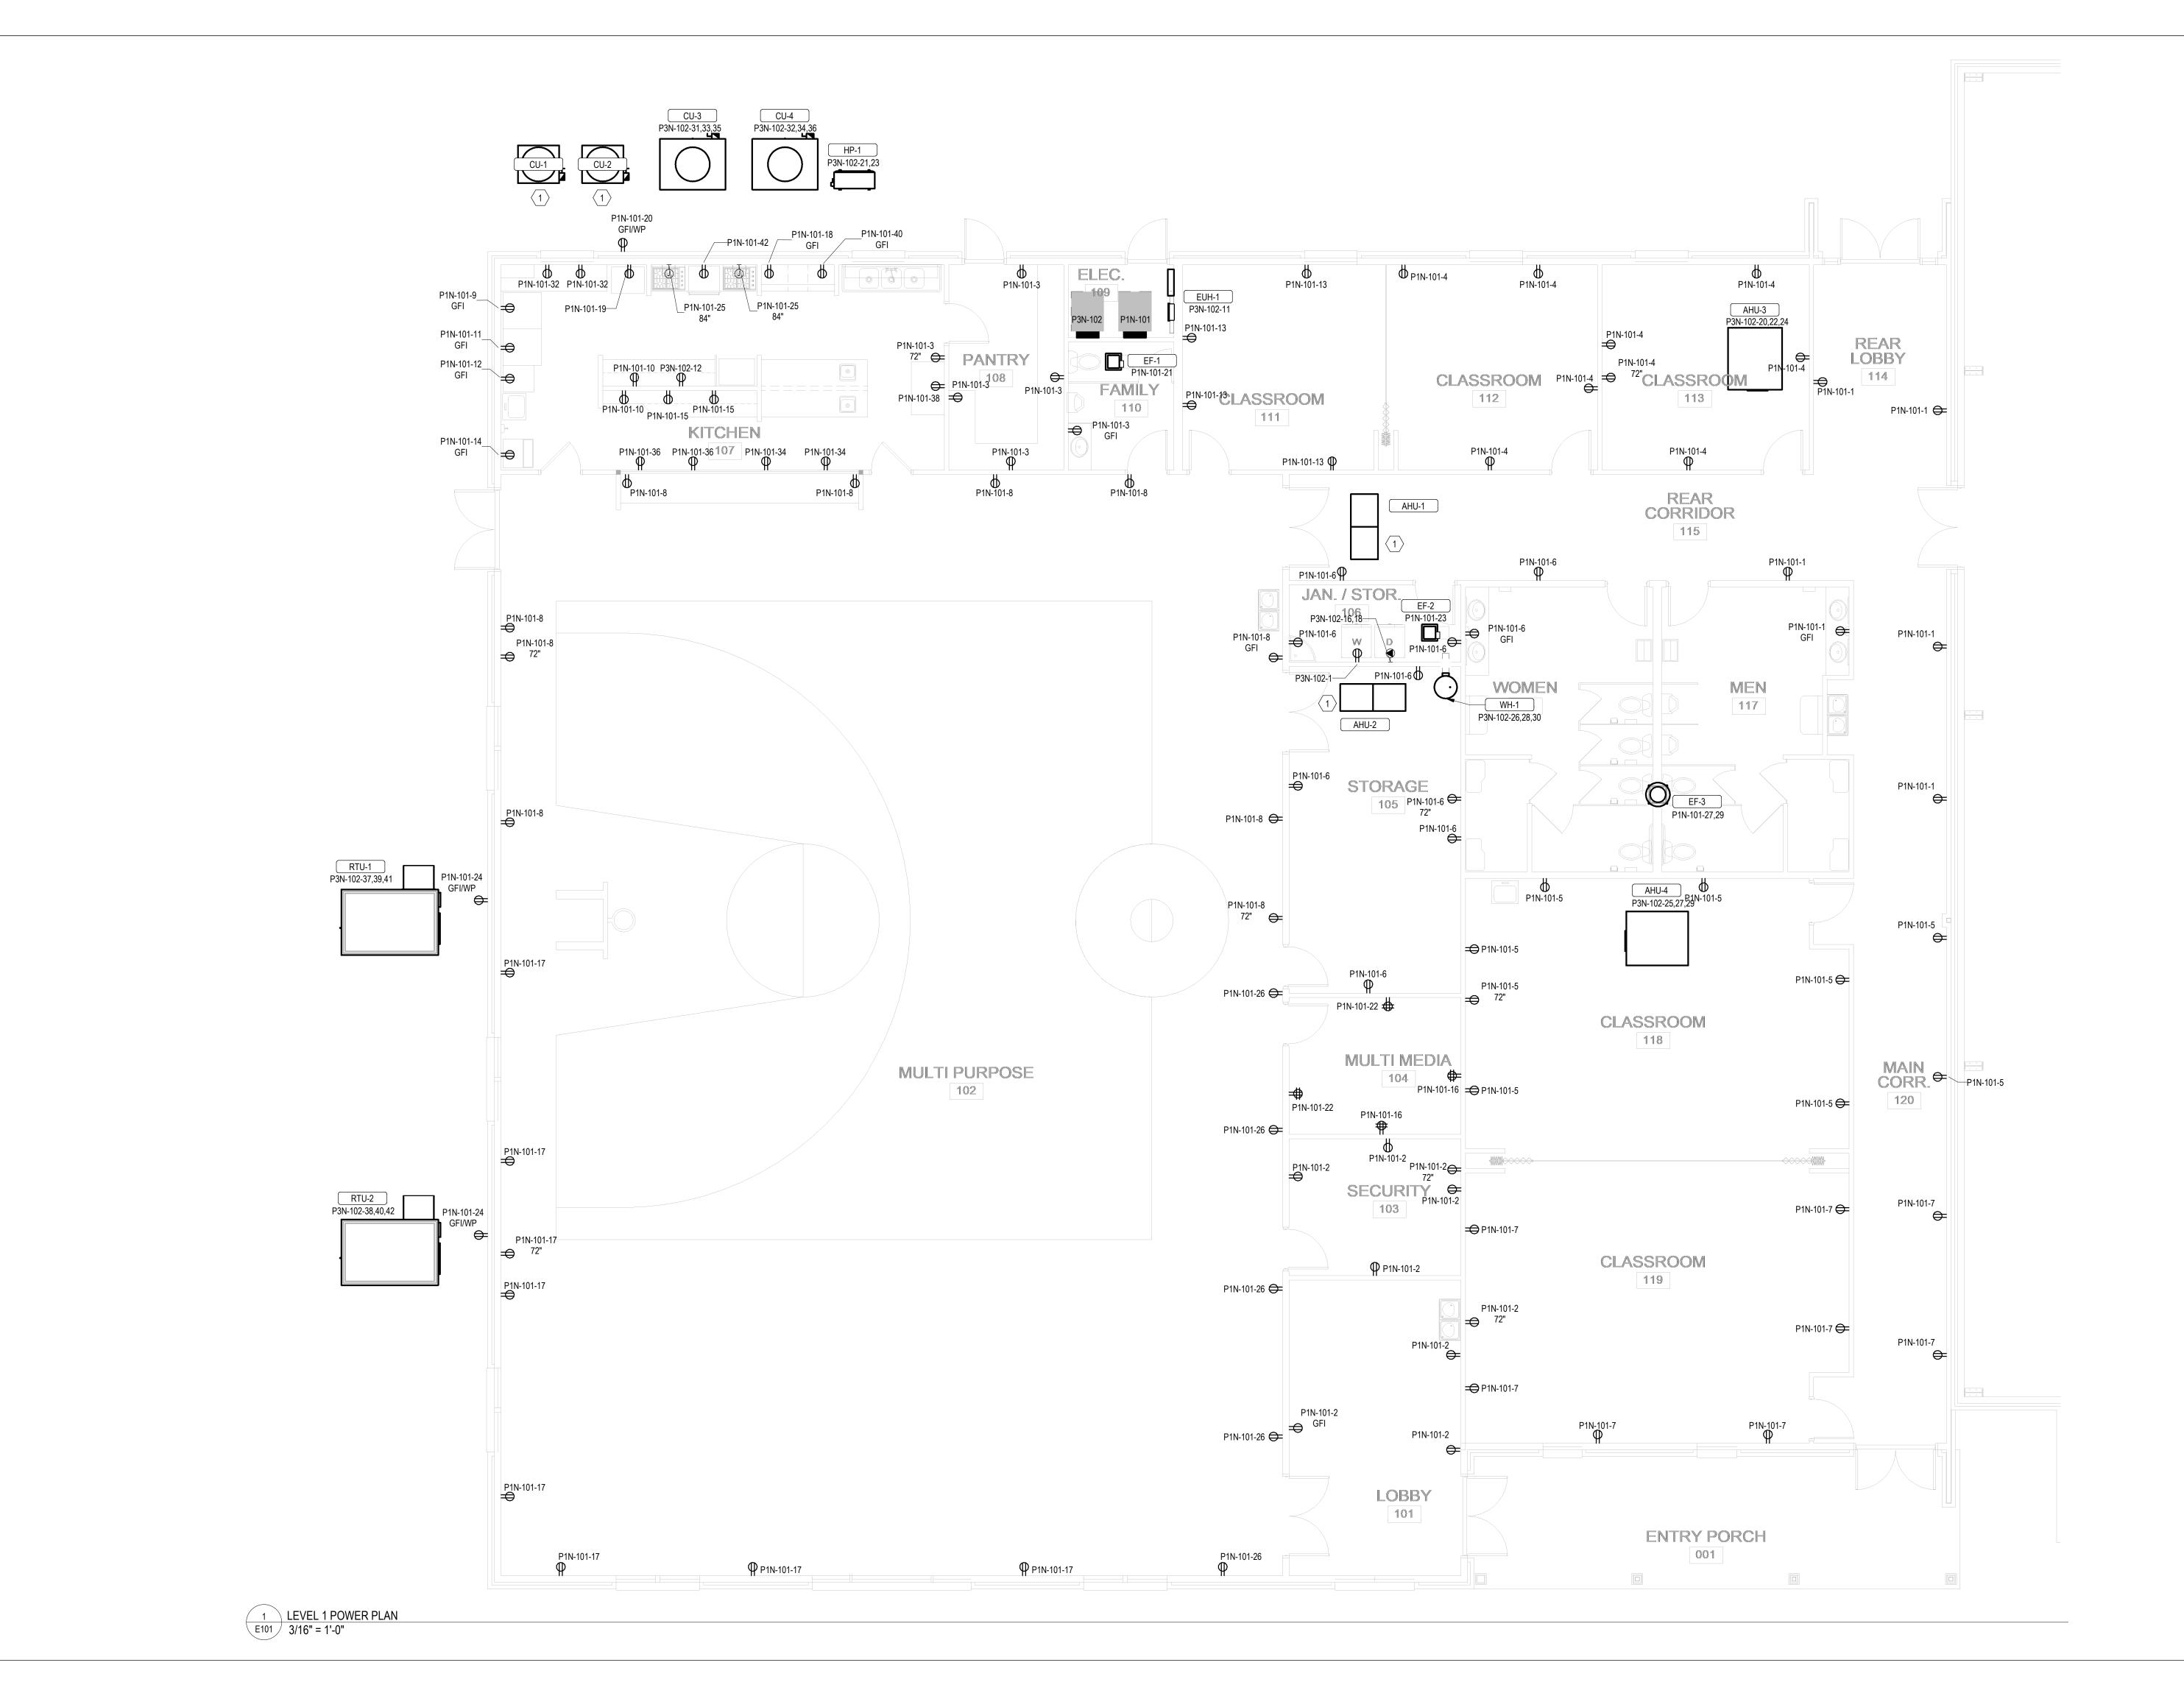
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ELECTRICAL TITLE SHEET



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ELECTRICAL POWER PLAN

E101

KEYNOTES 1 LIGHTING IN MULTIPURPOSE AREA TO BE IMPACT RATED P3N-102 - 5 P3N-102 - 5 EW2 EW2 P3N-102 - 5 EW2 P3N-102 - 5 P3N-102 - 5♥ P3N-102 - 5 P3N-102 - 5 P3N-102 - 5 L1-S8A P3N-102 - 5 P3N-102 - 5 P3N-102 - 5 L1-S7A P3N-102 - 5 L1-S7A P3N-102 - 5 L1-S8A P3N-102 - 5 L1-S6A EW3 L1-S2A L1-S2A L1-S2A L1-S2A ↔ S3B P3N-102 - 5 L1-S4 P3N-102 - 5 P3N-102 - 5 L1-S9 P3N-102 - 5 EW1 P3N-102 - 5 EW1 P3N-102 - 5 EW1 P3N-102 - 5 L1-S3A L1-S5 P3N-102 - 5 L1-S2B P3N-102 - 5 L1-S2B P3N-102 - 5 L1-S2B _P3N-102 - 5 L1-S3B P3N-102 - 5 P3N-102 - 5 P3N-102 - 5 L1-S2B P3N-102 - 5 L1-S6A L1-S7A L1-S7A L1-S9 EW1 • • S2A S2B P3N-102 - 5 S2A S2B D\$S7A EW1**←** S5\$ D\$S8A P3N-102 - 5 EW2 P3N-102 - 5 P3N-102 - 5 L1-S1A L1-S10 L1-S10 L1-S9 P3N-102 - 6 L2-S1A P3N-102 - 6 P3N-102 - 6 P3N-102 - 6 EW3 L2-S1A L2-S1A L2-S1A <u></u> S1C P3N-102 - 5 EW1 S1A — P3N-102 - 5 EW1 p\$p\$p\$p\$ ^D\$ S10 P1N-101 - 41 L3-S20A P1N-101 - 41 P3N-102 - 17 P3N-102 - 17 S13A \$D ⇔ S20A S12A \$_D (C) L3-S20B S11A ↔ S20B P3N-102 - 17 L1-S14A P3N-102 - 6 P3N-102 - 6 EW1 P3N-102 -L1-S12A L1-S13A P3N-102 - 6 L2-S1A P3N-102 - 6 L2-S1A P3N-102 - 6 L2-S1A P3N-102 - 6 L2-S1A P3N-102 - 17 P3N-102 - 17 L1-S12A P3N-102 - 17 L1-S13A L1-S11A P1N-101 - 41 P1N-101 - 41 (C) L3-S20B L3-S20A P3N-102 - 17 P3N-102 - 17 L1-S12A P3N-102 - 17 L1-S11A L1-S13A P3N-102 - 17 L1-S15A P3N-102 - 17 S15A P11-S15A P3N-102 - 17 EW1 P3N-102 - 6 L2-S1B P3N-102 - 6 L2-S1B P3N-102 - 6 L2-S1B L2-S1B P1N-101 - 41 P1N-101 - 41 EW1 (C) L3-S20B L3-S20A P3N-102 - 17 L1-S12A P3N-102 - 17 L1-S13A P3N-102 - 17 P3N-102 - 17 P3N-102 - 17 L1-S11A L1-S15A L1-S15A P3N-102 - 6 P3N-102 - 6 P3N-102 - 17 P3N-102 - 17 L1-S16A L1-S16A P1N-101 - 41 P1N-101 - 41 🗸 (C) L3-S20B L3-S20A P3N-102 - 17 P3N-102 - 17 P3N-102 - 17 P3N-102 - 6 P3N-102 - 6 P3N-102 - 6 P3N-102 - 6 L1-S19B L1-S19B L1-S19B L2-S1B L2-S1B L2-S1B L2-S1B S16A P3N-102 - 17 P3N-102 - 17 P3N-102 - 17 L1-S11A EW1 EW1 P3N-102 - 17 EW1 P1N-101 - 41 P1N-101 - 41 (C) L3-S20B L3-S20A P3N-102 - 17 L1-S17A L1-S19B L1-S19B L1-S19B P3N-102 - 6 P3N-102 - 6 P3N-102 - 6 P3N-102 - 6 L2-S1C L2-S1C L2-S1C L2-S1C P3N-102 - 17 L1-S11A P1N-101 - 41 P1N-101 - 41 L1-S17A (C) L3-S20B L3-S20A P3N-102 - 17 EW1 P3N-102 - 17 P3N-102 - 17 P3N-102 - 6 P3N-102 - 6 EW1 L1-S17A EW1 EW1 P3N-102 - 6 L2-S1C P3N-102 - 6 P3N-102 - 6 L2-S1C L2-S1C L2-S1C P3N-102 - 17 P3N-102 - 17 P3N-102 - 17 P1N-101 - 41 L1-S19B L1-S19B L1-S19B P1N-101 - 41 P3N-102 - 17 (C) L3-S20B L3-S20A L1-S11A P3N-102 - 17 L1-S17A P3N-102 - 17 EW1 P1N-101 - 41 P1N-101 - 41 P3N-102 - 17 (C) L3-S20B P3N-102 - 6 L3-S20A P3N-102 - 6 P3N-102 - 6 L1-S18A P3N-102 - 17 L1-S19B P3N-102 - 17 P3N-102 - 17 P3N-102 - 17 L2-S1D L2-S1D L2-S1D S19B⇔ L2-S1D L1-S19B L1-S19B L1-S11A EW1 👇 S11A ∾് L1-S18A P3N-102 - 17 EW3 🔊 P1N-101 - 41 P1N-101 - 41 (L3-S20B) L3-S20A P3N-102 - 17 F L1-S18A P3N-102 - 6 P3N-102 - 6 P3N-102 - 17 P3N-102 - 6 P3N-102 - 6 L2-S1D L2-S1D L2-S1D L2-S1D EW2 EW1 EW1 P3N-102 - 17 P3N-102 - 17 L1-\$18A D \$18A P3N-102 - 17 1 LEVEL 1 LIGHTING PLAN

E201 3/16" = 1'-0"

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Drawing No.
ELECTRICAL LIGHTING PLAN

F20

Branch Panel: P1N-101 Location: Space 226 A.I.C. Rating: 10,000 AMPS SYMMETRICAL Volts: 120/208 Supply From: P3N-102 Mains Type: MAIN CB Phases: 1 Mounting: SURFACE Wires: 3 Mains Rating: 225.0 A Enclosure: NEMA 1 MCB Rating: 225.0 A Trip CKT Trip Poles CKT **Circuit Description Circuit Description** 20.0 A 1 1080 VA 1620 VA 1 RCPT 1 20.0 A RCPT 2 1080 VA 1620 VA 1 20.0 A RCPT 3 RCPT 4 20.0 A 1 1620 VA 1800 VA 1 20.0 A RCPT 20.0 A 1 1440 VA 1800 VA 1 20.0 A RCPT 5 RCPT 7 RCPT 1 20.0 A KITCHEN MISC RCPTS 9 REFRIGERATOR (GFI) 10 500 VA 500 VA 1 20.0 A FREEZER (GFI) 12 14 11 REFRIGERATOR (GFI) 20.0 A 1 20.0 A ICE MAKER (GFI) 13 RCPT 20.0 A 1 720 VA 200 VA 15 KITCHEN MISC RCPTS 360 VA 360 VA 1 20.0 A RCPT 16 1 1440 VA 1500 VA 1 20.0 A RCPT 17 RCPT 18 20.0 A 19 FOOD WARMER 20 20.0 A 21 EF-1 22 20.0 A 24 VA 360 VA 1 20.0 A RCPT 23 EF-2,3,4 24 VA 360 VA 1 20.0 A RCPT 20.0 A 25 RANGE HOODS 26 1 20.0 A RCPT 20.0 A 1 472 VA 900 VA 27 29 EF-3 28 156 VA 20.0 A 156 VA 360 VA 1 20.0 A KITCHEN MISC RCPTS 32 34 33 1 20.0 A KITCHEN MISC RCPTS 360 VA 36 38 35 360 VA 1 20.0 A KITCHEN MISC RCPTS 1 20.0 A KITCHEN MISC RCPTS 180 VA 40 1500 VA 1 20.0 A RCPT Space 228 41 LITES Space 239 42 20.0 A 1 20.0 A RCPT Space 228 Total Load: 14072 VA 11800 VA Total Amps: 132.4 A 113.5 A Legend: **Demand Factor Load Classification** Connected Load **Estimated Demand** Panel Totals 360 VA 100.00% 360 VA LITES Total Conn. Load: 25872 VA 600 VA 125.00% 750 VA RCPT Total Est. Demand: 18566 VA 24912 VA 70.07% 17456 VA Total Conn.: 124.4 A Total Est. Demand: 89.3 A AIC IS ASSUMED, EC TO VERIFY BEFORE PURCHASE AND INSTALL.

	Location: S Supply From: Mounting: S Enclosure: N	URFACE				Volts: Phases: Wires:					Mains Mains F	Rating: 10,000 A Type: MAIN CE Rating: 400.0 A Rating: 400.0 A	AMPS SYMMETRICA 3	L											
lotes:			T	ı				ı																	
СКТ	Circuit Description	Trip	Poles		A		В		C	Poles	Trip	Circu	uit Description	СКТ											
1	WASHER	20.0 A	1	180 VA	14072 VA			•		Poles	шр	Circu	iit Description	2											
3	WASIER	20.0 A	'	100 VA	14072 77	1	11800 VA			2	20.0 A	P1N-101		4											
5	LITES	20.0 A	1				1.555 VA	1103 VA	1156 VA	1	20.0 A	LITES		6											
7		20.071	<u>'</u>					1.00 7/1	1.00 771		_5.071			8											
9														10											
11	C Space 226	20.0 A	1					1500 VA	1500 VA	1	20.0 A	MICROWAVE		12											
13														14											
15							900 VA			2	20.0 A	DRYER		16											
17	LITES	20.0 A	1					1585 VA	900 VA		20.0 A	DRIER		18											
19					555 VA									20											
21	HP-1	20.0 A	2			1950 VA	555 VA			3	20.0 A	AHU-3		22											
23	1115-1	20.0 A						1950 VA	555 VA					24											
25				555 VA	1000 VA									26											
27	AHU-4	20.0 A	3	3			555 VA	1000 VA			3	20.0 A	WH-1		28										
29								555 VA	1000 VA					30											
31															2402 VA 2402 V	2402 VA									32
33	CU-3	30.0 A	3	3	3	3	3			2402 VA	2402 VA			3	60.0 A	CU-4		34							
35								2402 VA	2402 VA					36											
37				10315 VA	10315 VA									38											
39	RTU-1	125.0 A	3			10315 VA	10315 VA			3	125.0 A	RTU-2		40											
41								10315 VA 10315 VA						42											
			al Load:		96 VA		94 VA		88 VA																
		Tota	I Amps:	35	4.1 A	357	.5 A	310	.3 A																
.egenc	J:																								
	Classification			nected Lo	ad	Demand Fa		Estimated				Panel 1	Totals												
IVAC				33891 VA		100.00%		83891																	
OWE	R			1800 VA		100.00%		1800				al Conn. Load:													
ITES				4444 VA		125.00%		5555			Tota	I Est. Demand:													
IEAT				4500 VA		100.00%		4500				Total Conn.:													
RCPT			2	26592 VA		68.80%		18296	o VA		Tota	I Est. Demand:	316.5 A												

						LIGH	HTING I	FIXT	URE SCHED	JLE						
	CONSTRUCTION				LIGH	IT SOURCE					ELE	CTRICAL		PRODUCT		
TYPE	DESCRIPTION	LENS/LOUVER	MOUNTING	LAMP	LUMENS DOWN	LUMENS UP	ССТ	CRI	PROJECTED LIFE	BALLAST/DRIVER	VOLT	WATTS	EMERGENCY COMPONENT	MFR	Model	NOTE
EW1	ELU INDOOR, TWO HEAD		SURFACE WALL	LED	1100 lm	0 lm	6500 K	80			120 V	3 W	BATTERY	LITHONIA	ELM6L UVOLT LTP	EC TO INSTALL EQUAL OR EQUIVALENT.
EW2	ELU SINGLE REMOTE HEAD		SURFACE WALL	LED	220 lm	0 lm	6500 K	80			120 V	11 W	REMOTE BATTERY	LITHONIA	ELMRE LP220L SGL	EC TO INSTALL EQUAL OR EQUIVALENT.
EW3	EXIT SIGN, EDGE-LIT, 1-SIDED		CEILING	LED	0 lm	0 lm	0 K	0			120 V	5 W	BATTERY	LITHONIA	EDGR 1 R EL	EC TO INSTALL EQUAL OR EQUIVALENT.
L1	2X4 RECESSED	CURVED RIBBED	LAY-IN	LED	4000 lm	0 lm	3500 K	82	60,000 HOURS	LED DRIVER, 0-10V DIMMING, 1%	120 V	32 W		LITHONIA	2BLT4 40L ADP EZ1 LP835	EC TO INSTALL EQUAL OR EQUIVALENT.
L2	2X4 SUSPENDED	CURVED RIBBED	CEILING SUSPENDED	LED	4000 lm	0 lm	3500 K	82	60,000 HOURS	LED DRIVER, 0-10V DIMMING, 1%	120 V	32 W		LITHONIA	2BLT4 40L ADP EZ1 LP835	EC TO INSTALL EQUAL OR EQUIVALENT.
L3	14" ROUND RECESSED	FROSTED ACRYLIC	RECESSED	LED	2040 lm	0 lm	3500 K	80	30,000 HOURS	LED DRIVER	120 V	30 W		LITHONIA	FMHLDL 14 208 35K	EC TO INSTALL EQUAL OR EQUIVALENT.

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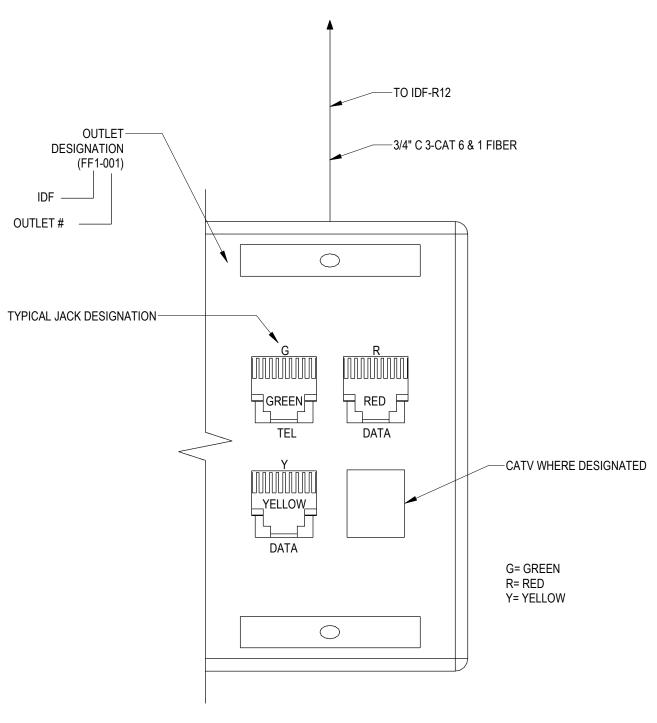
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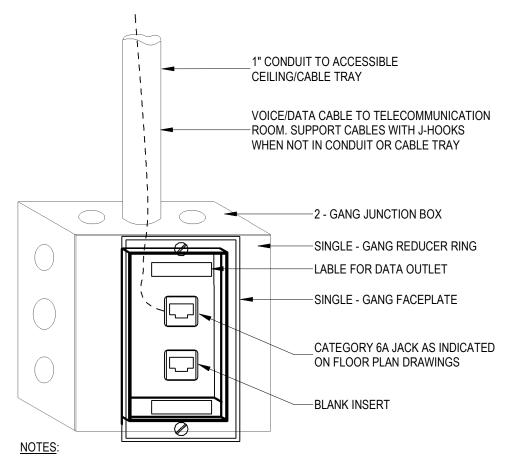
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ELECTRICAL SCHEDULES




1 TYPICAL TELEPHONE/DATA DEVICE DETAIL 4 PORT NOT TO SCALE



- TERMINATE VOICE AND DATA OUTLETS WITH T568B/T568A PIN-OUT SEQUENCE. ROUTE CABLES TO TELECOMMUNICATION ROOMS AND TERMINATE ON
- RACK-MOUNTED CATEGORY 6A PATCH PANELS.
- 3. LABEL VOICE AND DATA JACK WITH THE TELECOMMUNICATION ROOM NUMBER, PATCH PANEL NUMBER AND JACK POSITION NUMBER (EX. 005-A-18)
- 4. INSTALL BLANK INSERT ON OPEN PORTS WHEN JACKS ARE NOT INSTALLED.
- 5. WHEN VOICE/DATA OUTLETS ARE INSTALLED AT MODULAR FURNITURE OR FLOOR BOX LOCATIONS, PROVIDED COMPATIBLE ADAPTER PLATES.

ENGINEER EDIT NOTE: VERIFY CABLE TYPE AND REVISE DETAIL AS REQUIRED.

2 2-PORT SINGLE DROP VOICE/DATA OUTLET DETAIL E401 / NOT TO SCALE

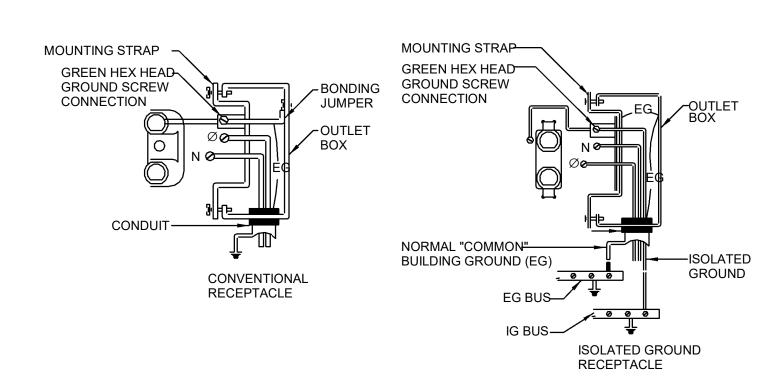

RECEPTACLE WIRING DETAILS E401 NOT TO SCALE

FEEDER	COPPER CC	NDUCTORS		CONDL	JIT SIZE	
TYPE	Ø & N	GND	2Ø+N+GND	3Ø+GND	3Ø+N+GND	3Ø+2N+2
20	#12	#12	16 (1/2")	16 (1/2")	16 (1/2")	21 (3/4
30	#10	#10	16 (1/2")	16 (1/2")	21 (3/4")	21 (3/4
40	#8	#10	21 (3/4")	21 (3/4")	27 (1")	27 (1"
55	#6	#10	27 (1")	27 (1")	27 (1")	27 (1"
70	#4	#8	35 (1 1/4")	35 (1 1/4")	35 (1 1/4")	35 (1 1/-
85	#3	#8	35 (1 1/4")	35 (1 1/4")	35 (1 1/4")	41 (1 1/2
95	#2	#8	35 (1 1/4")	35 (1 1/4")	41 (1 1/2")	41 (1 1/2
110	#1	#6	41 (1 1/2")	41 (1 1/2")	41 (1 1/2")	53 (2"
150	#1/0	#6	41 (1 1/2")	41 (1 1/2")	53 (2")	53 (2"
175	#2/0	#6	53 (2")	53 (2")	53 (2")	63 (2 1/2
200	#3/0	#6	53 (2")	53 (2")	53 (2")	63 (2 1/2
230	#4/0	#4	53 (2")	53 (2")	63 (2 1/2")	63 (2 1/2
255	250 kCM	#4	63 (2 1/2")	63 (2 1/2")	63 (2 1/2")	78 (3"
285	300 kCM	#4	63 (2 1/2")	78 (3")	78 (3")	78 (3"
310	350 kCM	#3	78 (3")	78 (3")	78 (3")	91 (3 1/2
335	400 kCM	#3	78 (3")	78 (3")	78 (3")	91 (3 1/2
380	500 kCM	#3	78 (3")	78 (3")	91 (3 1/2")	103 (4'
510	(2) 250 kCM	(2) #1	(2) 63 (2 1/2")	(2) 63 (2 1/2")	(2) 78 (3")	(2) 78 (3
570	(2) 300 kCM	(2) #1	(2) 63 (2 1/2")	(2) 63 (2 1/2")	(2) 78 (3")	(2) 91 (3
620	(2) 350 kCM	(2) #1	(2) 78 (3")	(2) 78 (3")	(2) 78 (3")	(2) 91 (3
760	(2) 500 kCM	(2) #1/0	(2) 78 (3")	(2) 78 (3")	(2) 91 (3 1/2")	(2) 103 (
1005	(3) 400 kCM	(3) #2/0	(3) 78 (3")	(3) 78 (3")	(3) 78 (3")	(3) 91 (3
1240	(4) 350 kCM	(4) #3/0	(4) 78 (3")	(4) 78 (3")	(4) 78 (3")	(4) 91 (3
1260	(3) 600 kCM	(3) #3/0	(3) 91 (3 1/2")	(3) 91 (3 1/2")	(3) 103 (4")	(3) 129 (
1675	(5) 400 kCM	(5) #4/0	(5) 78 (3")	(5) 78 (3")	(5) 91 (3 1/2")	(5) 103 (
1680	(4) 600 kCM	(4) #4/0	(4) 91 (3 1/2")	(4) 91 (3 1/2")	(4) 103 (4")	(4) 129 (
2010	(6) 400 kCM	(6) 250 kCM	(6) 78 (3")	(6) 78 (3")	(6) 91 (3 1/2")	(6) 103 (
2100	(5) 600 kCM	(5) 250 kCM	(5) 91 (3 1/2")	(5) 91 (3 1/2")	(5) 103 (4")	(5) 129 (
2520	(6) 600 kCM	(6) 350 kCM	(6) 91 (3 1/2")	(6) 91 (3 1/2")	(6) 103 (4")	(6) 129 (
2660	(7) 500 kCM	(7) 350 kCM	(7) 91 (3 1/2")	(7) 91 (3 1/2")	(7) 91 (3 1/2")	(7) 129 (
3040	(8) 500 kCM	(8) 400 kCM	(8) 91 (3 1/2")	(8) 91 (3 1/2")	(8) 91 (3 1/2")	(8) 129 (
4275	(8) 750 kCM	(8) 500 kCM	(8) 103 (4")	(8) 103 (4")	(8) 129 (5")	(8) 129 (
EQ	EQUIPMENT	FEEDER - REF	FER TO ELECTRICA	L EQUIPMENT SCH	HEDULE	•
200 - 4 - 1	G <u>FEED</u> ER DE	SIGNATION				

(1G) - EQUIPMENT GND OR ISOLATED GND (2G) - EQUIPMENT GND AND ISOLATED GND -SYSTEM DESCRIPTION:


(3) - 1Ø, 3W OR 3Ø, 3W (4) - 3Ø, 4W (5) - 3Ø, 5W (2 NEUTRALS) -CONDUCTOR AMPACITY:


(SEE FEEDER SCHEDULE)

GENERAL NOTES:

- A. THE ABOVE FEEDER SCHEDULE IS A SCHEDULE OF TYPICAL FEEDERS AND SOME SIZES MAY NOT BE
- B. ALL CONDUCTOR AMPACITIES ARE BASED ON TABLE 310-15(b)(16) OF THE NEC FOR COPPER CONDUCTOR TYPE THW/THWN.
- C. FEEDER SIZES SHOWN ON THE RISER DIAGRAM INDICATE FEEDER AMPACITIES AND DO NOT NECESSARILY CORRESPOND TO CIRCUIT BREAKER AMPACITIES. CERTAIN FEEDERS MAY BE SIZED
- FOR THE DERATION FACTORS REQUIRED BY CODE AND/OR ARE OVERSIZED FOR VOLTAGE DROP. D. WHERE MULTIPLE CONDUITS AND CONDUCTORS ARE INDICATED FOR A SINGLE FEEDER, EACH
- CONDUIT SHALL CONTAIN 1 PARALLEL PHASE, NEUTRAL, AND GROUND CONDUCTORS INDICATED. E. CONDUIT ABOVE GRADE INDOORS SHALL BE EMT. CONDUIT ABOVE GRADE OUTDOORS SHALL BE
- GALVANIZED IMC OR RMC. CONDUIT BELOW GRADE SHALL BE PVC WITH GALVANIZED RMC ELBOWS. CONDUIT SIZE INDICATED IS MINIMUM SIZE REGARDLESS OF CONDUIT TYPE.
- F. CONDUITS SIZED LARGER THAN INDICATED SHALL BE PERMITTED FOR RUNS WITH UP TO (4) 90° ELBOWS, OR FOR PULLING LONGER RUNS.
- CONDUIT AND WIRE SCHEDULE

E401 NOT TO SCALE

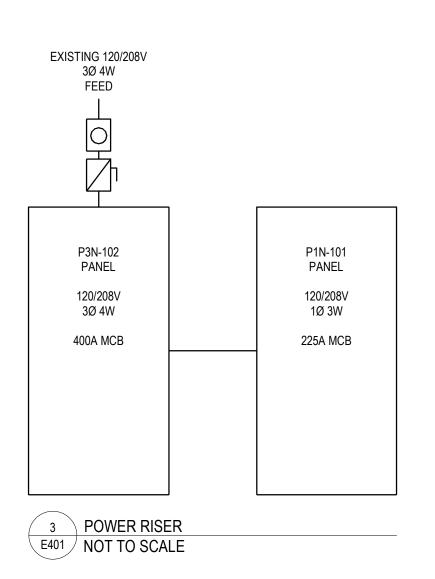

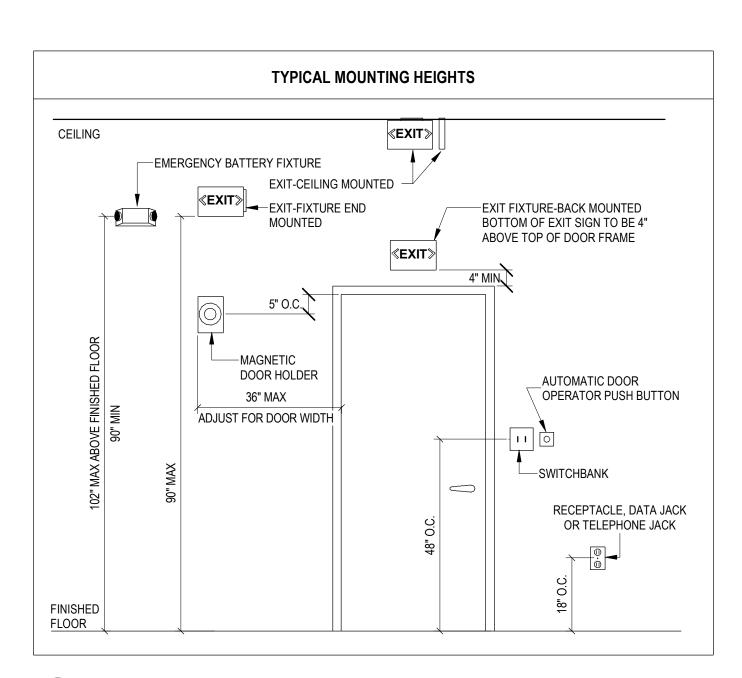

6 TYPICAL MOUNTING HEIGHTS E401 NOT TO SCALE

■ ARCHITECT

RON W. WEBB 1659 W. HANRAHAN ROAD **AYDEN, NC. 28513** TEL: (252) 531-2711

WEBB MT PISGAH

145 PROSPECT CHURCH RD **ERWIN, NC 28339**

PROJECT CONSULTANTS

120 SOMMERVILLE PARK ROAD RALEIGH, NC 27603

NC FIRM # C-3824



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Issue Date: Issue Date


Plot Date: 10/23/2023 4:26:59 PM

Revisions

M	ark	Date	Description

Drawing No.

ELECTRICAL DETAILS

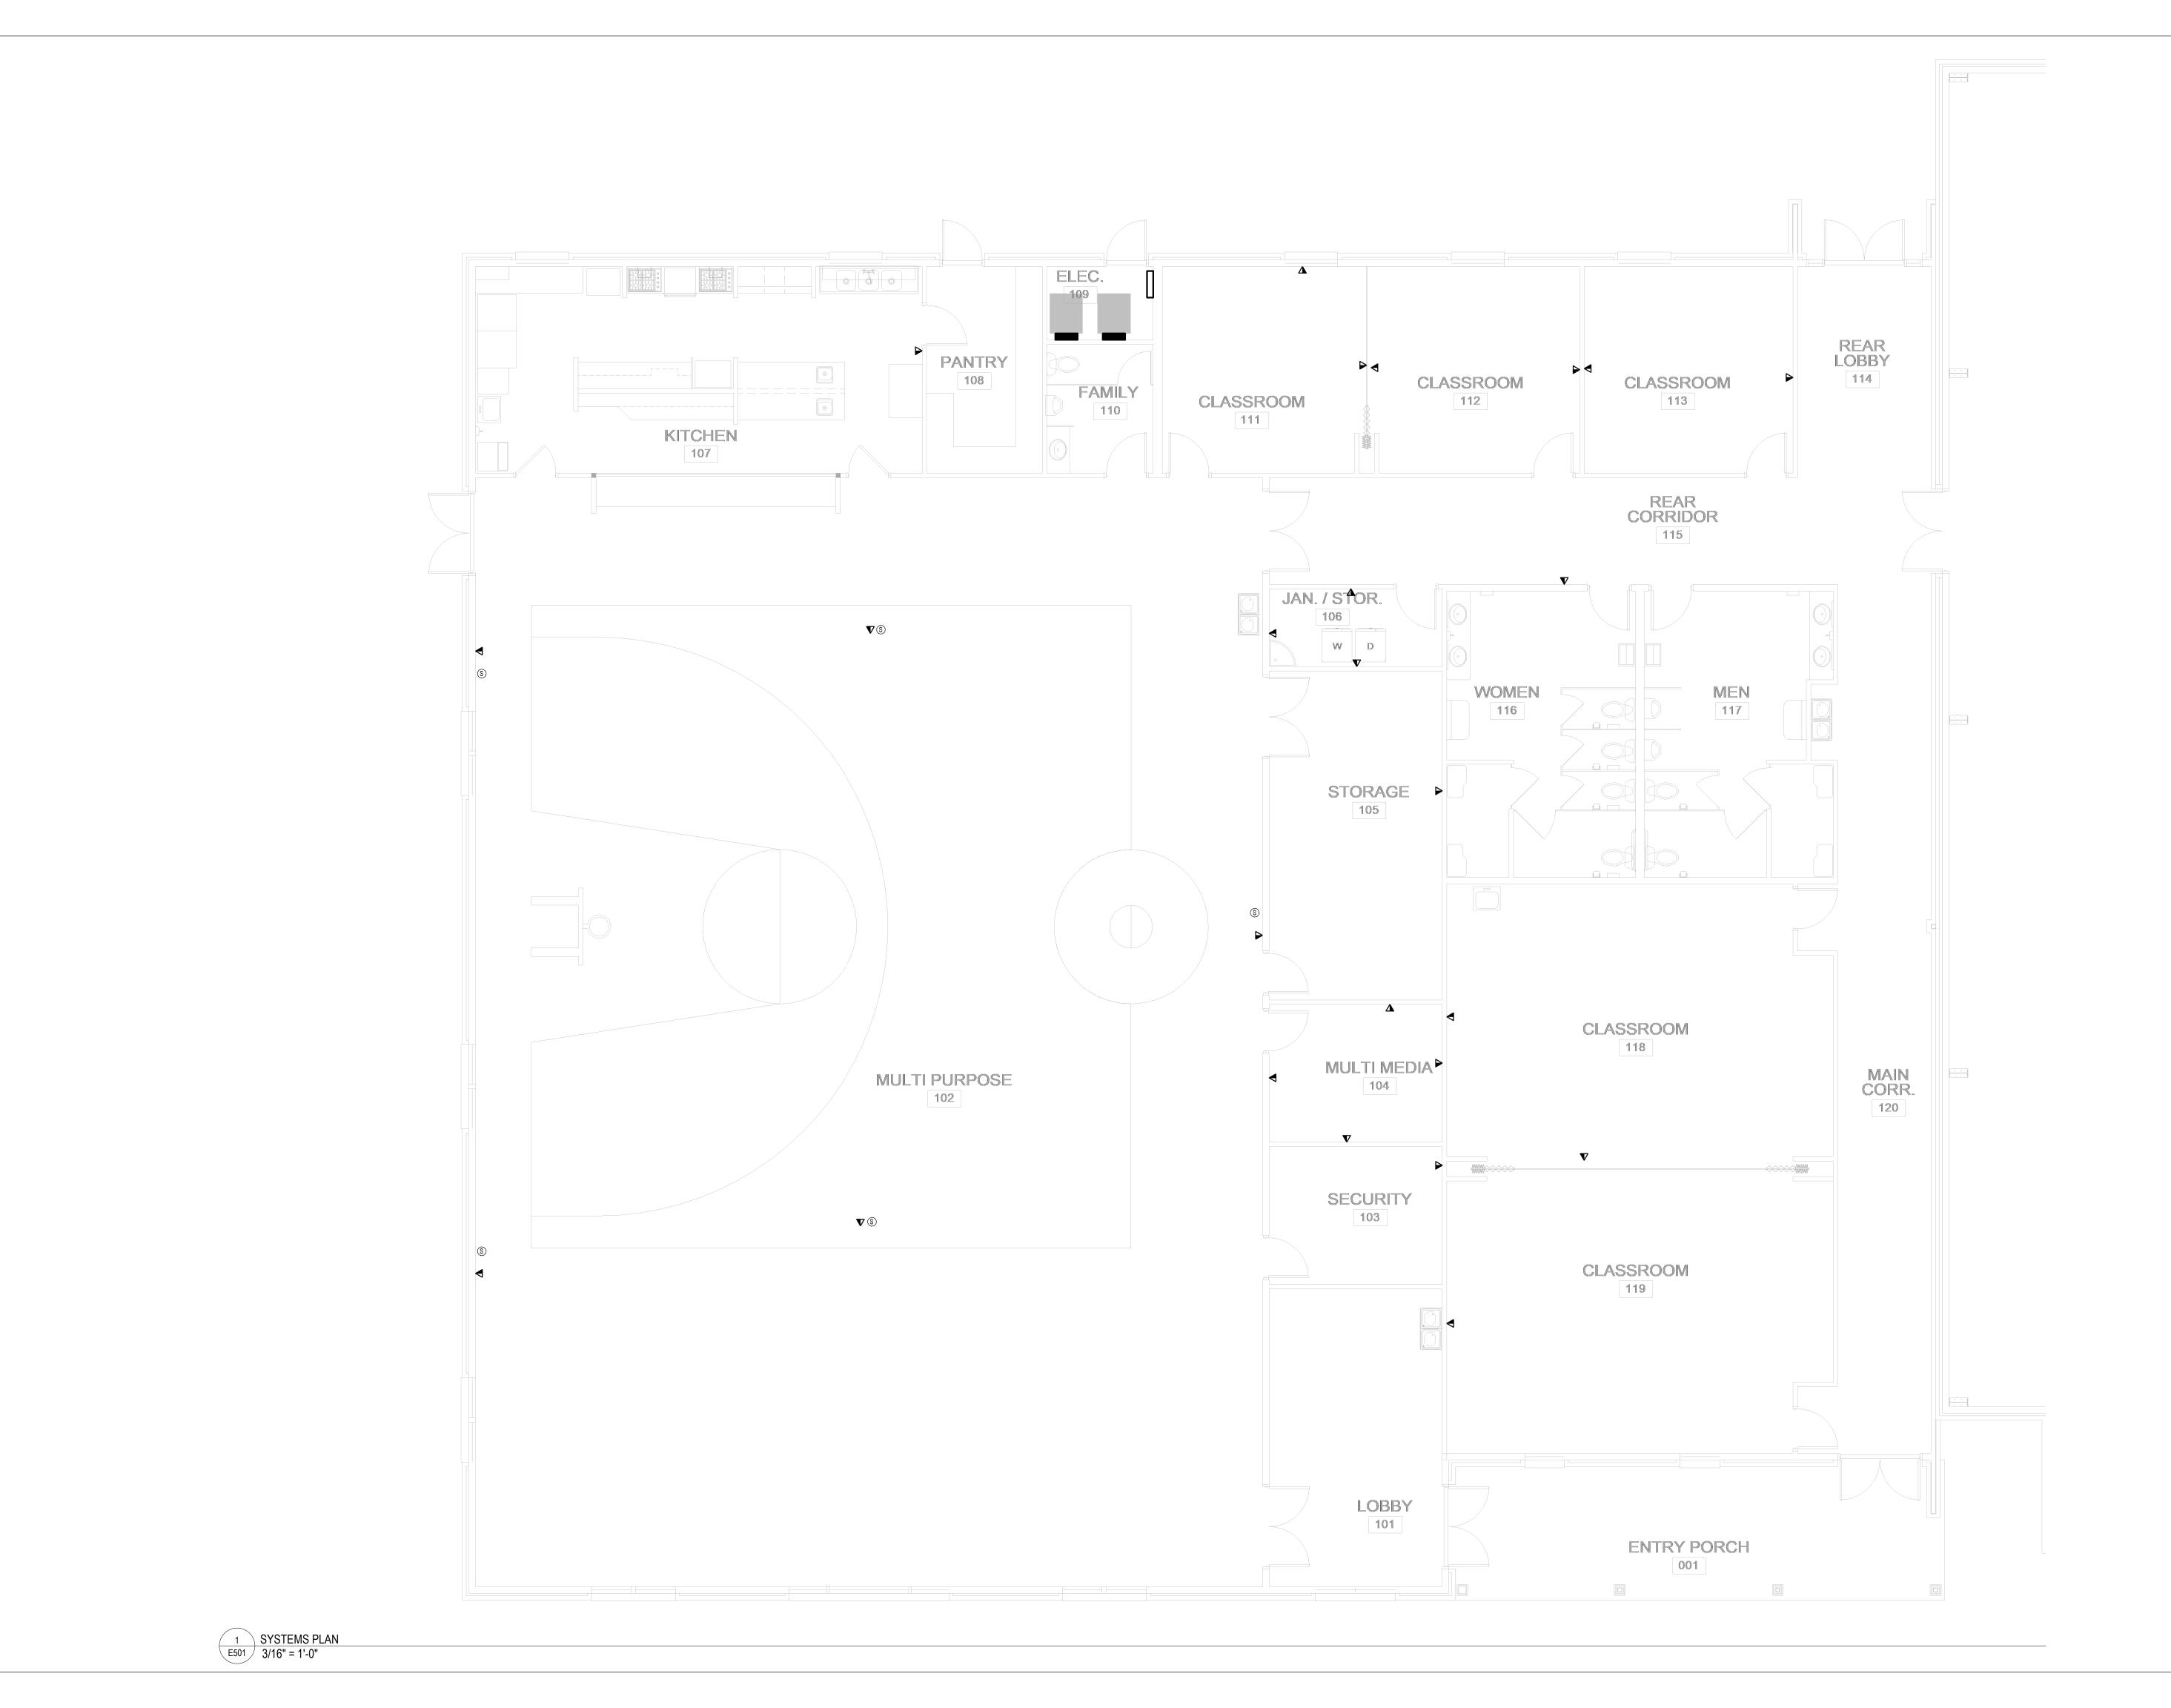

RON W. WEBB 1659 W. HANRAHAN ROAD AYDEN, NC. 28513 TEL: (252) 531-2711

WEBB MT PISGAH

145 PROSPECT CHURCH RD ERWIN, NC 28339

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120 SOMMERVILLE PARK ROAD RALEIGH, NC 27603 NC FIRM# C-3824



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Plot Date: 10/23/2023 4:27:01 PM Revisions

Mark	Date	Description

Drawing N ELECTRICAL SYSTEMS PLAN

F50'



RON W. WEBB 1659 W. HANRAHAN ROAD AYDEN, NC. 28513 TEL: (252) 531-2711

WEBB MT PISGAH

145 PROSPECT CHURCH RD ERWIN, NC 28339

PROJECT CONSULTANTS KAIROS

120 SOMMERVILLE PARK ROAD RALEIGH, NC 27603 NC FIRM# C-3824



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Mark Date Description


Diawii


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FIRE ALARM PLAN


E60'




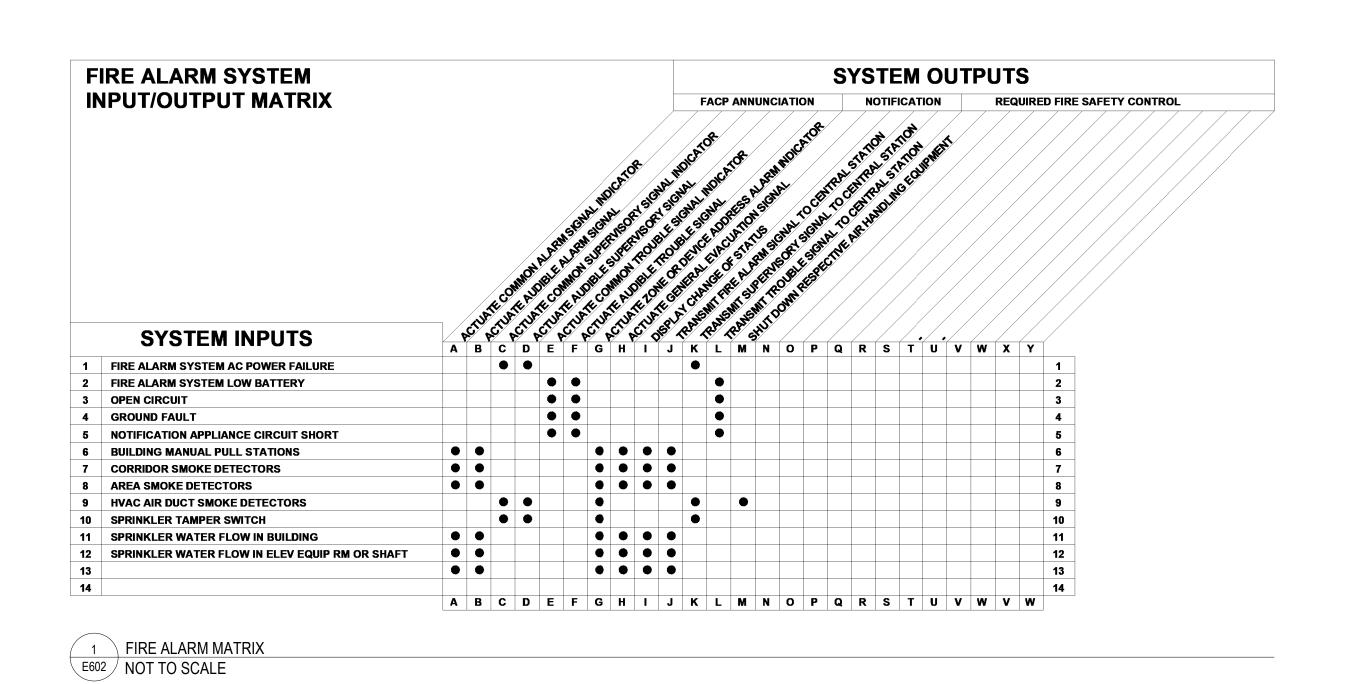

2 TYPICAL MOUNTING HEIGHTS E602 NOT TO SCALE

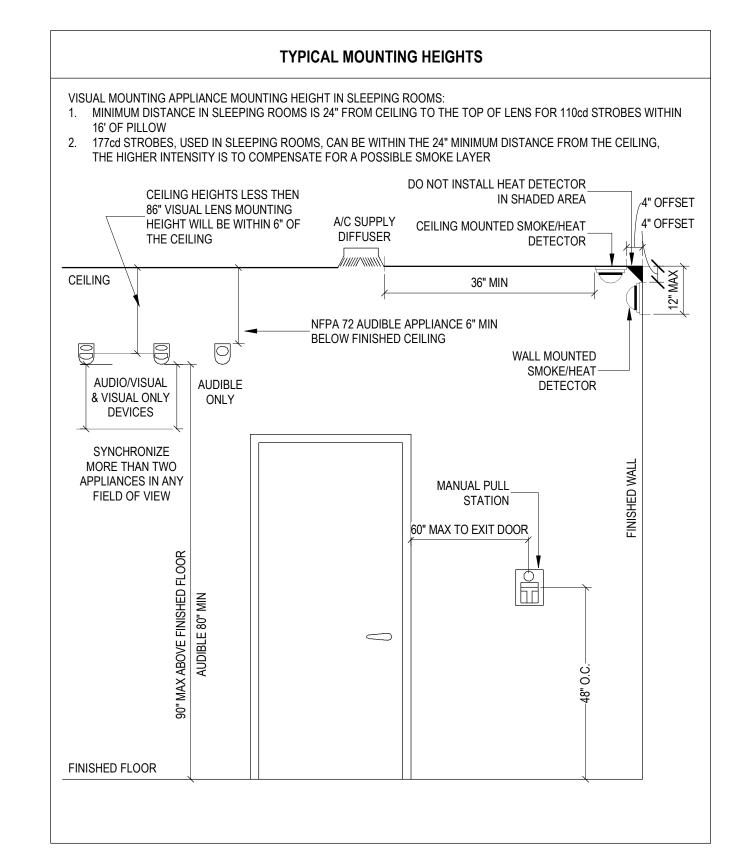SEE FIRE ALARM SHOP DRAWING FOR NUMBER OF LOOPS REQUIRED TO SUPPORT HORN/STROBE CURRENT DRAW.

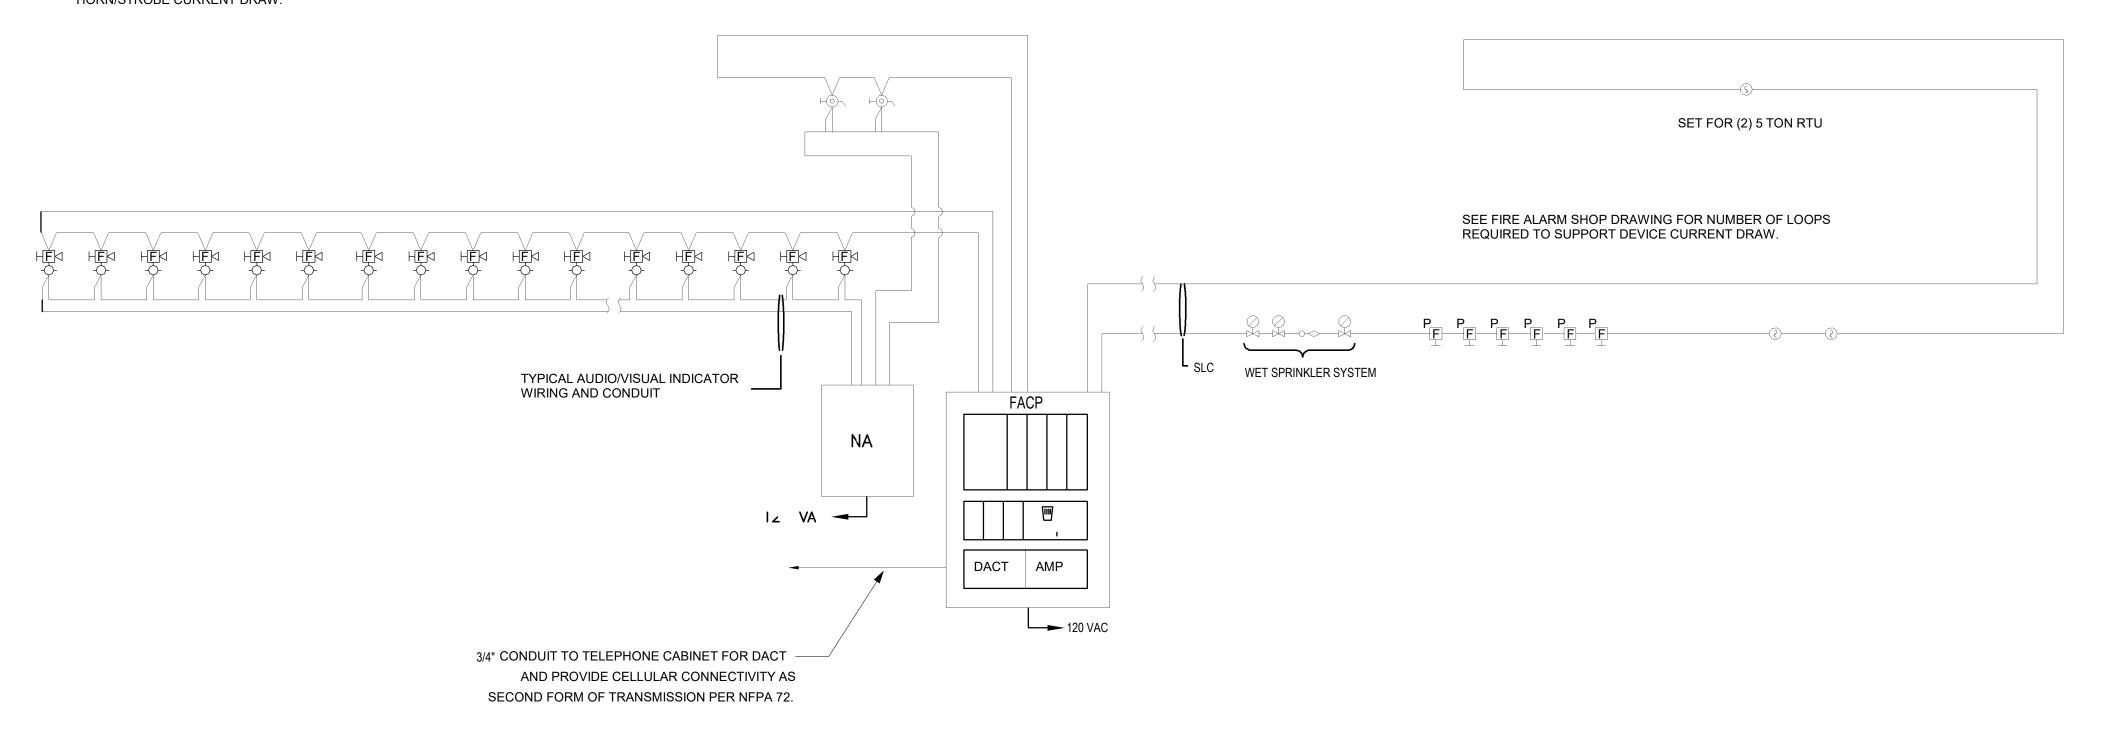

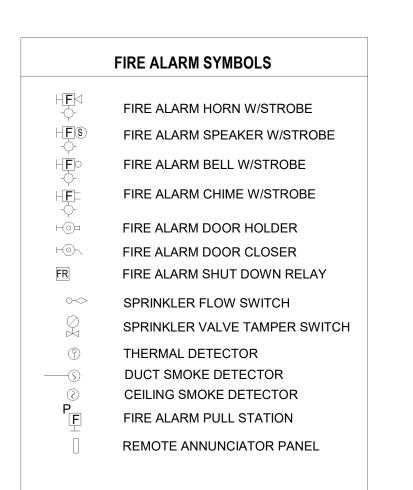

REFER TO FIRE ALARM SHOP DRAWINGS FOR MAKE/MODEL OF DEVICES.

3 FIRE ALARM RISER NOT TO SCALE

■ ARCHITECT

RON W. WEBB 1659 W. HANRAHAN ROAD **AYDEN, NC. 28513** TEL: (252) 531-2711

WEBB MT PISGAH

145 PROSPECT CHURCH RD **ERWIN, NC 28339**



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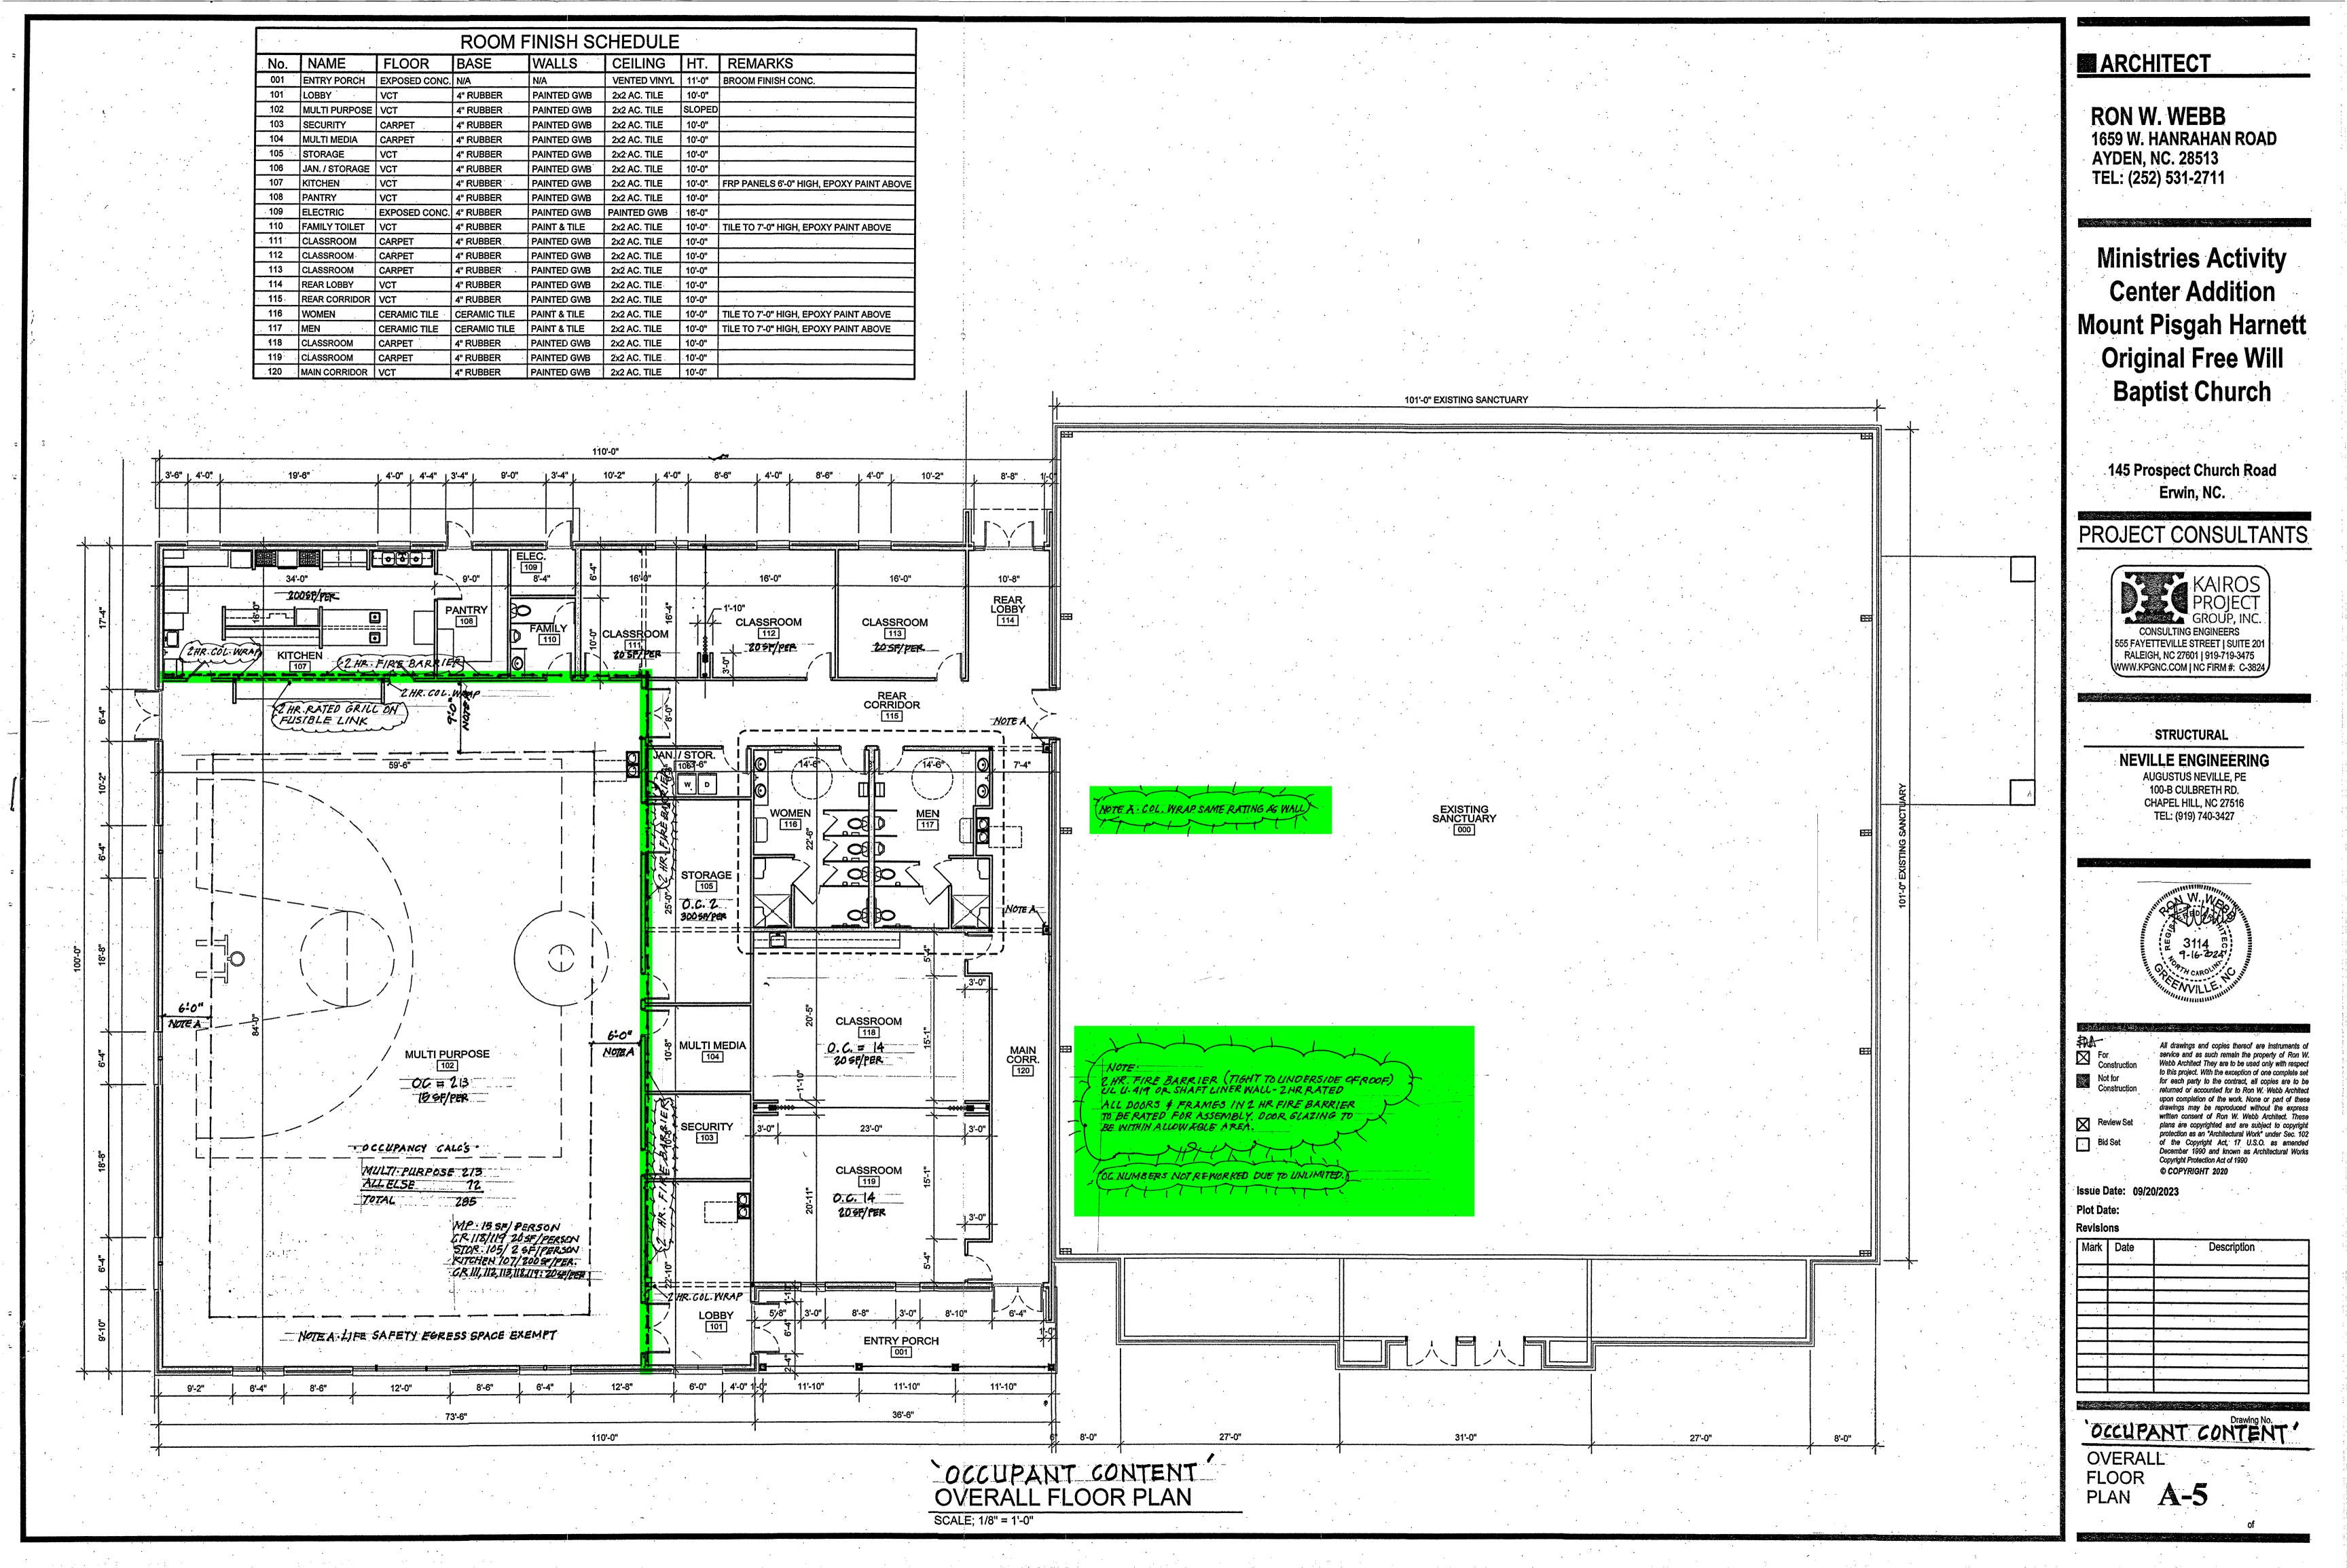
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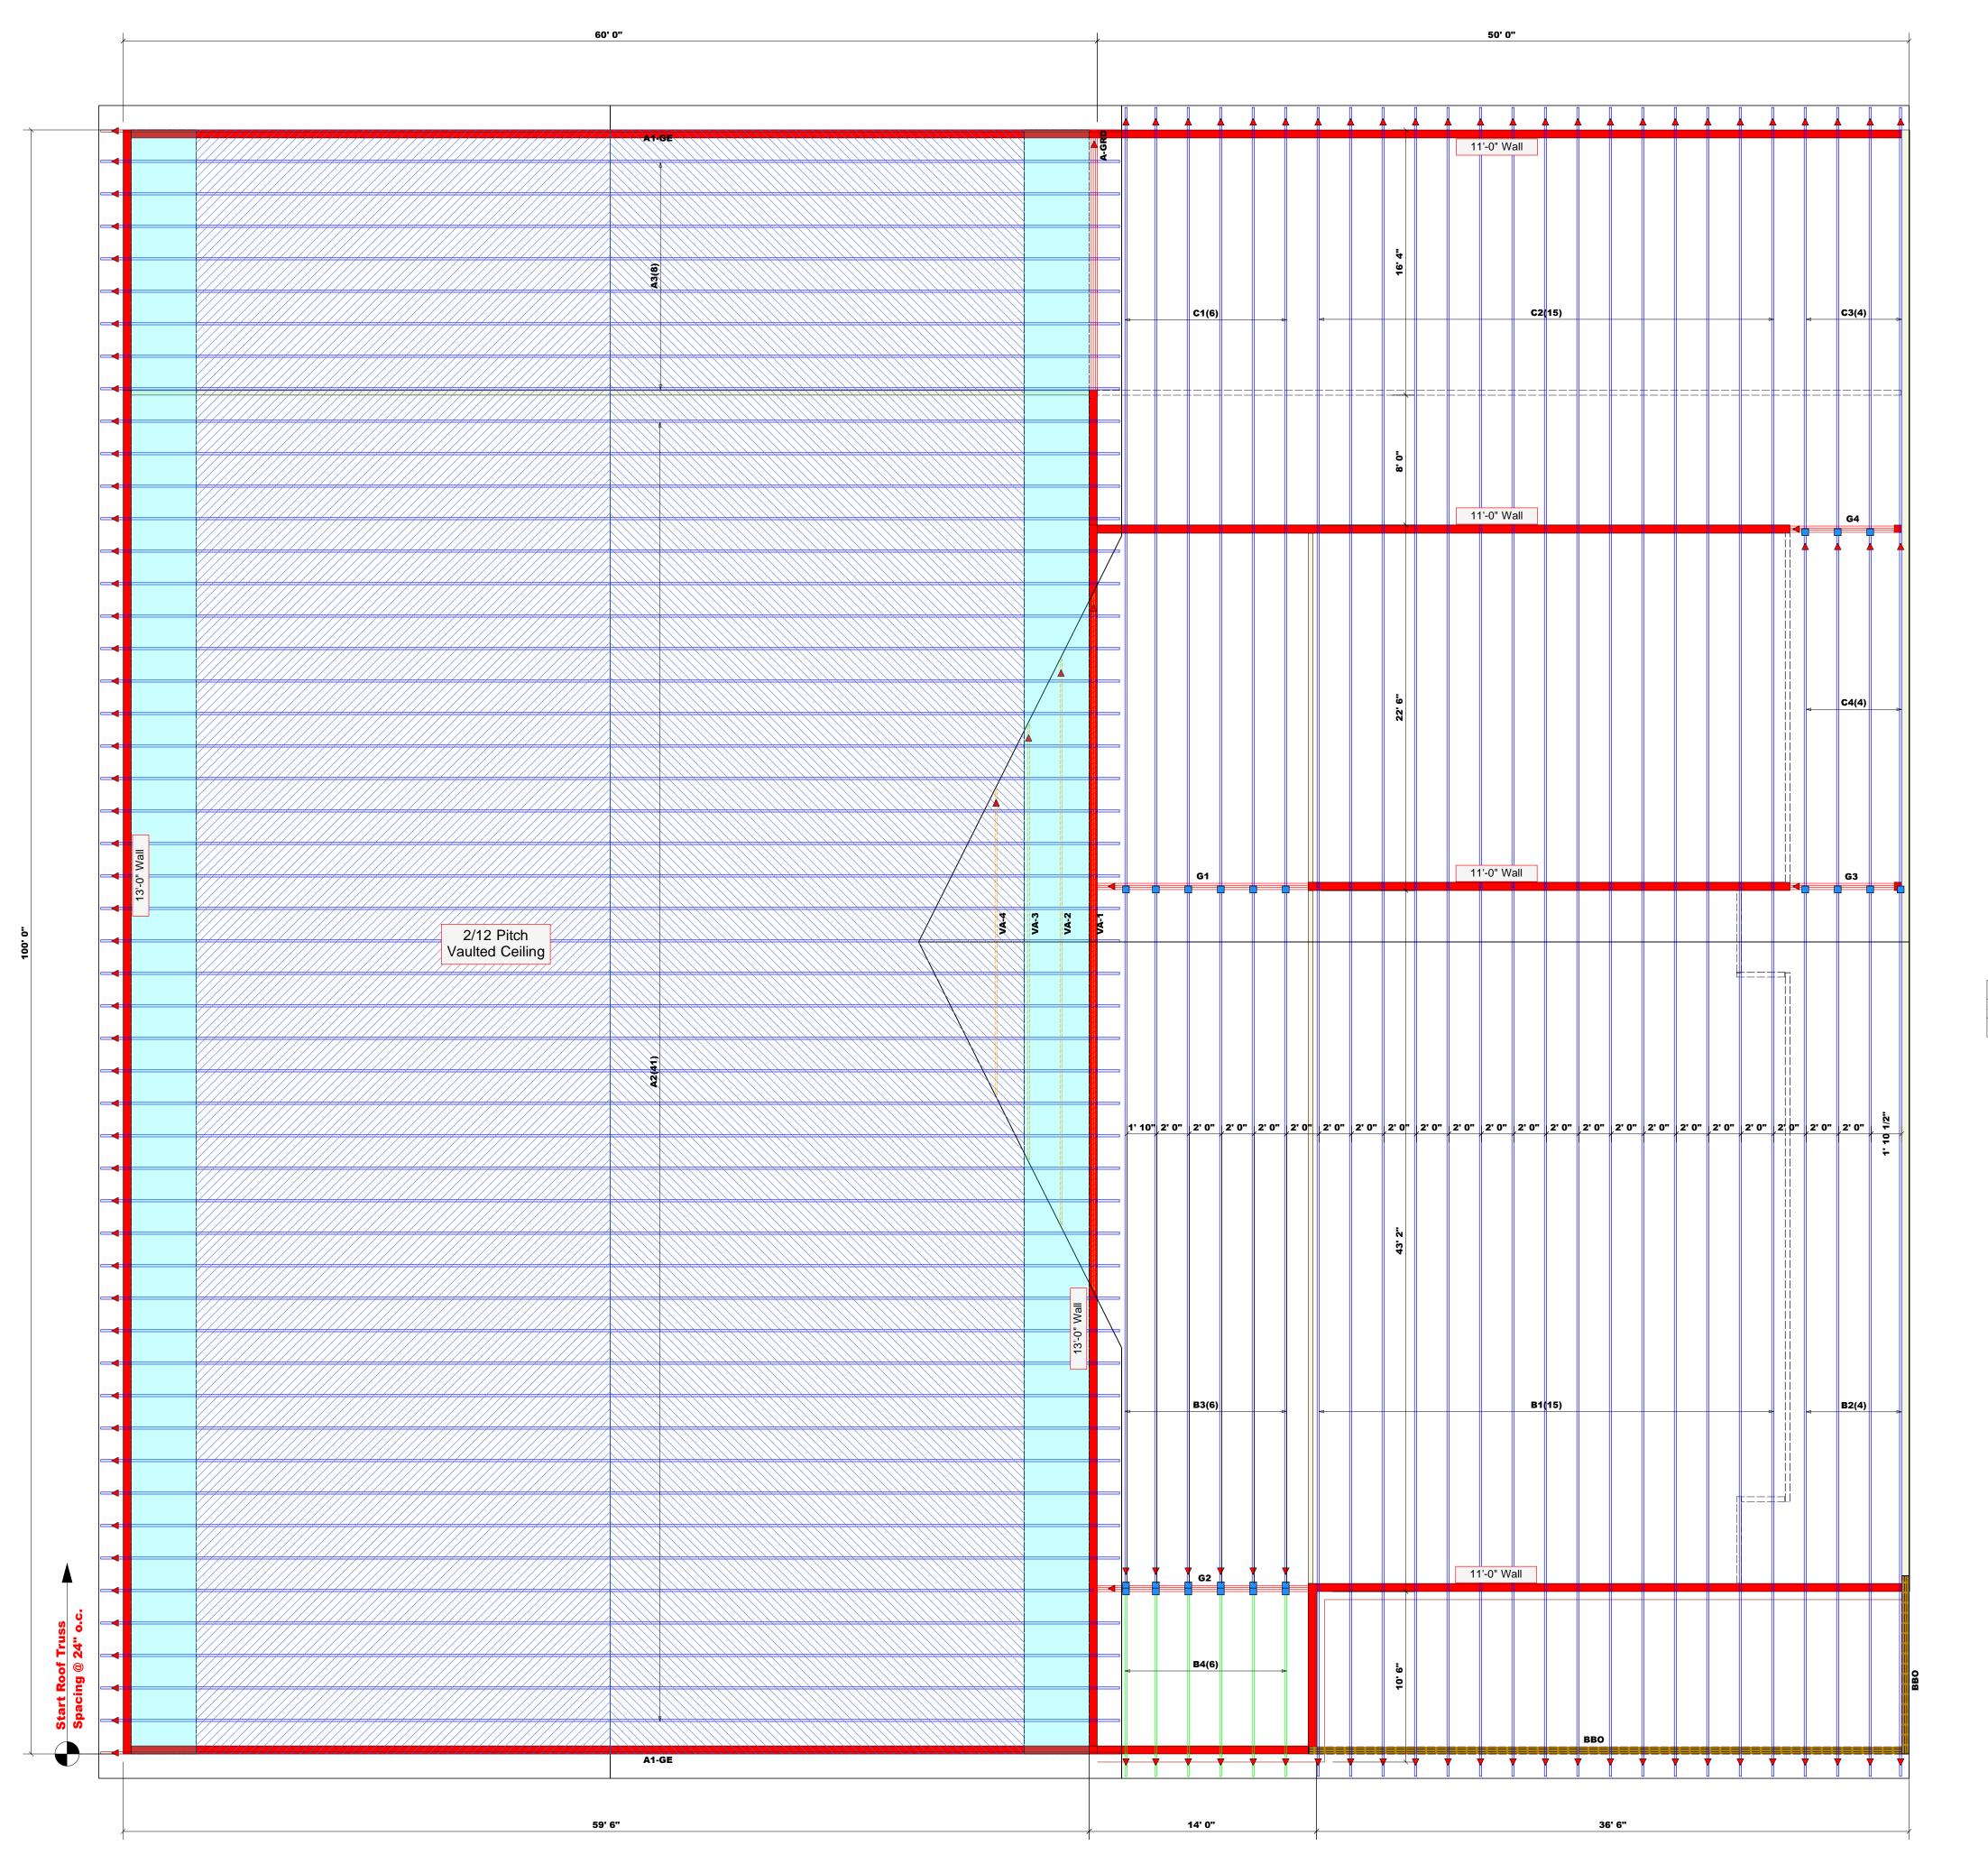
Revisions

Mark	Date	Description

FIRE ALARM DETAILS

Drawing No.







Phone: (910) 864-8787 Fax: (910) 864-4444

THIS IS A TRUSS PLACEMENT DIAGRAM ONLY.
These trusses are designed as individual building components to be incorporated into the building design at the specification of the building designer. See individual design sheets for each truss design identified on the placement drawing. The building designer is responsible for temporary and permanent bracing of the roof and floor system and for the overall structure. The design of the truss support structure including headers, beams, walls, and columns is the responsibility of the building designer. For general guidance regarding bracing, consult BCSI-B1 and BCSI-B3 provided with the truss delivery package or online @ sbcindustry.com

dearing reactions less than or equal to 3000# are eemed to comply with the prescriptive Code equirements. The contractor shall refer to the ttached Tables (derived from the prescriptive Code equirements) to determine the minimum foundation ize and number of wood studs required to support eactions greater than 3000# but not greater than 5000#. A registered design professional shall be etained to design the support system for any eaction that exceeds those specified in the attached ables. A registered design professional shall be etained to design the support system for all eactions that exceed 15000#.

ature Anthony Williams

Anthony Williams

Dimension Notes

1. All exterior wall to wall dimensions are to face of stud unless noted otherwise

2. All interior wall dimensions are to face of stud unless noted otherwise

3. All exterior wall to truss dimensions are to face of stud unless noted otherwise


All Walls Shown Are Considered Load Bearing

▲ = Indicates Left End of Truss (Reference Engineered Truss Drawing)
Do Not Erect Trusses Backwards

Roof Area = 11891.82 sq.ft. Ridge Line = 164 ft. Hip Line = 0 ft. Horiz. OH = 253 ft. Raked OH = 290.97 ft. Decking = 409 sheets

Connector Information Nail Information SymProductManufQtySupported MemberHeaderTrussHUS26USP25NA16d/3-1/2"16d/3-1/2"

Truss Placement Plan SCALE: 3/16" = 1'-0"

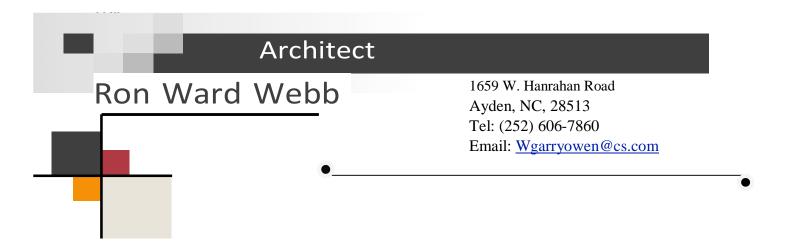

To: Mr. Brad Sutton, Code Enforcement Officer, Harnett County Inspections

From: Ron Ward Webb, Architect

Date: March 10, 2025

Re: Mount Pisgah Harnett OFWB Church

Mr. Sutton

Thank you for your most recent Plan Review comments. Without taking away from Mr. Tommy McLeod's comments, I will offer the following additional comments:

Your Item No. 1: No Structural Trusses will bear on or penetrate the rated 2 Hour Fire Barrier. The Fire Barrier will be parallel and tight to the bearing wall of the Multi-Purpose Room, but on the Educational side and the Contractor will set the first truss on the Educational side to allow for the Fire Barrier to extend tight to the underside of the Educational Roof. The bearing wall of the Multi Purpose Room will be braced by the trusses for the Multi Purpose Room, and the Fire Barrier wall will be braced by the incoming roof of the Educational Building. The trusses for the Educational Building are running from front to back so that the Fire Barrier will be running parallel to the Educational trusses, thus allowing it to run up tight to the underside of the roof.

Your Item No. 2: The column which receives Girder Truss GRD is just outside of the Fire Barrier, but all columns will be wrapped with 2 hour rated construction in compliance with UL Design No. U-419.

Your Item No. 3: All doors and frames within the Fire Barrier will be 90 minute rated with limiting glass area per Code.

Your Item No. 4: There will now be rated dampers within the penetrations of the Fire Barrier in ductwork. The reason these were not in the original plans is because the rated Fire Barrier was not. Now that the Fire Barrier is in the Scope of Work, the rated dampers will also be in the ductwork.

Your Item No. 5: Drawing M000, Note P states to provide duct smoke detectors. Also Drawing M401, Detail #3 shows the duct mounted Smoke Detectors.

Please do not hesitate to call if I may offer further clarifications. Thank you very much.

Sincerely

Ron Ward Webb, Architect

cc: R. Hinton, G. Surles, G. Blue, T. McLeod, file code: PR Response #2