


ROOM FINISH SCHEDULE						
No.	NAME	FLOOR	BASE	WALLS	CEILING	HT.
001	ENTRY PORCH	EXPOSED CONC.	N/A	N/A	VENTED VINYL	11'-0"
101	LOBBY	VCT	4" RUBBER	PAINTED GWB	2x2 AC. TILE	10'-0"
102	MULTI PURPOSE	VCT	4" RUBBER	PAINTED GWB	2x2 AC. TILE	SLOPED
103	SECURITY	CARPET	4" RUBBER	PAINTED GWB	2x2 AC. TILE	10'-0"
104	MULTI MEDIA	CARPET	4" RUBBER	PAINTED GWB	2x2 AC. TILE	10'-0"
105	STORAGE	VCT	4" RUBBER	PAINTED GWB	2x2 AC. TILE	10'-0"
106	JAN. / STORAGE	VCT	4" RUBBER	PAINTED GWB	2x2 AC. TILE	10'-0"
107	KITCHEN	VCT	4" RUBBER	PAINTED GWB	2x2 AC. TILE	10'-0"
108	PANTRY	VCT	4" RUBBER	PAINTED GWB	2x2 AC. TILE	10'-0"
109	ELECTRIC	EXPOSED CONC.	4" RUBBER	PAINTED GWB	PAINTED GWB	16'-0"
110	FAMILY TOILET	VCT	4" RUBBER	PAINT & TILE	2x2 AC. TILE	10'-0"
111	CLASSROOM	CARPET	4" RUBBER	PAINTED GWB	2x2 AC. TILE	10'-0"
112	CLASSROOM	CARPET	4" RUBBER	PAINTED GWB	2x2 AC. TILE	10'-0"
113	CLASSROOM	CARPET	4" RUBBER	PAINTED GWB	2x2 AC. TILE	10'-0"
114	REAR LOBBY	VCT	4" RUBBER	PAINTED GWB	2x2 AC. TILE	10'-0"
115	REAR CORRIDOR	VCT	4" RUBBER	PAINTED GWB	2x2 AC. TILE	10'-0"
116	WOMEN	CERAMIC TILE	CERAMIC TILE	PAINT & TILE	2x2 AC. TILE	10'-0"
117	MEN	CERAMIC TILE	CERAMIC TILE	PAINT & TILE	2x2 AC. TILE	10'-0"
118	CLASSROOM	CARPET	4" RUBBER	PAINTED GWB	2x2 AC. TILE	10'-0"
119	CLASSROOM	CARPET	4" RUBBER	PAINTED GWB	2x2 AC. TILE	10'-0"
120	MAIN CORRIDOR	VCT	4" RUBBER	PAINTED GWB	2x2 AC. TILE	10'-0"

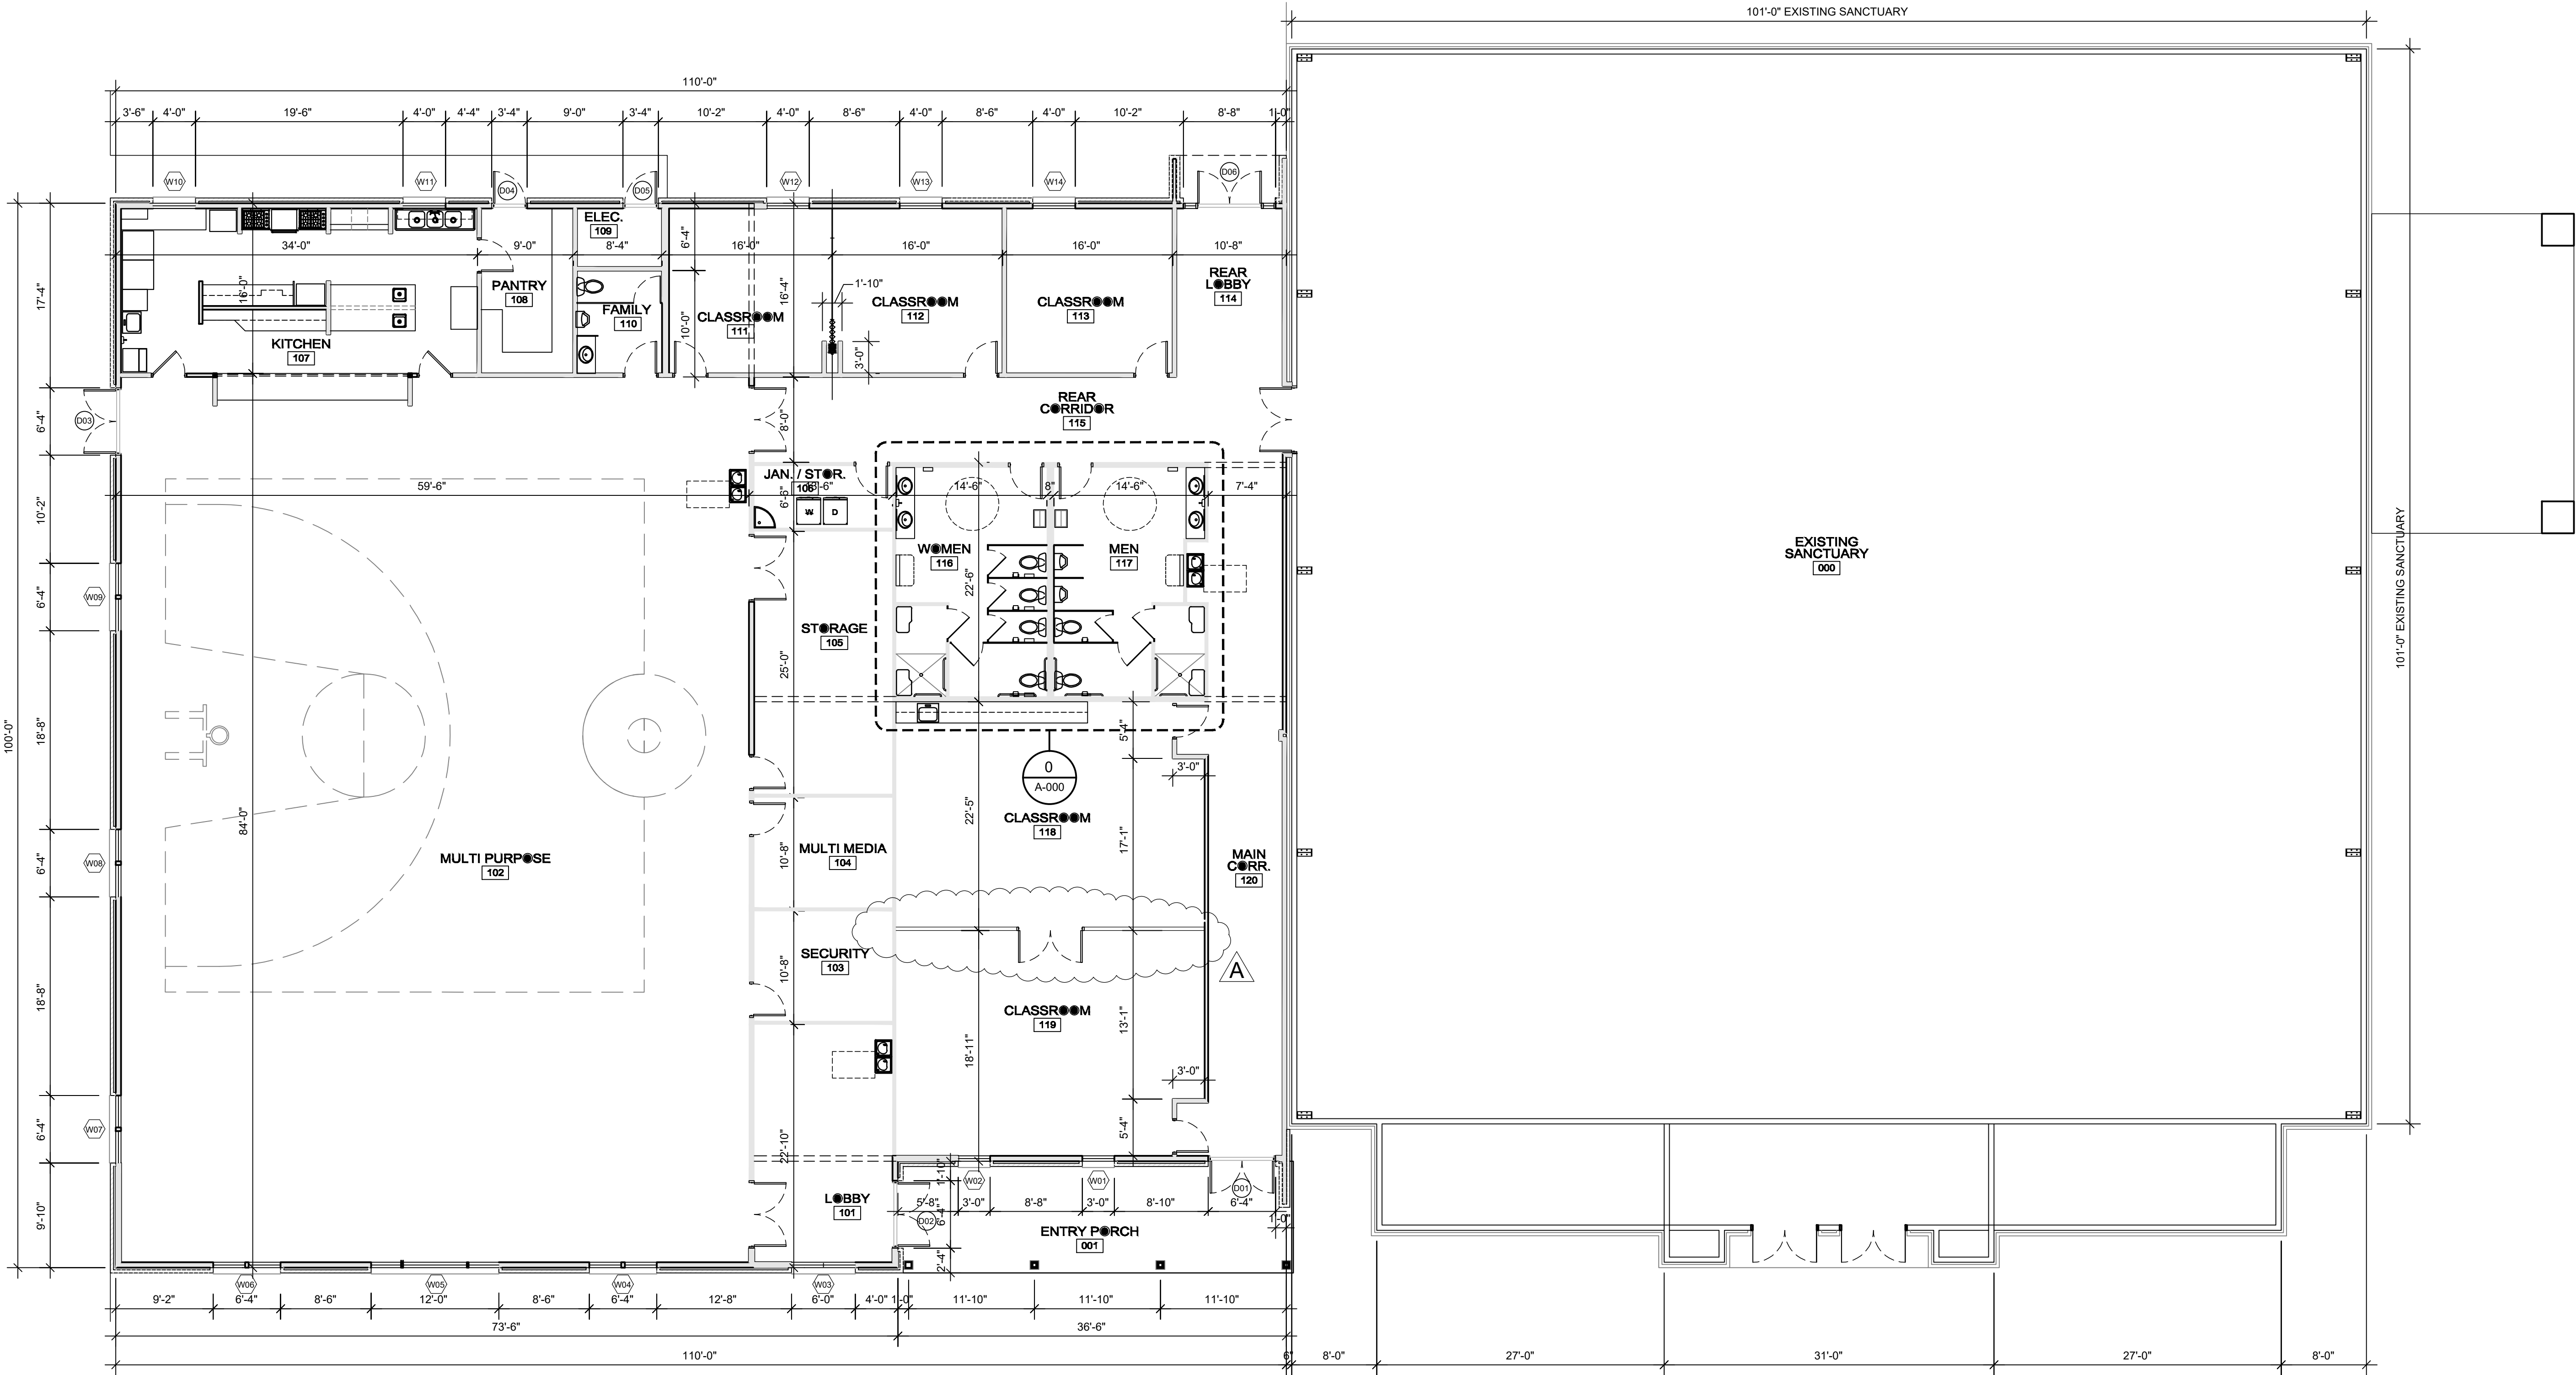

OVERALL FLOOR PLAN
SCALE: 1/8" = 1'-0"

PRELIMINARY
NOT FOR CONSTRUCTION
09/08/2023


ARCHITECT

RON W. WEBB
1659 W. HANRAHAN ROAD
AYDEN, NC. 28513
TEL: (252) 531-2711

Ministries Activity Center Addition Mount Pisgah Harnett Original Free Will Baptist Church


145 Prospect Church Road
Erwin, NC.

PROJECT CONSULTANTS

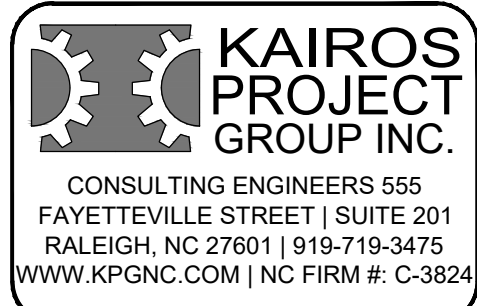

STRUCTURAL

NEVILLE ENGINEERING
AUGUSTUS NEVILLE, PE
100-B CULBRETH RD.
CHAPEL HILL, NC 27516
TEL: (919) 740-3427

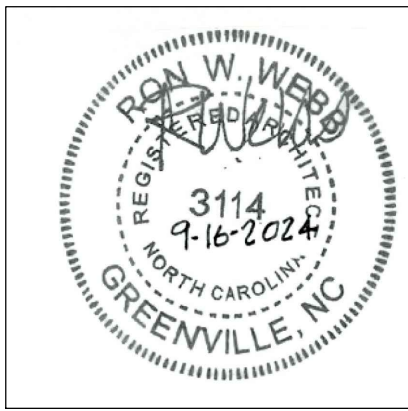

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Revisions


Mark	Date	Description
A	10-28-24	Lowered height of wall tile from 7'-0" to 5'-0" in schedule. Removed folding partition and added a wall and double door. Door type to be determined.

Drawing No.

OVERALL
FLOOR
PLAN

A1
of

ROOM FINISH SCHEDULE							
No.	NAME	FLOOR	BASE	WALLS	CEILING	HT.	REMARKS
001	ENTRY PORCH	EXPOSED CONC.	N/A	N/A	VENTED VINYL	11'-0"	BROOM FINISH CONC.
101	LOBBY	VCT	4" RUBBER	PAINTED GWB	2x2 AC. TILE	10'-0"	
102	MULTI PURPOSE	VCT	4" RUBBER	PAINTED GWB	2x2 AC. TILE	SLOPED	
103	SECURITY	CARPET	4" RUBBER	PAINTED GWB	2x2 AC. TILE	10'-0"	
104	MULTI MEDIA	CARPET	4" RUBBER	PAINTED GWB	2x2 AC. TILE	10'-0"	
105	STORAGE	VCT	4" RUBBER	PAINTED GWB	2x2 AC. TILE	10'-0"	
106	JAN. / STORAGE	VCT	4" RUBBER	PAINTED GWB	2x2 AC. TILE	10'-0"	
107	KITCHEN	VCT	4" RUBBER	PAINTED GWB	2x2 AC. TILE	10'-0"	FRP PANELS 6'-0" HIGH, EPOXY PAINT ABOVE
108	PANTRY	VCT	4" RUBBER	PAINTED GWB	2x2 AC. TILE	10'-0"	
109	ELECTRIC	EXPOSED CONC.	4" RUBBER	PAINTED GWB	PAINTED GWB	16'-0"	
110	FAMILY TOILET	VCT	4" RUBBER	PAINT & TILE	2x2 AC. TILE	10'-0"	TILE TO 7'-0" HIGH, EPOXY PAINT ABOVE
111	CLASSROOM	CARPET	4" RUBBER	PAINTED GWB	2x2 AC. TILE	10'-0"	
112	CLASSROOM	CARPET	4" RUBBER	PAINTED GWB	2x2 AC. TILE	10'-0"	
113	CLASSROOM	CARPET	4" RUBBER	PAINTED GWB	2x2 AC. TILE	10'-0"	
114	REAR LOBBY	VCT	4" RUBBER	PAINTED GWB	2x2 AC. TILE	10'-0"	
115	REAR CORRIDOR	VCT	4" RUBBER	PAINTED GWB	2x2 AC. TILE	10'-0"	
116	WOMEN	CERAMIC TILE	CERAMIC TILE	PAINT & TILE	2x2 AC. TILE	10'-0"	TILE TO 7'-0" HIGH, EPOXY PAINT ABOVE
117	MEN	CERAMIC TILE	CERAMIC TILE	PAINT & TILE	2x2 AC. TILE	10'-0"	TILE TO 7'-0" HIGH, EPOXY PAINT ABOVE
118	CLASSROOM	CARPET	4" RUBBER	PAINTED GWB	2x2 AC. TILE	10'-0"	
119	CLASSROOM	CARPET	4" RUBBER	PAINTED GWB	2x2 AC. TILE	10'-0"	
120	MAIN CORRIDOR	VCT	4" RUBBER	PAINTED GWB	2x2 AC. TILE	10'-0"	

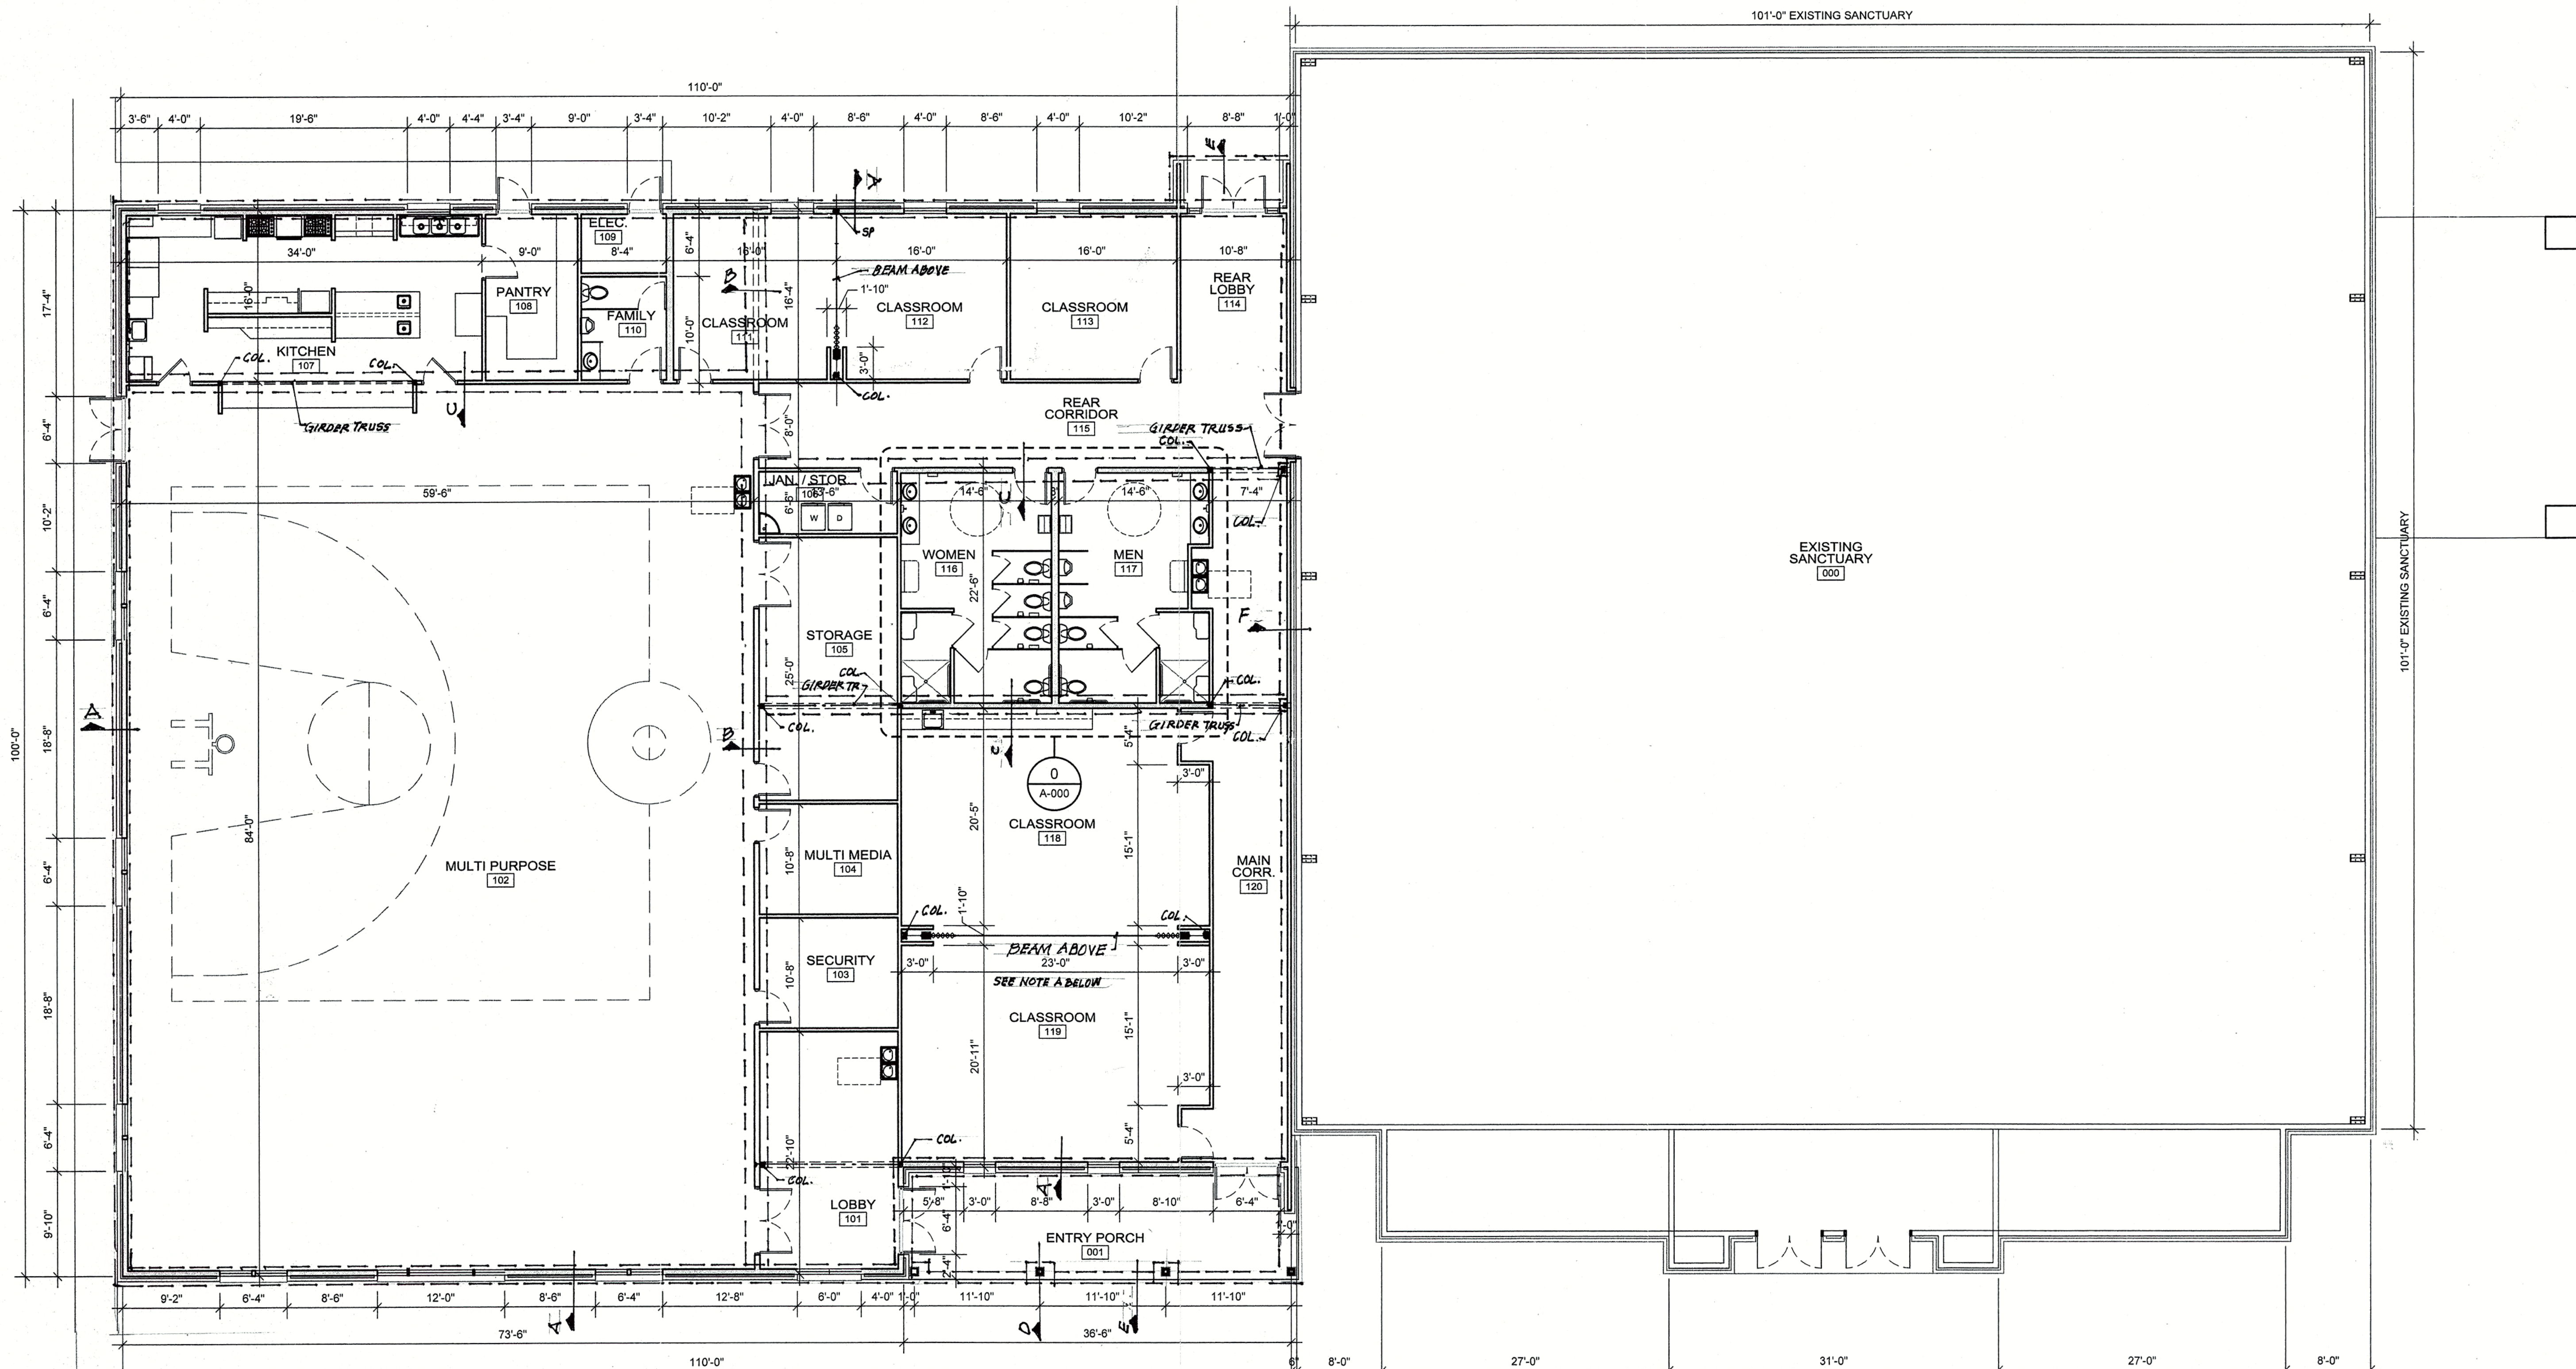

NOTE A: NO ROOF TRUSS LOAD ALLOWED ON FOLDING PARTITION BEAM.
NOTE B: WHERE COL'S ARE WIDER THAN STUD WALL, FLARE OUT FRAMING AND DRILLWALL TO ENCAPSULATE.

'FOOTING PLAN' OVERALL FLOOR PLAN

SCALE: 1/8" = 1'-0"


ARCHITECT

RON W. WEBB
1659 W. HANRAHAN ROAD
AYDEN, NC. 28513
TEL: (252) 531-2711

Ministries Activity Center Addition Mount Pisgah Harnett Original Free Will Baptist Church

145 Prospect Church Road
Erwin, NC.

PROJECT CONSULTANTS

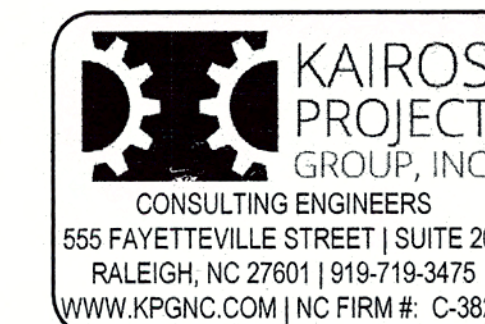

STRUCTURAL

NEVILLE ENGINEERING

AUGUSTUS NEVILLE, PE
100-B CULBRETH RD.
CHAPEL HILL, NC 27516
TEL: (919) 740-3427



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Revisions

Mark	Date	Description

FOOTING PLAN

OVERALL
FLOOR
PLAN

A-2

Drawing No.

of

ARCHITECT

RON W. WEBB
1659 W. HANRAHAN ROAD
AYDEN, NC. 28513
TEL: (252) 531-2711

Ministries Activity Center Addition Mount Pisgah Harnett Original Free Will Baptist Church

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STRUCTURAL

NEVILLE ENGINEERING
AUGUSTUS NEVILLE, PE
100-B CULBRETH RD.
CHAPEL HILL, NC 27516
TEL: (919) 740-3427



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Issue Date: 09/20/2023

Plot Date:

Revisions

Mark	Date	Description








SHEET NAME

FOUNDATION DETAILS


A-3

Drawing No.

of

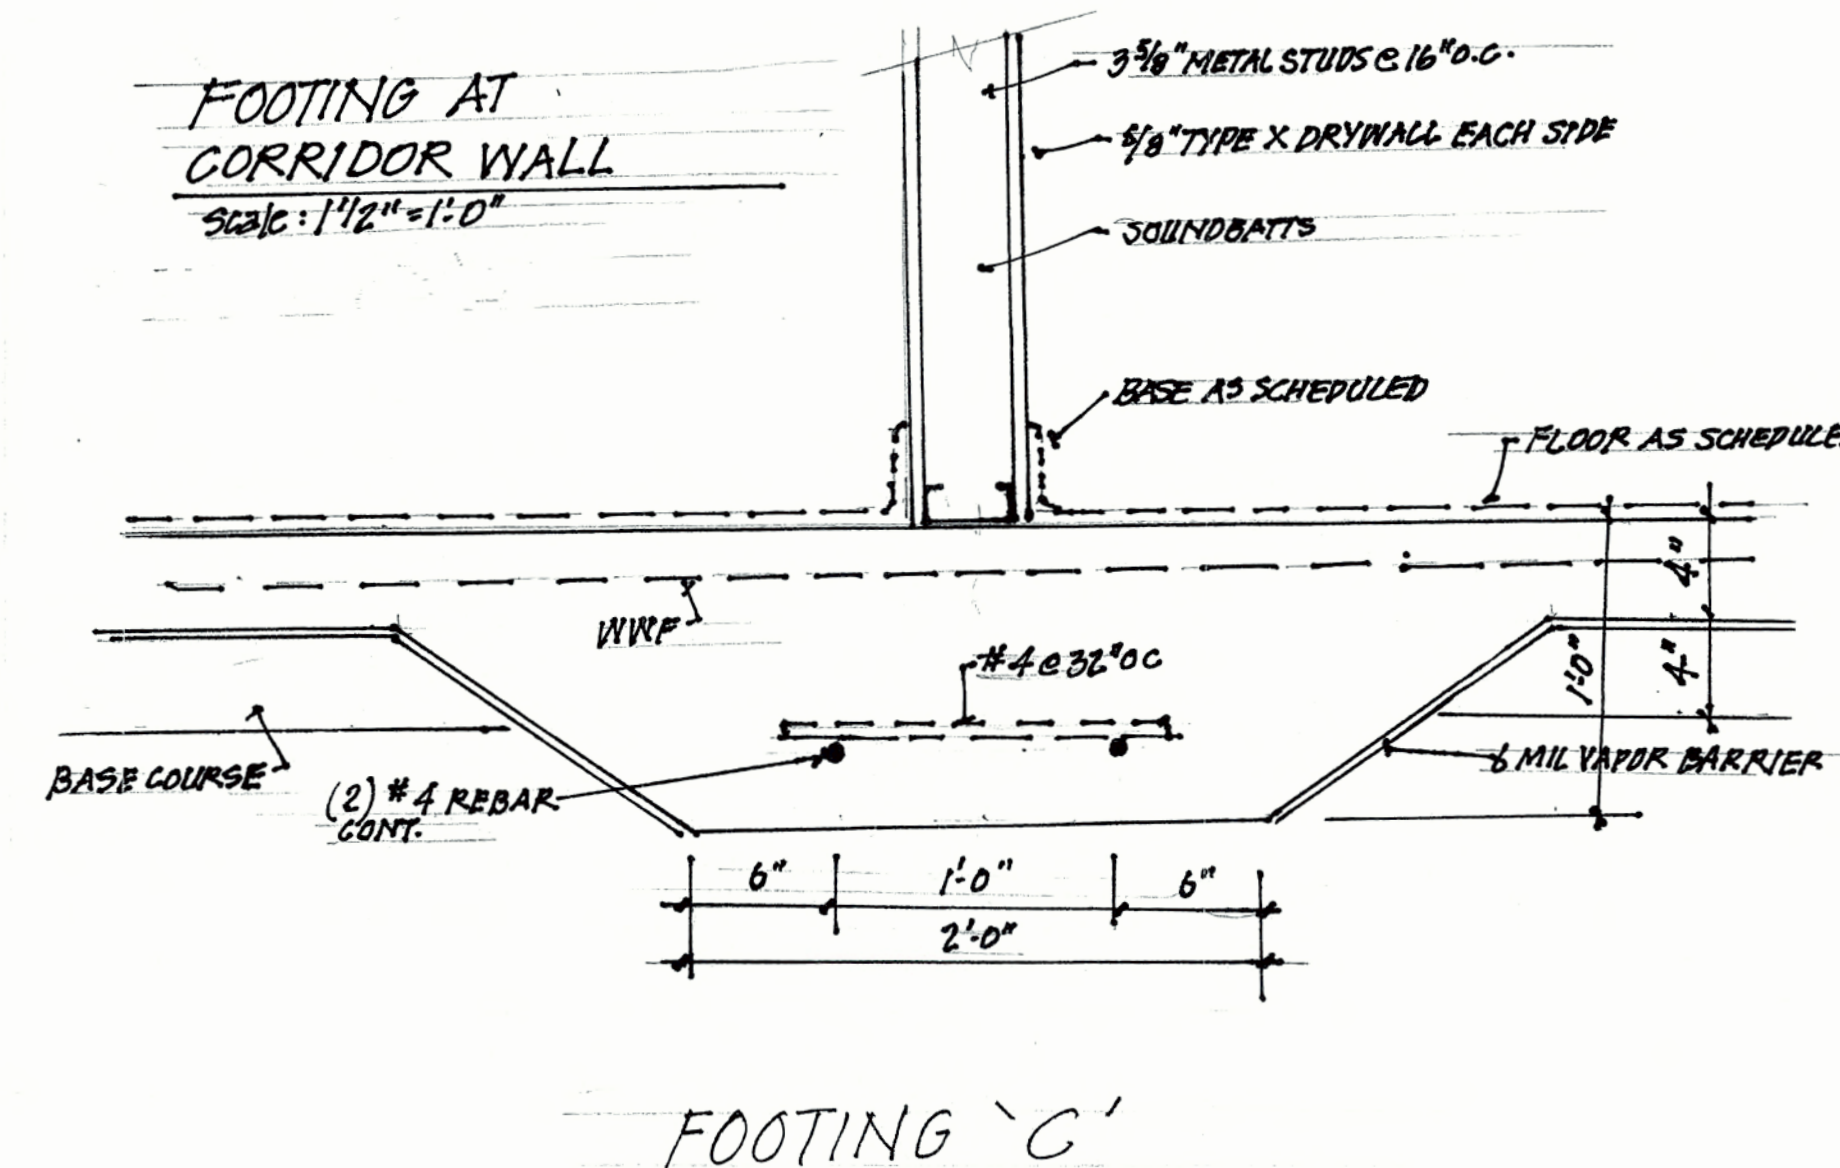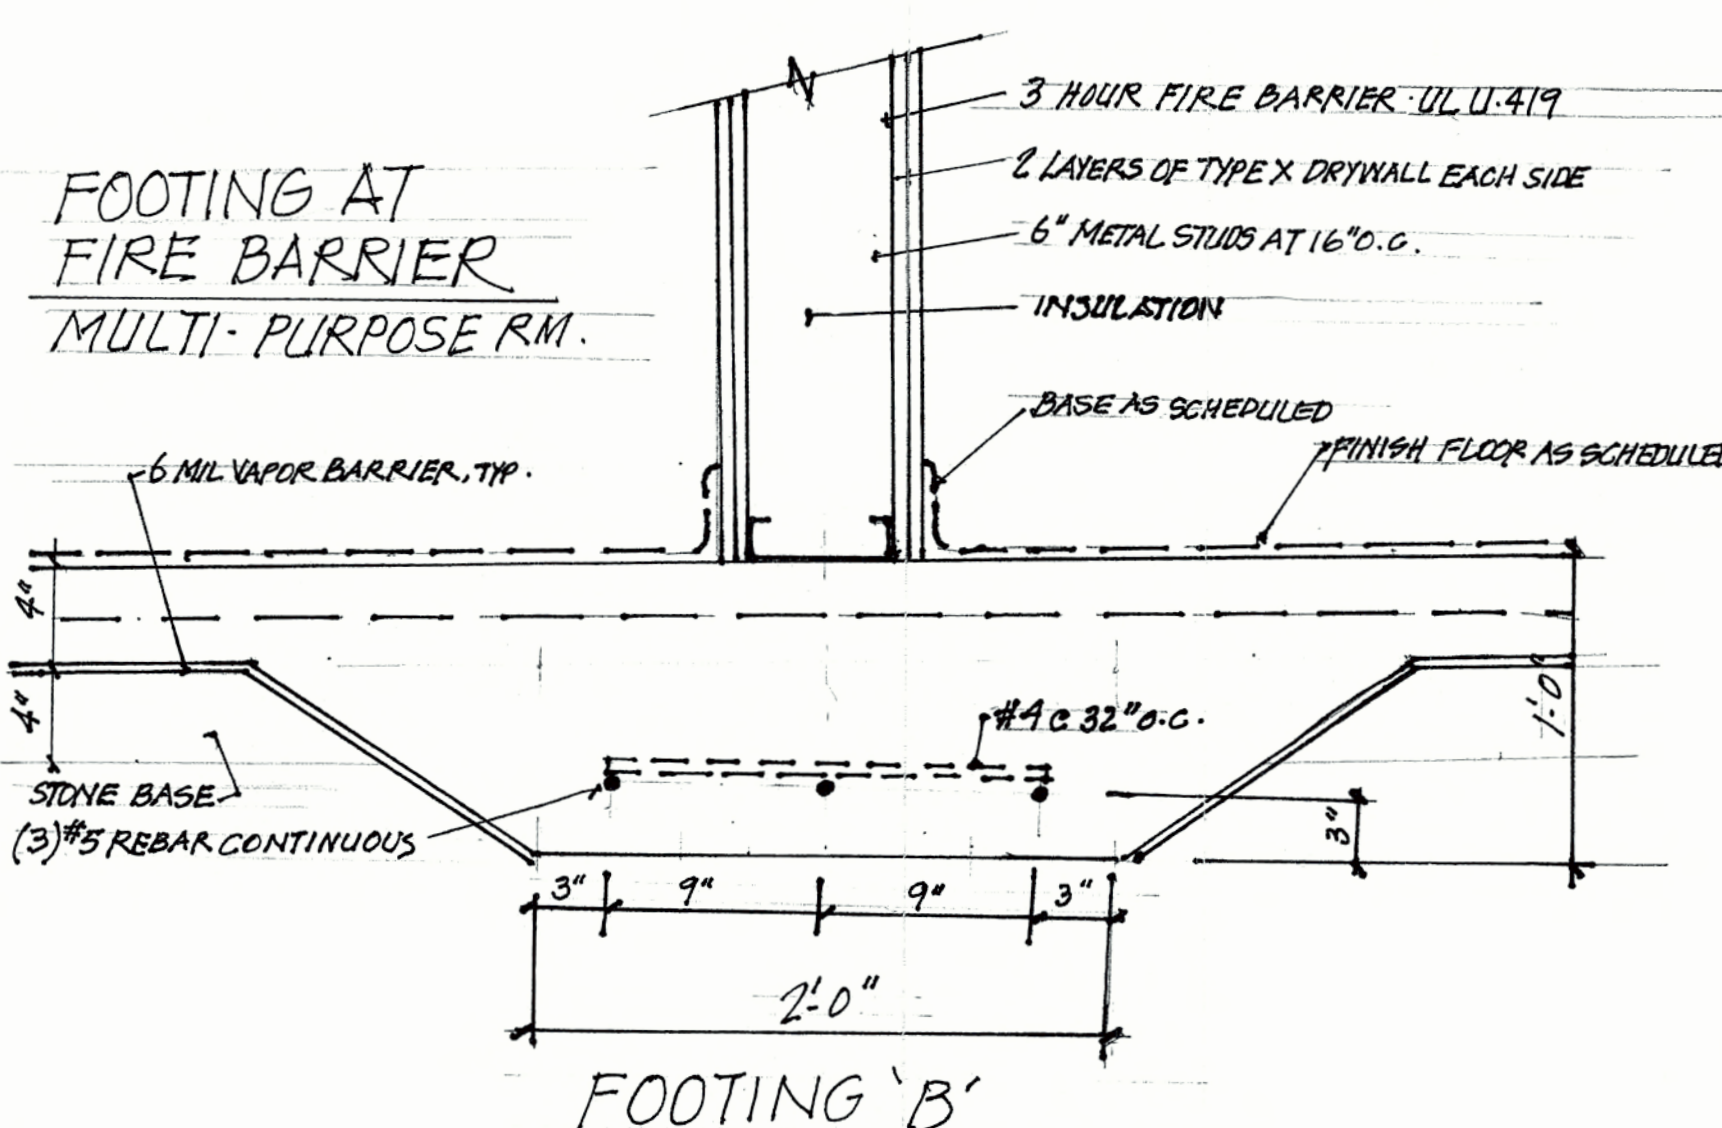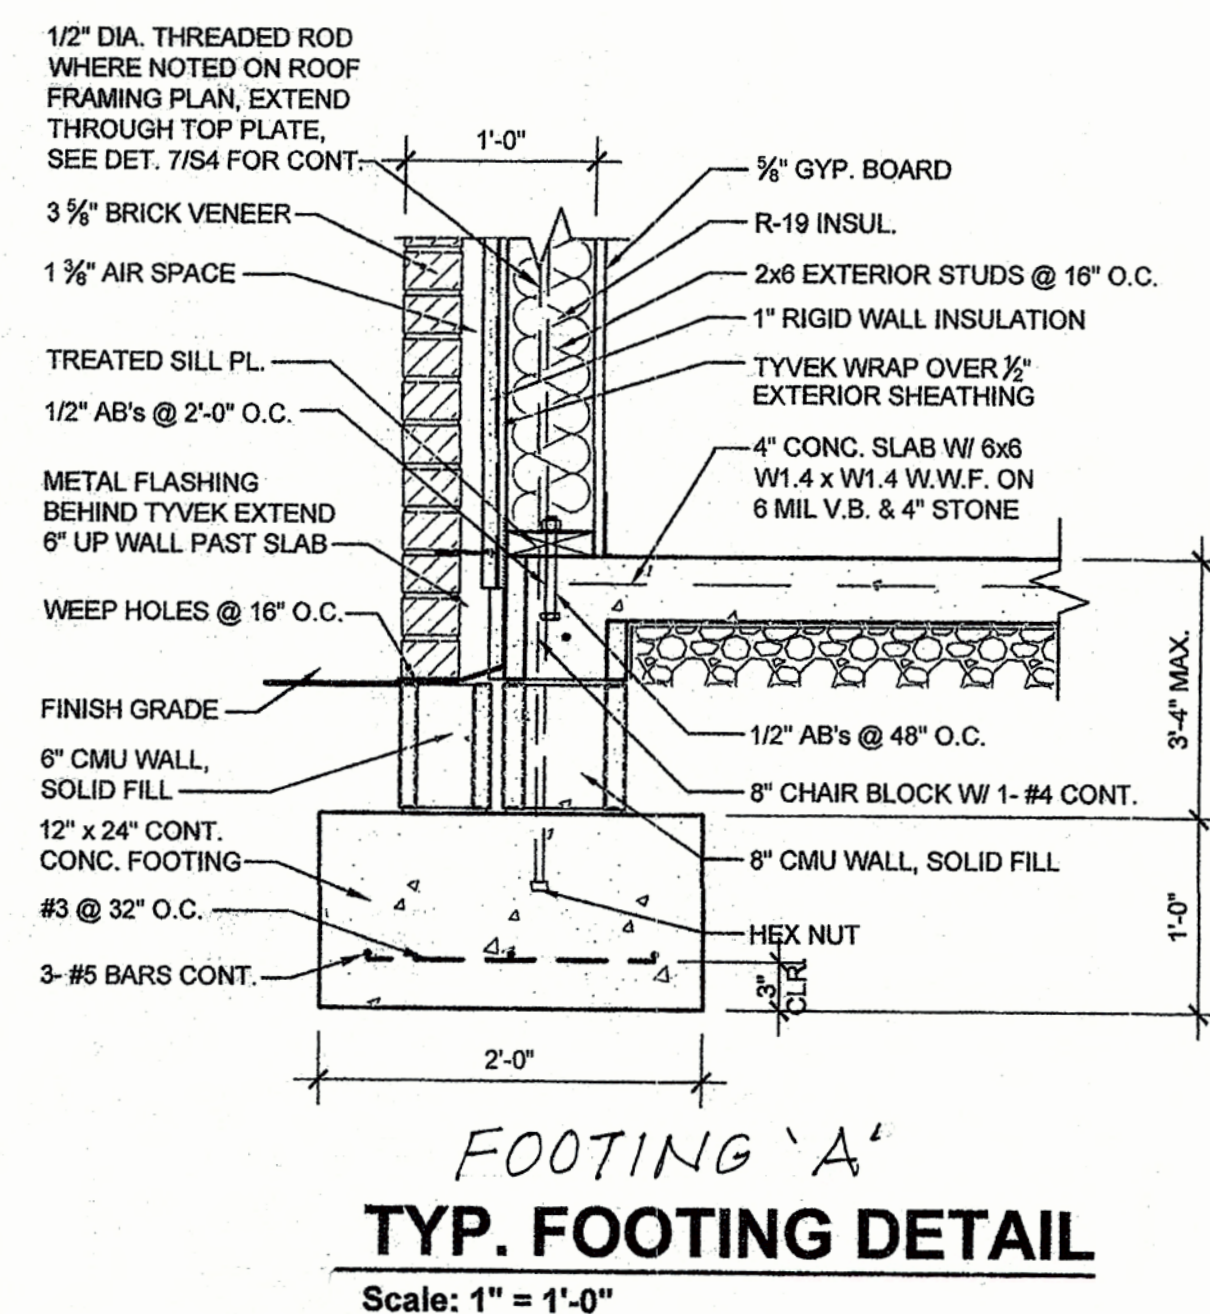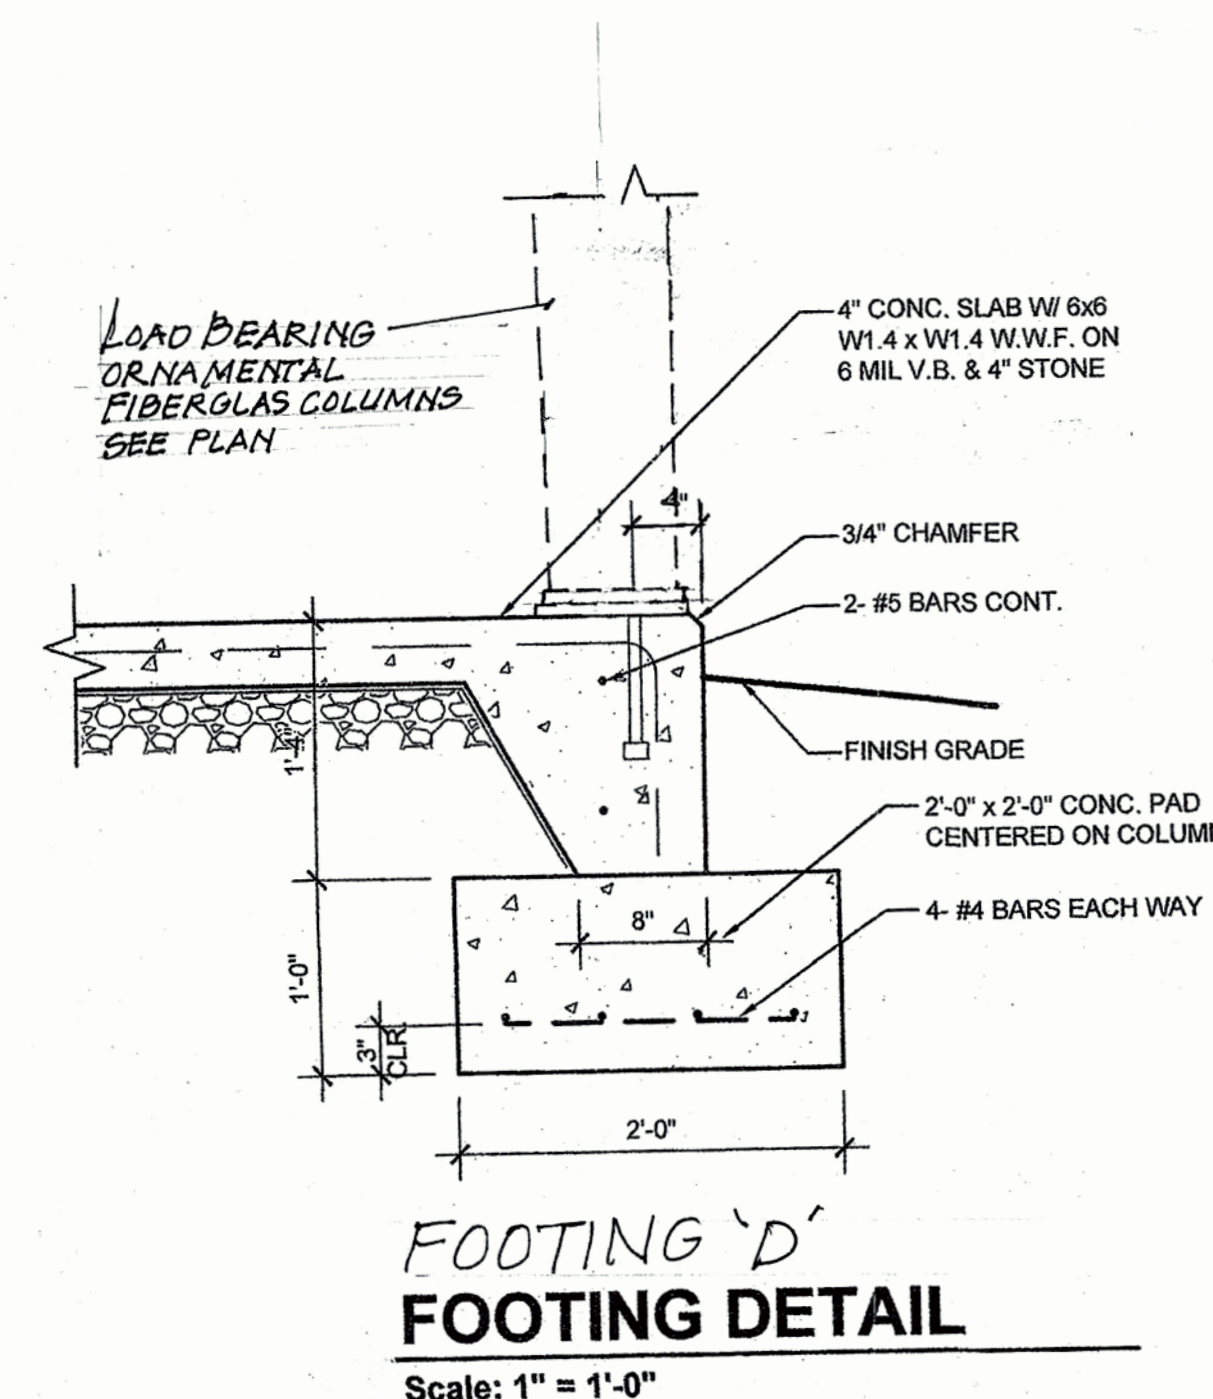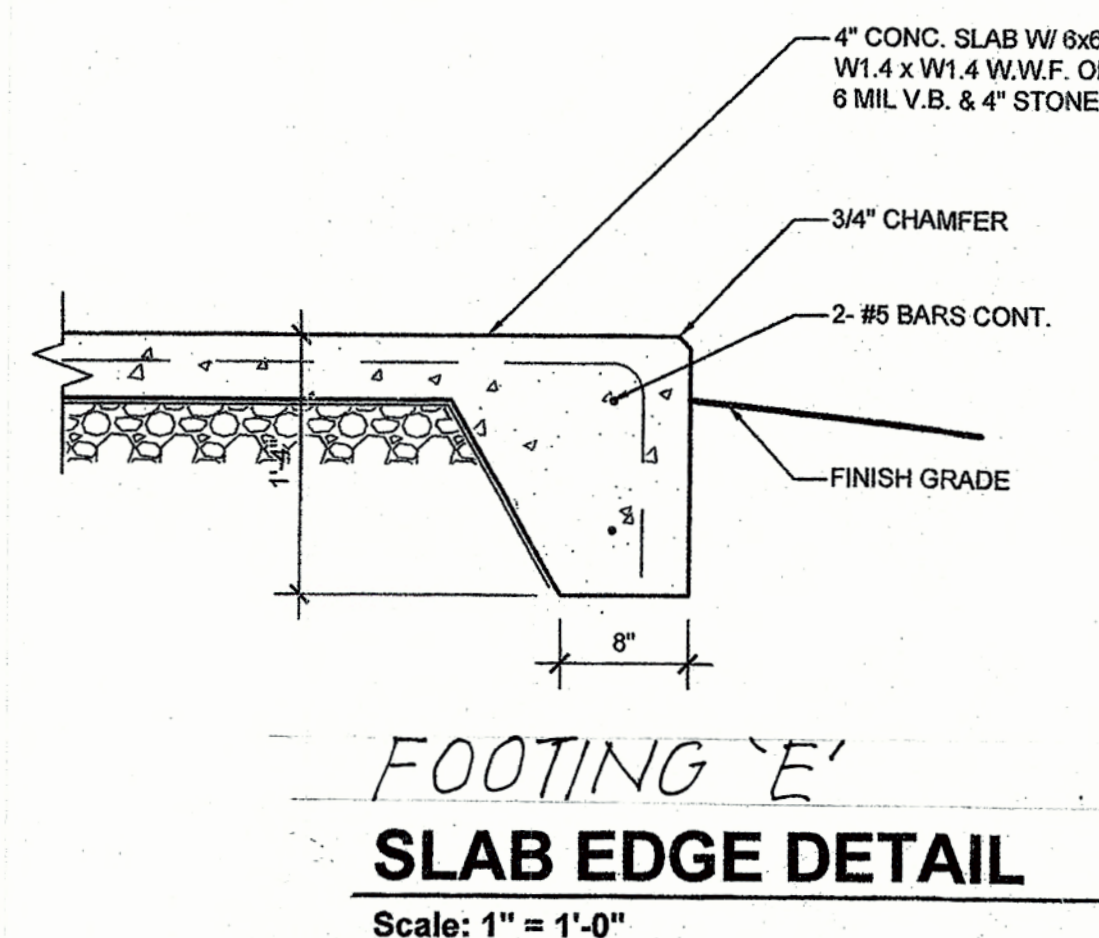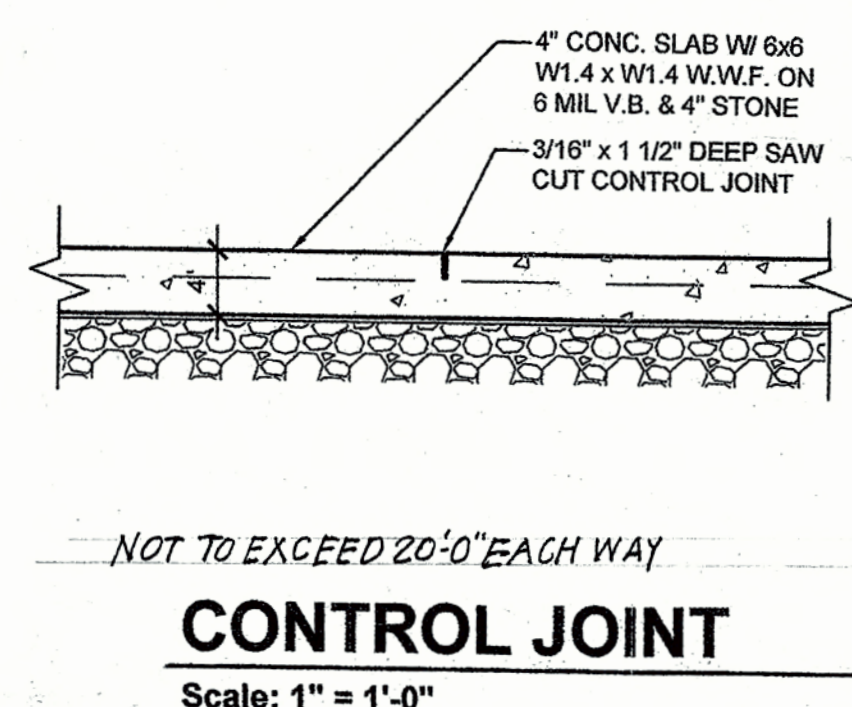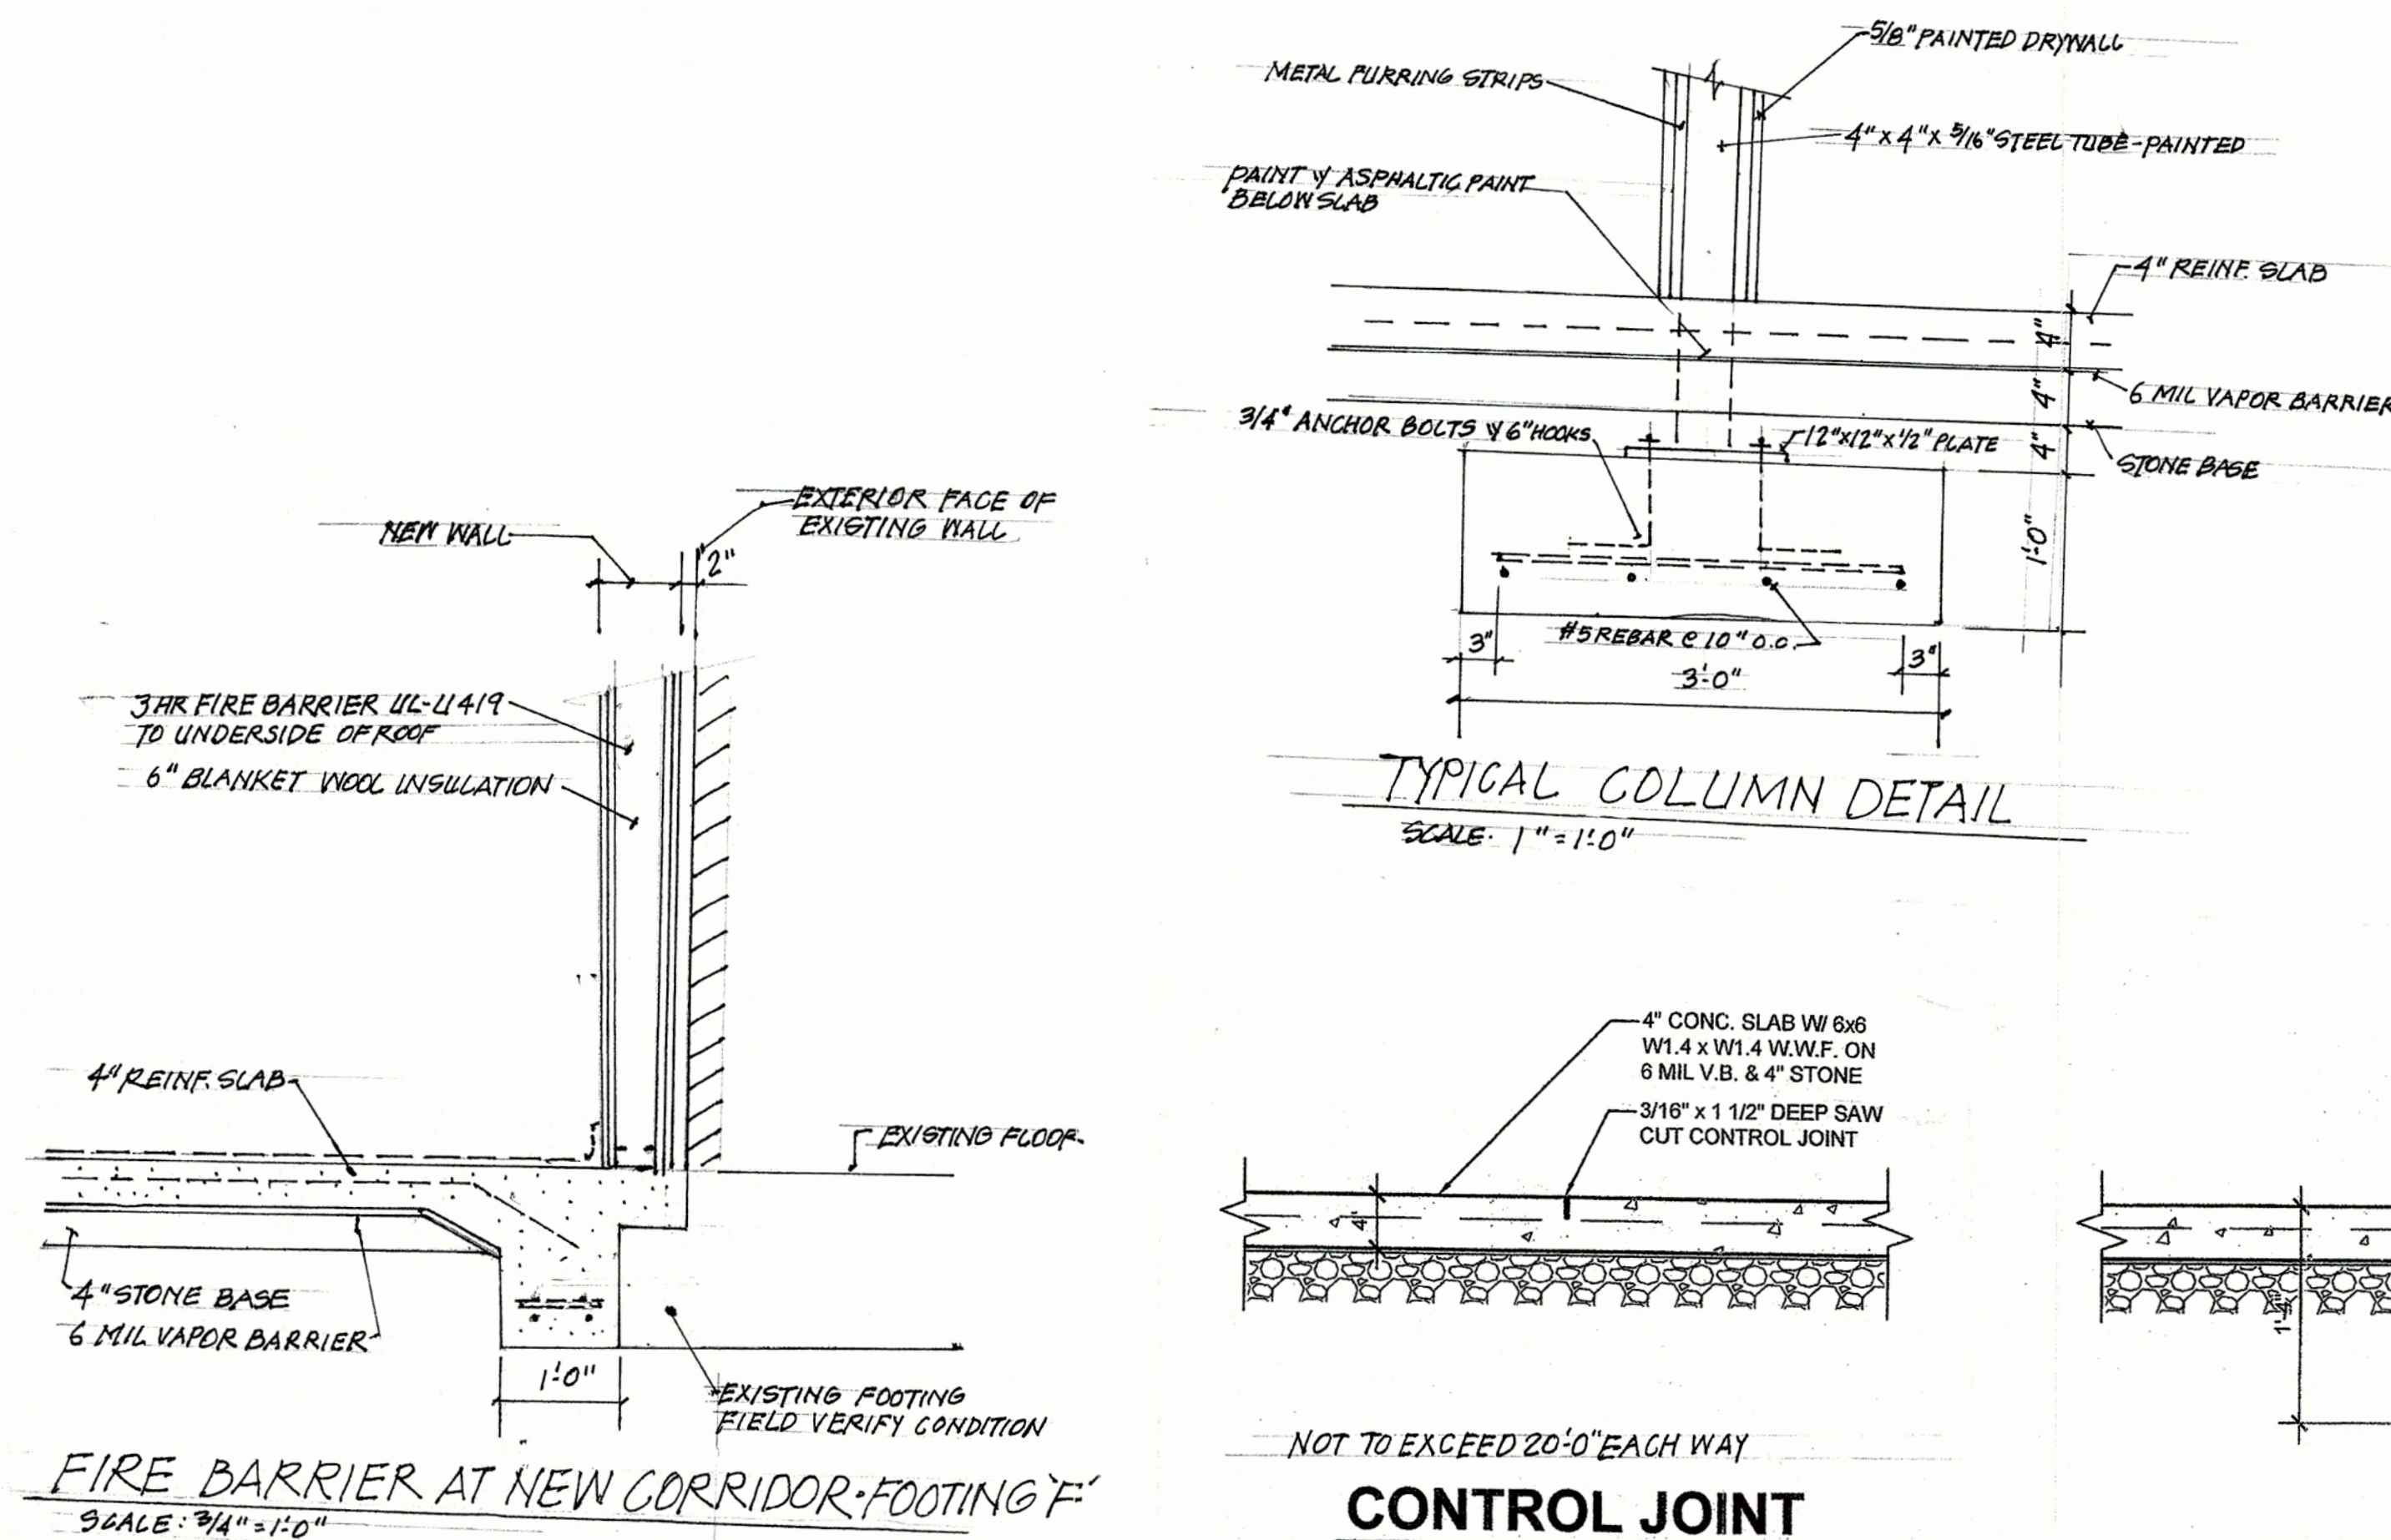

ROOM FINISH SCHEDULE							
No.	NAME	FLOOR	BASE	WALLS	CEILING	HT.	REMARKS
001	ENTRY PORCH	EXPOSED CONC.	N/A	N/A	VENTED VINYL	11'-0"	BROOM FINISH CONC.
101	LOBBY	VCT	4" RUBBER	PAINTED GWB	2x2 AC. TILE	10'-0"	
102	MULTI PURPOSE	VCT	4" RUBBER	PAINTED GWB	2x2 AC. TILE	SLOPED	
103	SECURITY	CARPET	4" RUBBER	PAINTED GWB	2x2 AC. TILE	10'-0"	
104	MULTI MEDIA	CARPET	4" RUBBER	PAINTED GWB	2x2 AC. TILE	10'-0"	
105	STORAGE	VCT	4" RUBBER	PAINTED GWB	2x2 AC. TILE	10'-0"	
106	JAN / STORAGE	VCT	4" RUBBER	PAINTED GWB	2x2 AC. TILE	10'-0"	
107	KITCHEN	VCT	4" RUBBER	PAINTED GWB	2x2 AC. TILE	10'-0"	FRP PANELS 6'-0" HIGH, EPOXY PAINT ABOVE
108	PANTRY	VCT	4" RUBBER	PAINTED GWB	2x2 AC. TILE	10'-0"	
109	ELECTRIC	EXPOSED CONC.	4" RUBBER	PAINTED GWB	PAINTED GWB	16'-0"	
110	FAMILY TOILET	VCT	4" RUBBER	PAINT & TILE	2x2 AC. TILE	10'-0"	TILE TO 7'-0" HIGH, EPOXY PAINT ABOVE
111	CLASSROOM	CARPET	4" RUBBER	PAINTED GWB	2x2 AC. TILE	10'-0"	
112	CLASSROOM	CARPET	4" RUBBER	PAINTED GWB	2x2 AC. TILE	10'-0"	
113	CLASSROOM	CARPET	4" RUBBER	PAINTED GWB	2x2 AC. TILE	10'-0"	
114	REAR LOBBY	VCT	4" RUBBER	PAINTED GWB	2x2 AC. TILE	10'-0"	
115	REAR CORRIDOR	VCT	4" RUBBER	PAINTED GWB	2x2 AC. TILE	10'-0"	
116	WOMEN	CERAMIC TILE	CERAMIC TILE	PAINT & TILE	2x2 AC. TILE	10'-0"	TILE TO 7'-0" HIGH, EPOXY PAINT ABOVE
117	MEN	CERAMIC TILE	CERAMIC TILE	PAINT & TILE	2x2 AC. TILE	10'-0"	TILE TO 7'-0" HIGH, EPOXY PAINT ABOVE
118	CLASSROOM	CARPET	4" RUBBER	PAINTED GWB	2x2 AC. TILE	10'-0"	
119	CLASSROOM	CARPET	4" RUBBER	PAINTED GWB	2x2 AC. TILE	10'-0"	
120	MAIN CORRIDOR	VCT	4" RUBBER	PAINTED GWB	2x2 AC. TILE	10'-0"	

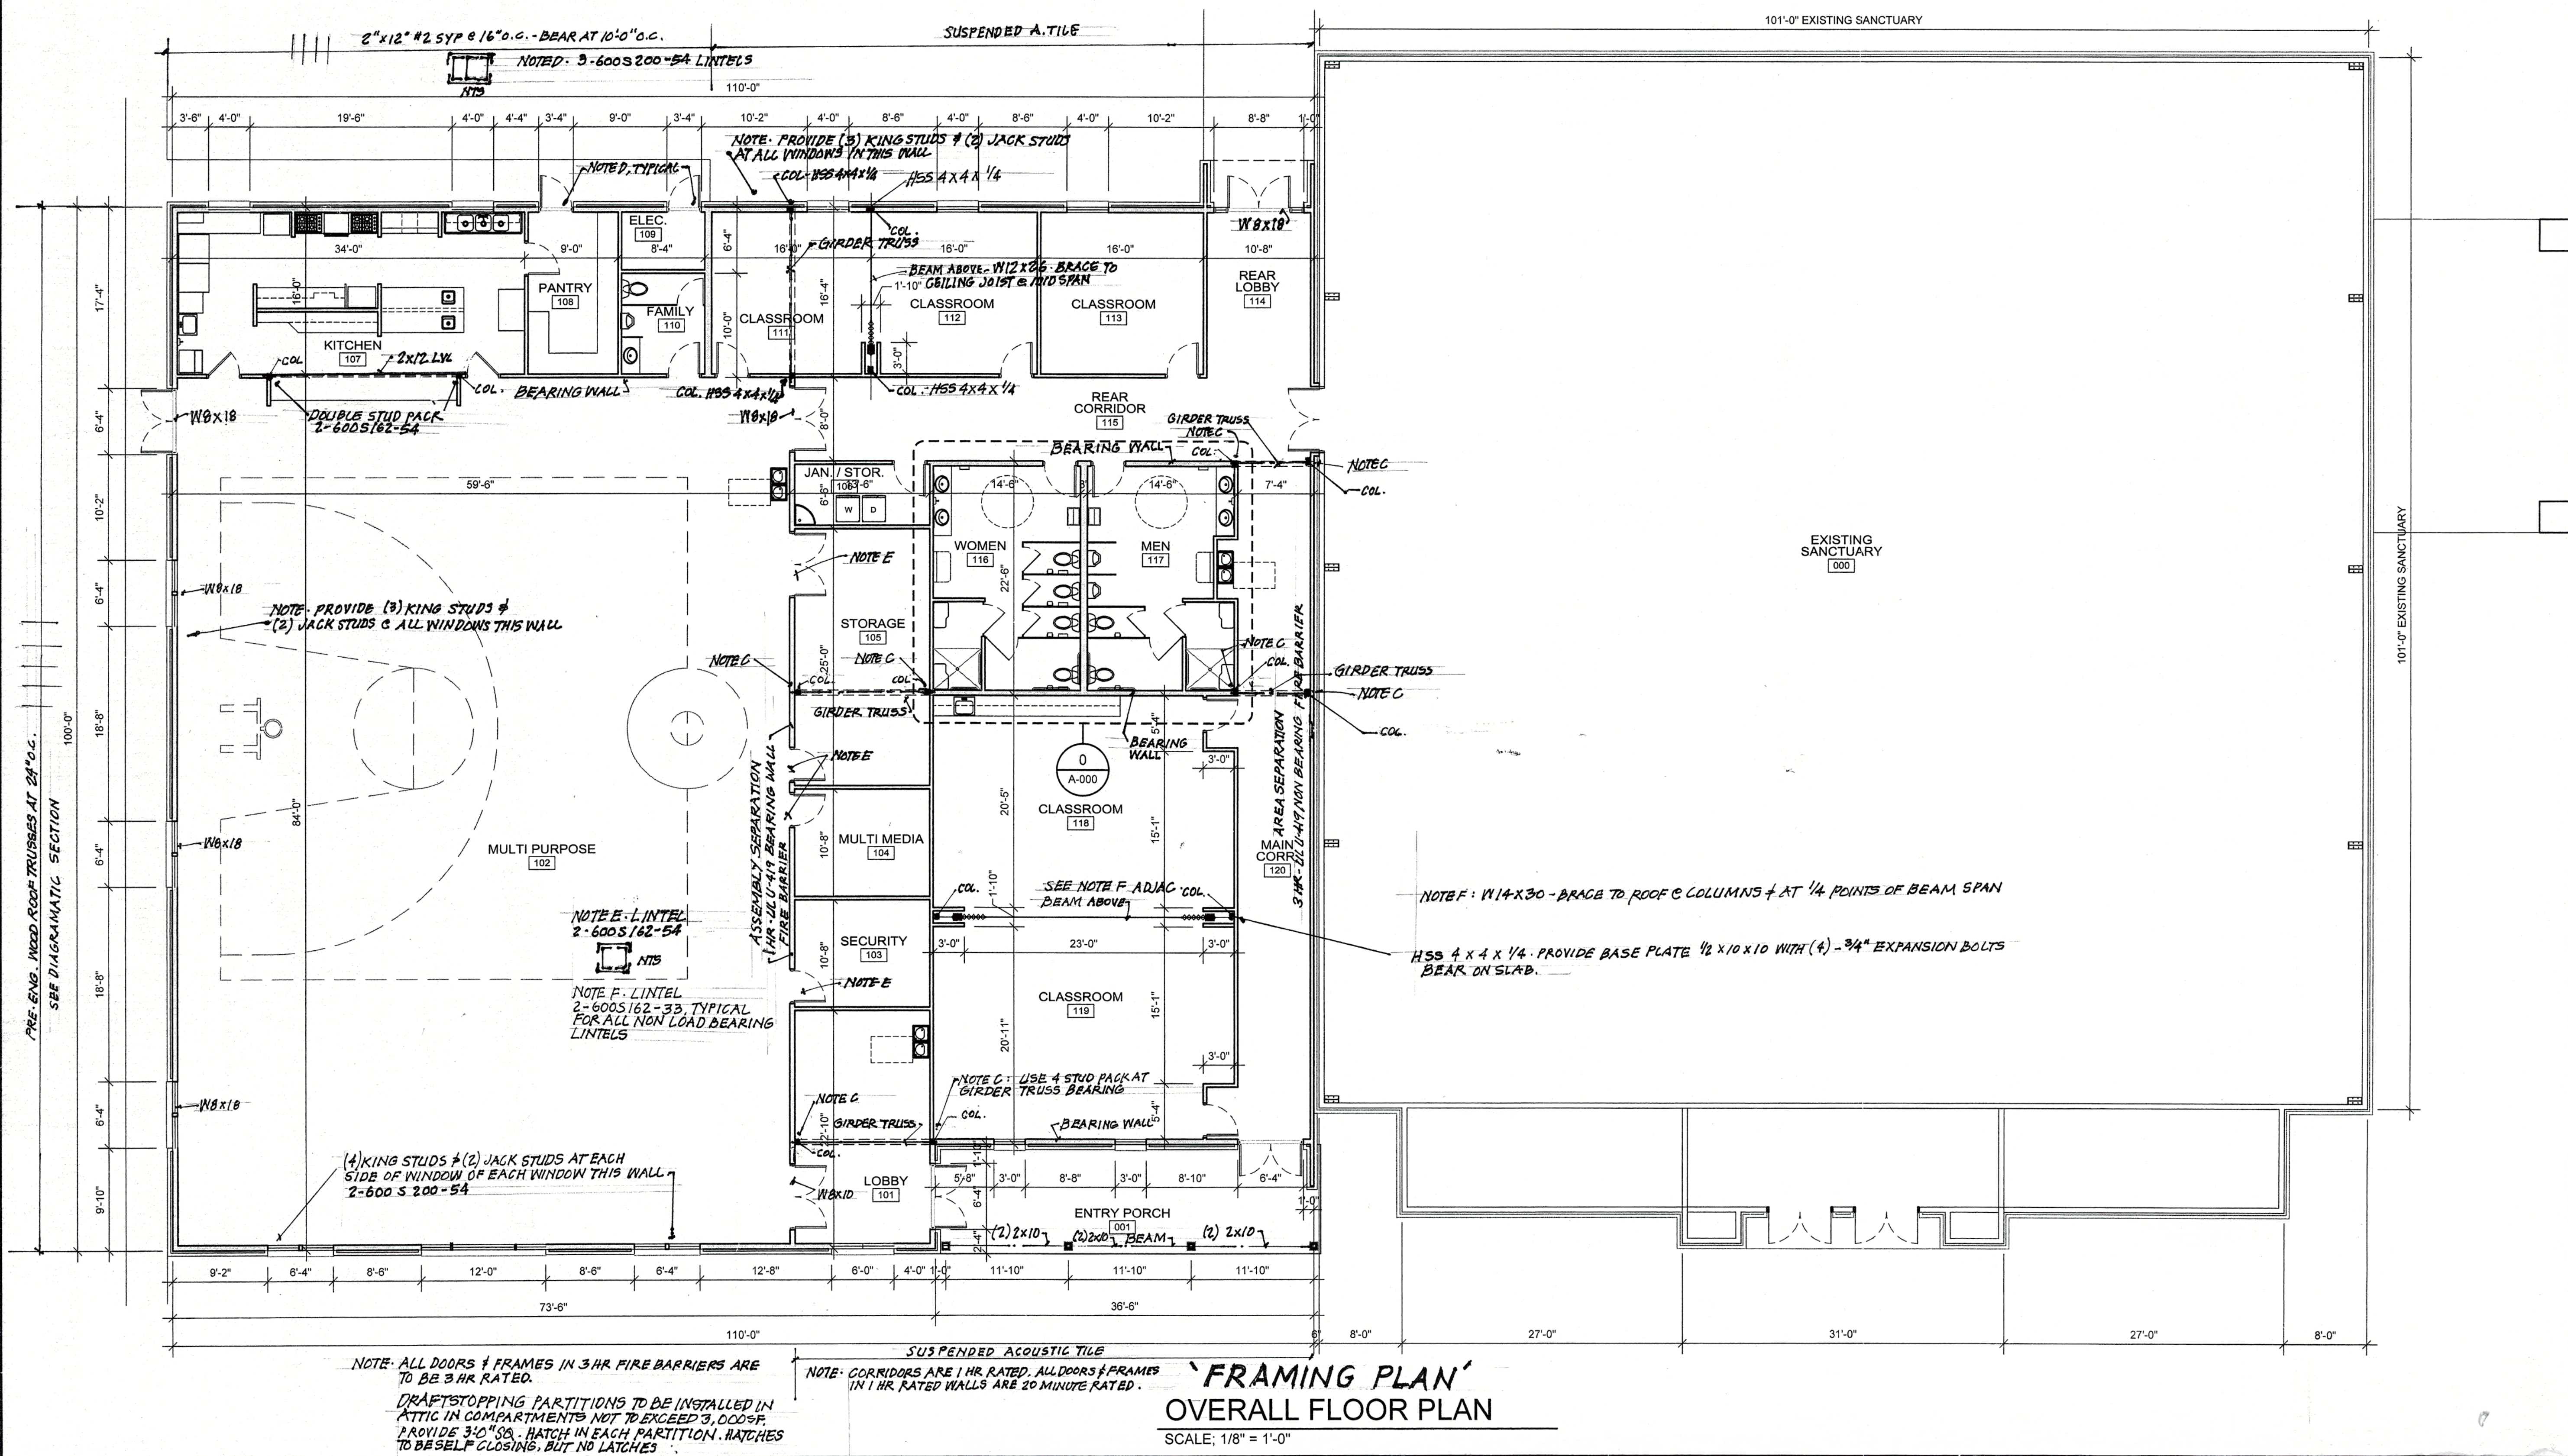

ARCHITECT

RON W. WEBB
1659 W. HANRAHAN ROAD
AYDEN, NC. 28513
TEL: (252) 531-2711

Ministries Activity
Center Addition
Mount Pisgah Harnett
Original Free Will
Baptist Church


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Erwin, NC.

PROJECT CONSULTANTS



STRUCTURAL

NEVILLE ENGINEERING
AUGUSTUS NEVILLE, PE
100-B CULBRETH RD.
CHAPEL HILL, NC 27516
TEL: (819) 740-3427

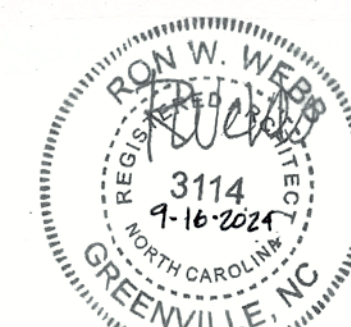

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Revisions


Mark	Date	Description

FRAMING PLAN

OVERALL
FLOOR
PLAN

A-4

ROOM FINISH SCHEDULE							
No.	NAME	FLOOR	BASE	WALLS	CEILING	HT.	REMARKS
001	ENTRY PORCH	EXPOSED CONC.	N/A	N/A	VENTED VINYL	11'-0"	BROOM FINISH CONC.
101	LOBBY	VCT	4" RUBBER	PAINTED GWB	2x2 AC. TILE	10'-0"	
102	MULTI PURPOSE	VCT	4" RUBBER	PAINTED GWB	2x2 AC. TILE	SLOPED	
103	SECURITY	CARPET	4" RUBBER	PAINTED GWB	2x2 AC. TILE	10'-0"	
104	MULTI MEDIA	CARPET	4" RUBBER	PAINTED GWB	2x2 AC. TILE	10'-0"	
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106	JAN. / STORAGE	VCT	4" RUBBER	PAINTED GWB	2x2 AC. TILE	10'-0"	
107	KITCHEN	VCT	4" RUBBER	PAINTED GWB	2x2 AC. TILE	10'-0"	FRP PANELS 6'-0" HIGH, EPOXY PAINT ABOVE
108	PANTRY	VCT	4" RUBBER	PAINTED GWB	2x2 AC. TILE	10'-0"	
109	ELECTRIC	EXPOSED CONC.	4" RUBBER	PAINTED GWB	PAINTED GWB	16'-0"	
110	FAMILY TOILET	VCT	4" RUBBER	PAINT & TILE	2x2 AC. TILE	10'-0"	TILE TO 7'-0" HIGH, EPOXY PAINT ABOVE
111	CLASSROOM	CARPET	4" RUBBER	PAINTED GWB	2x2 AC. TILE	10'-0"	
112	CLASSROOM	CARPET	4" RUBBER	PAINTED GWB	2x2 AC. TILE	10'-0"	
113	CLASSROOM	CARPET	4" RUBBER	PAINTED GWB	2x2 AC. TILE	10'-0"	
114	REAR LOBBY	VCT	4" RUBBER	PAINTED GWB	2x2 AC. TILE	10'-0"	
115	REAR CORRIDOR	VCT	4" RUBBER	PAINTED GWB	2x2 AC. TILE	10'-0"	
116	WOMEN	CERAMIC TILE	CERAMIC TILE	PAINT & TILE	2x2 AC. TILE	10'-0"	TILE TO 7'-0" HIGH, EPOXY PAINT ABOVE
117	MEN	CERAMIC TILE	CERAMIC TILE	PAINT & TILE	2x2 AC. TILE	10'-0"	TILE TO 7'-0" HIGH, EPOXY PAINT ABOVE
118	CLASSROOM	CARPET	4" RUBBER	PAINTED GWB	2x2 AC. TILE	10'-0"	
119	CLASSROOM	CARPET	4" RUBBER	PAINTED GWB	2x2 AC. TILE	10'-0"	
120	MAIN CORRIDOR	VCT	4" RUBBER	PAINTED GWB	2x2 AC. TILE	10'-0"	

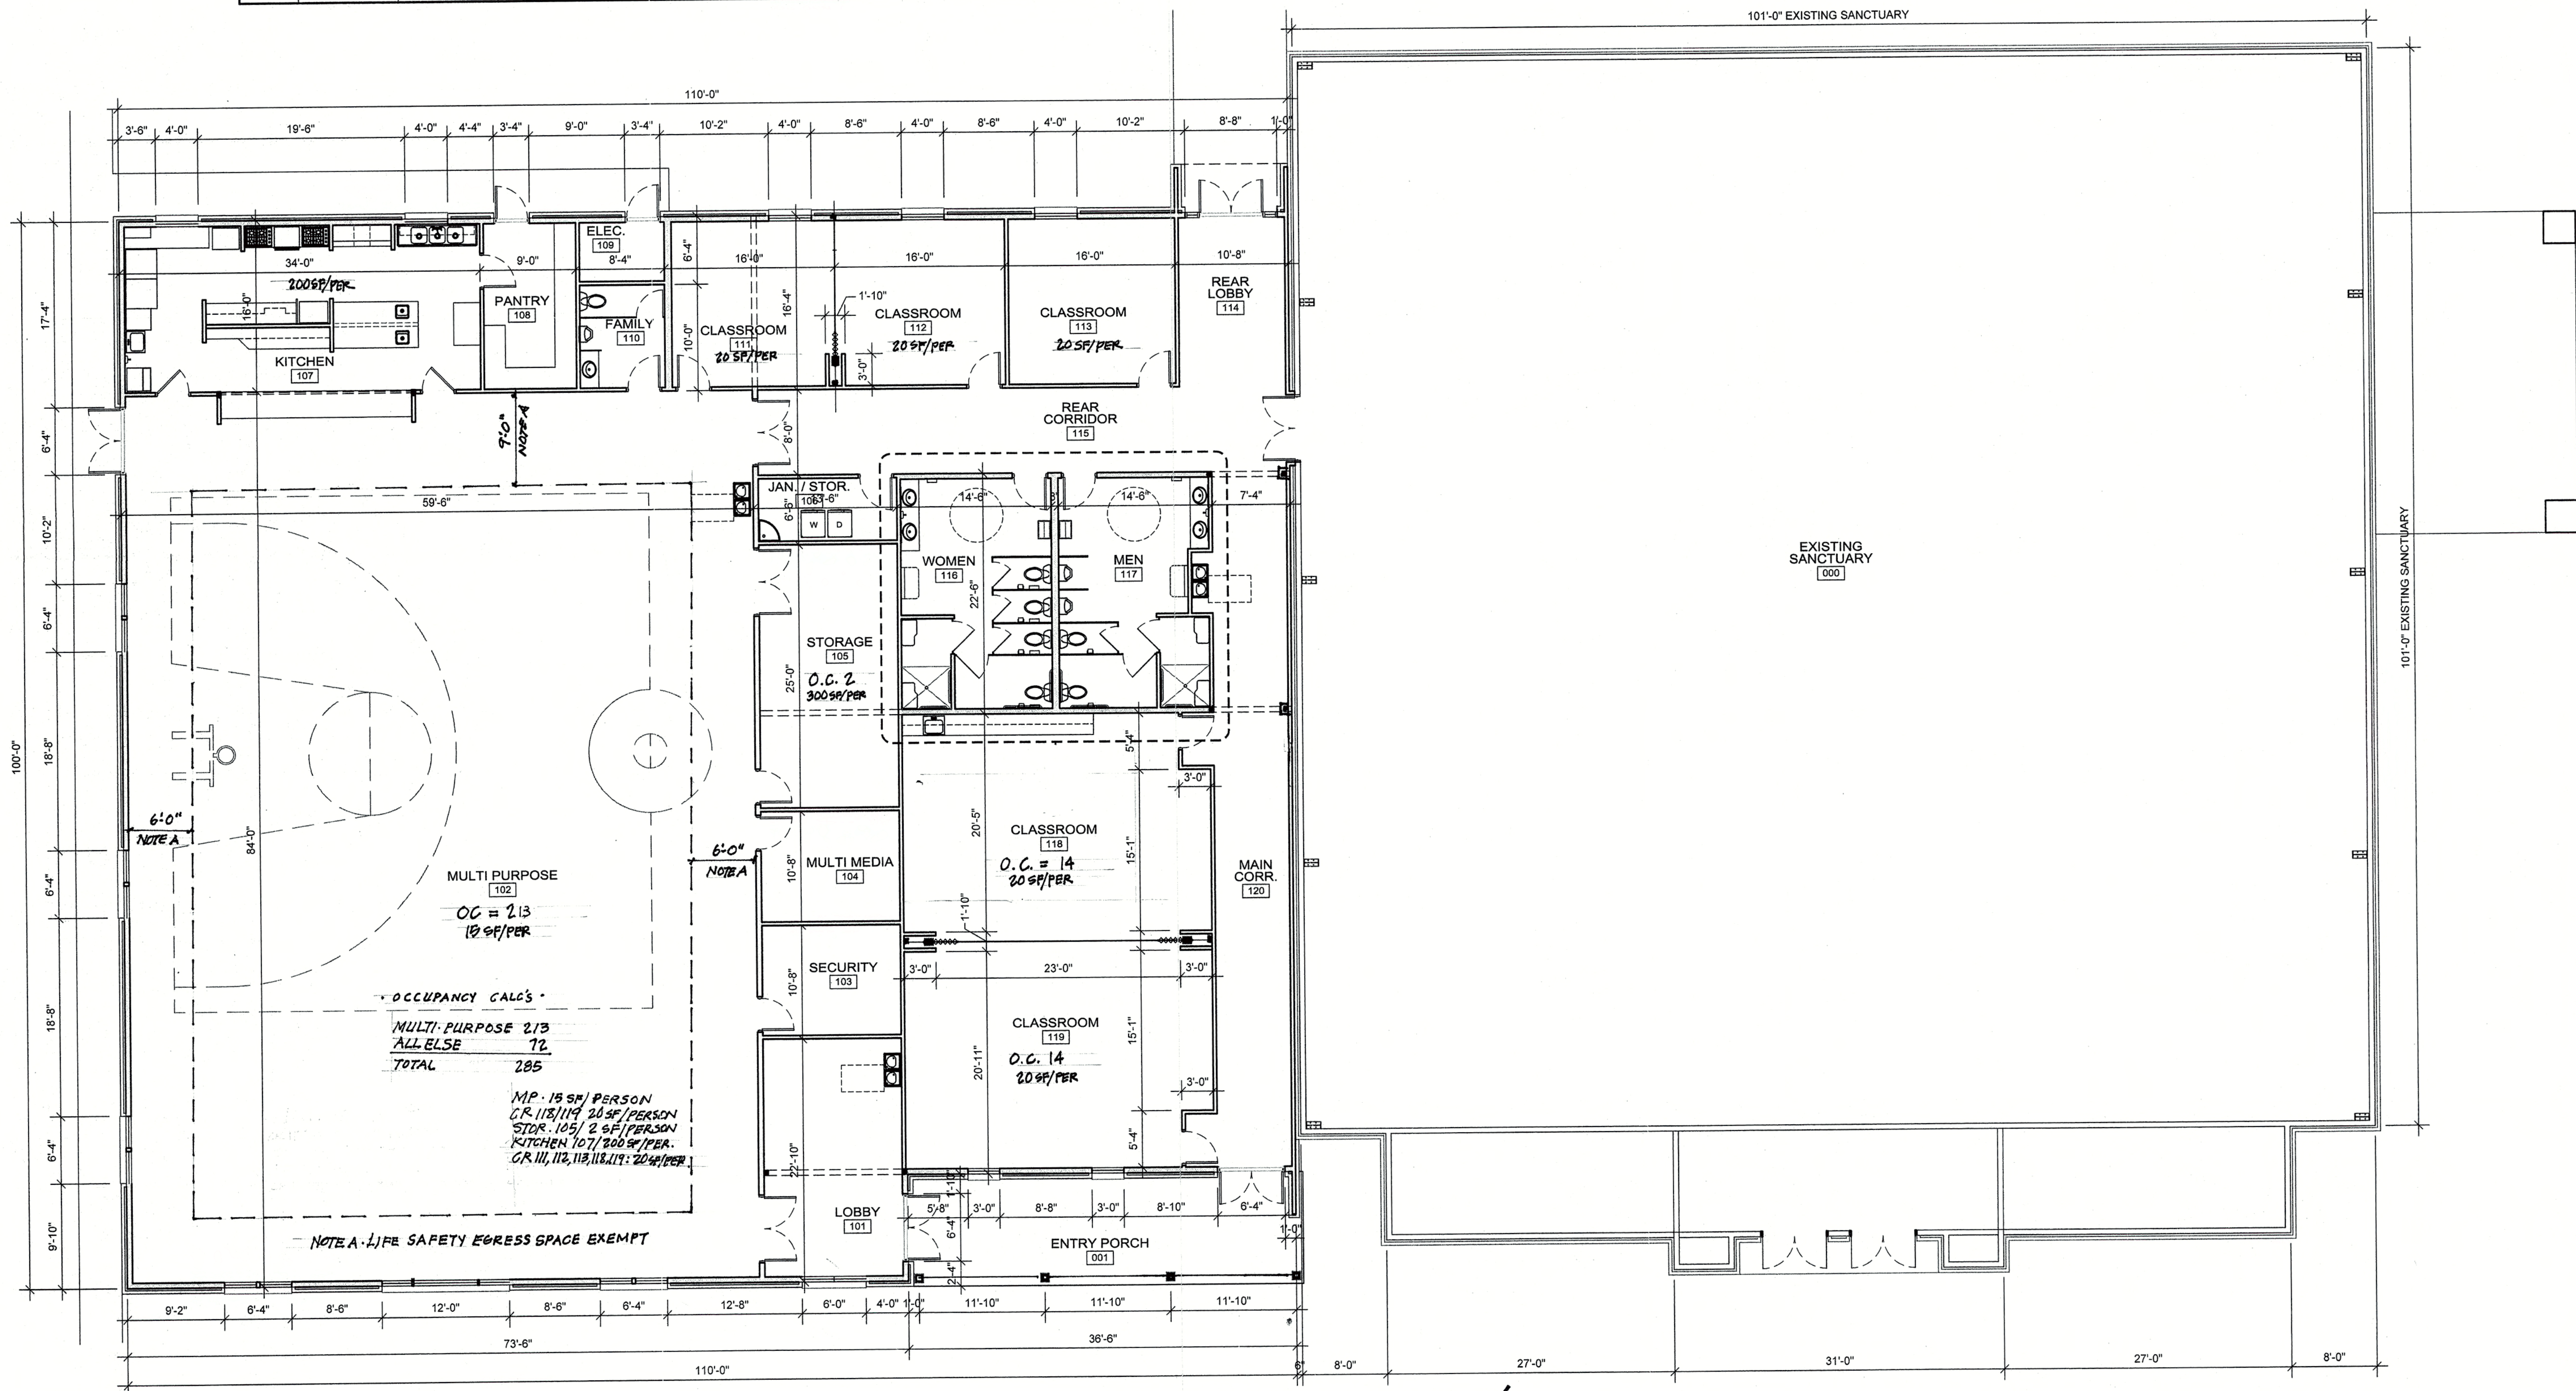

'OCCUPANT CONTENT'
OVERALL FLOOR PLAN

SCALE: 1/8" = 1'-0"

ARCHITECT

RON W. WEBB
1659 W. HANRAHAN ROAD
AYDEN, NC. 28513
TEL: (252) 531-2711

**Ministries Activity
Center Addition
Mount Pisgah Harnett
Original Free Will
Baptist Church**

145 Prospect Church Road
Erwin, NC.

PROJECT CONSULTANTS



STRUCTURAL

NEVILLE ENGINEERING

AUGUSTUS NEVILLE, PE
100-B CULBRETH RD.
CHAPEL HILL, NC 27516
TEL: (919) 740-3427



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Plot Date:

Revisions

Mark	Date	Description



Drawing No.
'OCCUPANT CONTENT'
OVERALL
FLOOR
PLAN **A-5**



REAR ELEVATION

SCALE: 1/8" = 1'-0"

2 12

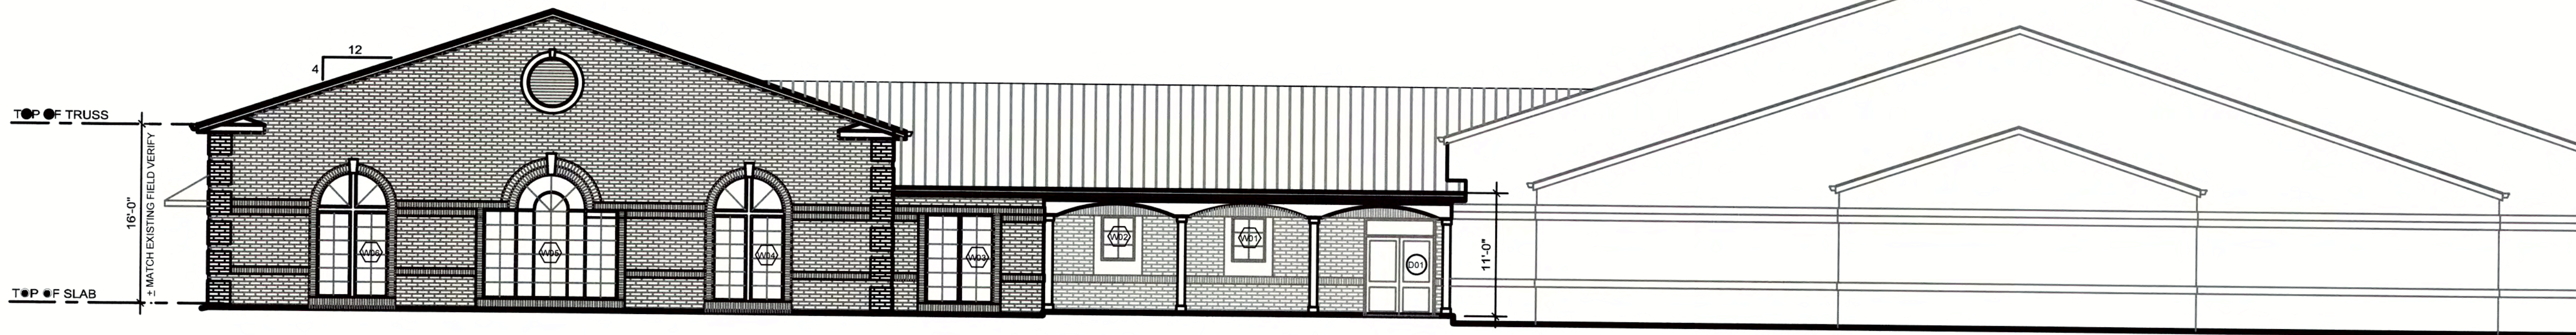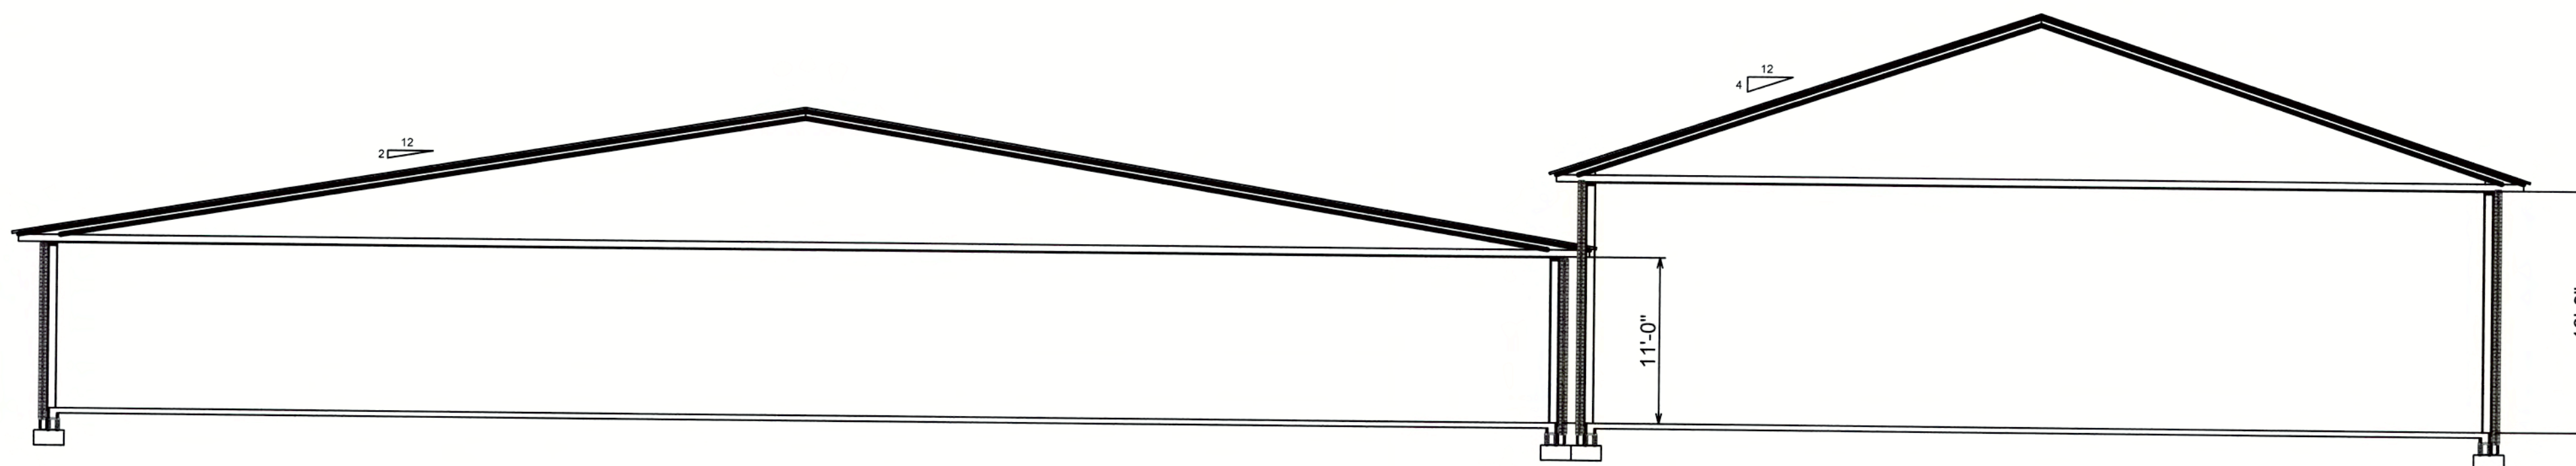

FRONT ELEVATION

SCALE: 1/8" = 1'-0"

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09/08/2023

ARCHITECT

RON W. WEBB
1659 W. HANRAHAN ROAD
AYDEN, NC. 28513
TEL: (252) 531-2711

Ministries Activity
Center Addition
Mount Pisgah Harnett
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Baptist Church

145 Prospect Church Road
Erwin, NC.

PROJECT CONSULTANTS

CONSULTING ENGINEERS
555 FAYETTEVILLE STREET | SUITE 201
RALEIGH, NC 27601 | 919-719-3475
WWW.KPGNC.COM | NC FIRM # 0-3824

STRUCTURAL

NEVILLE ENGINEERING

AUGUSTUS NEVILLE, PE
100-B CULBRETH RD.
CHAPEL HILL, NC 27516
TEL: (919) 740-3427



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Plot Date:

Revisions

Mark	Date	Description

Drawing No.

ELEVATIONS

A6

of


ARCHITECT

RON W. WEBB
1659 W. HANRAHAN ROAD
AYDEN, NC. 28513
TEL: (252) 531-2711

Ministries Activity
Center Addition
Mount Pisgah Harnett
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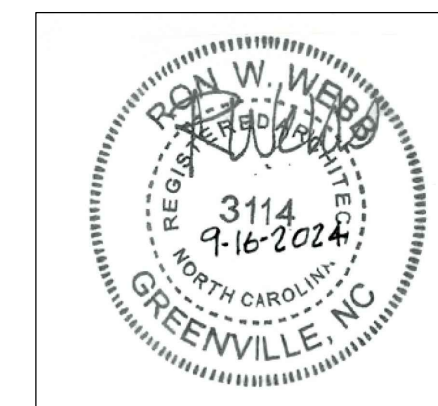
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AUGUSTUS NEVILLE, PE
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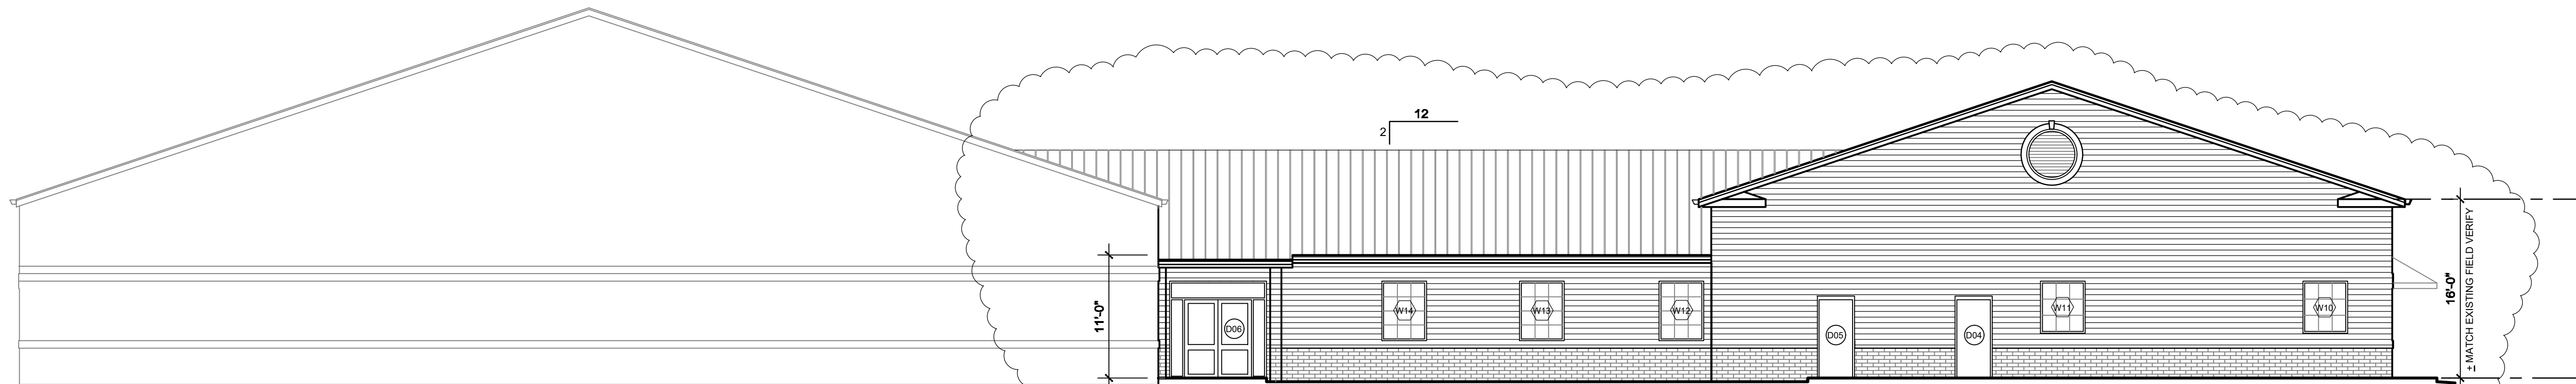
Revisions

Mark	Date	Description
A	10-28-24	Revised window types, changed brick veneer to hardie plank siding on rear elevation and removed mid rails from storefront doors

ELEVATIONS

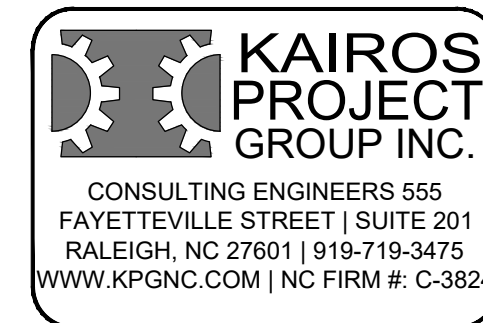Drawing No.

A6
of




REAR ELEVATION

SCALE: 1/8" = 1'-0"

MARK	SIZE	ELEV.	TYPE	MAT'L	HEIGHT	REMARKS
D01	6'-0" x 7'-0"	SF2	DOUBLE DOOR	ALUM.	@ 8'-0"	STOREFRONT DOOR, 1" TINTED INSUL. GLASS WITH TRANSOM
D02	6'-0" x 7'-0"	SF2	DOUBLE DOOR	ALUM.	@ 8'-0"	STOREFRONT DOOR, 1" TINTED INSUL. GLASS WITH TRANSOM
D03	6'-0" x 7'-0"	SF2	DOUBLE DOOR	ALUM.	@ 8'-0"	STOREFRONT DOOR, 1" TINTED INSUL. GLASS WITH TRANSOM
D04	3'-0" x 7'-0"	D1	SINGLE DOOR	H.M.	@ 7'-4"	
D05	3'-0" x 7'-0"	D1	SINGLE DOOR	H.M.	@ 7'-4"	
D06	6'-0" x 7'-0"	SF1	DOUBLE DOOR	ALUM.	@ 8'-0"	STOREFRONT DOOR, 1" TINTED INSUL. GLASS WITH TRANSOM AND SIDE LITES

MARK	SIZE	ELEV.	TYPE	MAT'L	HEIGHT	REMARKS
W01	3'-0" x 4'-0"	W-C	FIXED	ALUM.	@ 8'-0"	STOREFRONT WINDOW, 1" TINTED INSUL. GLASS
W02	3'-0" x 4'-0"	W-C	FIXED	ALUM.	@ 8'-0"	STOREFRONT WINDOW, 1" TINTED INSUL. GLASS
W03	6'-0" x 8'-0"	W-D	FIXED	ALUM.	@ 9'-0"	STOREFRONT WINDOW, 1" TINTED INSUL. GLASS
W04	6'-4" x 11'-0"	W-E	FIXED	ALUM.	@ 11'-10"	STOREFRONT WINDOW, 1" TINTED INSUL. GLASS
W05	12'-0" x 11'-0"	W-F	FIXED	ALUM.	@ 12'-2"	STOREFRONT WINDOW, 1" TINTED INSUL. GLASS
W06	6'-4" x 11'-0"	W-E	FIXED	ALUM.	@ 11'-10"	STOREFRONT WINDOW, 1" TINTED INSUL. GLASS
W07	6'-4" x 11'-0"	W-E	FIXED	ALUM.	@ 11'-10"	STOREFRONT WINDOW, 1" TINTED INSUL. GLASS
W08	6'-4" x 11'-0"	W-E	FIXED	ALUM.	@ 11'-10"	STOREFRONT WINDOW, 1" TINTED INSUL. GLASS
W09	6'-4" x 11'-0"	W-E	FIXED	ALUM.	@ 11'-10"	STOREFRONT WINDOW, 1" TINTED INSUL. GLASS
W10	4'-0" x 4'-0"	W-B	FIXED	ALUM.	@ 8'-0"	STOREFRONT WINDOW, 1" TINTED INSUL. GLASS
W11	4'-0" x 4'-0"	W-B	FIXED	ALUM.	@ 8'-0"	STOREFRONT WINDOW, 1" TINTED INSUL. GLASS
W12	4'-0" x 4'-0"	W-A	FIXED	ALUM.	@ 8'-0"	STOREFRONT WINDOW, 1" TINTED INSUL. GLASS
W13	4'-0" x 4'-0"	W-A	FIXED	ALUM.	@ 8'-0"	STOREFRONT WINDOW, 1" TINTED INSUL. GLASS
W14	4'-0" x 4'-0"	W-A	FIXED	ALUM.	@ 8'-0"	STOREFRONT WINDOW, 1" TINTED INSUL. GLASS

WINDOW AND DOOR ELEVATIONS

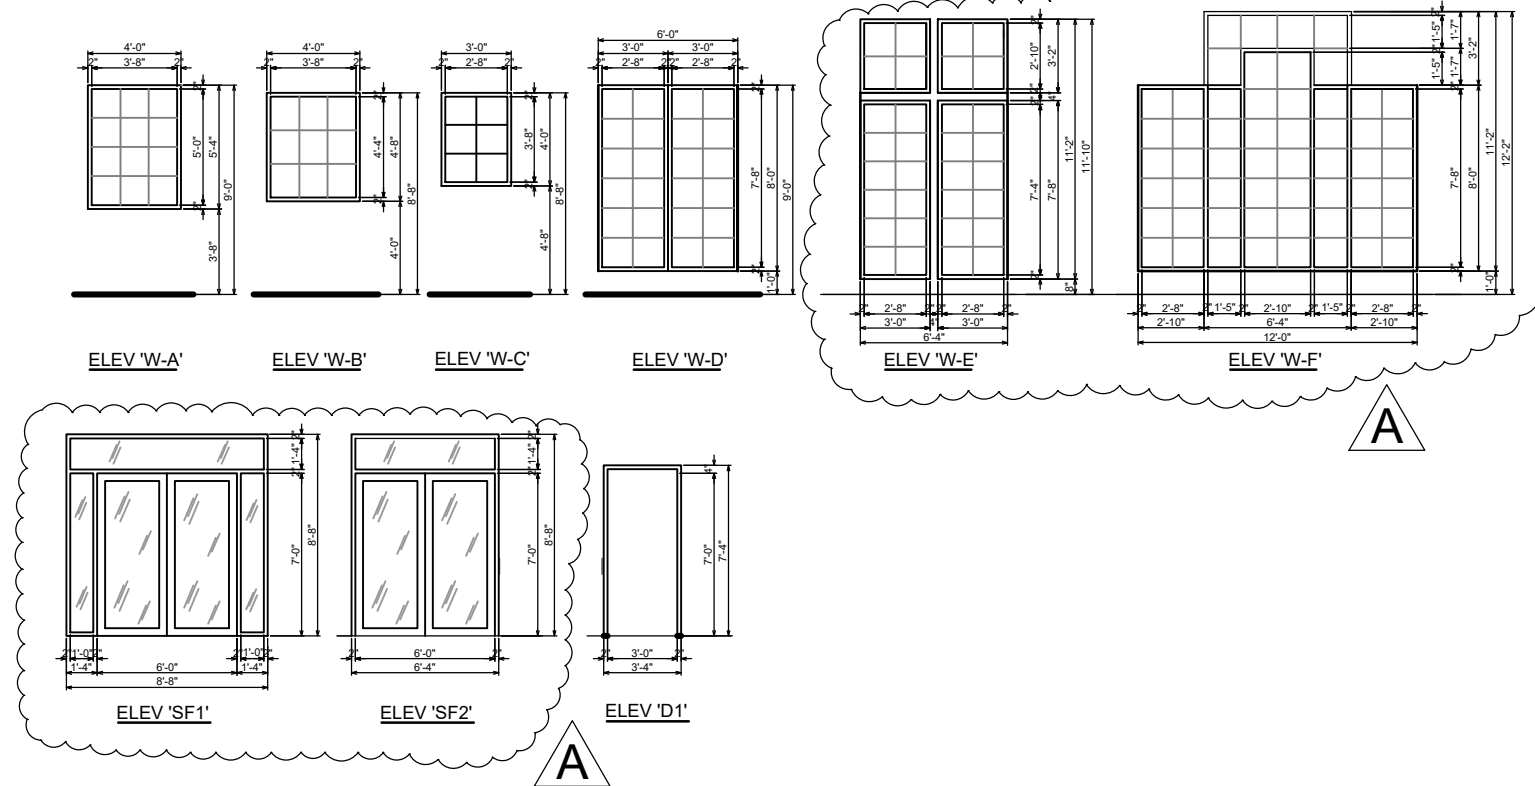


LEFT SIDE ELEVATION

SCALE: 1/8" = 1'-0"




FRONT ELEVATION

SCALE: 1/8" = 1'-0"

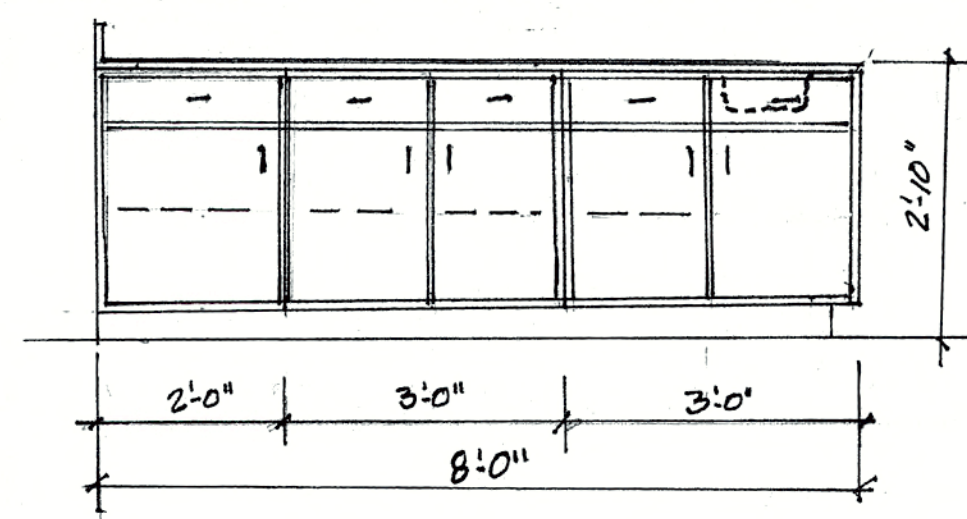

'F' CABINET AT PREP COUNTER

Scale: 1/2" = 1'-0" NOTE: 'H' CABINET IS OPPOSITE

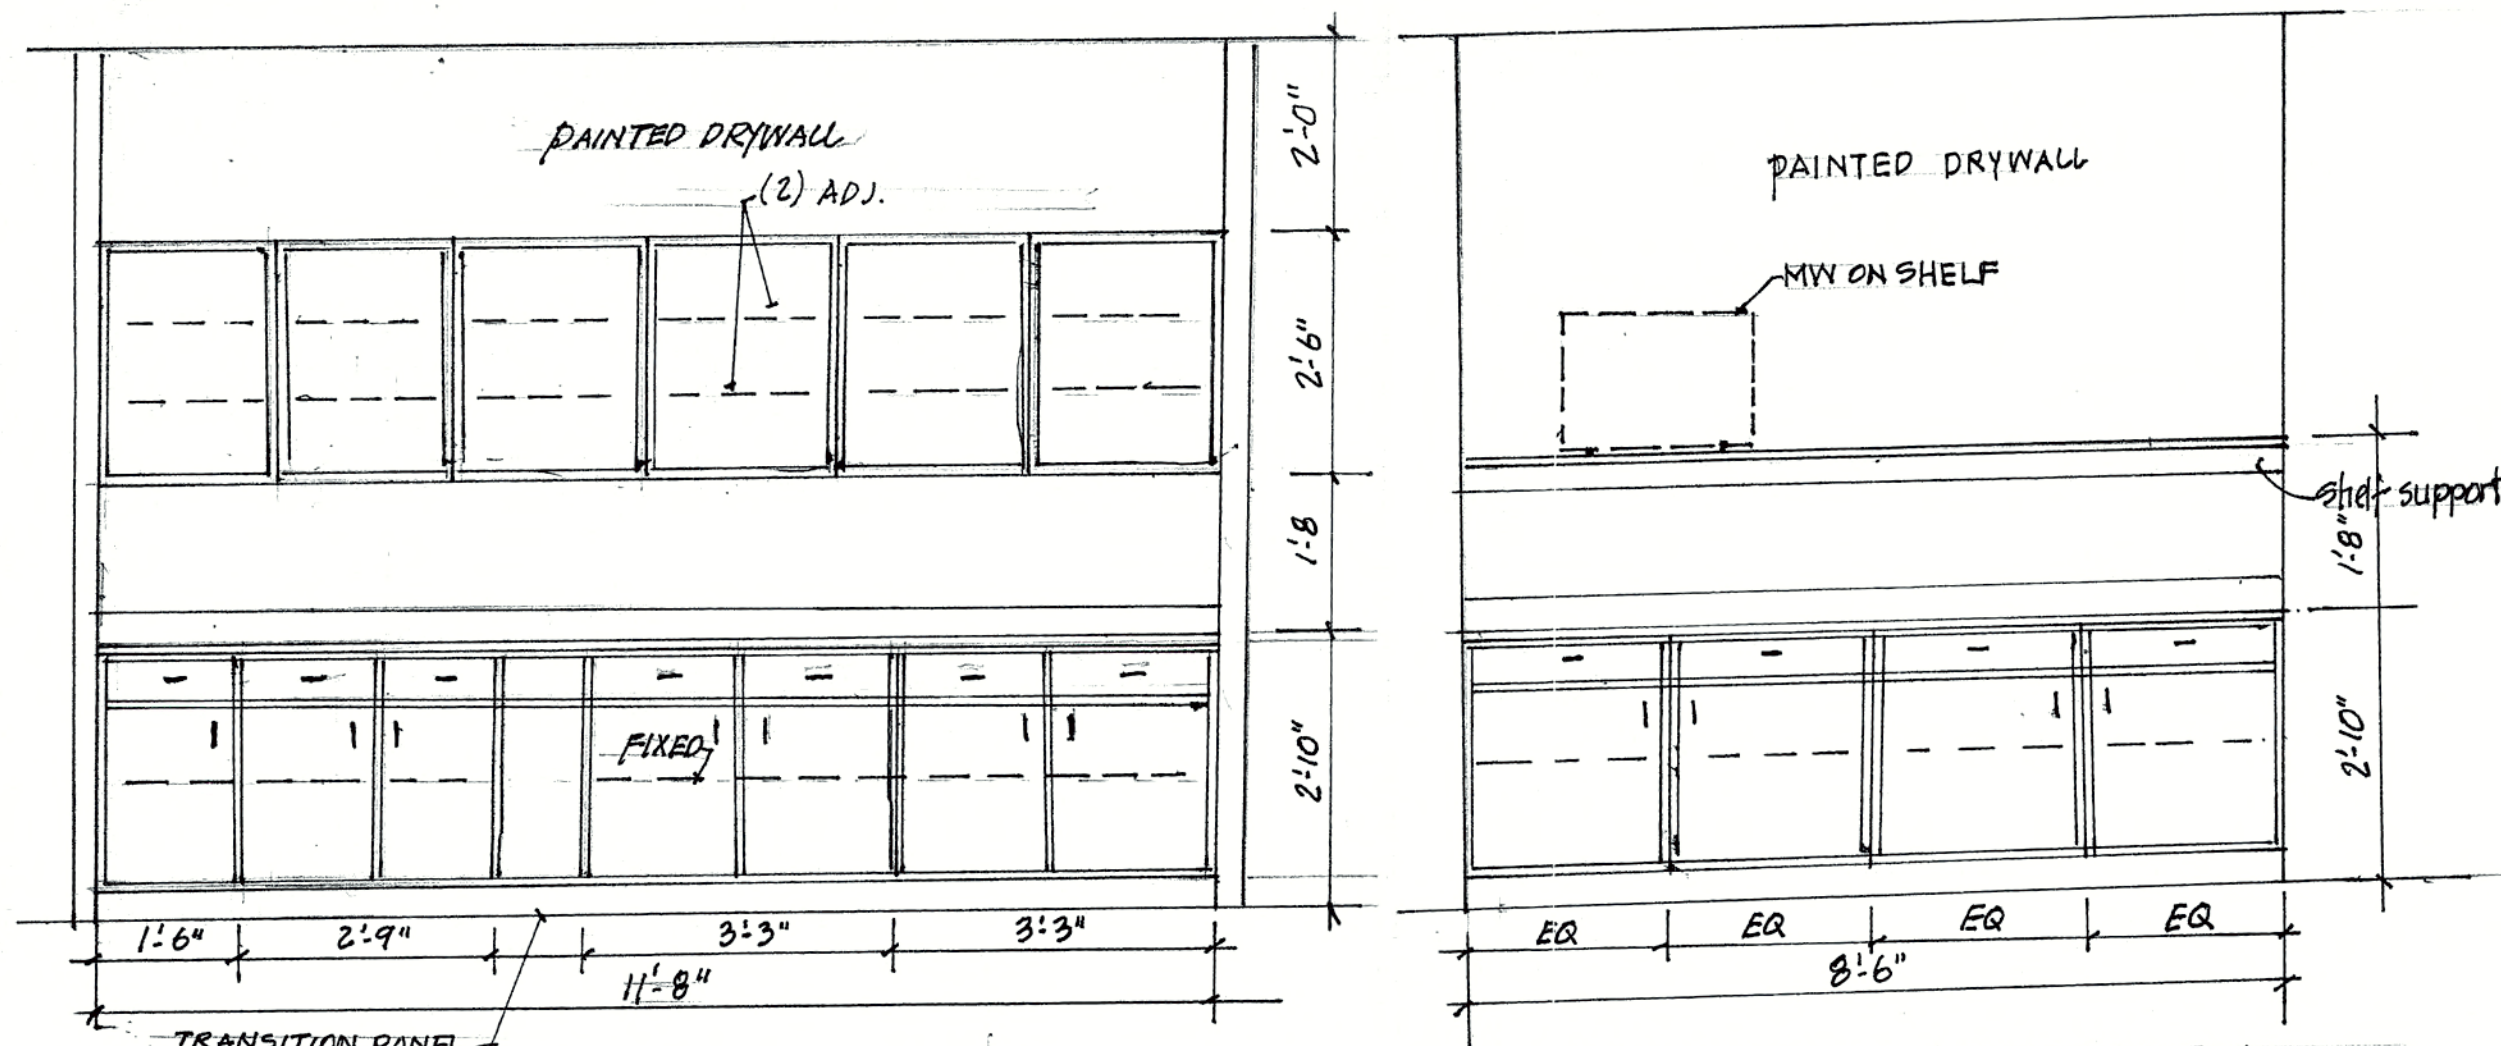


'E' CABINET AT KITCHEN

Scale: 1/2" = 1'-0"

'D' CABINET AT KITCHEN

Scale: 1/2" = 1'-0"

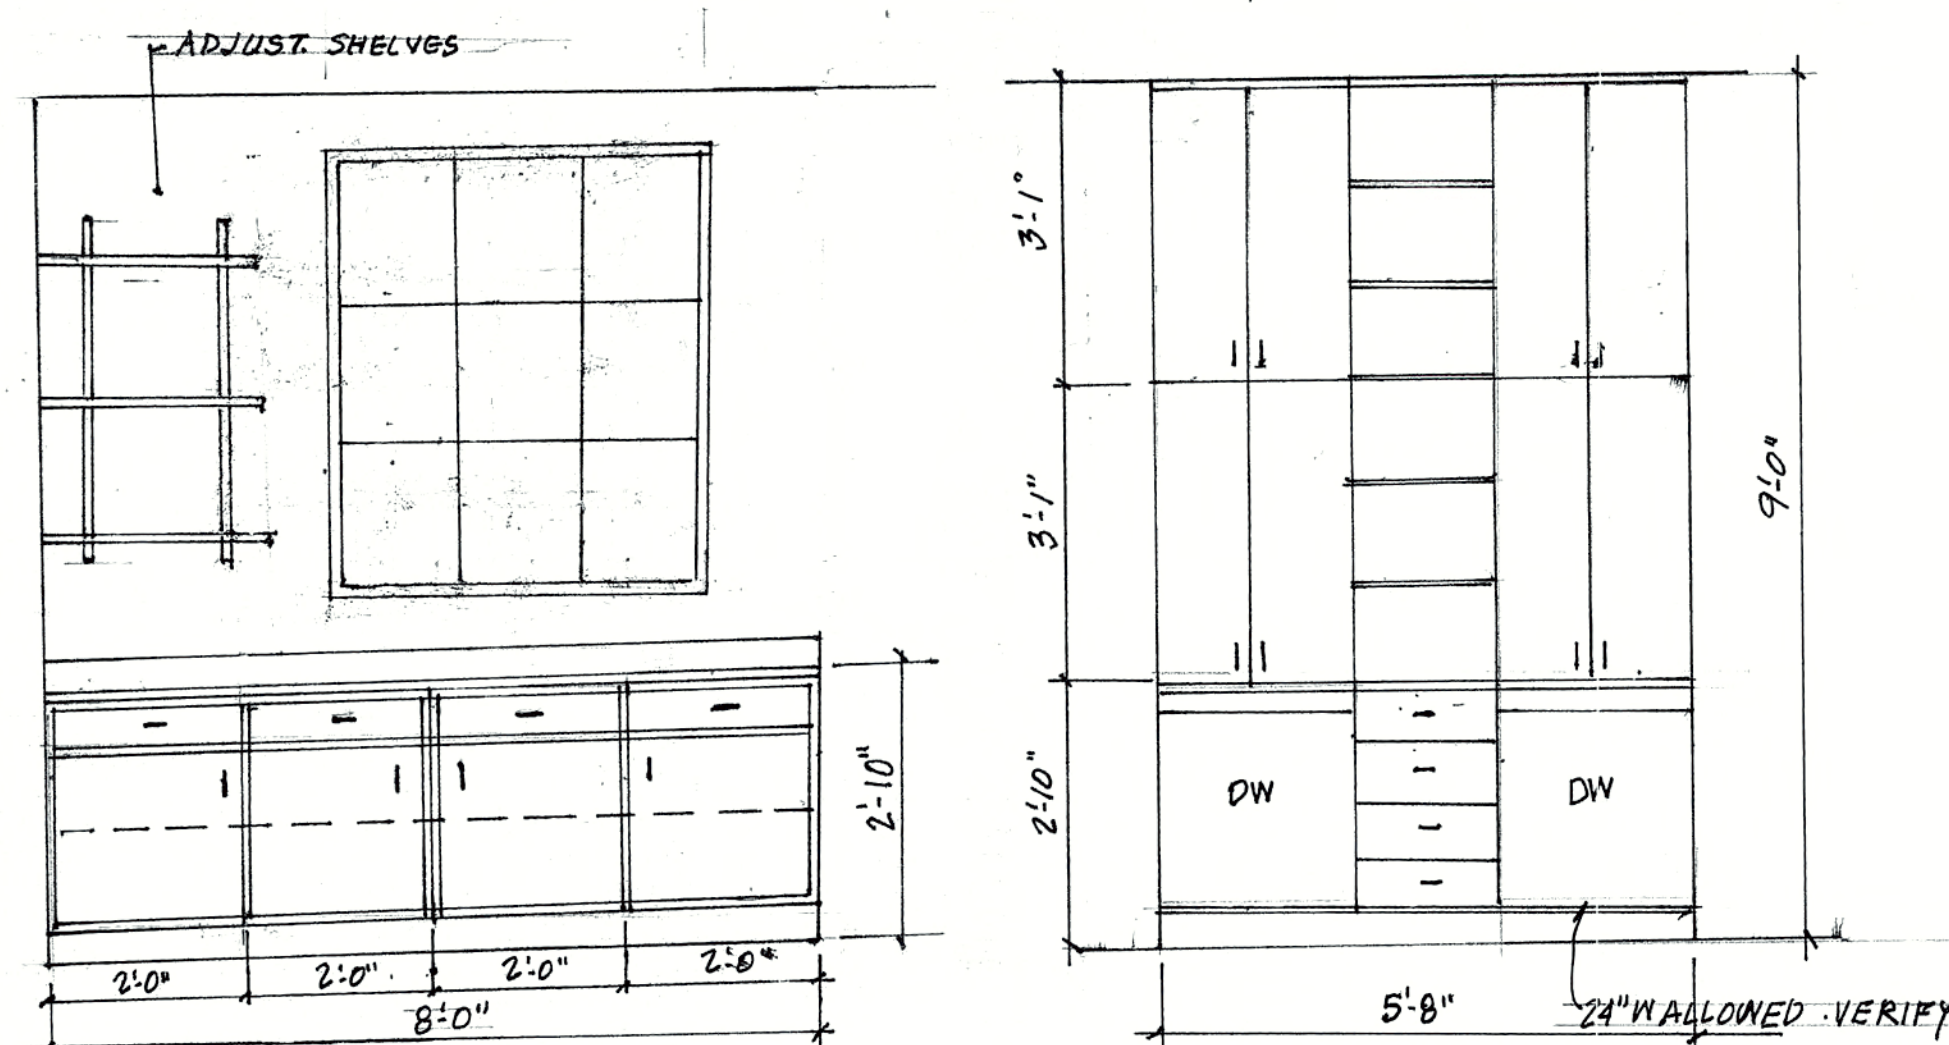


'B' CABINET

Scale: 1/2" = 1'-0"

'C' CABINET AT DISH WASHERS

Scale: 1/2" = 1'-0"

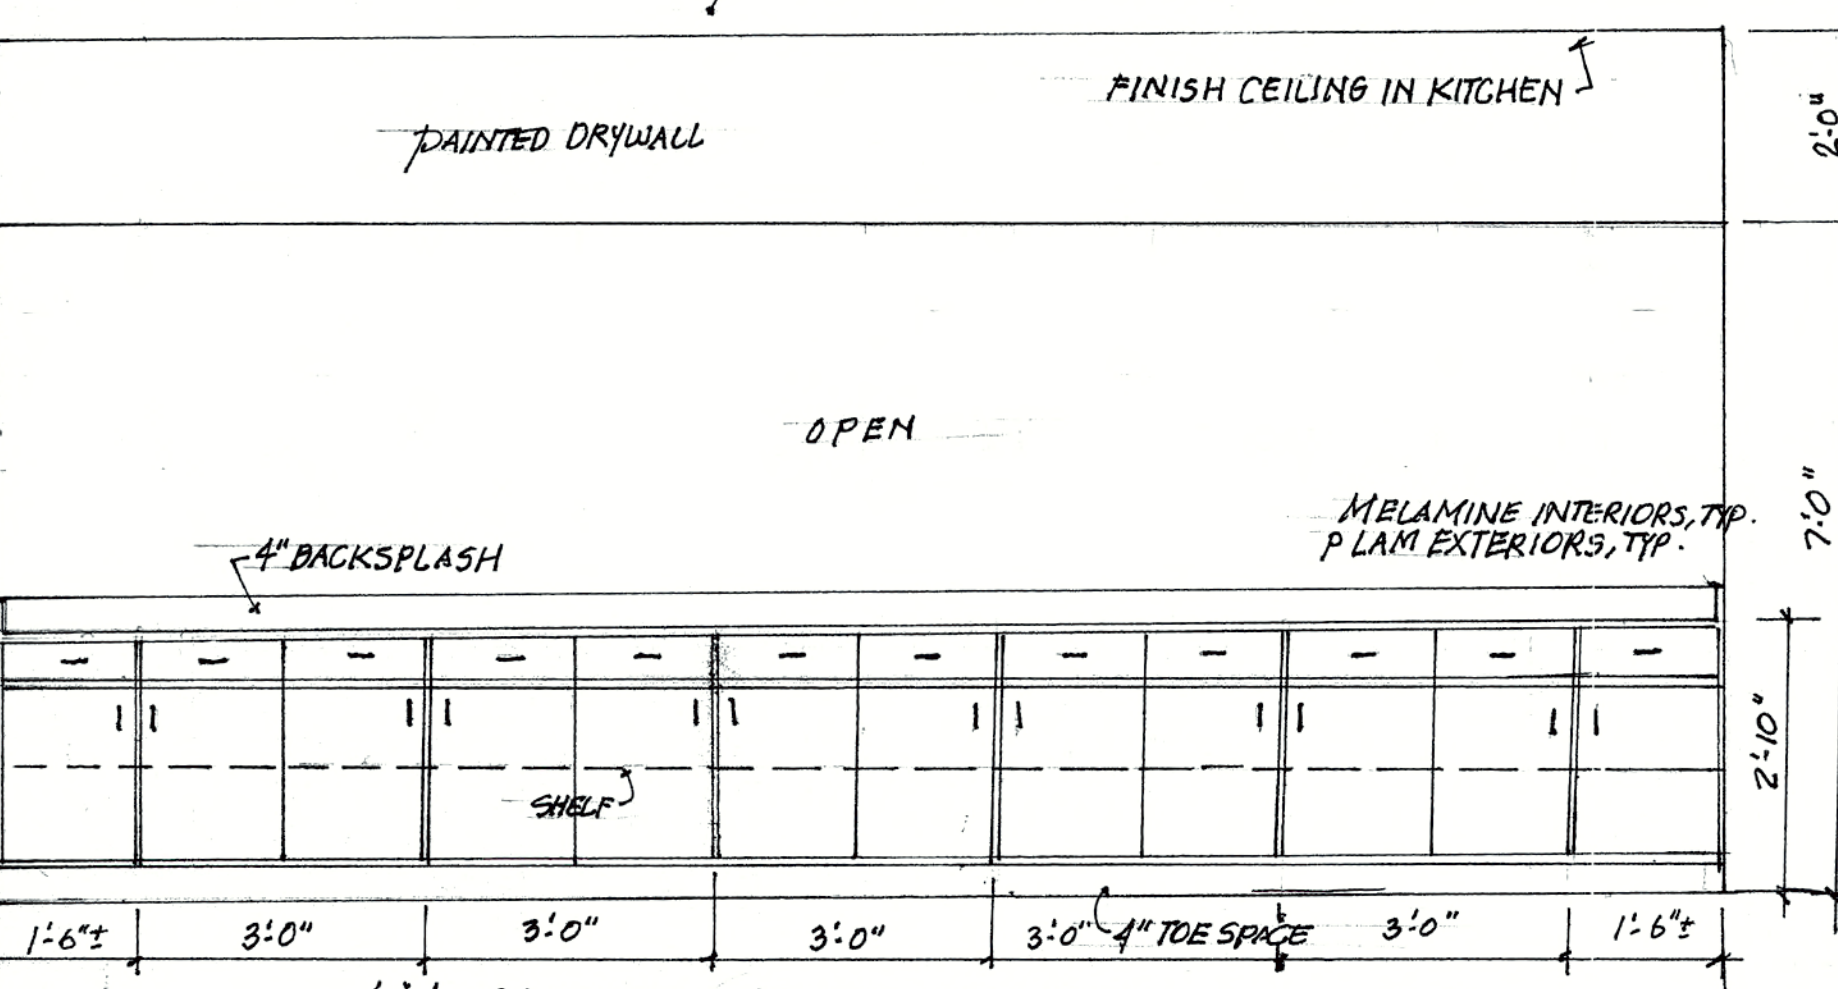


'A' CABINETS AT PASS WINDOW

Scale: 1/2" = 1'-0"

KITCHEN EQUIPMENT SCHEDULE			
MARK	DESCRIPTION	MANUFACTURER	REMARKS
1	ICE MAKER	AVANTCO ICE; UC-F-160A;	REFER TO PLUMBING DRAWINGS
2	SOAP DISPENSER	BOBRICK; MODEL 82216	BY GENERAL CONTRACTOR; 44" MAX. TO OUTLET
3	HAND SINK	AMERICAN STANDARD; MODEL 0355 012 020	REFER TO PLUMBING DRAWINGS
4	FREEZER	SAMSUNG MODEL RZ11M70745A	BY GENERAL CONTRACTOR
5	REFRIGERATOR	FRIGIDAIRE SIDE BY SIDE; 22.3 CF.; S.S.	BY GENERAL CONTRACTOR
6	REFRIGERATOR	FRIGIDAIRE SIDE BY SIDE; 22.3 CF.; S.S.	BY GENERAL CONTRACTOR
7	FOOD WARMER	EXISTING BY OWNER	N.I.C. APPROX. SIZE 24" x 30"
8	RANGE	KUCHT; 4 BURNER; MODEL KNG 301/LP-G	BY GENERAL CONTRACTOR
9	DOUBLE OVEN	SAMSUNG; NV51 T 5511D	BY GENERAL CONTRACTOR
10	RANGE	KUCHT; 4 BURNER; MODEL KNG 301/LP-G	BY GENERAL CONTRACTOR
11	MICROWAVE ON SHELF	LG; LMC 1575 21; 1250 WATT	BY GENERAL CONTRACTOR
12	FRYER	EXISTING BY OWNER	N.I.C. APPROX. SIZE 24" x 32"
13	PREP SINK	ELKAY DAYTON; D11515	REFER TO PLUMBING DRAWINGS
14	PREP SINK	ELKAY DAYTON; D11515	REFER TO PLUMBING DRAWINGS
15	30" x 48" ROLLING COFFEE SERVICE	STILTON; 18 GA. S.S.; ON CASTERS	BY GENERAL CONTRACTOR
16	3 COMPARTMENT SINK	ADVANCE TABCO; FC-3-1818 18RL	BY GENERAL CONTRACTOR
17	RANGE HOOD	COSMO; 30" DUCTED; S.S.; UNDER CABINET	BY GENERAL CONTRACTOR
18	FAUCET EXTENSION	DELTA; 18803-DST; ANTONI 1.8 GEM	BY GENERAL CONTRACTOR
19	DISHWASHER	T.B.D.	BY GENERAL CONTRACTOR
20	DISHWASHER	T.B.D.	BY GENERAL CONTRACTOR

NOTE: 1. REFER TO PME DRAWINGS FOR ALL CONNECTIONS AND PIPE SIZING ETC.
2. ALL MANUFACTURERES AND MODEL NUMBERS ARE AS PROVIDED BY OWNERS

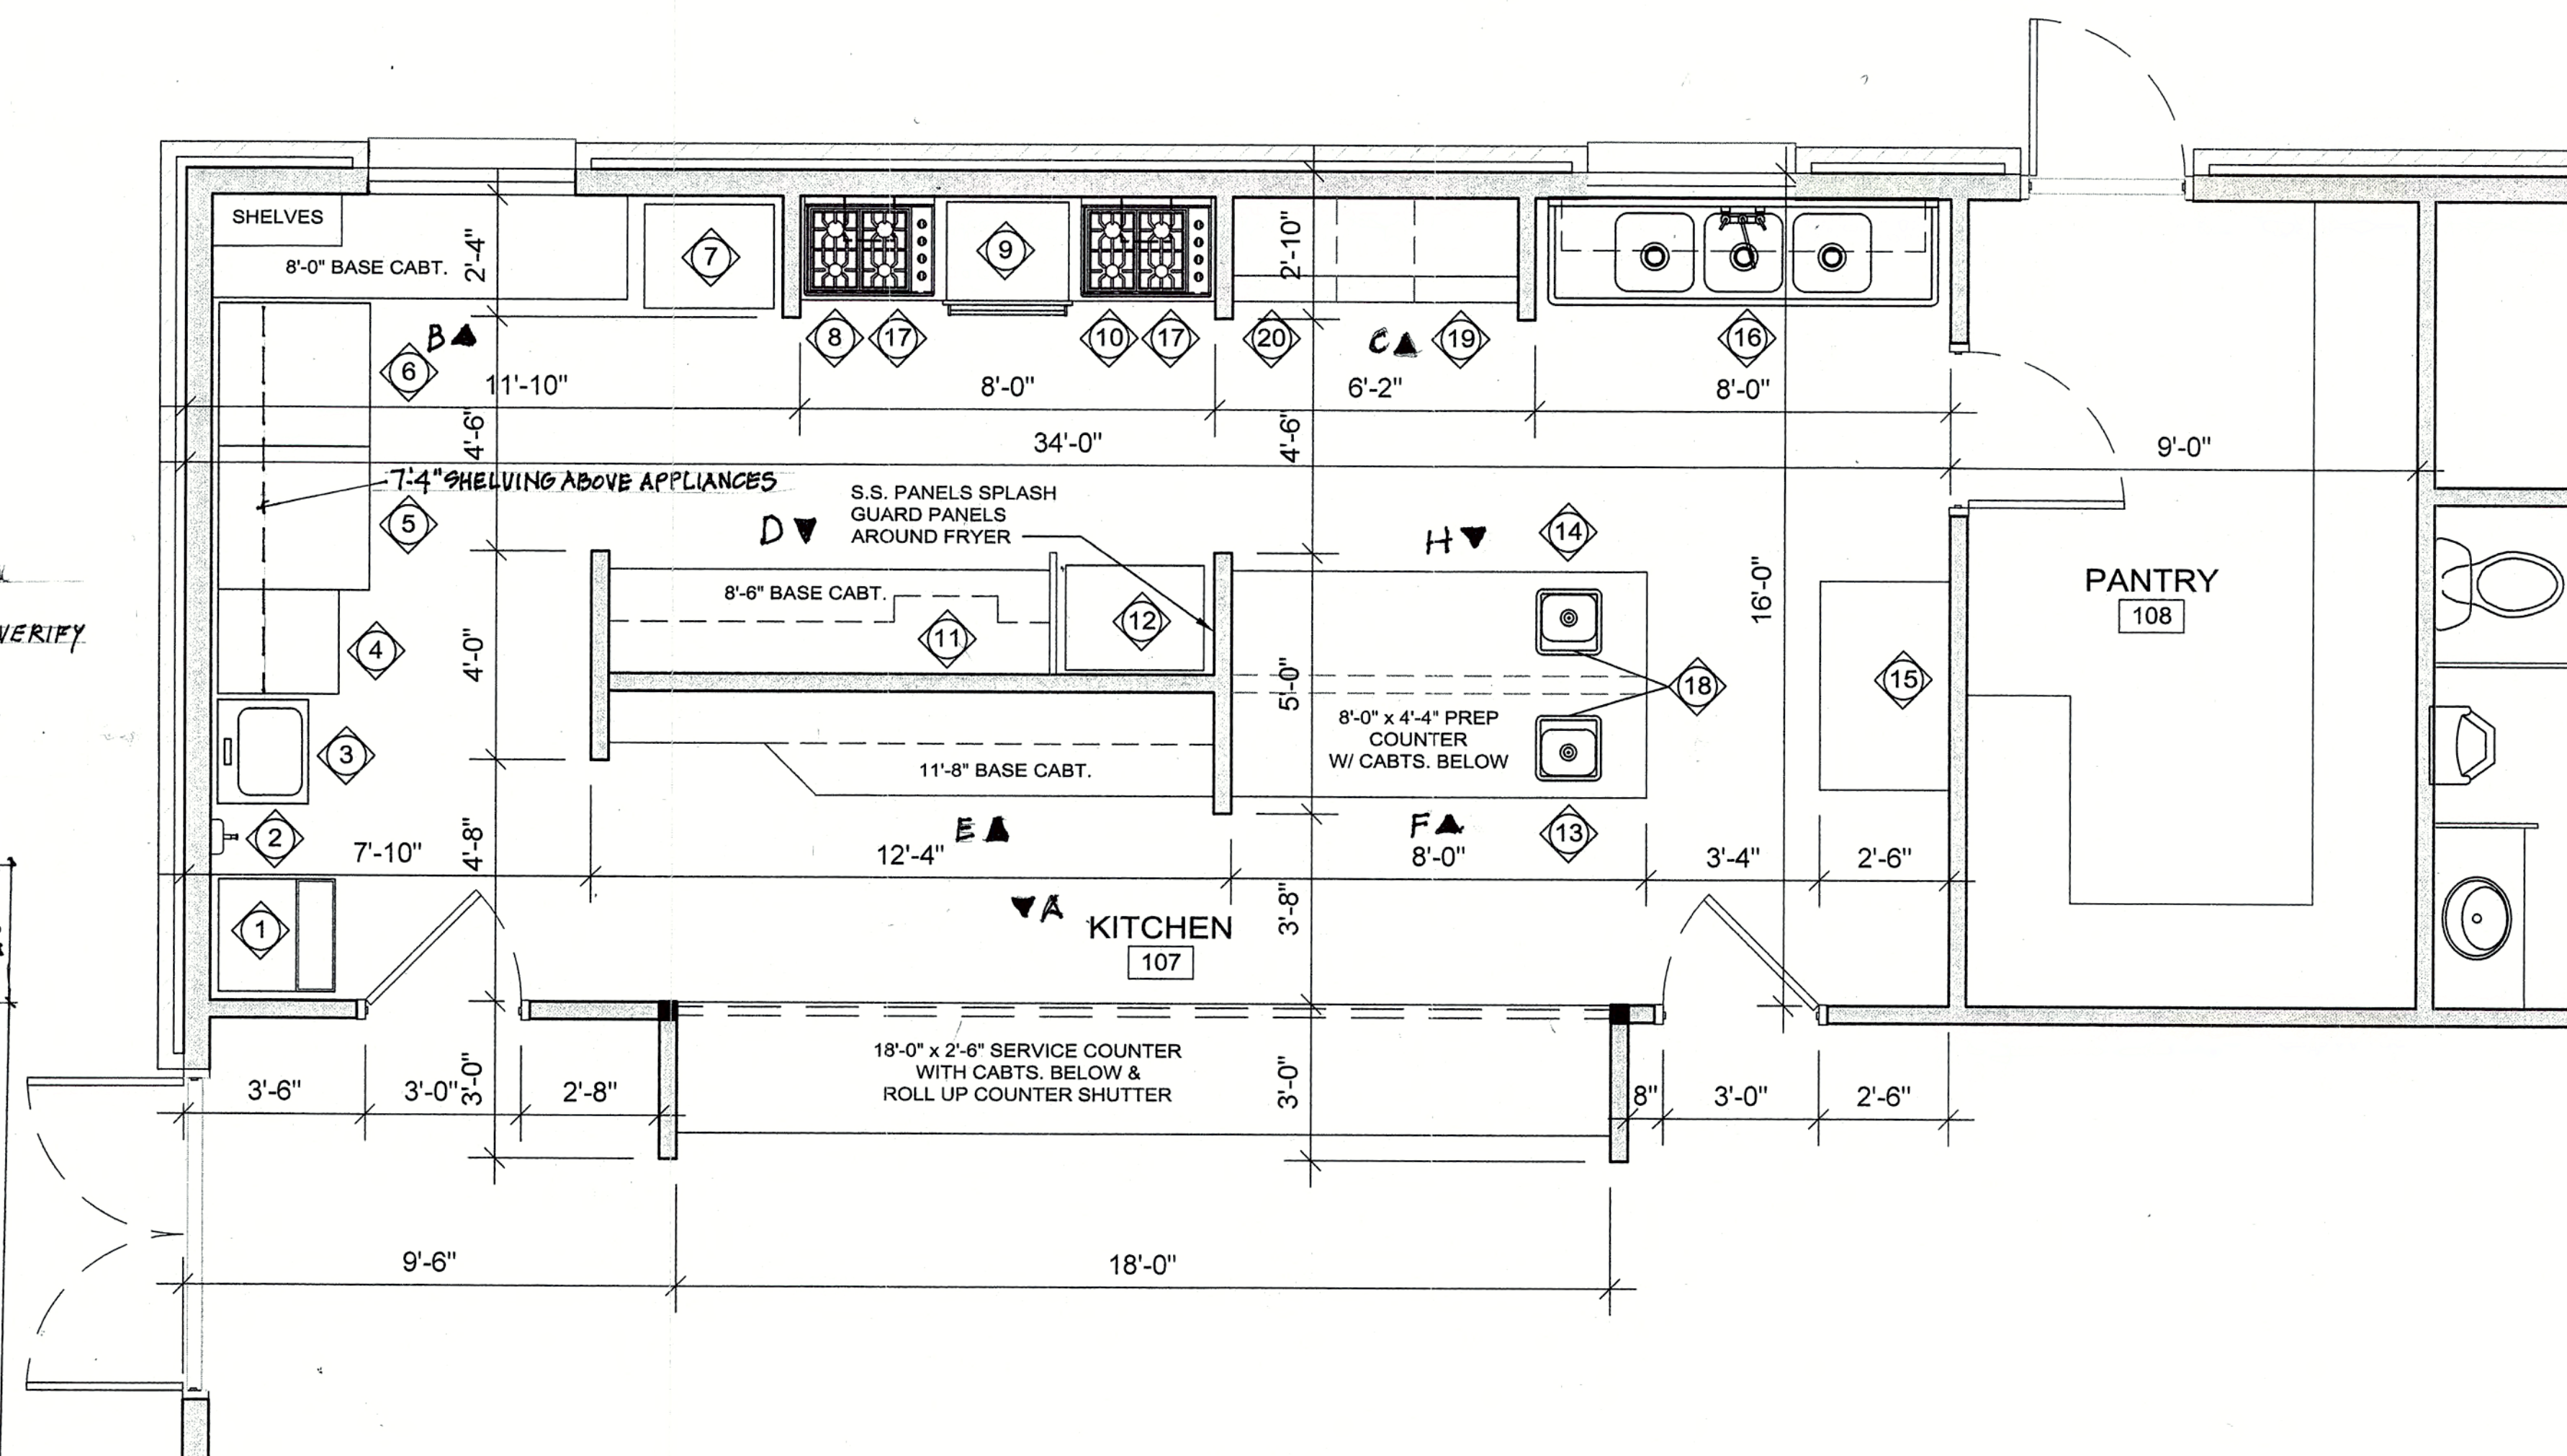

ENLARGED KITCHEN PLAN

Scale: 3/8" = 1'-0"


ARCHITECT

RON W. WEBB
1659 W. HANRAHAN ROAD
AYDEN, NC. 28513
TEL: (252) 531-2711

**Ministries Activity
Center Addition
Mount Pisgah Harnett
Original Free Will
Baptist Church**

145 Prospect Church Road
Erwin, NC.

PROJECT CONSULTANTS

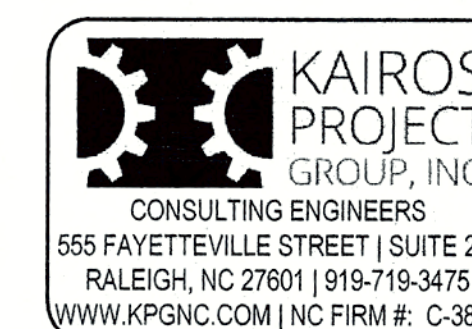

STRUCTURAL

NEVILLE ENGINEERING
AUGUSTUS NEVILLE, PE
100-B CULBRETH RD.
CHAPEL HILL, NC 27516
TEL: (919) 740-3427



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Issue Date: 09/20/2023

Plot Date:

Revisions

Mark	Date	Description

Drawing No.

ENLARGED
KITCHEN PLAN

A-7

of

ARCHITECT

RON W. WEBB
1659 W. HANRAHAN ROAD
AYDEN, NC. 28513
TEL: (252) 531-2711

Ministries Activity
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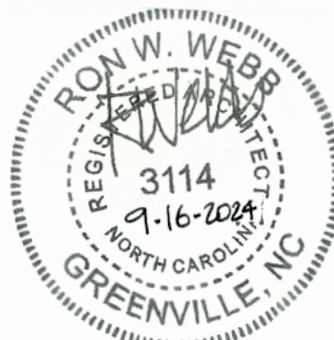
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☒ For Construction
☐ Not for Construction
☒ Review Set
☐ Bid Set

Issue Date 09/20/2023

Plot Date:


Revisions

Mark	Date	Description

Drawing No.

SHEET
NAME
MISCELLANEOUS
DETAILS
A-8

of

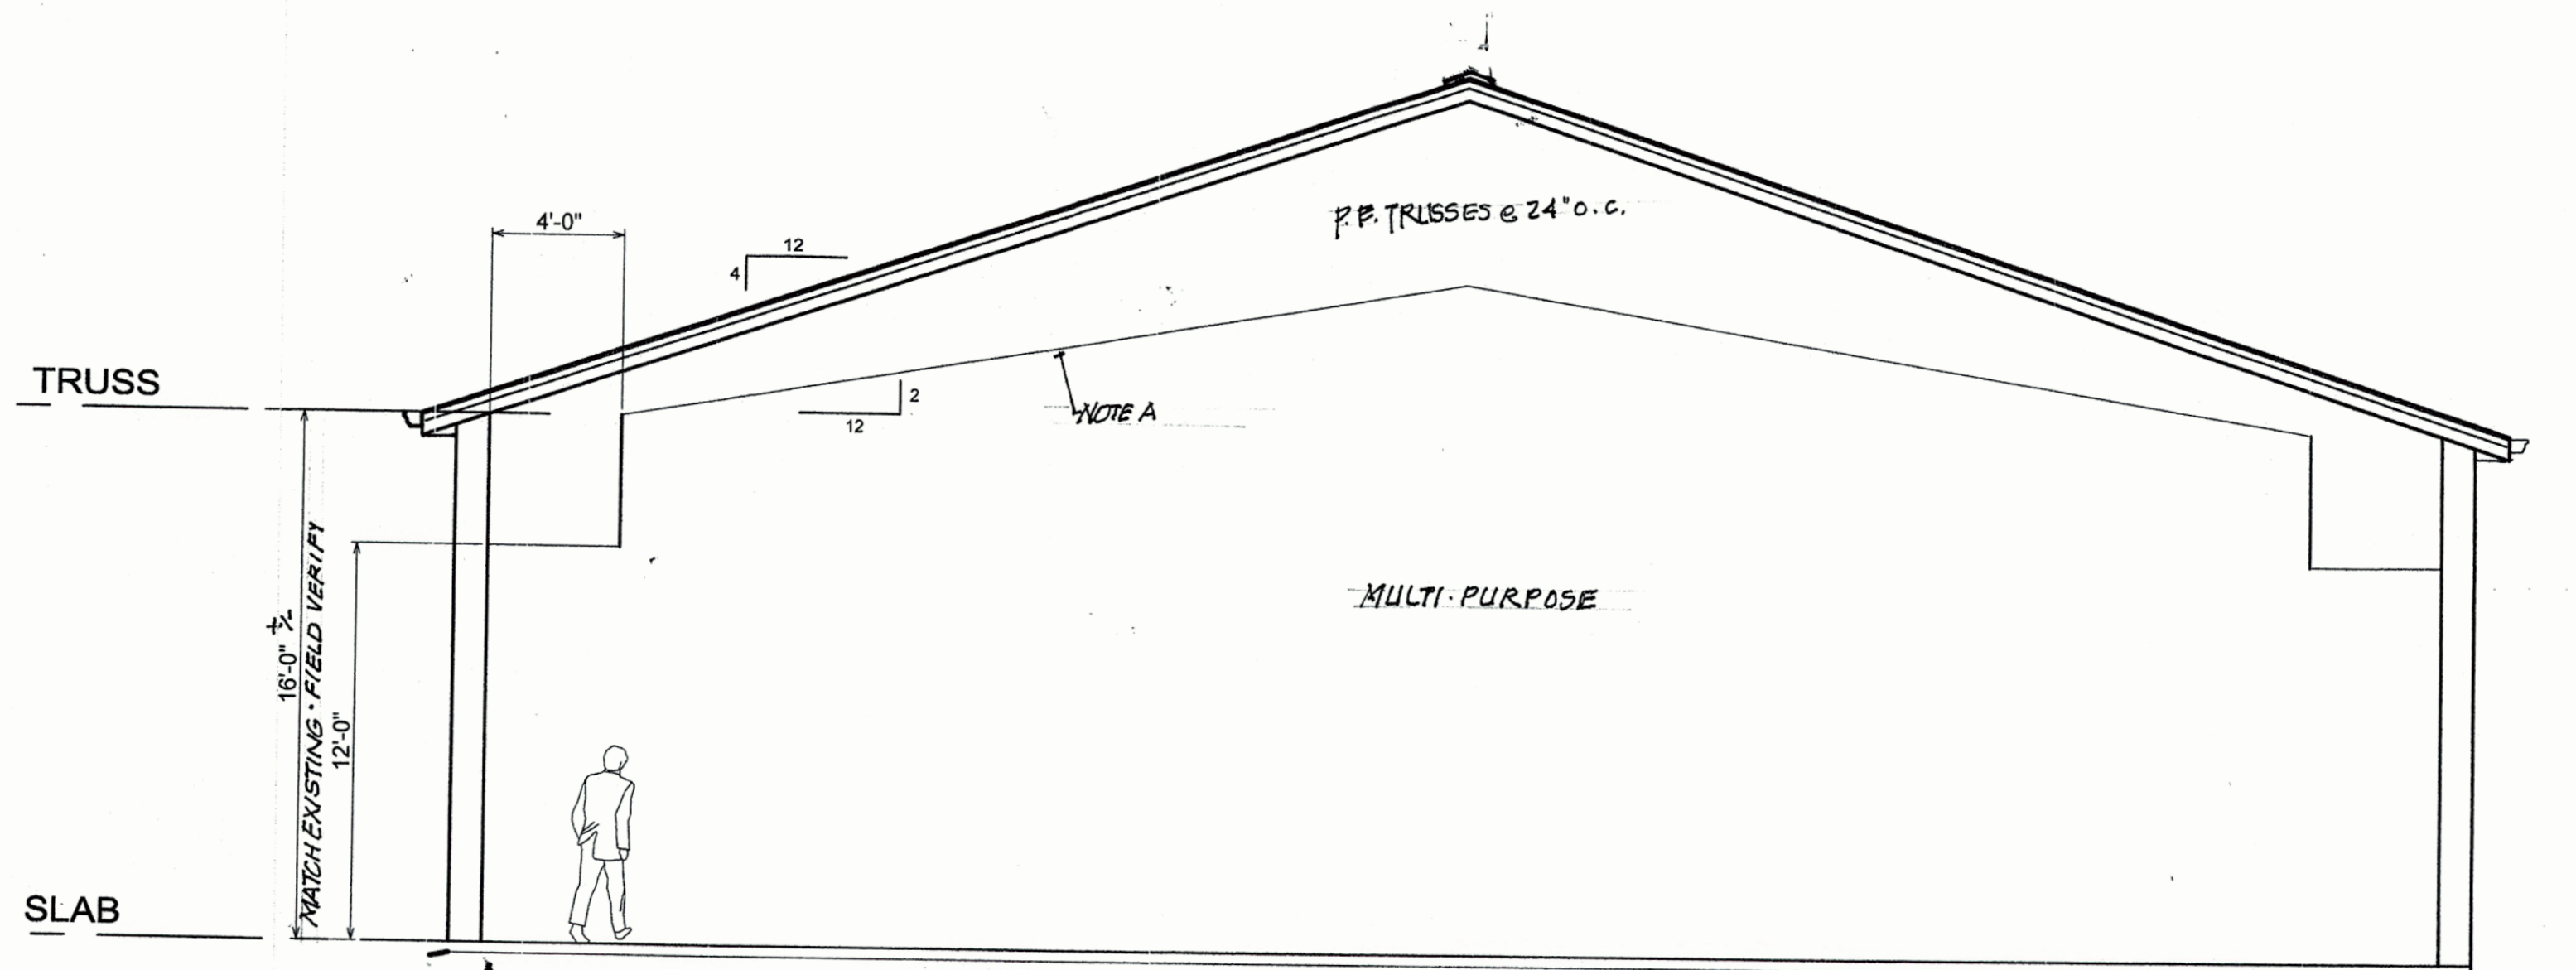

NOTE: SEE FOOTING DETAILS

DIAGRAMMATIC SECTION

NOTE: SEE ELECTRICAL FOR LIGHTS
NOTE A: 5/8" PAINTED DRYWALL ON METAL FURRING STRIPS FRONT TO REAR WALL.

4" REINFC SLAB ON 6 MIL VAPOR BARRIER
4" STONE BASE

2018 APPENDIX B
BUILDING CODE SUMMARY FOR ALL COMMERCIAL PROJECTS
(EXCEPT 1 AND 2-FAMILY DWELLINGS AND TOWNHOUSES)
(Reproduce the following data on the building plans sheet 1 or 2)

Name of Project: Mount Pisgah Harnett Original Free Will Baptist Church- Life Center/Classrooms/Kitchen
Address: 145 Prospect Church Rd., Erwin, NC Zip Code 28339
Owner/Authorizing Agent: Ron W. Webb, Architect Phone # (919) 215-3064 E-Mail: ronwebb20@gmail.com
Owned By: ☐ City/County ☒ Private ☐ State
Code Enforcement Jurisdiction: ☐ City ☒ County ☐ State

CONTACT:

DESIGNER	FIRM	NAME	LICENSE #	TELEPHONE #	E-MAIL
Architectural	Ron W. Webb, Architect	Ron W. Webb	51408	252-931-2711	wgarryowen@cs.com
Civil					
Electrical	Karios Project Group	Ben Lewis	3824	919-741-8223	blewis@pgncc.com
Fire Alarm					
Plumbing	Karios Project Group	Ben Lewis	3824	919-741-8223	blewis@pgncc.com
Mechanical	Karios Project Group	Ben Lewis	3824	919-741-8223	blewis@pgncc.com
Sprinkler-Standpipe					
Structural	Neville Engineering	Agustus Neville		919-740-3427	
Retaining Walls >5' High					
Other					

("Other" should include firms and individuals such as truss, precast, pre-engineered, interior designers, etc.)

2018 NC BUILDING CODE: ☒ New Building ☐ Addition ☐ Renovation
☐ 1st Time Interior Completion
☐ Shell/Core - Contact the local inspection jurisdiction for possible additional procedures and requirements
☐ Phased Construction - Shell/Core - Contact the local inspection jurisdiction for possible additional procedures and requirements

2018 NC EXISTING BUILDING CODE: EXISTING: ☐ Prescriptive ☐ Repair ☐ Chapter 14
Alteration: ☐ Level I ☐ Level II ☐ Level III
☐ Historic Property ☐ Change of Use

CONSTRUCTED: (date) _____ CURRENT OCCUPANCY(S) (Ch. 3): _____
RENOVATED: (date) _____ PROPOSED OCCUPANCY(S) (Ch. 3): A3

RISK CATEGORY (Table 1604.5): Current: ☐ I ☐ II ☐ III ☐ IV
Proposed: ☐ I ☐ II ☐ III ☐ IV

BASIC BUILDING DATA

Construction Type: ☐ I-A ☐ II-A ☐ III-A ☐ IV ☐ V-A
(check all that apply) ☐ I-B ☐ II-B ☒ III-B ☐ V-B
Sprinklers: ☒ No ☐ Partial ☐ Yes ☐ NFPA 13 ☐ NFPA 13R ☐ NFPA 13D
Standpipes: ☒ No ☐ Yes Class ☐ I ☐ II ☐ III ☐ Wet ☐ Dry
Fire District: ☒ No ☐ Yes Flood Hazard Area: ☒ No ☐ Yes
Special Inspections Required: ☒ No ☐ Yes (Contact the local inspection jurisdiction for additional procedures and requirements.)

2018 NC Administrative Code and Policies

Revised 6/15/2020

Gross Building Area Table			
FLOOR	EXISTING (SQ FT)	NEW (SQ FT)	SUB-TOTAL
3 rd Floor	0	0	0
2 nd Floor	0	0	0
Mezzanine	0	0	0
1 st Floor	0	11000	0
Basement	0	0	0
TOTAL	0	11000	0

ALLOWABLE AREA

Primary Occupancy Classification(s):
Assembly ☐ A-1 ☐ A-2 ☒ A-3 ☐ A-4 ☐ A-5
Business ☐
Educational ☐
Factory ☐ F-1 Moderate ☐ F-2 Low
Hazardous ☐ H-1 Detonate ☐ H-2 Deflagrate ☐ H-3 Combust ☐ H-4 Health ☐ H-5 HPM
Institutional ☐ I-1 Condition ☐ I-2 Condition ☐ I-3 Condition ☐ I-4
Mercantile ☐
Residential ☐ R-1 ☐ R-2 ☐ R-3 ☐ R-4
Storage ☐ S-1 Moderate ☐ S-2 Low ☐ High-piled
☐ Parking Garage ☐ Open ☐ Enclosed ☐ Repair Garage
Utility and Miscellaneous ☐

Accessory Occupancy Classification(s): S1 Storage <10% of aggregate area

Incidental Uses (Table 509):

Special Uses (Chapter 4 - List Code Sections):

Special Provisions: (Chapter 5 - List Code Sections):

Mixed Occupancy: ☒ No ☐ Yes Separation: _____ Hr. Exception:

☐ Non-Separated Use (508.3) - The required type of construction for the building shall be determined by applying the height and area limitations for each of the applicable occupancies to the entire building. The most restrictive type of construction, so determined, shall apply to the entire building.

☐ Separated Use (508.4) - See below for area calculations for each story, the area of the occupancy shall be such that the sum of the ratios of the actual floor area of each use divided by the allowable floor area for each use shall not exceed 1.

Actual Area of Occupancy A + Actual Area of Occupancy B
Allowable Area of Occupancy A

_____ + _____ = _____ ≤ 1.00

2018 NC Administrative Code and Policies

Revised 6/15/2020

FIRE PROTECTION REQUIREMENTS

BUILDING ELEMENT	FIRE SEPARATION DISTANCE (FEET)	RATING REQ'D	PROVIDED (W/ REDUCTION)	DETAIL # AND SHEET #	DESIGN # FOR RATED ASSEMBLY	SHEET # FOR RATED PENETRATION	SHEET # FOR RATED JOINTS
Structural Frame, including columns, girders, trusses							
Bearing Walls							
Exterior							
North	>30'						
East	0	3hr.	3hr.		U419		
West	>30'						
South	>30'						
Interior							
Nonbearing Walls and Partitions							
Exterior walls							
North							
East							
West							
South							
Interior walls and partitions							
Floor Construction							
Including supporting beams and joists		N/A					
Floor Ceiling Assembly		N/A					
Columns Supporting Floors		N/A					
Roof Construction, including supporting beams and joists		N/A					
Roof Ceiling Assembly		N/A					
Columns Supporting Roof		N/A					
Shaft Enclosures - Exit		N/A					
Shaft Enclosures - Other		N/A					
Corridor Separation	1 hr.	1 hr.			U305- wall	T722.6.2(1)	Ceiling
Occupancy/Fire Barrier Separation	N/A						
Party/Fire Wall Separation	3 hr.	3 hr.			U419		
Smoke Barrier Separation	N/A						
Smoke Partition	N/A						
Tenant/Dwelling Unit/ Sleeping Unit Separation	N/A						
Incidental Use Separation	N/A						

* Indicate section number permitting reduction

NCSBC T722.6.2(1)- For ceiling- 2 layers 5/8" Type X= 80 minutes. 60 minutes required.

2018 NC Administrative Code and Policies

Revised 6/15/2020

PERCENTAGE OF WALL OPENING CALCULATIONS

FIRE SEPARATION DISTANCE (FEET) FROM PROPERTY LINES	DEGREE OF OPENINGS PROTECTION (TABLE 705.8)	ALLOWABLE AREA (%)	ACTUAL SHOWN ON PLANS (%)
>30'	Unprotected, Non sprinkler	No Limit	

LIFE SAFETY SYSTEM REQUIREMENTS

Emergency Lighting: ☐ No ☒ Yes
Exit Signs: ☐ No ☒ Yes
Fire Alarm: ☒ No ☐ Yes
Smoke Detection Systems: ☐ No ☐ Yes ☒ Partial _____ Duct detectors in units >2000 cfm
Carbon Monoxide Detection: ☒ No ☐ Yes

LIFE SAFETY PLAN REQUIREMENTS

Life Safety Plan Sheet #: LS-1

- ☒ Fire and/or smoke rated wall locations (Chapter 7)
☐ Assumed and real property line locations (if not on the site plan)
☐ Exterior wall opening area with respect to distance to assumed property lines (705.8)
☒ Occupancy Use for each area as it relates to occupant load calculation (Table 1004.1.2)
☒ Occupant loads for each area
☒ Exit sign locations (1013)
☒ Exit access travel distances (1017)
☐ Common path of travel distances (Tables 1006.2.1 & 1006.3.2(1))
☐ Dead end lengths (1020.4)
☐ Clear exit widths for each exit door
☐ Maximum calculated occupant load capacity each exit door can accommodate based on egress width (1005.3)
☐ Actual occupant load for each exit door
☐ A separate schematic plan indicating where fire rated floor/ceiling and/or roof structure is provided for purposes of occupancy separation
☒ Location of doors with panic hardware (1010.1.10)
☐ Location of doors with delayed egress locks and the amount of delay (1010.1.9.7)
☐ Location of doors with electromagnetic egress locks (1010.1.9.9)
☐ Location of doors equipped with hold-open devices
☐ Location of emergency escape windows (1030)
☐ The square footage of each fire area (202)
☐ The square footage of each smoke compartment for Occupancy Classification I-2 (407.5)
☐ Note any code exceptions or table notes that may have been utilized regarding the items above

2018 NC Administrative Code and Policies

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ACCESSIBLE DWELLING UNITS

(SECTION 1107)

UNIT CLASSIFICATION	TOTAL UNITS	ACCESSIBLE UNITS REQUIRED	ACCESSIBLE UNITS PROVIDED	TYPE A UNITS REQUIRED	TYPE A UNITS PROVIDED	TYPE B UNITS REQUIRED	TYPE B UNITS PROVIDED	TOTAL ACCESSIBLE UNITS PROVIDED
N/A								

ACCESSIBLE PARKING

(SECTION 1106)

LOT OR PARKING AREA	TOTAL # OF PARKING SPACES REQUIRED	PROVIDED	# OF ACCESSIBLE SPACES PROVIDED	96" SPACES	132" SPACES	TOTAL # ACCESSIBLE SPACES PROVIDED
TOTAL						

PLUMBING FIXTURE REQUIREMENTS

(TABLE 2902.1)

USE		WATER CLOSETS			URINALS			LAVATORIES			SHOWERS /TUBS	DRINKING FOUNTAINS	
		MALE	FEMALE	UNSEX	MALE	FEMALE	UNSEX	MALE	FEMALE	UNSEX		REGULAR	ACCESSIBLE
SPACE 251	EXIST'G	2	4	1	2	2	2	1	2	1	2	3	3
	REQ'D	2	3	0	0	1	1	0	0	0	1	1	1

SPECIAL APPROVALS

Special approval: (Local Jurisdiction, Department of Insurance, OSC, DPI, DHHS, etc., describe below)

Local Jurisdiction

2018 NC Administrative Code and Policies

Revised 6/15/2020

ARCHITECT


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Issue Date 09/20/2023

Plot Date:

Revisions

Mark	Date	Description

SHEET
NAME BCS

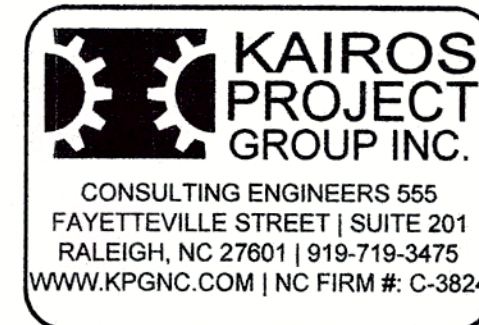Drawing No.

1

ENERGY REQUIREMENTS:
The following data shall be considered minimum and any special attribute required to meet the energy code shall also be provided. Each Designer shall furnish the required portions of the project information for the plan data sheet. If performance method, state the annual energy cost for the standard reference design vs annual energy cost for the proposed design.

ENERGY SUMMARY
Existing building envelope complies with code: ☐ No ☐ Yes (The remainder of this section is not applicable)
Exempt Building: ☒ No ☐ Yes (Provide code or statutory reference):
Climate Zone: ☐ 3A ☒ 4A ☐ 5A
Method of Compliance: Energy Code ☐ Performance ☒ Prescriptive
ASHRAE 90.1 ☐ Performance ☐ Prescriptive
(If "Other" specify source here)
THERMAL ENVELOPE (Prescriptive method only)
Roof/ceiling Assembly (each assembly) Batt or Blown R42 insulation
Description of assembly:
U-Value of total assembly:
R-Value of insulation: R-42
Skylights in each assembly:
U-Value of skylight:
total square footage of skylights in each assembly:
Exterior Walls (each assembly) R-13 Batt cavity filled insulation + R-7.5, 1 1/2" Polystyrene (XPS)
Description of assembly:
U-Value of total assembly:
R-Value of insulation: R13+R7.5
Openings (windows or doors with glazing)
U-Value of assembly:
Solar heat gain coefficient:
projection factor:
Door R-Values:
Walls below grade (each assembly)
Description of assembly:
U-Value of total assembly:
R-Value of insulation:
Floors over unconditioned space
Description of assembly:
U-Value of total assembly:
R-Value of insulation:
Floors slab on grade R-15 Polystyrene termite resistant rigid foam for 24"
Description of assembly:
U-Value of total assembly:
R-Value of insulation: R-15
Horizontal/vertical requirement:
slab heated:

2018 NC Administrative Code and Policies
Revised 6/15/2020

2018 APPENDIX B
BUILDING CODE SUMMARY FOR ALL COMMERCIAL PROJECTS
MECHANICAL DESIGN
(PROVIDE ON THE MECHANICAL SHEETS IF APPLICABLE)
MECHANICAL SUMMARY
MECHANICAL SYSTEMS, SERVICE SYSTEMS AND EQUIPMENT
Thermal Zone
winter dry bulb:
summer dry bulb:
Interior design conditions
winter dry bulb:
summer dry bulb:
relative humidity:
Building heating load:
Building cooling load:
Mechanical Spacing Conditioning System
Unitary
description of unit:
heating efficiency:
cooling efficiency:
size category of unit:
Boiler
Size category. If oversized, state reason.:
Chiller
Size category. If oversized, state reason.:
List equipment efficiencies:

Note to plan reviewer:
SEE MECHANICAL DRAWINGS FOR MECHANICAL SUMMARY INFORMATION

2018 NC Administrative Code and Policies
Revised 6/15/2020

2018 APPENDIX B
BUILDING CODE SUMMARY FOR ALL COMMERCIAL PROJECTS
STRUCTURAL DESIGN
(PROVIDE ON THE STRUCTURAL SHEETS IF APPLICABLE)
DESIGN LOADS:
Importance Factors: Snow (Is) 1.0
Seismic (Ie) 1.0
Live Loads: Roof 20 psf
Mezzanine N/A psf
Floor 100 psf
Ground Snow Load: 15 psf
Wind Load: Ultimate Wind Speed 120 mph (ASCE-7)
Exposure Category D
SEISMIC DESIGN CATEGORY: ☐ A ☐ B ☐ C ☐ D
Provide the following Seismic Design Parameters:
Risk Category (Table 1604.5) ☐ I ☐ II ☐ III ☐ IV
Spectral Response Acceleration Ss, XX.X %g
Site Classification (ASCE 7) ☐ A ☐ B ☐ C ☐ D ☐ E ☐ F
Data Source: ☐ Field Test ☐ Presumptive ☐ Historical Data
Basic structural system ☒ Bearing Wall ☐ Dual w/Special Moment Frame
☐ Building Frame ☐ Dual w/Intermediate R/C or Special Steel
☐ Moment Frame ☐ Inverted Pendulum
Analysis Procedure: ☐ Simplified ☐ Equivalent Lateral Force ☐ Dynamic
Architectural, Mechanical, Components anchored? ☒ Yes ☐ No
LATERAL DESIGN CONTROL: Earthquake ☐ Wind ☒
SOIL BEARING CAPACITIES:
Field Test (provide copy of test report) To be provided psf
Presumptive Bearing capacity 2000 psf
Pile size, type, and capacity

2018 NC Administrative Code and Policies
Revised 6/15/2020

2018 APPENDIX B
BUILDING CODE SUMMARY FOR ALL COMMERCIAL PROJECTS
ELECTRICAL DESIGN
(PROVIDE ON THE ELECTRICAL SHEETS IF APPLICABLE)
ELECTRICAL SUMMARY
ELECTRICAL SYSTEM AND EQUIPMENT
Method of Compliance: Energy Code ☐ Performance ☐ Prescriptive
ASHRAE 90.1 ☐ Performance ☐ Prescriptive
Lighting schedule (each fixture type)
lamp type required in fixture
number of lamps in fixture
ballast type used in the fixture
number of ballasts in fixture
total wattage per fixture
total interior wattage specified vs. allowed (whole building or space by space)
total exterior wattage specified vs. allowed
Additional Efficiency Package Options
(When using the 2018 NCECC; not required for ASHRAE 90.1)
☐ C406.2 More Efficient HVAC Equipment Performance
☐ C406.3 Reduced Lighting Power Density
☐ C406.4 Enhanced Digital Lighting Controls
☐ C406.5 On-Site Renewable Energy
☐ C406.6 Dedicated Outdoor Air System
☐ C406.7 Reduced Energy Use in Service Water Heating

Note to plan reviewer:
SEE ELECTRICAL DRAWINGS FOR ELECTRICAL SUMMARY INFORMATION

2018 NC Administrative Code and Policies
Revised 6/15/2020

ARCHITECT

RON W. WEBB
1659 W. HANRAHAN ROAD
AYDEN, NC. 28513
TEL: (252) 531-2711

Ministries Activity
Center Addition
Mount Pisgah Harnett
Original Free Will
Baptist Church

145 Prospect Church Road
Erwin, NC.

Project Consultants



STRUCTURAL

NEVILLE ENGINEERING

AUGUSTUS NEVILLE, PE
100-B CULBRETH RD.
CHAPEL HILL, NC 27516
TEL: (919) 740-3427



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☒ For Construction
☐ Not for Construction
☒ Review Set
☐ Bid Set

Issue Date 09/20/2023

Plot Date:

Revisions

Mark	Date	Description

SHEET NAME BCS 2
Drawing No.

Neville Engineering

919-740-3427

213 River Birch Lane
Chapel Hill, NC 27514

neveng@aol.com

December 6, 2024

Mr. Ron Webb, Architect
Ayden, NC

Re: Structural Metal Studs
Mount Pisgah Free Will Baptist Church
Erwin, NC

Dear Ron,

I am pleased to provide this design for the structural metal studs for the referenced project. I have enclosed a print of the framing plan with the type of stud to be used marked with numbers 1 thru 3.


Studs for the left end wall and rear wall are marked Type 1 and are to be 600S200-54 at 16" on center.

Studs for the front wall are marked Type 2 and are to be 600S200-54 at 10" on center and are to be braced at the bottom of the roof trusses by connecting to the trusses and adding diagonal bracing from the bottom chord of the truss to the roof. Provide 4 king studs at each side of the window and door openings.

Studs in the other locations are marked Type 3 and are to be 600S137-33 at 16" on center.

Please contact me if you have questions.

Sincerely,

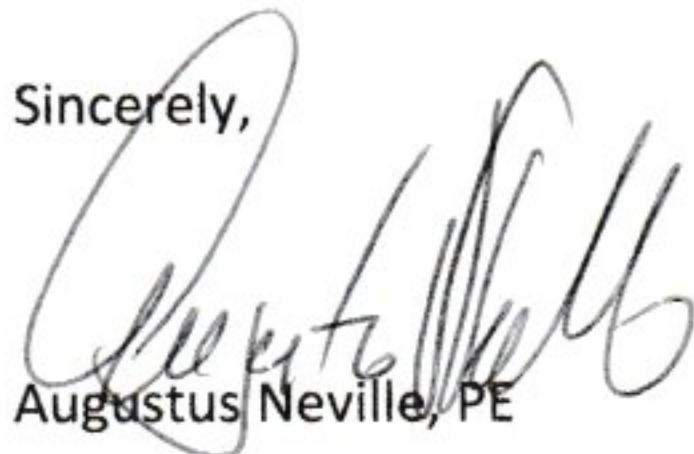


Augustus Neville, PE



Structural metal studs

Type 1 600S200-54 @ 16" cts
 Type 1 600S200-54 @ 10" cts
 Connect to truss bottom chord
 @ provide diagonal brace to roof
 @ 48" maximum center
 Type 3 600S137-33 @ 16" cts

No	NAME	FLOOR	BASE	WALLS	CEILING	HT.	REMARKS
001	ENTRY PORCH	EXPOSED CONC.	NA	NA	VENTED VINYL	11'-0"	BROOM FINISH CONC.
101	LOBBY	VCT	4" RUBBER	PAINTED GWB	2x2 AC. TILE	10'-0"	
102	MULTI PURPOSE	VCT	4" RUBBER	PAINTED GWB	2x2 AC. TILE	10'-0"	
103	SECURITY	CARPET	4" RUBBER	PAINTED GWB	2x2 AC. TILE	10'-0"	
104	MULTI MEDIA	CARPET	4" RUBBER	PAINTED GWB	2x2 AC. TILE	10'-0"	
105	STORAGE	VCT	4" RUBBER	PAINTED GWB	2x2 AC. TILE	10'-0"	
106	JAN / STORAGE	VCT	4" RUBBER	PAINTED GWB	2x2 AC. TILE	10'-0"	
107	KITCHEN	VCT	4" RUBBER	PAINTED GWB	2x2 AC. TILE	10'-0"	FRP PANELS 8'-0" HIGH, EPOXY PAINT ABOVE
108	PANTRY	VCT	4" RUBBER	PAINTED GWB	2x2 AC. TILE	10'-0"	
109	BULKHEAD	EXPOSED CONC.	4" RUBBER	PAINTED GWB	PAINTED GWB	10'-0"	
110	FAMILY TOILET	VCT	4" RUBBER	PAINT & TILE	2x2 AC. TILE	10'-0"	TILE TO 7'-0" HIGH, EPOXY PAINT ABOVE
111	CLASSROOM	CARPET	4" RUBBER	PAINTED GWB	2x2 AC. TILE	10'-0"	
112	CLASSROOM	CARPET	4" RUBBER	PAINTED GWB	2x2 AC. TILE	10'-0"	
113	CLASSROOM	CARPET	4" RUBBER	PAINTED GWB	2x2 AC. TILE	10'-0"	
114	REAR LOBBY	VCT	4" RUBBER	PAINTED GWB	2x2 AC. TILE	10'-0"	
115	REAR CORRIDOR	VCT	4" RUBBER	PAINTED GWB	2x2 AC. TILE	10'-0"	
116	WOMEN	CERAMIC TILE	CERAMIC TILE	PAINT & TILE	2x2 AC. TILE	10'-0"	TILE TO 7'-0" HIGH, EPOXY PAINT ABOVE
117	MEN	CERAMIC TILE	CERAMIC TILE	PAINT & TILE	2x2 AC. TILE	10'-0"	TILE TO 7'-0" HIGH, EPOXY PAINT ABOVE
118	CLASSROOM	CARPET	4" RUBBER	PAINTED GWB	2x2 AC. TILE	10'-0"	
119	CLASSROOM	CARPET	4" RUBBER	PAINTED GWB	2x2 AC. TILE	10'-0"	
120	MAIN CORRIDOR	VCT	4" RUBBER	PAINTED GWB	2x2 AC. TILE	10'-0"	

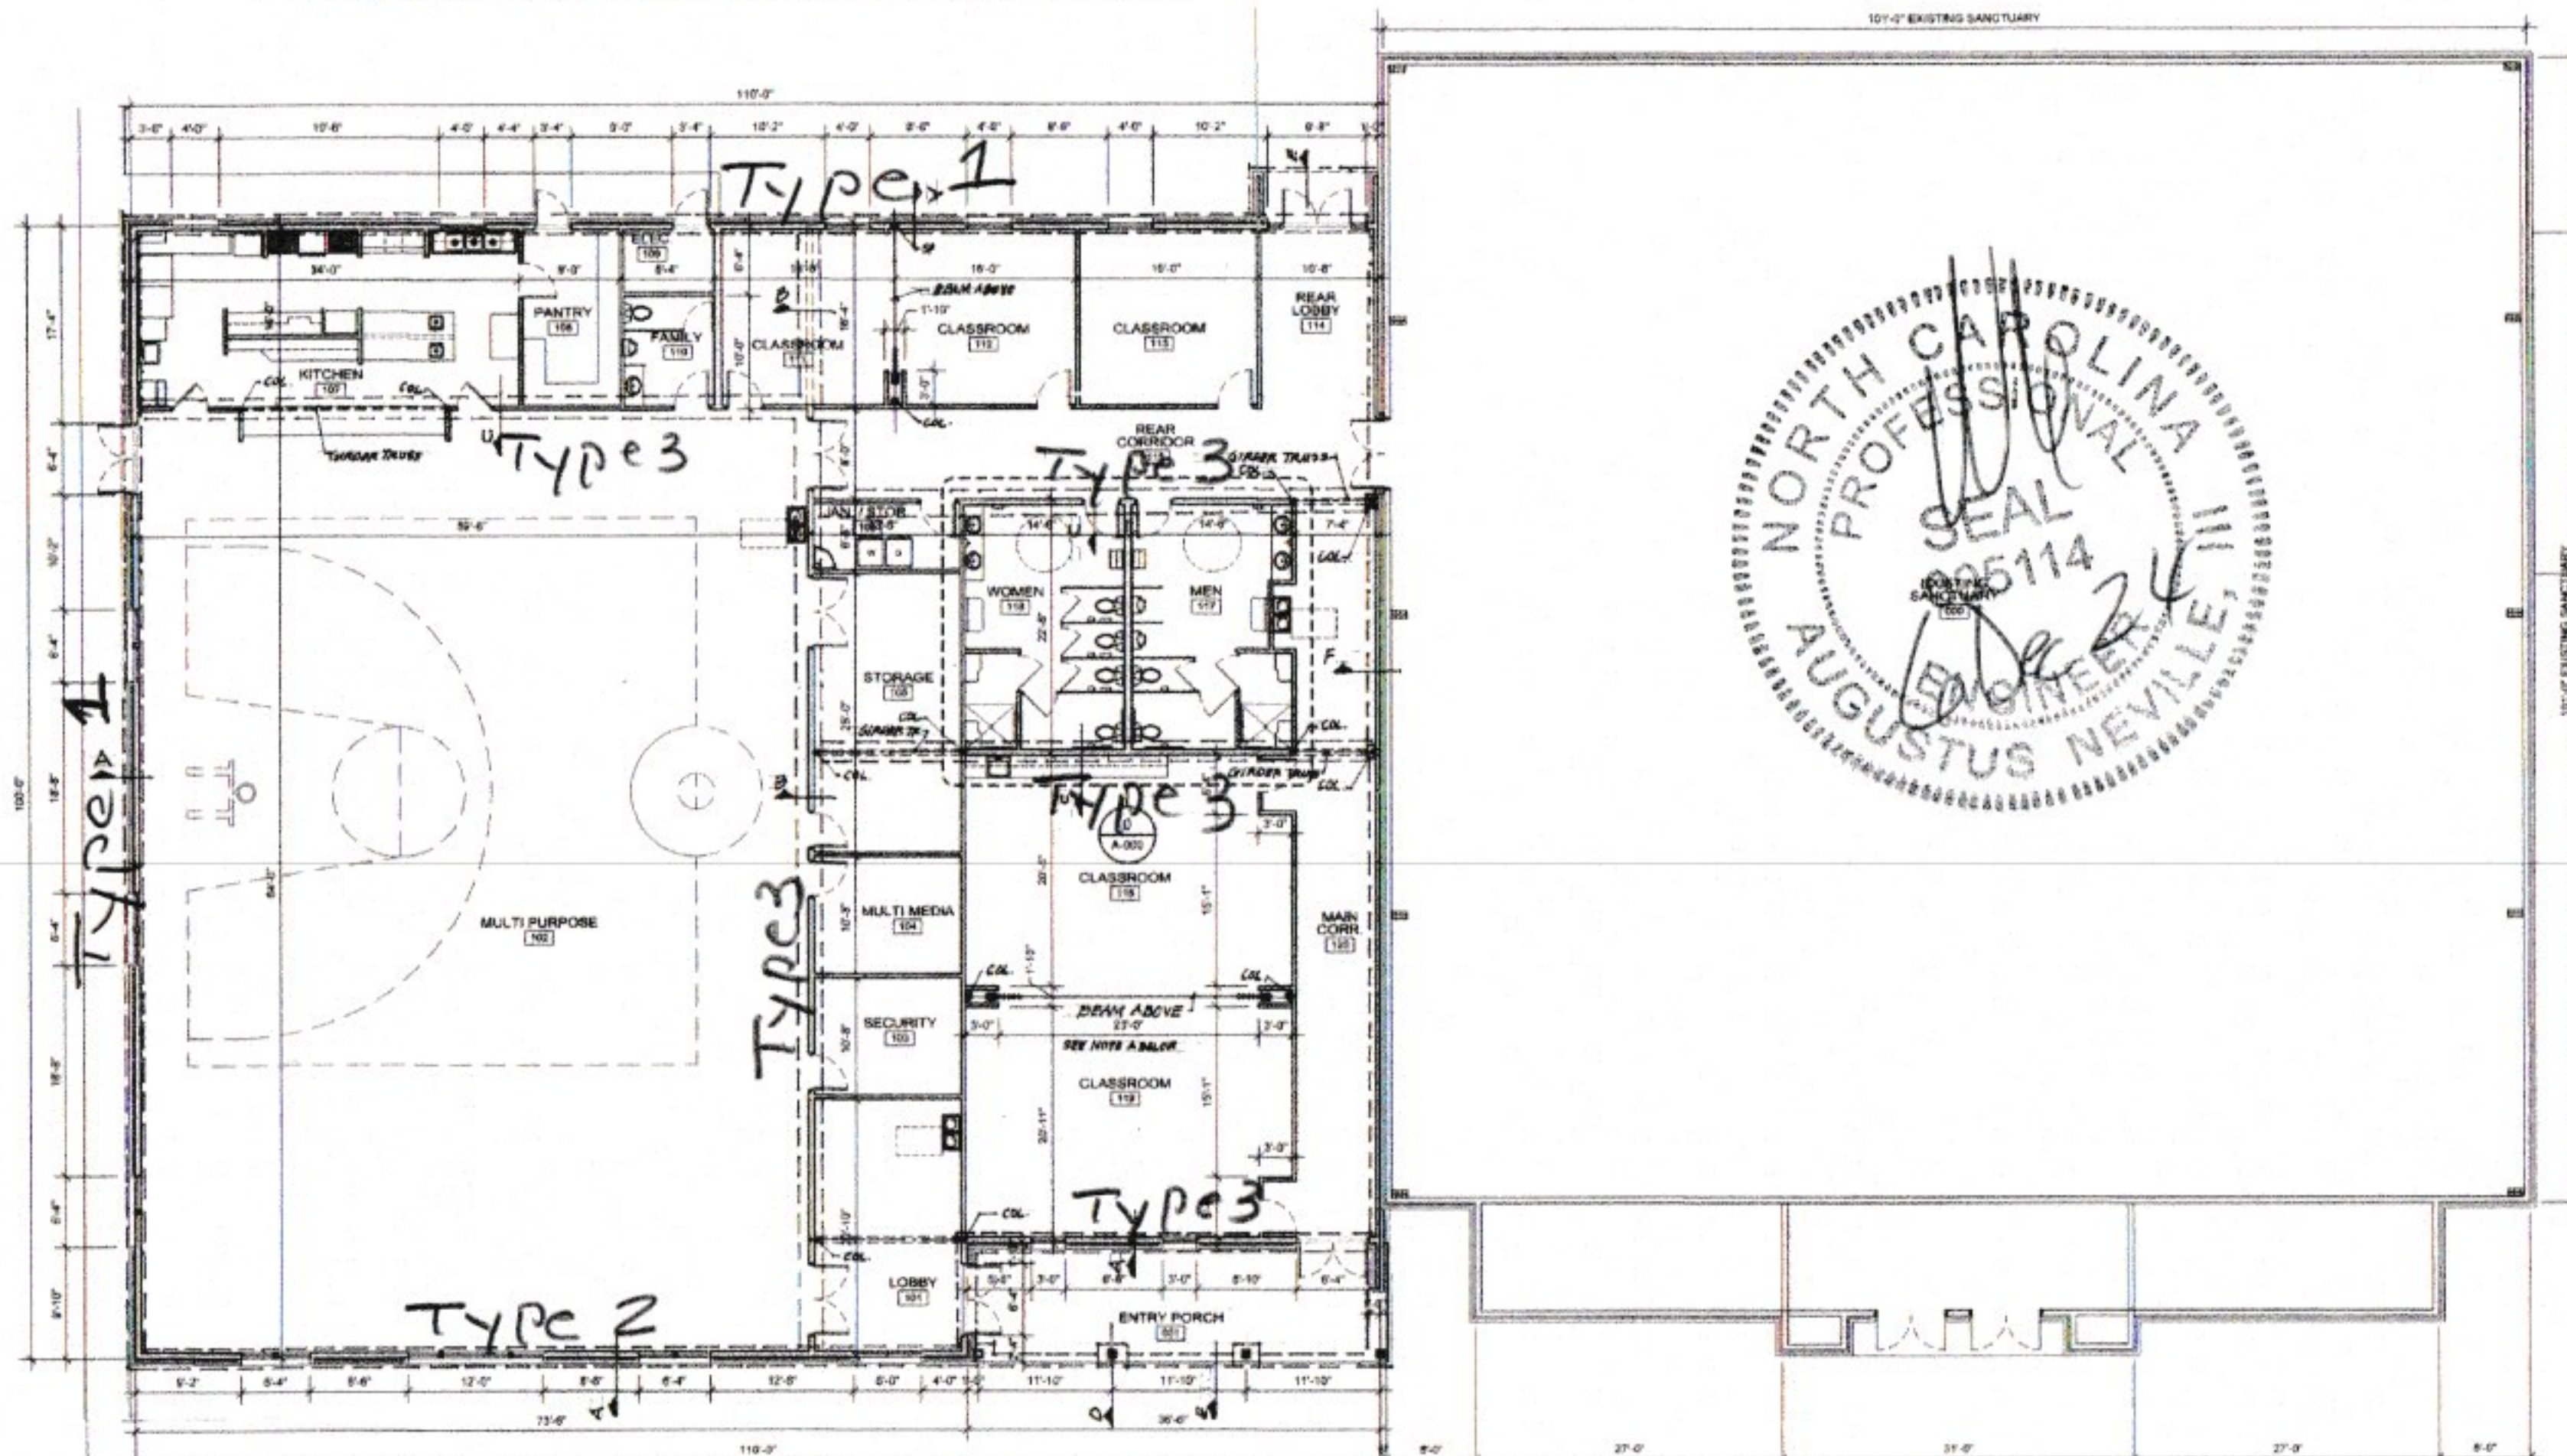

NOTE A: NO ROOF TRUSS LOAD ALLOWED ON FOLDING PARTITION BRAN.
 NOTE B: FLOOR GRS ARE DEEPER THAN STD WALL. PLACE GRS PERMANENTLY TO ENCAPSULATE.
'FOOTING PLAN'
 OVERALL FLOOR PLAN
 SCALE: 1/8" = 1'-0"

ARCHITECT

RON W. WEBB
 1659 W. HANRAHAN ROAD
 AYDEN, NC. 28513
 TEL: (252) 531-2711

**Ministries Activity
 Center Addition
 Mount Pisgah Harnett
 Original Free Will
 Baptist Church**

145 Prospect Church Road
 Erwin, NC.

PROJECT CONSULTANTS



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 100-B CULBRETH RD
 CHAPEL HILL, NC 27516
 TEL: (919) 740-3427



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Issue Date: 09/20/2023

Plot Date:

Revisions

Mark	Date	Description



FOOTING PLAN

OVERALL
 FLOOR
 PLAN


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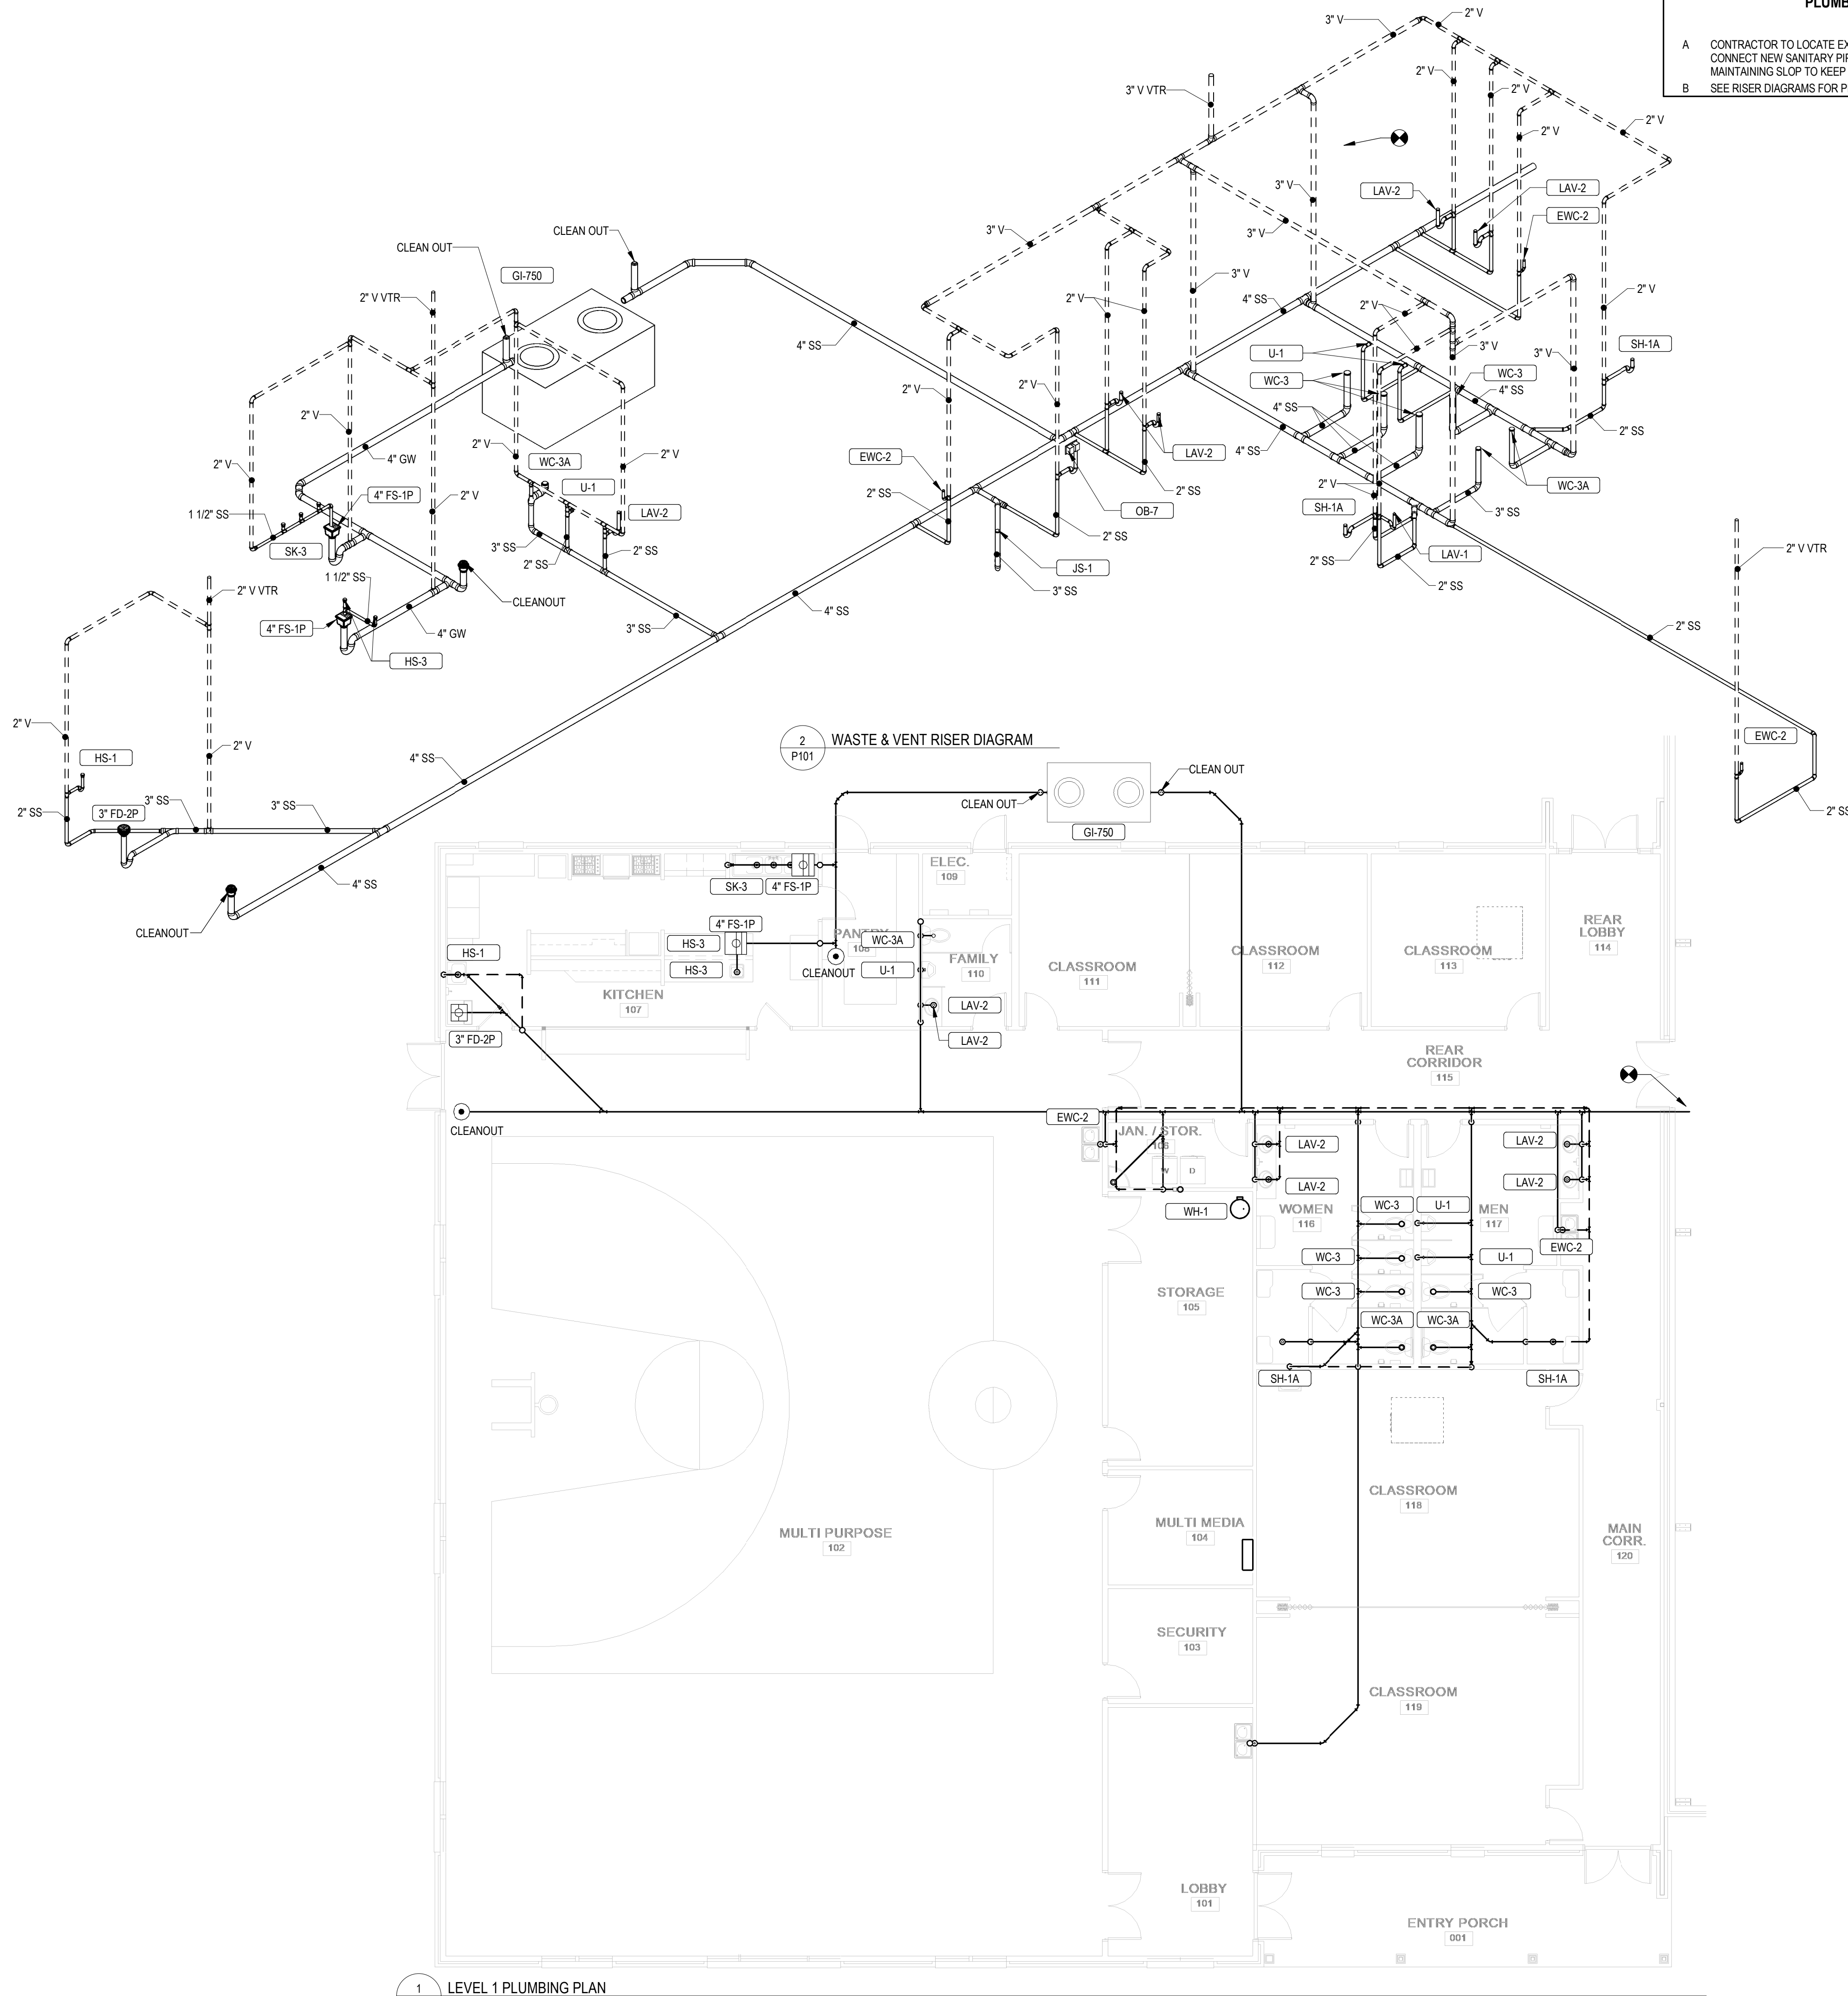
RON W. WEBB
1659 W. HANRAHAN ROAD
AYDEN, NC. 28513
TEL: (252) 531-2711

PROJECT CONSULTANTS

[illegible]

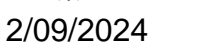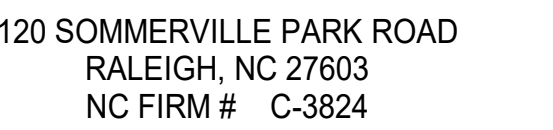of



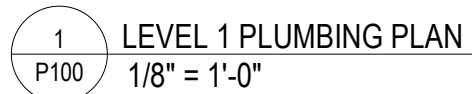

PLUMBING SHEET NOTES

A CONTRACTOR TO LOCATE EXISTING 4" SANITARY PIPING. CONTRACTOR SHALL CONNECT NEW SANITARY PIPING INTO EXISTING SANITARY PIPING WHILE MAINTAINING SLOP TO KEEP SANITARY SYSTEM FULLY FUNCTIONAL.

B SEE RISER DIAGRAMS FOR PIPE SIZING.

ARCHITECT

RON W. WEBB
1659 W. HANRAHAN ROAD
AYDEN, NC. 28513
TEL: (252) 531-2711


**WEBB MT
PISGAH**

145 PROSPECT CHURCH RD
ERWIN, NC 28339

PROJECT CONSULTANTS



120 SOMMERVILLE PARK ROAD
RALEIGH, NC 27603
NC FIRM # C-3824

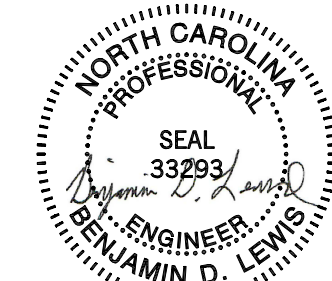

12/09/2024

☒ For Construction
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☐ Review Set
☒ Bid Set

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Issue Date: Issue Date

Plot Date: 10/23/2023 4:27:33 PM

Revisions

Mark	Date	Description

Drawing No.
PLUMBING SANITARY PLAN

P101






of

DOMESTIC FIXTURE SCHEDULE																								
ID	DESCRIPTION	MANUFACTURER	MODEL	QTY	MATERIAL DESCRIPTION	FINISH	TRIM				FLOW FIXTURE					FLUSH FIXTURE		WASTE ROUGH-IN PIPE SIZE	INDIRECT WASTE PIPE SIZE	VENT PIPE SIZE	COLD WATER ROUGH-IN PIPE SIZE	HOT WATER ROUGH-IN PIPE SIZE	SPECIFICATION	REMARKS
							MANUFACTURER	MODEL	TYPE	MOTION SENSOR CONTROL	WATER FLOW	TIMER DURATION (SEC)	CWT	HWT	MAX. MW	VOL. PER FLUSH	MIN. VOL. PER FLUSH							
EWC-2	WATER COOLER - DUAL HEIGHT	ELKAY	EZSL8WSSK	3	GALVANIZED STEEL	STAINLESS STEEL CABINET				No	0.1 GPM	15	40 °F		40 °F			2"		1 1/2"	1/2"		TWO LEVEL WALL HUNG WATER COOLER WITH BOTTLE FILLING STATION. THE UNIT SHALL BE COMPLETE WITH CABINET, MOUNTING FRAME, SELF CLOSING EASY TOUCH SIDE AND FRONT PUSHBAR CONTROLS, FLEXIGUARD SAFETY BUBBLER, REFRIGERATING SYSTEM, AIR COOLED, 120 VOLT, 60 CYCLE, SINGLE PHASE POWER CONNECTION, FULLY AUTOMATIC, COMPLETE AND READY TO OPERATE.	
HS-1	HAND SINK	ELKAY	EHS-18X	1	STAINLESS STEEL	STAINLESS STEEL	ELKAY	INCLUDED	MANUAL	No	0.5 GPM	0	40 °F	120 °F	105 °F			2"		1 1/2"	1/2"	1/2"	SINGLE COMPARTMENT, WALL HUNG, 18 GAUGE, WITH STRAINER AND FAUCET INCLUDED, P-TRAP, TAILPIECES, SUPPLIES AND STOPS. PROVIDE WITH HAWS MODEL NO. 7620 FAUCET MOUNTED EYEWASH AXION EYEPOD.	
HS-3	HAND SINK	ELKAY	D11515	2	STAINLESS STEEL	STAINLESS STEEL	ELKAY	LKD24898BH C	MANUAL	No	0.5 GPM	0	40 °F	120 °F	105 °F			2"		1 1/2"	1/2"	1/2"	DAYTON STAINLESS STEEL 15" X 15" X 5-3/16", SINGLE BOWL, DROP-IN BAR SINK. SINK IS MANUFACTURED FROM 23 GAUGE 300 SERIES STAINLESS STEEL WITH A SATIN FINISH, CENTER DRAIN PLACEMENT, AND BOTTOM ONLY PADS	
JS-1	JANITOR SINK	FIAT	MSB-2424	1	MOLDED STONE		CHICAGO FAUCET CO	897-CP	MANUAL	No	2.5 GPM	0	40 °F	120 °F	105 °F			3"		2"	3/4"	3/4"	SERVICE BASIN WITH CAP ON TWO SIDES, WITH CHROME PLATED 3" DRAIN AND CAST IRON TRAP. FAUCET SHALL INCLUDE PAIL HOOK AND ATMOSPHERIC VACUUM BREAKER SPOUT. FURNISH 5'-0" LENGTH OF 5-PLY GARDEN HOSE AND FITTINGS.	
LAV-1	LAVATORY - WALL HUNG	AMERICAN STANDARD	LUCERNE	1	WHITE VITREOUS CHINA	WHITE	CHICAGO FAUCET CO	116.976 AB.1	ELECTRONIC	Yes	0.5 GPM	12	40 °F	120 °F	105 °F			2"		1 1/2"	1/2"	1/2"	WALL HUNG LAVATORY WITH BACKSPLASH, FAUCET HOLES ON 4" CENTERS. DECK-MOUNTED FAUCET WITH SENSOR, WATER TURBINE POWER WITH VANDAL RESISTANT SPRAY, EXTERNAL ASSE 1070 COMPLIANT THERMOSTATIC MIXING VALVE, GRID DRAIN, LOOSE KEY ANGLE STOPS AND SUPPLIES. INSULATE WATER AND WASTE WITH INSULATION KIT.	
LAV-2	LAVATORY - COUNTER	AMERICAN STANDARD	CADET	5	WHITE VITREOUS CHINA	WHITE	CHICAGO FAUCET CO	116.976 AB.1	ELECTRONIC	Yes	0.5 GPM	12	40 °F	120 °F	105 °F			2"		1 1/2"	1/2"	1/2"	COUNTERTOP LAVATORY, SELF-RIMMING, FAUCET HOLES ON 4" CENTERS. DECK-MOUNTED FAUCET SENSOR, WATER TURBINE POWER WITH VANDAL RESISTANT SPRAY, EXTERNAL ASSE 1070 COMPLIANT THERMOSTATIC MIXING VALVE, GRID DRAIN, LOOSE KEY ANGLE STOPS AND SUPPLIES. INSULATE WATER AND WASTE WITH INSULATION KIT.	
OB-5	ICE MAKER OUTLET BOX	SIOUX CHIEF	696-RG1010MF	1	ABS PLASTIC	WHITE				No	0.5 GPM	0	40 °F	120 °F	105 °F						1/2"		FULLY RECESSED FIRE RATED ICE MAKER SUPPLY BOX WITH COVER. PROVIDE 1/4 TURN BALL VALVES AND WATER HAMMER ARRESTORS IN BOX.	
OB-7	WASHING MACHINE OUTLET BOX	SIOUX CHIEF	696-RG2303WF	1	ABS PLASTIC	WHITE				No	0.5 GPM	0	40 °F	120 °F	105 °F			2"		2"	1/2"	1/2"	FULLY RECESSED FIRE RATED WASHING MACHINE SUPPLY BOX WITH COVER. PROVIDE 1/4 TURN BALL VALVES AND WATER HAMMER ARRESTORS IN BOX. PROVIDE A 2" TRAPPED STANDPIPE IN CONCEALED WALL SPACE.	
SH-1A	SHOWER STALL - ADA	BY OTHERS	BY OTHERS	2			SYMMONS	C-96-500-830-V	MANUAL	No	1.0 GPM	300	40 °F	120 °F	105 °F			2"		1 1/2"	1/2"	1/2"	THE INDIVIDUAL SHOWER STALL IS SPECIFIED IN ANOTHER DIVISION. PROVIDE A SHOWER DRAIN AS SPECIFIED IN "SOIL, WASTE AND VENT PIPING SYSTEMS." SHOWER SYSTEM WITH ASSE 1016 COMPLIANT TYPE "1P" THERMOSTATIC/PRESSURE BALANCING COMBINATION VALVE WITH ADJUSTABLE STOP SCREW TO LIMIT HANDLE TURN. CONCEALED 3-PORT DIVERTER VALVE WITH LEVER HANDLE WITH ARM AND FLANGE, INTEGRAL STOPS, AND IN-LINE VACUUM BREAKER. HAND SHOWER SYSTEM WITH STANDARD HAND SHOWER, 60" FLEXIBLE METAL HOSE, AND 48" SLIDE BAR FOR HAND SHOWER MOUNTING. PROVIDE MANUFACTURER'S FLOW RATE RESTRICTOR ON SHOWERHEAD.	
U-1	URINAL	AMERICAN STANDARD	WASHBROOK	3	WHITE VITREOUS CHINA	WHITE	SLOAN	8186	BATTERY	Yes			40 °F		40 °F	0.125 gal	0.125 gal	2"		1 1/2"	3/4"		WALL HUNG URINAL WITH WASHOUT ACTION, TOP SPUD, SIZE 18" WITH INTEGRAL EXTENDED SHIELDS SUPPORTED BY THROUGH GOING BOLTS AND C.P. NUTS. SOLAR POWERED SENSOR ACTIVATED FLUSHMETER.	
WC-3	WATER CLOSET - FLOOR - TANK TYPE	AMERICAN STANDARD	CADET	4	WHITE VITREOUS CHINA	WHITE	TANK TYPE			No			40 °F		40 °F	1.28 gal	1.28 gal	4"		2"	1/2"		ELONGATED FLOOR MOUNTED TANK TYPE WATER CLOSET, WITH CHURCH 295CT ELONGATED OPEN FRONT SEAT. PROVIDE A 1/4" BRASS BALL VALVE AT WALL CONNECTION.	
WC-3A	WATER CLOSET - FLOOR - PRESSURE ASSISTED TANK TYPE - ADA	AMERICAN STANDARD	CADET RIGHT HEIGHT	3	WHITE VITREOUS CHINA	WHITE	AMERICAN STANDARD	2467.016	MANUAL	No			40 °F		40 °F	1.6 gal	1.6 gal	3"		2"	1/2"		ELONGATED FLOOR MOUNTED PRESSURE ASSISTED TANK TYPE WATER CLOSET, WITH CHURCH 296CT ELONGATED OPEN FRONT SEAT. PROVIDE A 1/4" BRASS BALL VALVE AT WALL CONNECTION. INSTALL AT ADA COMPLIANT HEIGHT.	
Grand total: 27																								

GREASE INTERCEPTOR SIZING PROCEDURE FOR KITCHEN FIXTURES				
FIXTURE TYPE	QUANTITY	PIPE DIAMETER	GPM/FIXTURE	RATING
Pot sink (3 comp)	1	1 1/2"	13	1.00
Meat & Vegetable prep sink	2	1 1/2"	13	0.10
Pre-rinse sink				
Wok				0
Other				0
Dishwasher				0
Can wash / Mop sink				0
Total				23.6
Grease Interceptor Size = flow rate x 30 minutes =				708
Please round up to the next available size to determine the required grease interceptor.				

ELECTRIC WATER HEATER SCHEDULE																								
ID	LOCATION		MANUFACTURER	MODEL NO.	TYPE	ELECTRIC HEAT EXCHANGER					HEATING ELEMENT				EF	ASME	UNIT WEIGHT	FLA	MCA	MOC	VOLT	PH	REMARKS	
	NAME	NO.				HEATING CAP	FLOW		STORAGE		MAX TEMP RISE													
							DESIGN	MIN	RECOVERY	VOL														
WH-1	Space	235	AO SMITH	DEN-40	STORAGE	0.0 kW			0.0 gal/h	40.0 gal	80 °F	2	0.0 kW	Yes	0.9	Yes	447 lb	8.3 A	10.4 A	15.0 A	208 V	3	PROVIDE ASSE 1017 COMPLIANT MIXING VALVE; POWERS SERIES LF5H OR EQUAL.	

GREASE INTERCEPTOR SCHEDULE																			
ID TYPE	MANUFACTURER	MODEL	QTY	TYPE	MATERIAL DESCRIPTION	COVER		CAPACITY		INSTALLATION	PIPE CONNECTIONS			DIMENSIONS			REMARKS		
						DESCRIPTION	DIA	DESIGN FLOW	LIQUID		SOLIDS	ARRANGEMENT	INLET DIA	OUTLET DIA	LENGTH	WIDTH		HEIGHT	
GI-750	MIFAB	SUPER-750	1	GRAVITY	HIGH DENSITY POLYETHYLENE	CAST IRON	2' - 0"	250.0 GPM	750.0 gal	77.0 gal	ABOVE GRADE	4"	-3"	4"	9' - 3"	5' - 4"	4' - 5 5/8"		
Grand total: 1																			

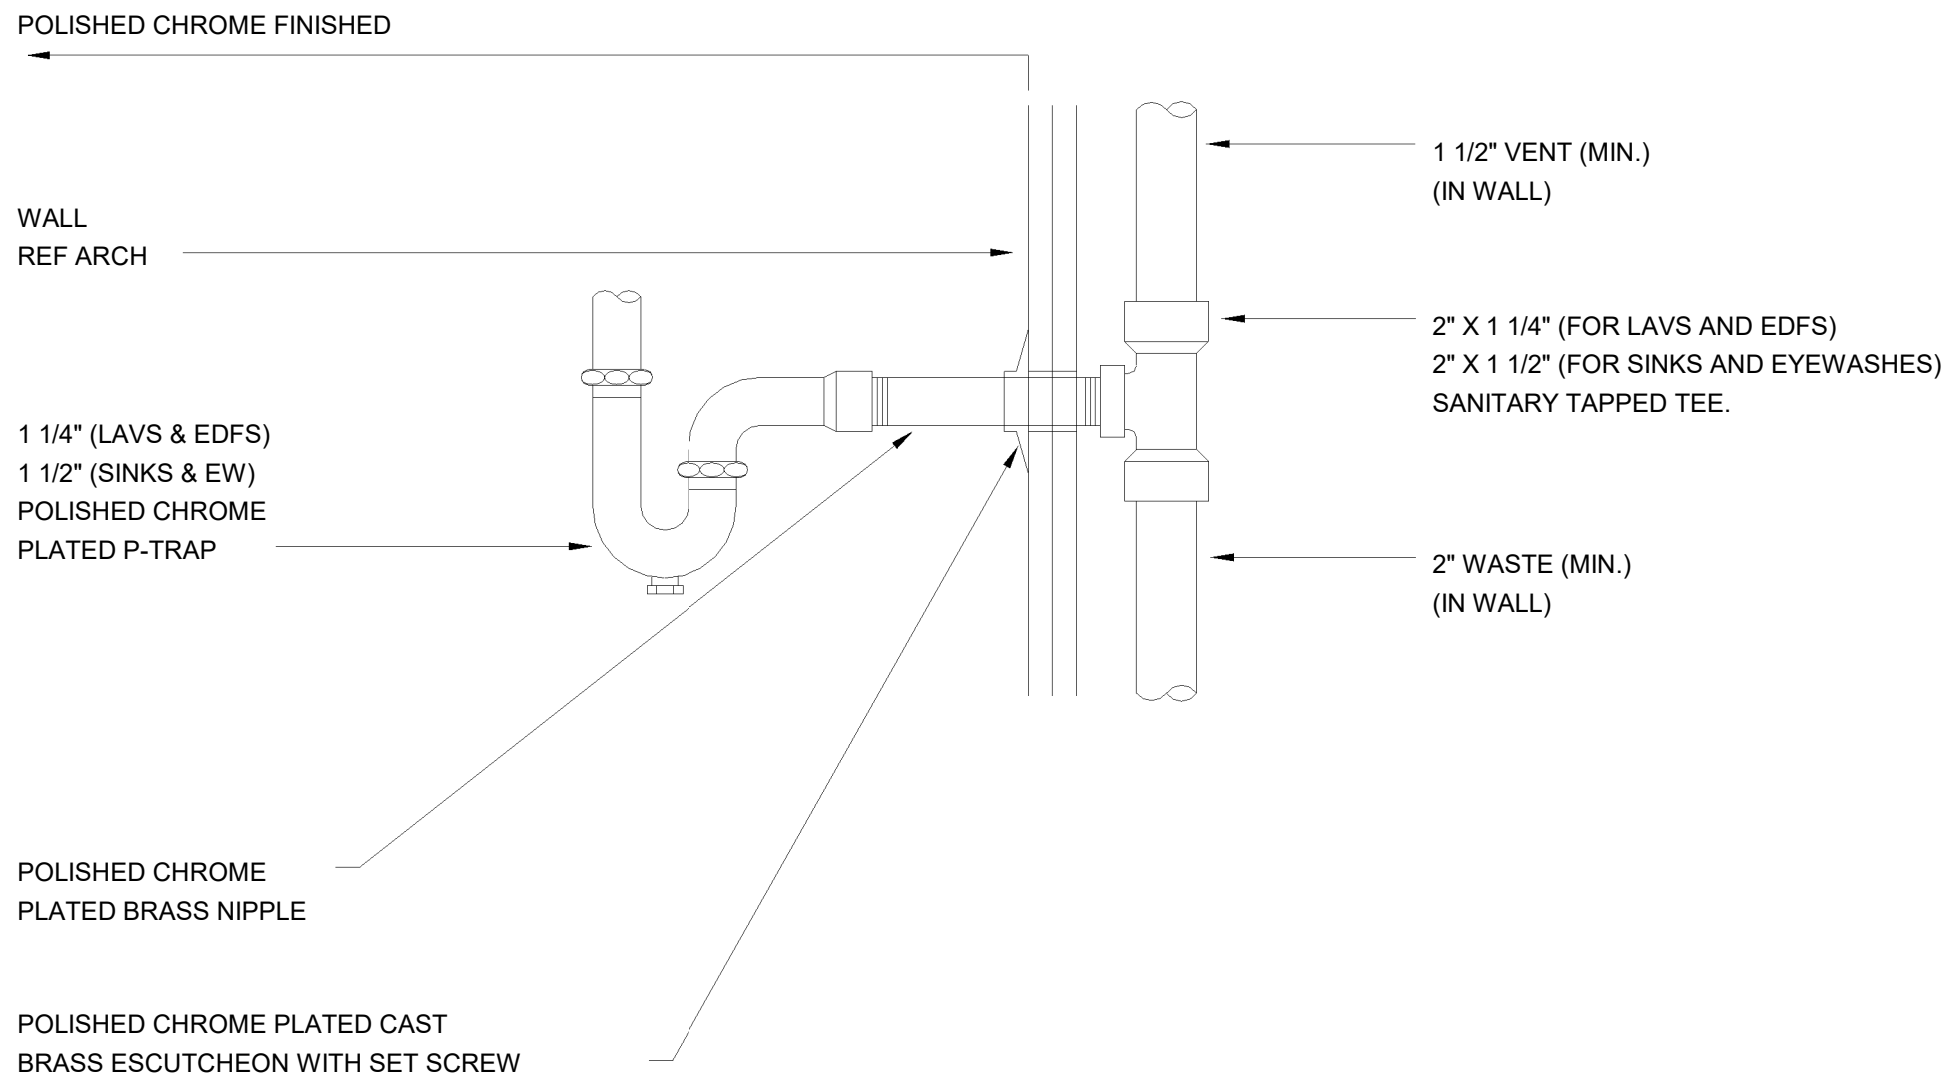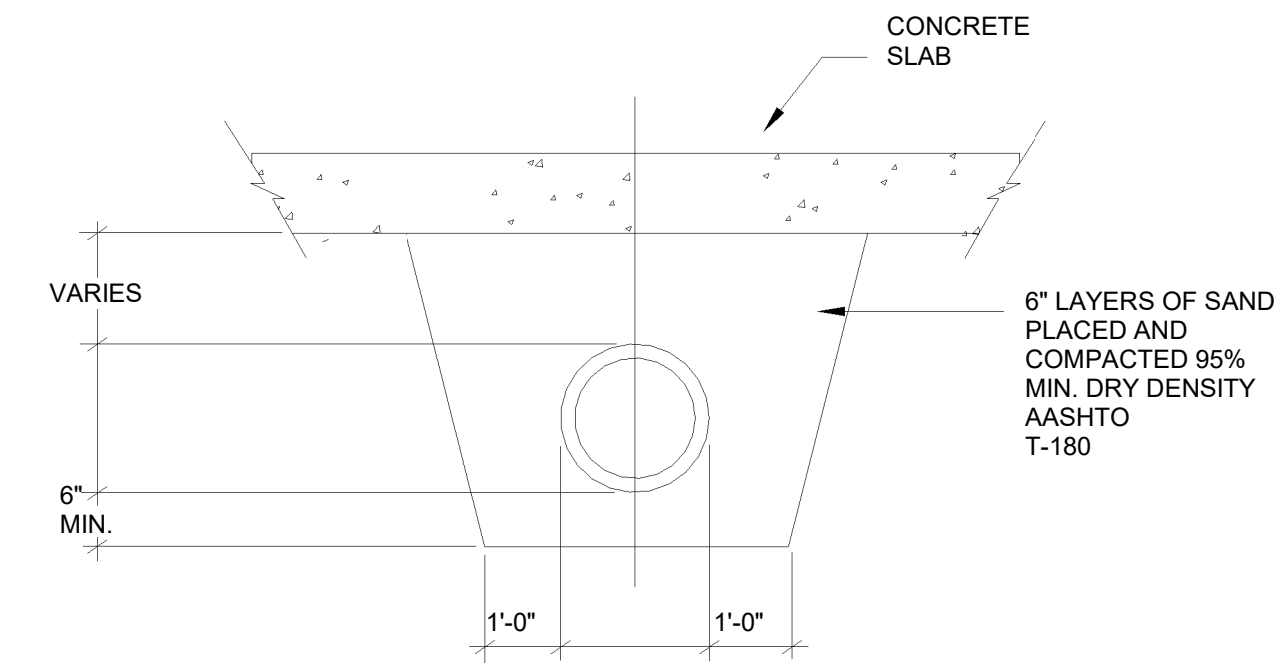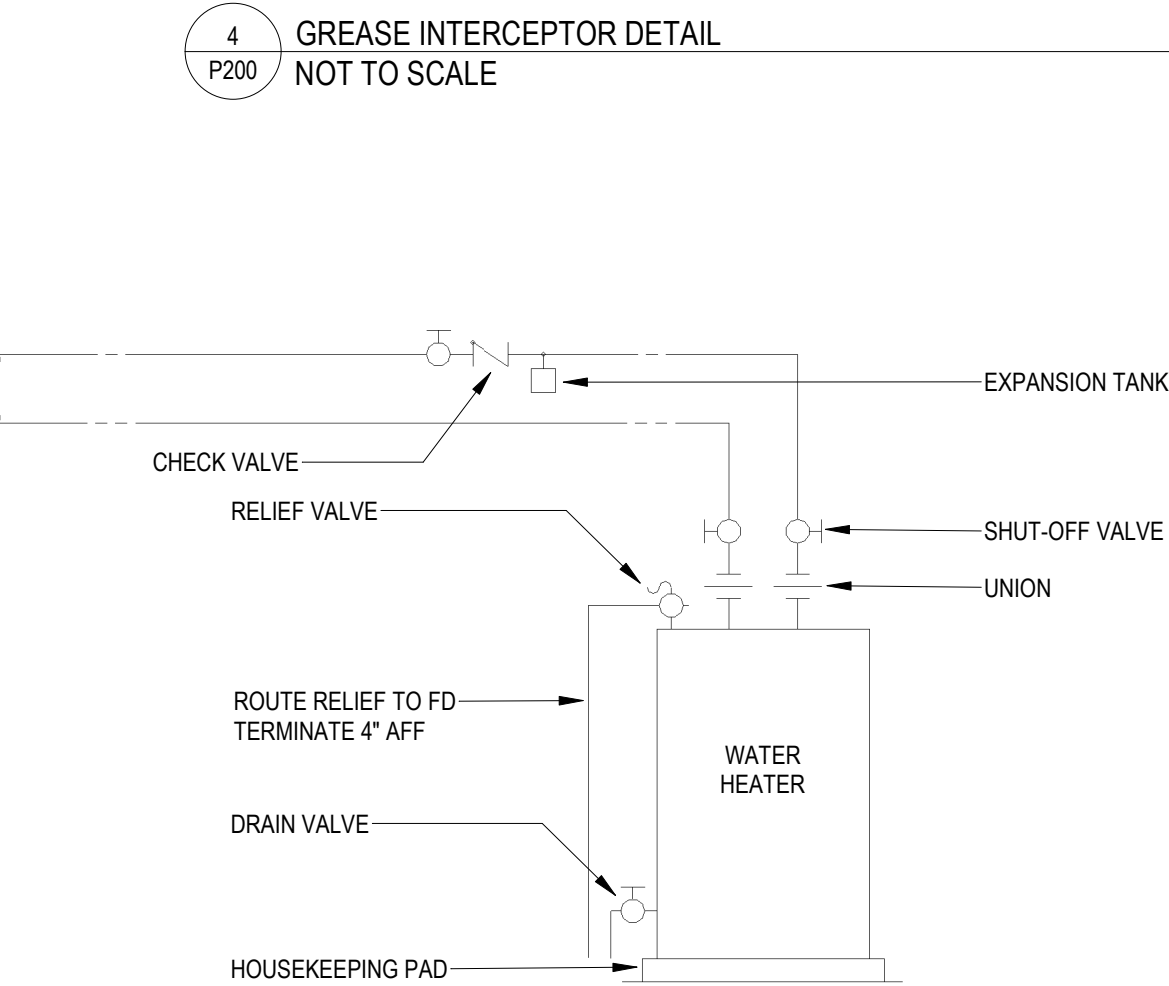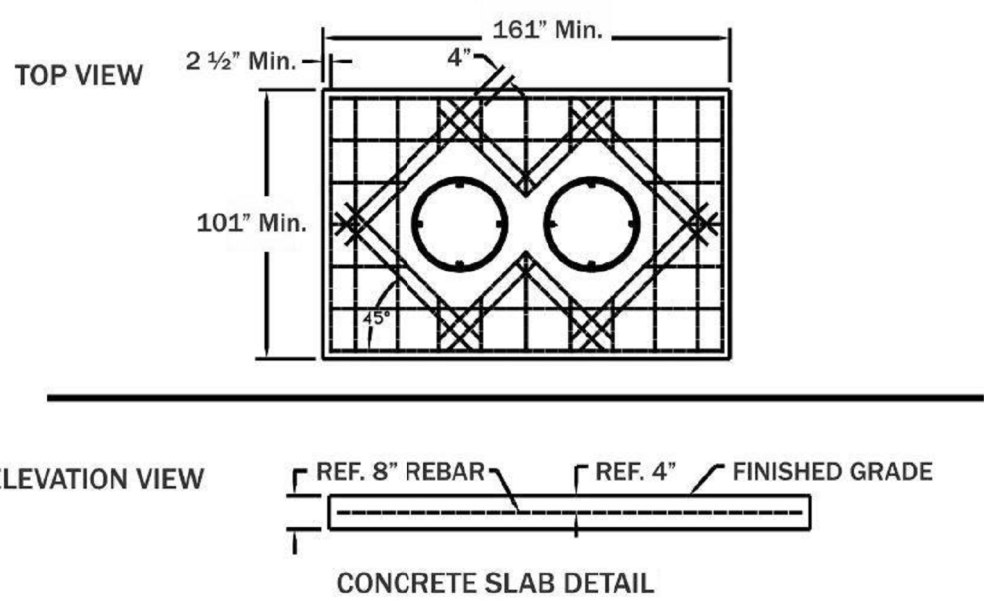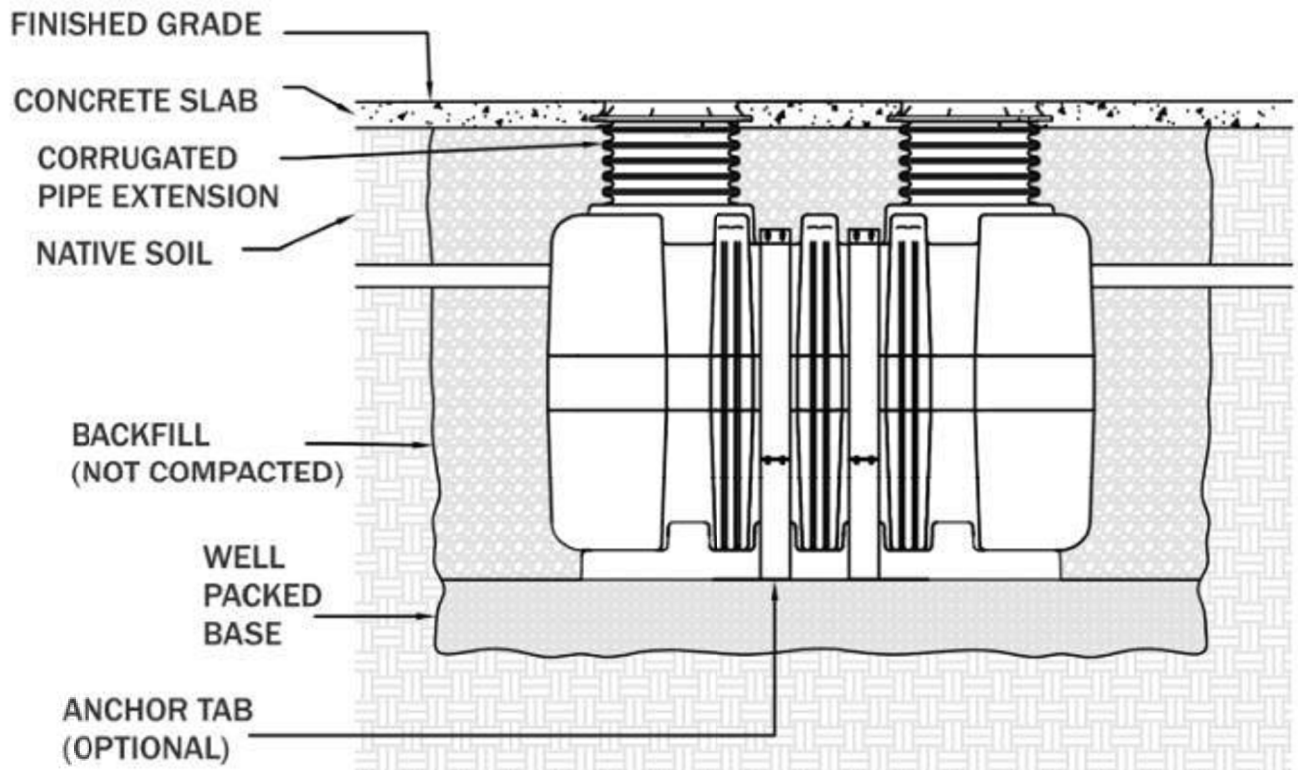

DRAINAGE FIXTURE UNIT SUMMARY						
ID	FIXTURE DESCRIPTION	QTY	WASTE SIZE	DFU DEMAND UNIT	DFU DEMAND TOTAL	
EWC-2	WATER COOLER - DUAL HEIGHT	3	1 1/4"	0.5	1.5	
FD-2	FLOOR DRAIN	1	3"	6	6	
FS-1	FLOOR SINK	2	4"	6	12	
HS-1	HAND SINK	1	2"	2	2	
HS-3	HAND SINK	2	2"	2	4	
JS-1	JANITOR SINK	1	3"	3	3	
LAV-1	LAVATORY - WALL HUNG	1	1 1/2"	1	1	
LAV-2	LAVATORY - COUNTER	5	2"	1	5	
OB-7	WASHING MACHINE OUTLET BOX	1	2"	3	3	
SH-1A	SHOWER STALL - ADA	2	2"	2	4	
SK-3	3-COMPARTMENT SINK	1	2"	4	4	
U-1	URINAL	3	2"	2	6	
WC-3	WATER CLOSET - FLOOR - TANK TYPE	4	4"	4	16	
WC-3A	WATER CLOSET - FLOOR - PRESSURE ASSISTED TANK TYPE - ADA	3	3"	4	12	
Grand total: 30						79.5

WATER SUPPLY FIXTURE UNIT SUMMARY											
ID	FIXTURE DESCRIPTION	QTY	PIPE SIZE	DFU DEMAND UNIT	DFU DEMAND TOTAL	CWFU DEMAND UNIT	CWFU DEMAND TOTAL	HWFU DEMAND UNIT	HWFU DEMAND TOTAL	WSFU DEMAND UNIT	WSFU DEMAND TOTAL
EWC-2	WATER COOLER - DUAL HEIGHT	3	1/2"	0.5	1.5	0.5	1.5	0	0	0.5	1.5
HS-1	HAND SINK	1	1/2"	1/2"	2	1.125	1.125	1.125	1.125	1.5	1.5
HS-3	HAND SINK	2	1/2"	1/2"	2	4	1.125	2.25	1.125	2.25	3
JS-1	JANITOR SINK	1	3/4"	3/4"	3	3	2.25	2.25	2.25	3	3
LAV-1	LAVATORY - WALL HUNG	1	1/2"	1/2"	1	1	0.75	0.75	0.75	1	1
LAV-2	LAVATORY - COUNTER	5	1/2"	1/2"	1	5	0.75	3.75	0.75	3.75	1
OB-5	ICE MAKER OUTLET BOX	1	1/2"	1/2"	0	0	0.5	0.5	0	0	0.5
OB-7	WASHING MACHINE OUTLET BOX	1	1/2"	1/2"	3	3	3	3	3	3	4
SH-1A	SHOWER STALL - ADA	2	1/2"	1/2"	2	4	1.5	3	1.5	3	2
SK-3	3-COMPARTMENT SINK	1	1/2"	1/2"	4	4	1.5	1.5	1.5	1.5	2
U-1	URINAL	3	3/4"		2	6	4	12	0	0	4
WC-3	WATER CLOSET - FLOOR - TANK TYPE	4	1/2"		4	16	2.5	10	0	0	2.5
WC-3A	WATER CLOSET - FLOOR - PRESSURE ASSISTED TANK TYPE - ADA	3	1/2"		4	12	2.5	7.5	0	0	2.5
Grand total: 28										61.5	49.125

ARCHITECT

RON W. WEBB
1659 W. HANRAHAN ROAD
AYDEN, NC. 28513
TEL: (252) 531-2711


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120 SOMMERVILLE PARK ROAD
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12/09/2024

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Revisions

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Drawing No.
PLUMBING DETAILS AND SCHEDULES

P200

of

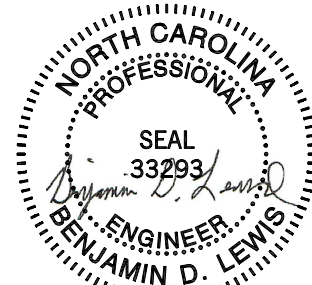RON W. WEBB
1659 W. HANRAHAN ROAD
AYDEN, NC. 28513
TEL: (252) 531-2711


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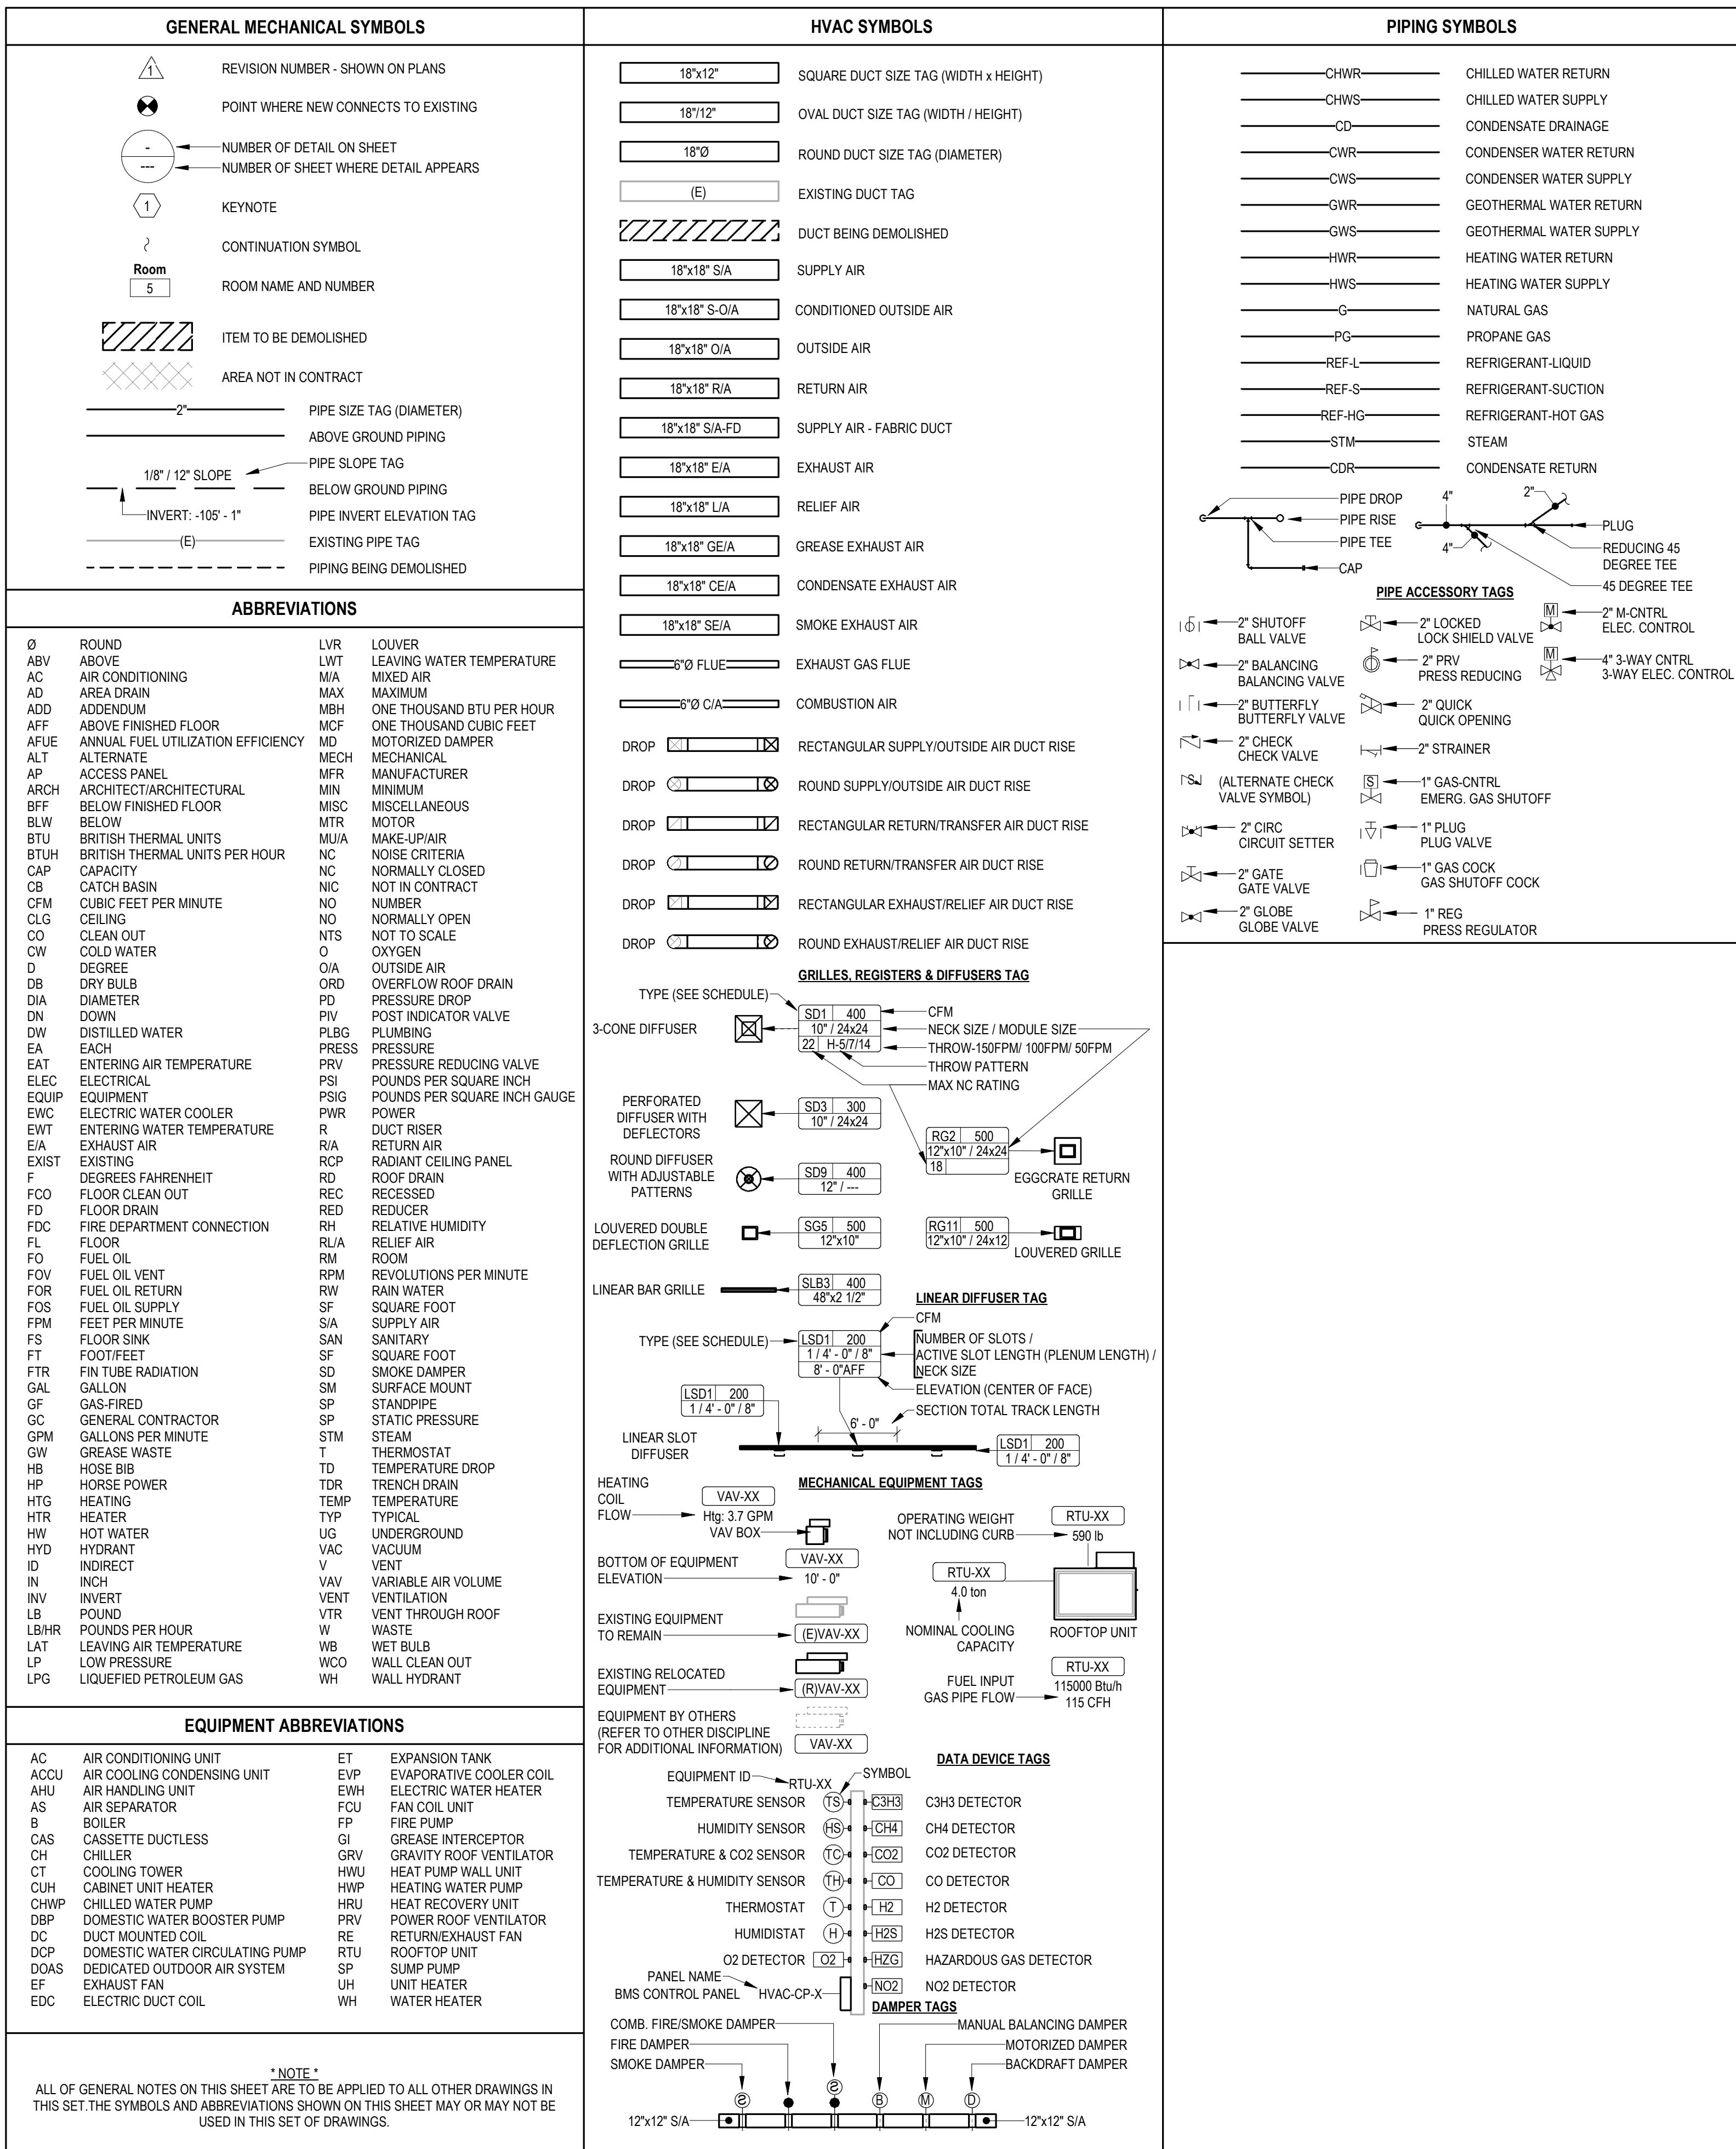
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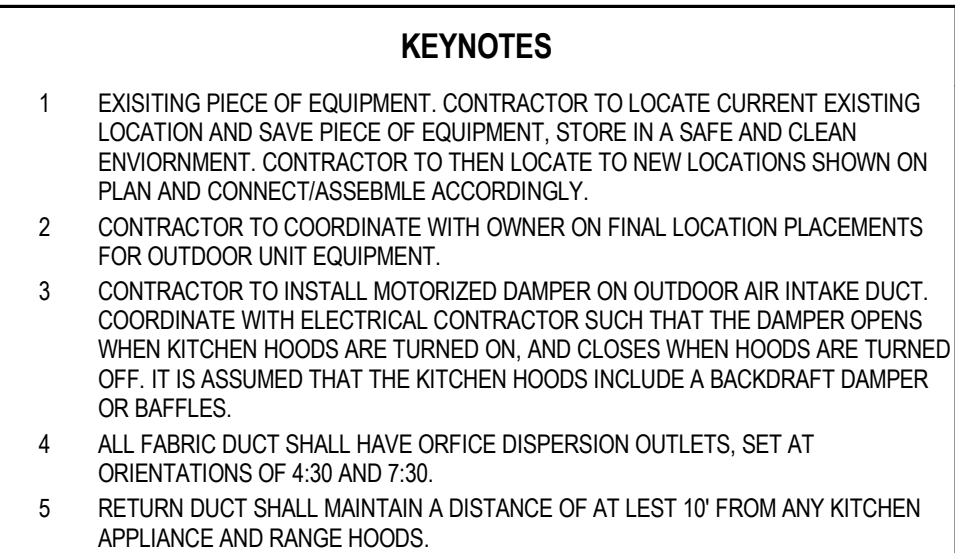
Drawing No.

HVAC TITLE SHEET

M000

of



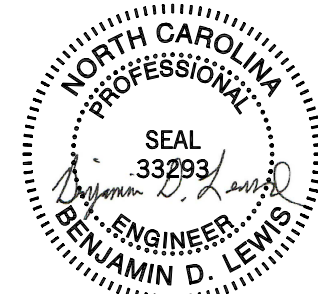

RON W. WEBB
1659 W. HANRAHAN ROAD
AYDEN, NC. 28513
TEL: (252) 531-2711

145 PROSPECT CHURCH RD
ERWIN, NC 28339



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GROUP, INC.

120 SOMMERVILLE PARK ROAD
RALEIGH, NC 27603
NC FIRM # C-3824



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Revisions

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Drawing No.

HVAC FLOOR PLAN

M101

2018 NC MECHANICAL CODE - VENTILATION CALCULATIONS

ROOM NAME	OCCUPANCY CLASS	AREA (Az)	OCCUPANCY DENSITY (PEOPLE / 1000 FT^2)	OCCUPANCY (Pz)	OCCUPANCY BASED		AREA BASED		BREATHING ZONE OUTDOOR AIRFLOW (Vb = Rp*Pz + Ra*Az)	ZONE AIR DISTRIBUTION EFFECTIVENESS	ZONE OUTDOOR AIRFLOW (Voz = Vbz / Ez)	EXHAUST RATE (CFM)
					CFM / PERSON (Rp)	CFM (Rp*Pz)	CFM / SF (Ra)	CFM (Ra*Az)				
MULTI PURPOSE	SPORTS (PLAY AREA)	4969	0	0	0	0	0.3	1490.7	1490.7	0.8	1864	0
REAR CORRIDOR	PUBLIC SPACES (CORRIDORS)	336	0	0	0	0	0.06	20.16	20.16	0.8	26	0
MAIN CORRIDOR	PUBLIC SPACES (CORRIDORS)	498	0	0	0	0	0.06	29.88	29.88	0.8	38	0
REAR LOBBY	PUBLIC SPACES (CORRIDORS)	158	0	0	0	0	0.06	9.48	9.48	0.8	12	0
TOTALS ----->		5961		0							1940	0

OUTDOOR AIR INTAKE FLOW RATE:	1940
EXHAUST FLOW RATE PLUS 8% FOR PRESSURIZATION	0
FINAL VENT. AIR REQUIREMENT (GREATER OF THE ABOVE):	1940

BALANCE RTU-1 TO PROVIDE 870 CFM OF OUTSIDE AIR.
BALANCE RTU-2 TO PROVIDE 870 CFM OF OUTSIDE AIR.
BALANCE AHU-1 TO PROVIDE 360 CFM OF OUTSIDE AIR.

2018 NC MECHANICAL CODE - VENTILATION CALCULATIONS

ROOM NAME	OCCUPANCY CLASS	AREA (Az)	OCCUPANCY DENSITY (PEOPLE / 1000 FT^2)	OCCUPANCY (Pz)	OCCUPANCY BASED		AREA BASED		BREATHING ZONE OUTDOOR AIRFLOW (Vb = Rp*Pz + Ra*Az)	ZONE AIR DISTRIBUTION EFFECTIVENESS	ZONE OUTDOOR AIRFLOW (Voz = Vbz / Ez)	EXHAUST RATE (CFM)
					CFM / PERSON (Rp)	CFM (Rp*Pz)	CFM / SF (Ra)	CFM (Ra*Az)				
JANITOR/STORAGE	ASHRAE62.1-2019-JC	115	0	0	10	0	0	0	0	0.8	0	115
STORAGE	RETAIL STORES (STORAGE ROOMS)	208	0	0	0	0	0.06	12.48	12.48	0.8	16	0
MULTIMEDIA	EDUCATION (MEDIA CENTER)	134	25	4	10	40	0.12	16.08	56.08	0.8	71	0
SECURITY	CORRECTIONAL (GUARD STATIONS)	208	15	4	5	20	0.06	12.48	32.48	0.8	41	0
LOBBY	OFFICES (MAIN ENTRY LOBBY)	290	10	3	5	15	0.06	17.4	32.4	0.8	41	0
TOTALS ----->		955		11							169	115

OUTDOOR AIR INTAKE FLOW RATE:	169
EXHAUST FLOW RATE PLUS 8% FOR PRESSURIZATION	124.2
FINAL VENT. AIR REQUIREMENT (GREATER OF THE ABOVE):	169

BALANCE AHU-2 TO PROVIDE 340 CFM OF OUTSIDE AIR

2018 NC MECHANICAL CODE - VENTILATION...

ROOM NAME	OCCUPANCY CLASS	AREA (Az)	OCCUPANCY DENSITY (PEOPLE / 1000 FT^2)	OCCUPANCY (Pz)	OCCUPANCY BASED		AREA BASED		BREATHING ZONE OUTDOOR AIRFLOW (Vb = Rp*Pz + Ra*Az)	ZONE AIR DISTRIBUTION EFFECTIVENESS	ZONE OUTDOOR AIRFLOW (Voz = Vbz / Ez)	EXHAUST RATE (CFM)
					CFM / PERSON...	CFM...	CFM / SF...	CFM...				
WOMEN'S BR	PUBLIC SPACES (TOILET...	305	0	0	0	0	0	0	0	0.8	0	200
MEN'S BR	PUBLIC SPACES (TOILET...	292	0	0	0	0	0	0	0	0.8	0	200
CLASSROOM	EDUCATION (CLASSROOM...	603	35	22	7.5	165	0	0	165	0.8	207	0
CLASSROOM	EDUCATION (CLASSROOM...	603	35	22	7.5	165	0	0	165	0.8	207	0
TOTALS ----->		1803		0							414	400

OUTDOOR AIR INTAKE FLOW RATE:	414
EXHAUST FLOW RATE PLUS 8% FOR PRESSURIZATION	432
FINAL VENT. AIR REQUIREMENT (GREATER OF THE ABOVE):	432

BALANCE RTU-5 TO PROVIDE CFM OF OUTSIDE AIR

2018 NC MECHANICAL CODE - VENTILATION...

ROOM NAME	OCCUPANCY CLASS	AREA (Az)	OCCUPANCY DENSITY (PEOPLE / 1000 FT^2)	OCCUPANCY (Pz)	OCCUPANCY BASED		AREA BASED		BREATHING ZONE OUTDOOR AIRFLOW (Vb = Rp*Pz + Ra*Az)	ZONE AIR DISTRIBUTION EFFECTIVENESS	ZONE OUTDOOR AIRFLOW (Voz = Vbz / Ez)	EXHAUST RATE (CFM)
					CFM / PERSON...	CFM...	CFM / SF...	CFM...				
CLASSROOM	EDUCATION (CLASSROO...	243	35	9	7.5	67.5	0	0	67.5	0.8	85	0
CLASSROOM	EDUCATION (CLASSROO...	243	35	9	7.5	67.5	0	0	67.5	0.8	85	0
CLASSROOM	EDUCATION (CLASSROO...	238	35	9	7.5	67.5	0	0	67.5	0.8	85	0
FAMILY	EDUCATION (DAY CARE)	77	25	2	10	20	0.18	13.86	33.86	0.8	43	0
PANTRY	ASHRAE 62.1-2019...	135	2	1	5	5	0.06	8.1	13.1	0.8	17	0
KITCHEN	FOOD & BEVERAGE...	520	0	0	0	0	0	0	0	0.8	0	364
TOTALS ----->		1456		30							315	364

OUTDOOR AIR INTAKE FLOW RATE:	315
EXHAUST FLOW RATE PLUS 8% FOR PRESSURIZATION	393.12
FINAL VENT. AIR REQUIREMENT (GREATER OF THE ABOVE):	394

BALANCE RTU-6 TO PROVIDE CFM OF OUTSIDE AIR

ARCHITECT

RON W. WEBB
1659 W. HANRAHAN ROAD
AYDEN, NC. 28513
TEL: (252) 531-2711


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145 PROSPECT CHURCH RD
ERWIN, NC 28339

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120 SOMMERVILLE PARK ROAD
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Revisions

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Drawing No.

HVAC SCHEDULES

M301

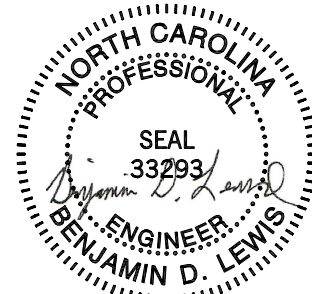of

ARCHITECT

RON W. WEBB
1659 W. HANRAHAN ROAD
AYDEN, NC. 28513
TEL: (252) 531-2711

WEBB MT
PISGAH

145 PROSPECT CHURCH RD
ERWIN, NC 28339

PROJECT CONSULTANTS



120 SOMMERVILLE PARK ROAD
RALEIGH, NC 27603
NC FIRM # C-3824



2018 APPENDIX B BUILDING CODE SUMMARY FOR ALL COMMERCIAL PROJECTS MECHANICAL DESIGN (PROVIDE ON THE MECHANICAL SHEETS IF APPLICABLE)	
MECHANICAL SUMMARY	
MECHANICAL SYSTEMS, SERVICE SYSTEMS AND EQUIPMENT	
Thermal Zone	3A winter dry bulb: <u>22 F</u> summer dry bulb: <u>96 F</u>
Interior design conditions	
	winter dry bulb: <u>68 F</u> summer dry bulb: <u>78 F</u> relative humidity: <u>50%</u>
Building heating load:	<u>107,500 BTU</u>
Building cooling load:	<u>489,000 BTU</u>
Mechanical Spacing Conditioning System	
Unitary	SEE PLANS
description of unit:	<u> </u>
heating efficiency:	<u> </u>
cooling efficiency:	<u> </u>
size category of unit:	<u> </u>
Boiler	
Size category. If oversized, state reason.	<u> N/A </u>
Chiller	
Size category. If oversized, state reason.	<u> N/A </u>
List equipment efficiencies: _____	

MECHANICAL SYSTEMS, SERVICE SYSTEMS AND EQUIPMENT

Thermal Zone 3A
winter dry bulb: 22 F
summer dry bulb: 96 F

Interior design conditions

winter dry bulb: 68 F

summer dry bulb: 78 F

relative humidity: 50%

Building heating load: 107,500 BTU

Building cooling load: 489,000 BTU

Mechanical Spacing Conditioning System

Unitary	SEE PLANS
description of unit:	_____
heating efficiency:	_____
cooling efficiency:	_____
size category of unit:	_____

Boiler

Chiller

Size category. If oversized, state reason.: _____

List equipment efficiencies: _____

PACKAGED ROOFTOP UNIT SCHEDULE																							
ID	DESCRIPTION	MANUFACTURER	MODEL NO.	QTY	ARRANGEMENT	SUPPLY AIR	OUTSIDE AIR	EXHAUST AIRFLOW	SECONDARY FAN INCLUDE POWER EXHAUST	COMPRESSOR REFRIGERANT		SEER	EER	UNIT DIMENSIONS			UNIT WEIGHT	FLA	MCA	MOCp	VOLT	PH	REMARKS
						FLOW	FLOW			TYPE	CHARGE			LENGTH	WIDTH	HEIGHT							
RTU-1	ROOFTOP UNIT	CARRIER	50FCQM12A55-QA0A0	1	HORIZONTAL	4000 CFM	870 CFM	795 CFM	Yes	R-410A	21 lb	14.3	11	7' - 4 1/8"	4' - 11 1/2"	4' - 1 3/8"	955 lb	21.7 A	86.0 A	90.0 A	208 V	3	PROVIDE 10KW OF AUXILIARY HEAT. EQUAL OR EQUIVALENT IS ACCEPTABLE.
RTU-2	ROOFTOP UNIT	CARRIER	50FCQM12A55-QA0A0	1	HORIZONTAL	4000 CFM	870 CFM	795 CFM	Yes	R-410A	21 lb	14.3	11	7' - 4 1/8"	4' - 11 1/2"	4' - 1 3/8"	955 lb	21.7 A	86.0 A	90.0 A	208 V	3	PROVIDE 10KW OF AUXILIARY HEAT. EQUAL OR EQUIVALENT IS ACCEPTABLE.

ELECTRIC UNIT HEATER SCHEDULE																					
ID	MANUFACTURER	MODEL NO.	QTY	TYPE	ARRANGEMENT	ELECTRIC HEATING COIL			HEATING ELEMENT			UNIT DIMENSIONS			AFF ELEVATION	UNIT WEIGHT	FLA	VOLT	PH	REMARKS	
						CAP	AIRSIDE			QTY	POWER	SCR	LENGTH	WIDTH							HEIGHT
							DESIGN FLOW	EAT(db)	LAT(db)												
EUH-1	BERKO	FRC	1	CABINET	RECESSED MOUNT	5118 Btu/h	100 CFM	55.0 °F	102.4 °F	1	1.5 kW	No	3 7/8"	1' - 2 5/16"	1' - 6 1/4"	1' - 0"	25 lb	12.5 A	120 V	1	

SPLIT SYSTEM AIR SOURCE HEAT PUMP																			
ID	MANUFACTURER	MODEL NO.	QTY	NOMINAL COOLING CAP	COMPRESSOR REFRIGERANT TYPE	EER	UNIT DIMENSIONS			UNIT WEIGHT	FLA	MCA	MOCp	VOLT	PH	FREQ	INTERLOCK	REMARKS	
							LENGTH	WIDTH	HEIGHT										
CJ-1	UNKNOWN	UNKNOWN	1	4.00 ton	-	0	2' - 10 1/4"	3' - 1 1/4"	3' - 9 1/8"	0 lb	0.0 A	0.0 A	15.0 A	0 V	0	0 Hz	AH-1	EXISTING EQUIPMENT ON SITE.	
CJ-2	UNKNOWN	UNKNOWN	1	4.00 ton	-	0	2' - 10 1/4"	3' - 1 1/4"	3' - 9 1/8"	0 lb	0.0 A	0.0 A	15.0 A	0 V	0	0 Hz	AH-2	EXISTING EQUIPMENT ON SITE.	
CJ-3	CARRIER	38AUQM07A0A5	1	6.00 ton	R-410A	11	4' - 11 13/32"	3' - 9 29/32"	3' - 6 3/8"	444 lb	20.0 A	25.0 A	30.0 A	208 V	3	60 Hz	AHU-3		
CJ-4	CARRIER	38AUQM07A0A5	1	6.00 ton	R-410A	11	4' - 11 13/32"	3' - 9 29/32"	3' - 6 3/8"	444 lb	20.0 A	25.0 A	30.0 A	208 V	3	60 Hz	AHU-4		
HP-1	CARRIER	38MARBQ09A3	1	0.75 ton	R-410A	16.2	11 15/16"	2' - 6 1/8"	1' - 9 13/16"	75 lb	0.0 A	15.0 A	15.0 A	208 V	1	60 Hz	HWU-1		

AIR HANDLING UNIT SUMMARY SCHEDULE																			
ID	MANUFACTURER	MODEL NO.	QTY	VENTILATION	SUPPLY FAN	RETURN/EXHAUST FAN	NET COOLING CAP	UNIT DIMENSIONS			UNIT WEIGHT	FLA	MCA	MOCp	VOLT	PH	INTERLOCK	REMARKS	
				DESIGN AIRFLOW	DESIGN AIRFLOW	AIRFLOW DESIGN		LENGTH	WIDTH	HEIGHT							CONDENSING UNIT ID		
AHU-1	UNKNOWN	UNKNOWN	1	360 CFM	1600 CFM	1240 CFM	0 Btuh	0"	0"	0"	0 lb	0.0 A	0.0 A	0.0 A	0 V	0		EXISTING EQUIPMENT ON SITE.	
AHU-2	UNKNOWN	UNKNOWN	1	340 CFM	1600 CFM	1260 CFM	0 Btuh	0"	0"	0"	0 lb	0.0 A	0.0 A	0.0 A	0 V	0		EXISTING EQUIPMENT ON SITE.	
AHU-3	Carrier	40RFQAO7A2A5	1	550 CFM	2400 CFM	1850 CFM	72000 Btuh	4' - 1"	2' - 4 3/16"	4' - 8 1/16"	380 lb	6.4 A	8.0 A	15.0 A	208 V	3	CU-3	PROVIDE SKW OF AUXILIARY HEAT.	
AHU-4	Carrier	40RFQAO7A2A5	1	600 CFM	2400 CFM	1800 CFM	72000 Btuh	4' - 1"	2' - 4 3/16"	4' - 8 1/16"	380 lb	6.4 A	8.0 A	15.0 A	208 V	3	CU-4	PROVIDE SKW OF AUXILIARY HEAT.	

FAN COIL UNIT SCHEDULE														
ID	DESCRIPTION	MANUFACTURER	MODEL NO.	QTY	ARRANGEMENT	COOLING COIL	UNIT DIMENSIONS			UNIT WEIGHT	MCA	VOLT	PH	REMARKS
						NOMINAL CAP	LENGTH	WIDTH	HEIGHT					
HWU-1	Heat Pump Indoor Unit High Wall Ductless System	Carrier Corporation	40MACB09-3	1	WALL-MOUNT	0.75 ton	Z - 8' 8"	7' 13' 16"	11' 13"2"	20 lb	0.2 A	208 V	1	POWERED FROM OUTDOOR HEAT PUMP UNIT.

EXHAUST FAN SCHEDULE																	
ID	DESCRIPTION	MANUFACTURER	MODEL NO.	QTY	TYPE	FAN		UNIT DIMENSIONS			UNIT WEIGHT	FLA	MCA	MOCp	VOLT	PH	REMARKS
						DESIGN AIRFLOW	DRIVE TYPE	LENGTH	WIDTH	HEIGHT							
EF-1	CEILING FAN	GREENHECK	SP-110-VG	1	CEILING	70 CFM	DIRECT	10 1/2"	11 3/8"	7 5/8"	12 lb	0.2 A	0.3 A	15.0 A	120 V	1	EQUAL OR EQUIVALENT IS ACCEPTABLE.
EF-2	CEILING FAN	GREENHECK	SP-110-VG	1	CEILING	70 CFM	DIRECT	10 1/2"	11 3/8"	7 5/8"	12 lb	0.2 A	0.3 A	15.0 A	120 V	1	EQUAL OR EQUIVALENT IS ACCEPTABLE.
EF-3	POWER ROOF VENTILATOR	GREENHECK	G-095	1	DOWNBLAST	650 CFM	DIRECT	1'- 5"	1'- 5"	1'- 2 5/8"	29 lb	1.5 A	1.9 A	15.0 A	208 V	1	EQUAL OR EQUIVALENT IS ACCEPTABLE.

GRILLES, REGISTERS AND DIFFUSERS SCHEDULE								
ID	MANUFACTURER	MODEL	MATERIAL	FINISH	QTY	INSTALLATION	SPECIFICATION	NOTES
						TYPE		
RD1	Titus	PAR-AA	ALUMINUM	WHITE ENAMEL	18	LAY-IN INSTALLATION	PERFORATED DIFFUSER WITH FACE MOUNTED DEFLECTORS	
RG1	Titus	350FL	ALUMINUM	WHITE ENAMEL	3	SURFACE MOUNT INSTALLATION		
SD1	Titus	TMS-AA	ALUMINUM	WHITE ENAMEL	24	LAY-IN INSTALLATION	HIGH PERFORMANCE 3-CONE DIFFUSER	
SG1	Titus	301FL	ALUMINUM	WHITE ENAMEL	3	SURFACE MOUNT INSTALLATION		

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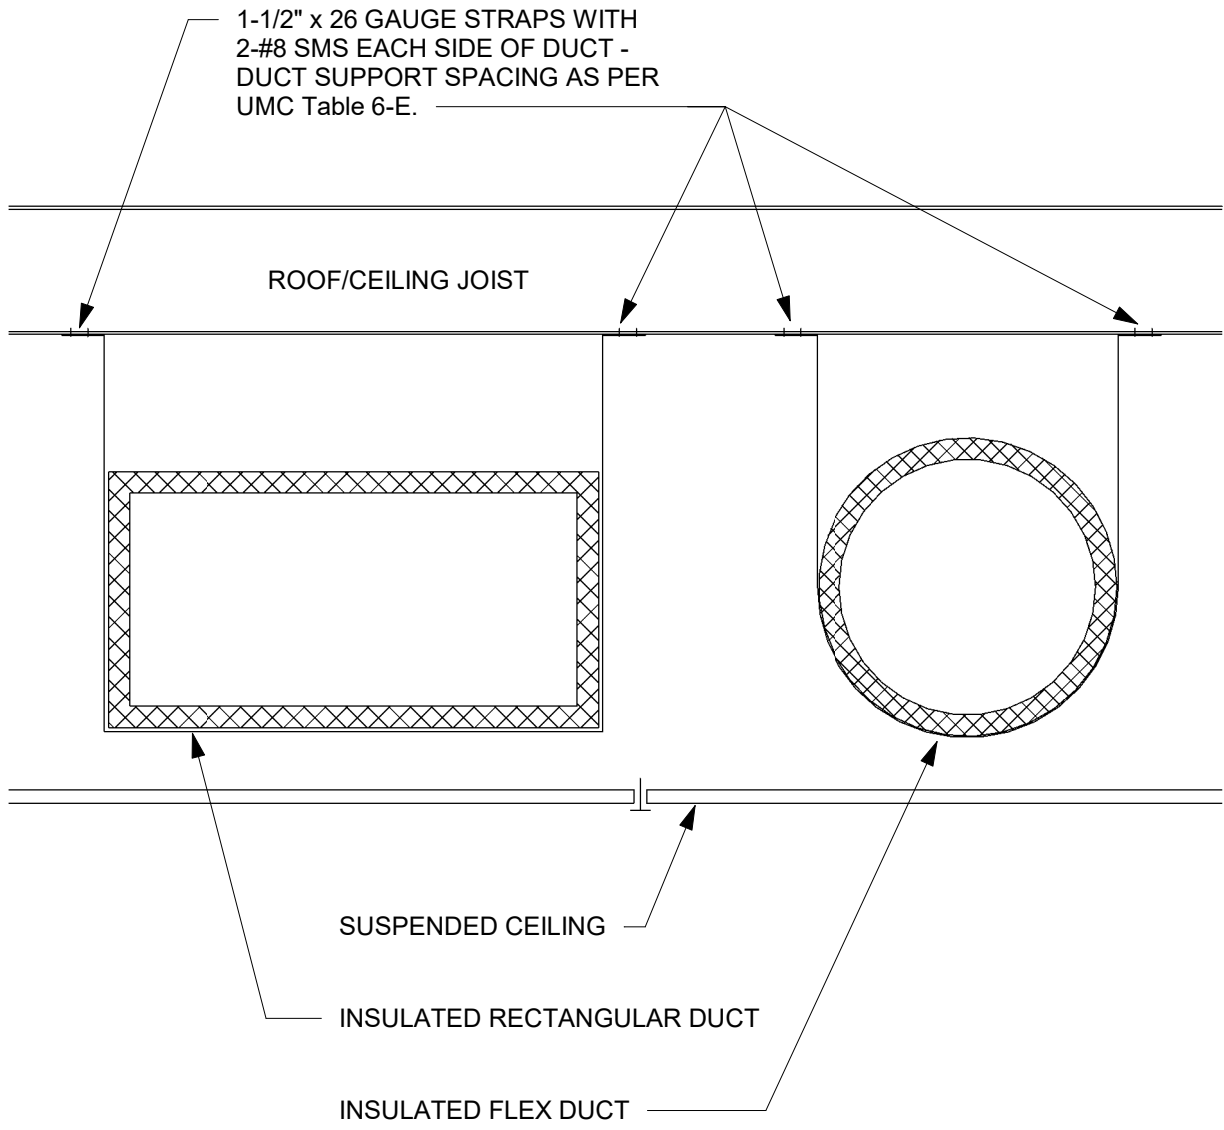
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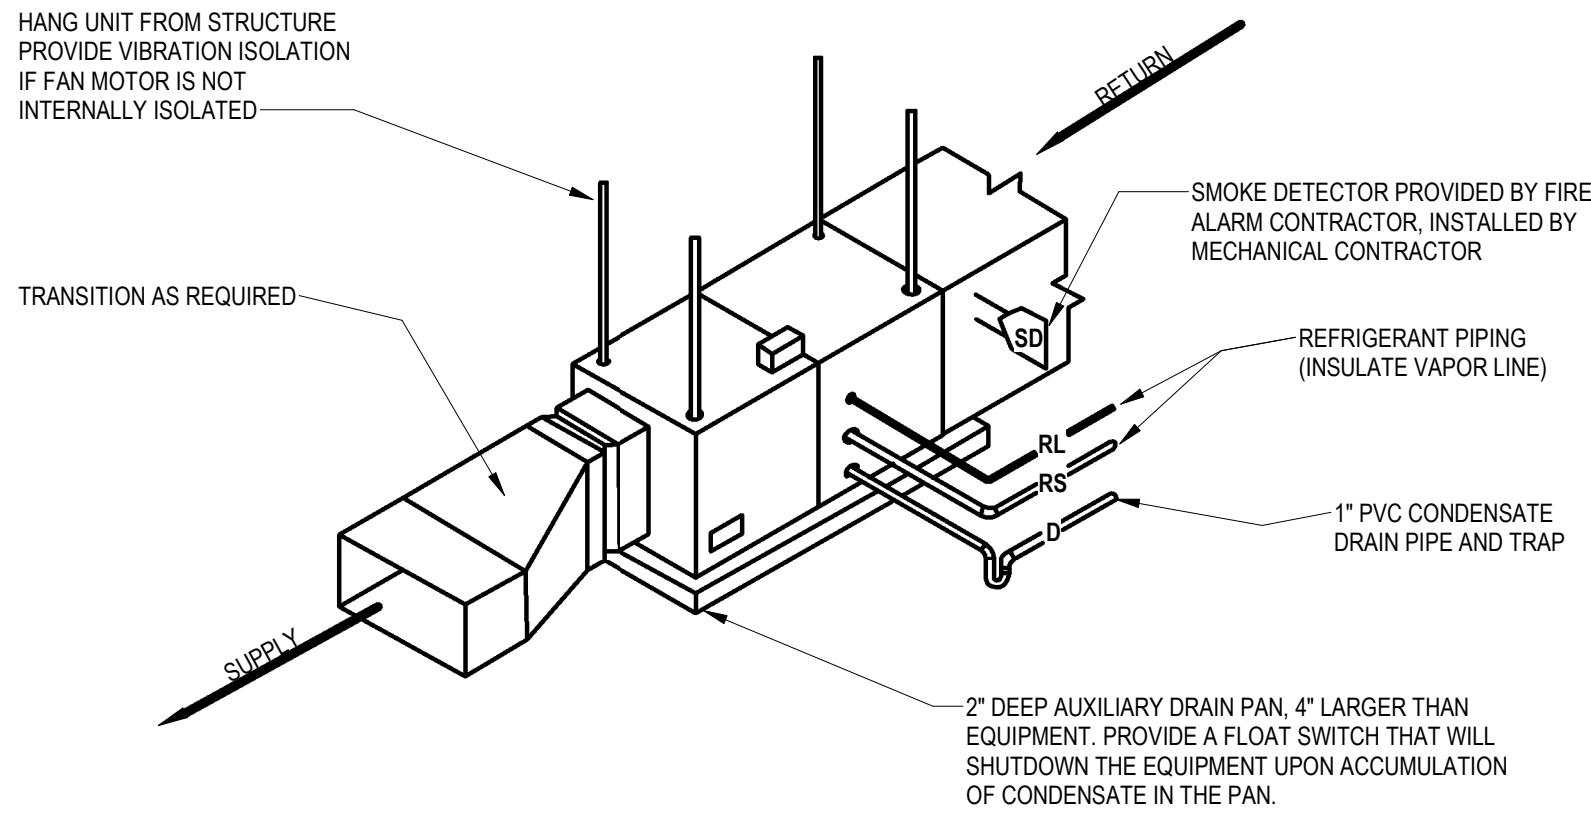
HVAC SCHEDULES

M302


of



4 DUCT SUPPORT DETAIL
M401 NOT TO SCALE




3 AHU HORIZONTAL MOUNTING
M401 NOT TO SCALE

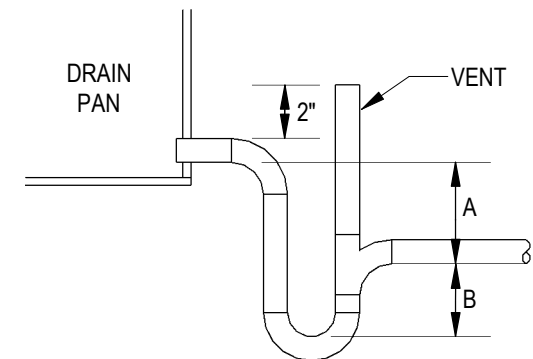


2 COOLING COIL CONDENSATE DRAIN DETAIL
M401 NO SCALE


PACKAGED ROOFTOP UNIT SHALL BE MOUNTED ON CONCRETE SLAB. SLAB SHALL BE 6" DEEP AND EXTEND 6" OVER ON EACH SIDE OF THE ROOFTOP UNIT.

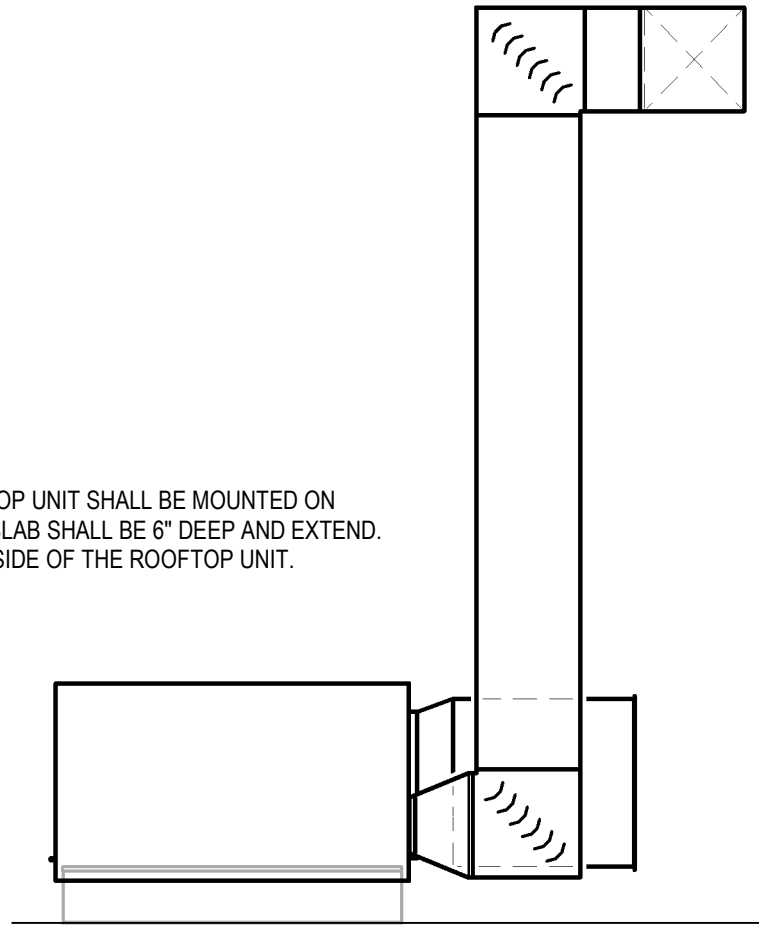


1 PACKAGED ROOFTOP UNIT DETAIL
M401 1/4" = 1'-0"

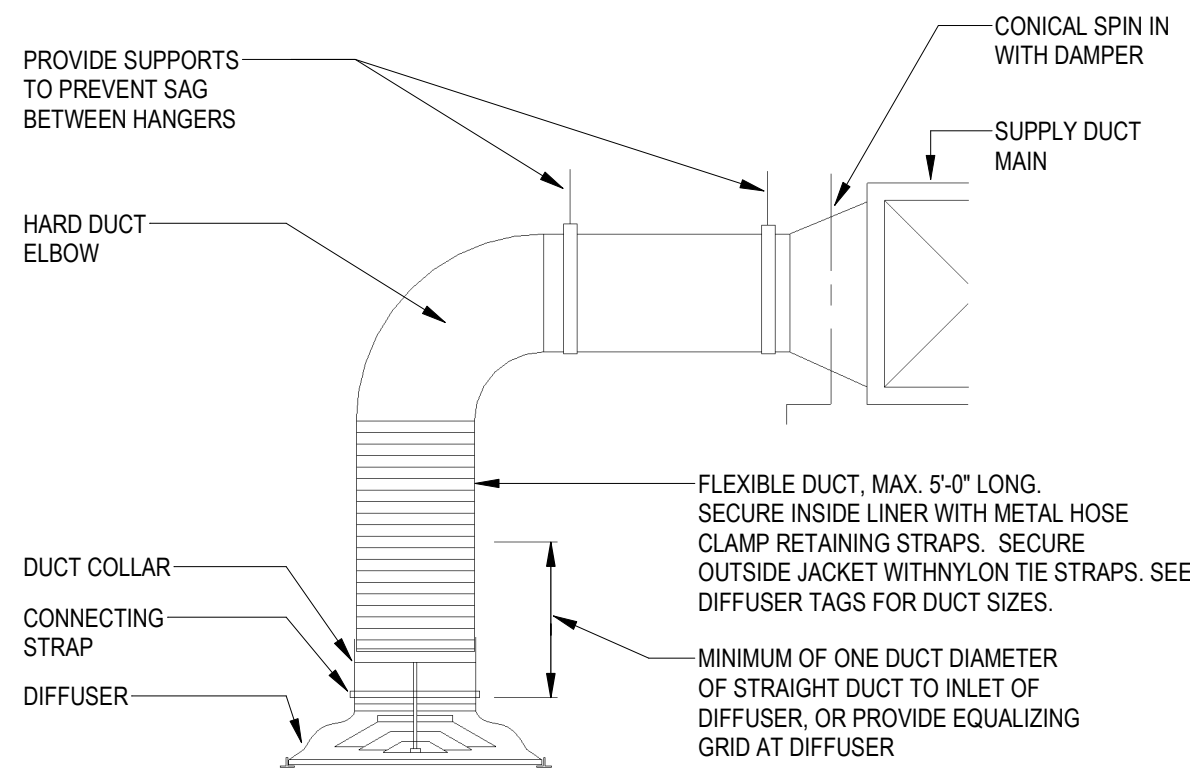


7 DIFFUSER FLEXIBLE DUCT CONNECTION
M401 NOT TO SCALE

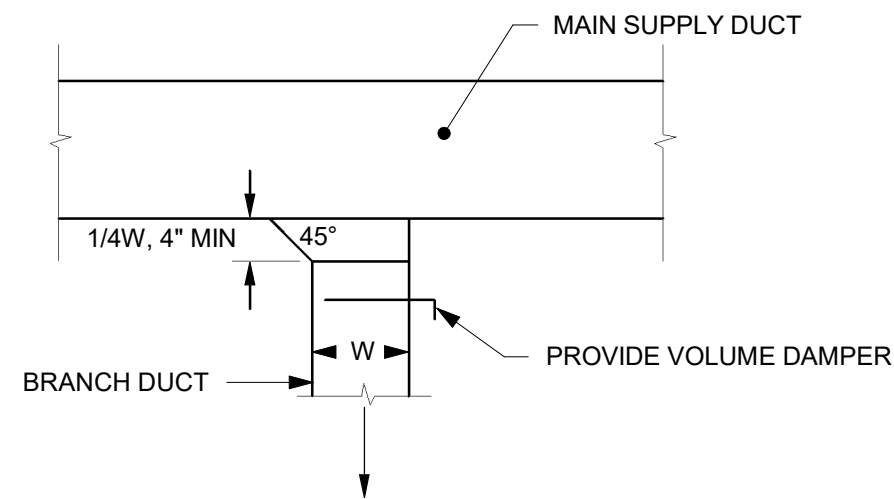


6 DUCT TAKE-OFF DETAIL
M401 NOT TO SCALE

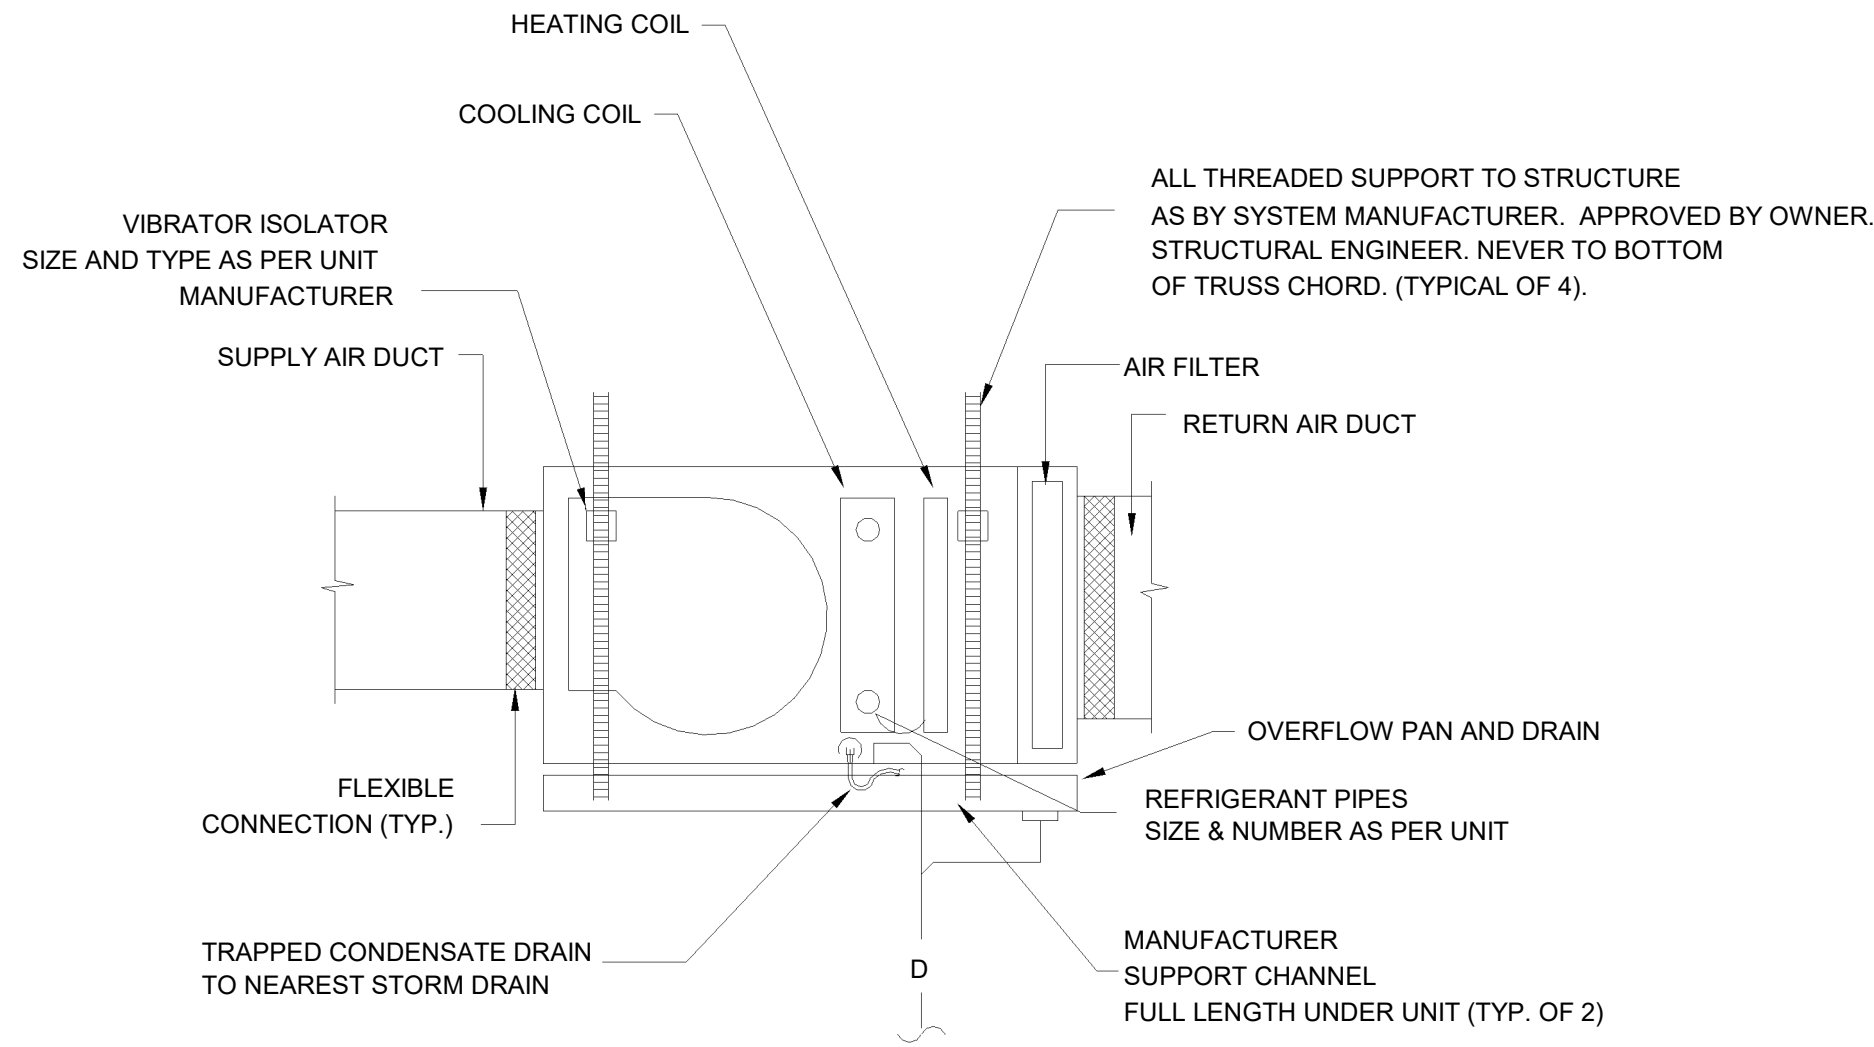


5 AHU HORIZONTAL INSTALLATION DETAIL
M401 NOT TO SCALE

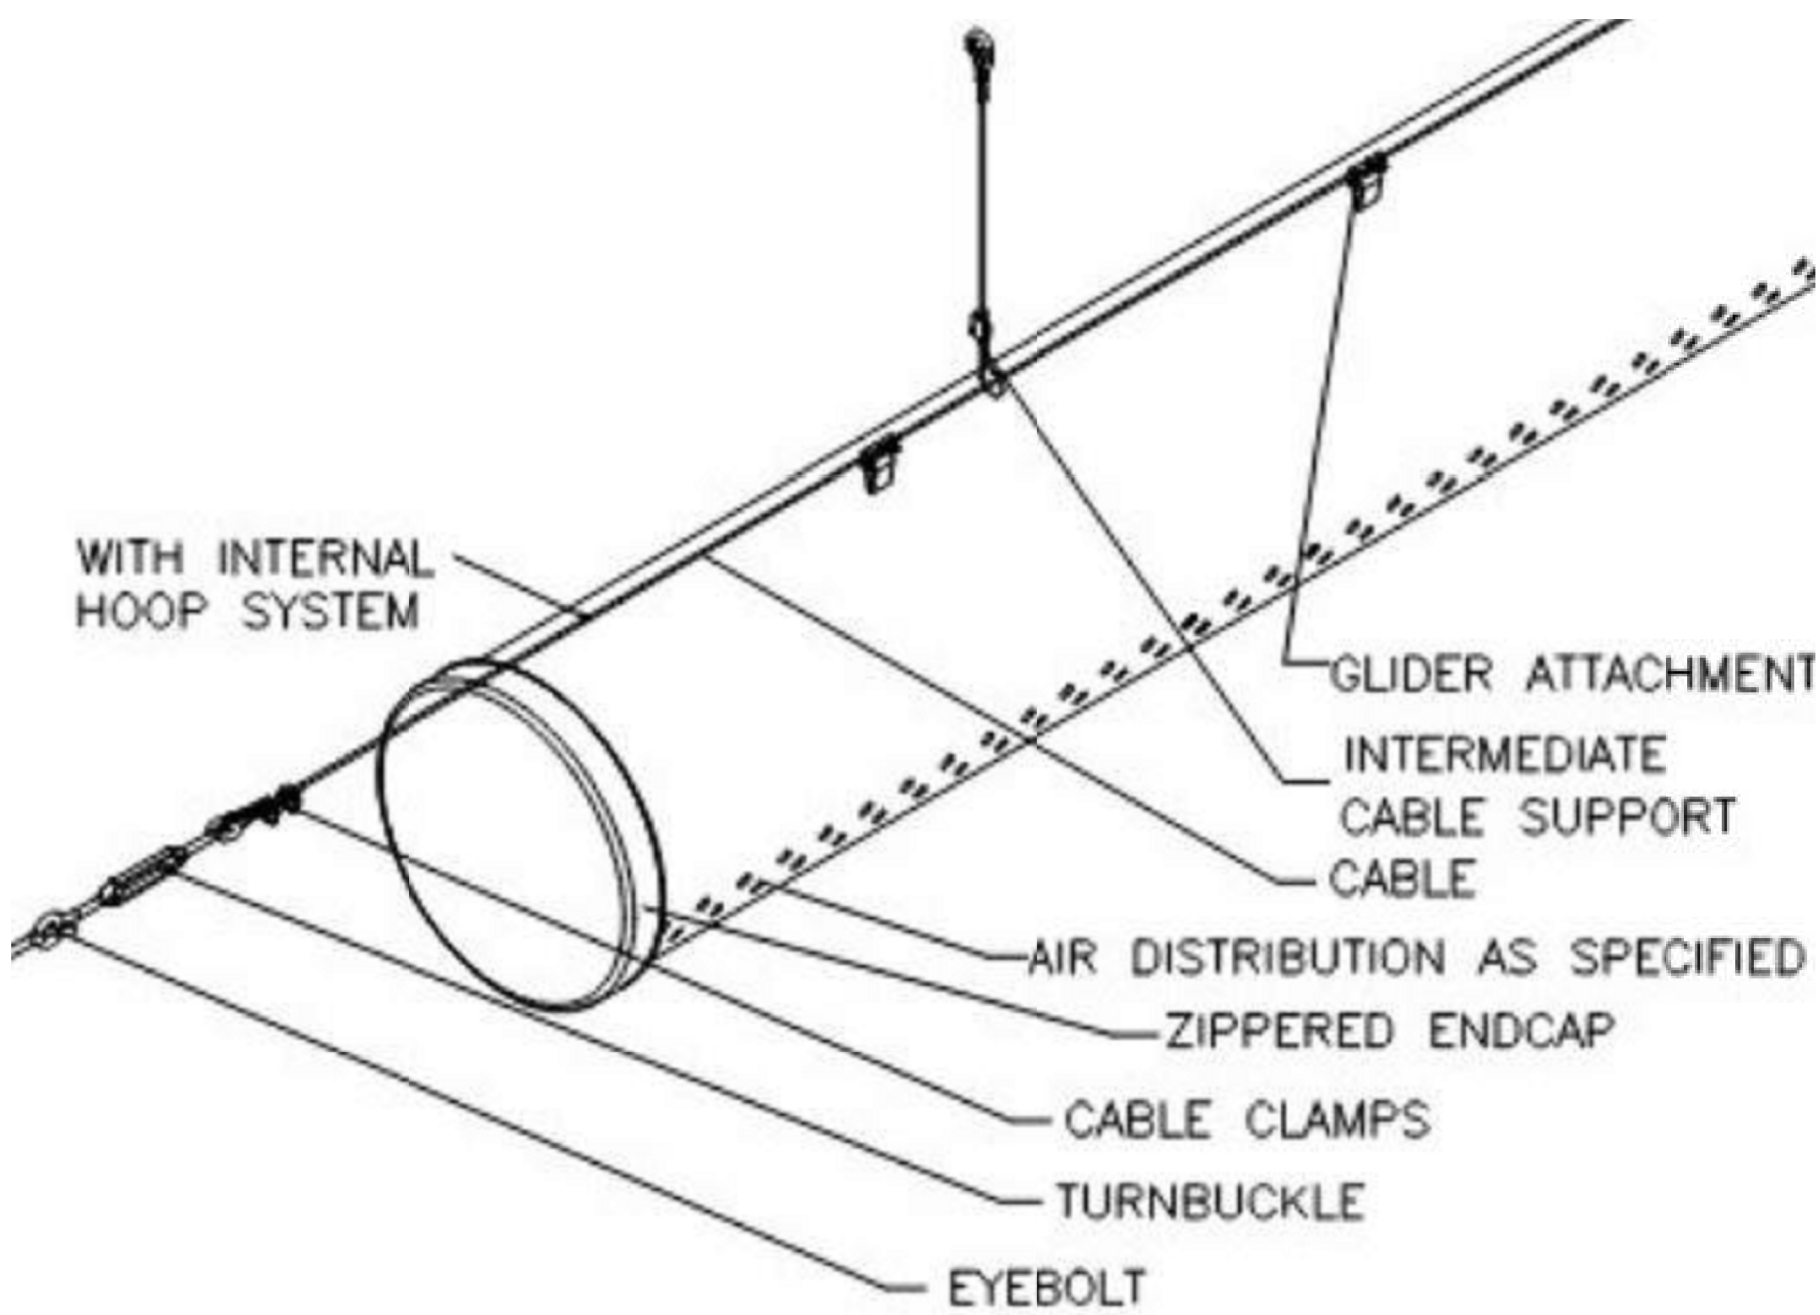


11 FABRIC DUCT SUSPENSION DETAIL
M401 NOT TO SCALE

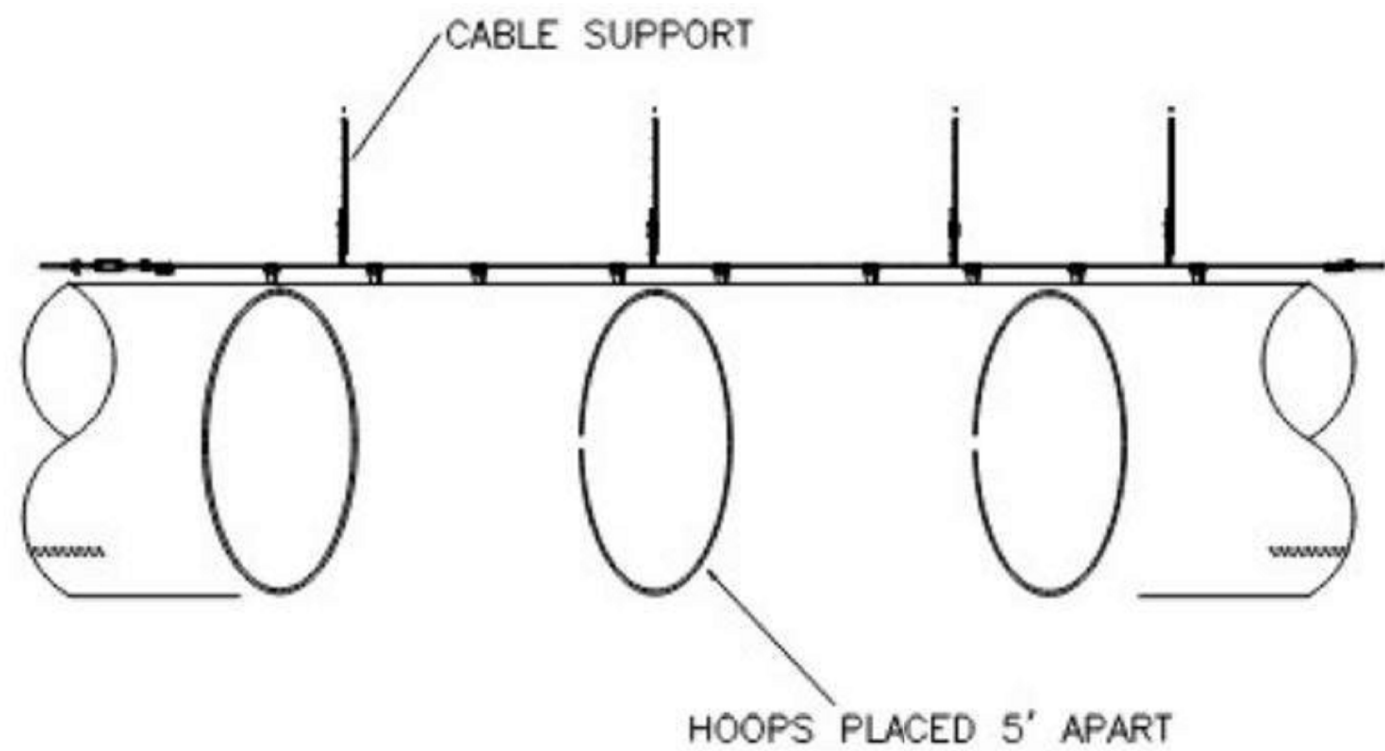

10 FABRIC DUCT HOOP SECTION DETAIL
M401 NOT TO SCALE

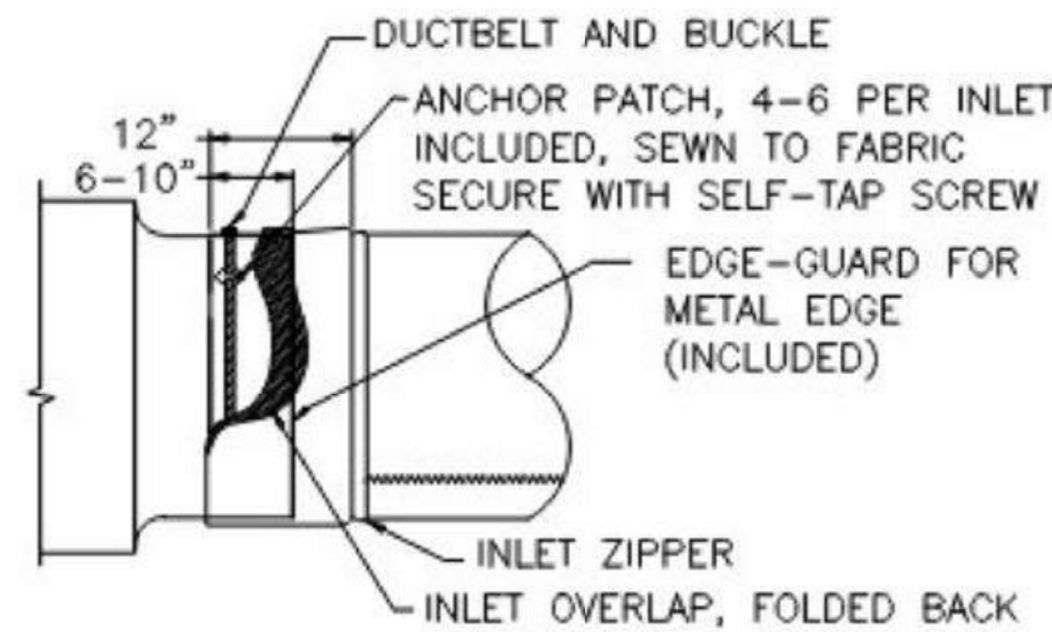

9 FABRIC DUCT INLET ATTACHMENT DETAIL
M401 NOT TO SCALE

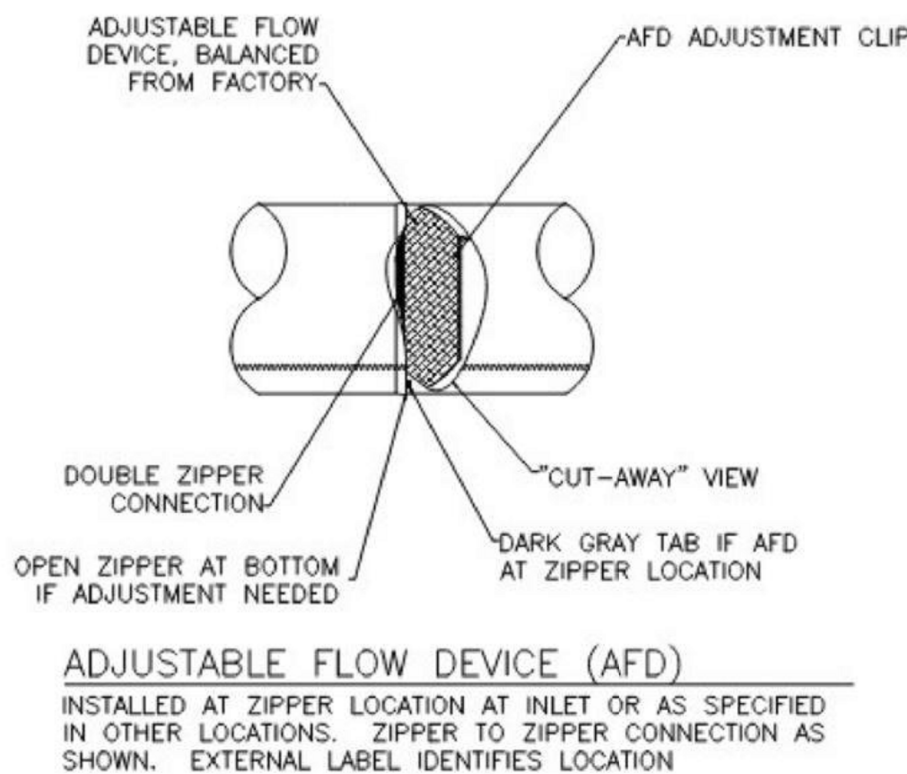

8 FABRIC DUCT ADJUSTABLE FLOW DETAIL
M401 NOT TO SCALE

ARCHITECT

RON W. WEBB
1659 W. HANRAHAN ROAD
AYDEN, NC. 28513
TEL: (252) 531-2711

WEBB MT PISGAH

145 PROSPECT CHURCH RD
ERWIN, NC 28339

PROJECT CONSULTANTS



120 SOMMERVILLE PARK ROAD
RALEIGH, NC 27603
NC FIRM # C-3824



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Drawing No.

HVAC DETAILS

M401

of

ELECTRICAL ABBREVIATIONS LIST			
1P	1 POLE (2P, 3P, 4P, ETC.)	MCB	MAIN CIRCUIT BREAKER
A	AMPERE	MCC	MOTOR CONTROL CENTER
AC	ABOVE COUNTER	MDC	MAIN DISTRIBUTION CENTER
ACLG	ABOVE CEILING	MDP	MAIN DISTRIBUTION PANEL
ADO	AUTOMATIC DOOR OPENER	MFR	MANUFACTURER
AF	AMP FRAME	MFS	MAIN FUSED DISCONNECT SW
AFB	ABOVE FINISHED FLOOR	MH	MANHOLE
AFG	ABOVE FINISHED GRADE	MIC	MICROPHONE
AFI	ARC FAULT CIRCUIT INTERRUPTER	MIN	MINIMUM
AHU	AIR HANDLING UNIT	MISC	MISCELLANEOUS
AL	ALUMINUM	MLO	MAIN LUGS ONLY
ALT	ALTERNATE	MMS	MANUAL MOTOR STARTER
AMP	AMPERE	MOA	MULTIOUTLET ASSEMBLY
AMPL	AMPLIFIER	MSP	MOTOR STARTER PANELBOARD
ANNUN	ANNUNCIATOR	MSBD	MAIN SWITCHBOARD
APPROX	APPROXIMATELY	MT	MOUNT
AQ-STAT	AQUASTAT	MT-C	EMPTY CONDUIT
ARCH	ARCHITECT, ARCHITECTURAL	MTS	MANUAL TRANSFER SWITCH
AS	AMP SWITCH	MTR	MOTOR, MOTORIZED
AT	AMP TRIP	N.C.	NORMALLY CLOSED
ATS	AUTOMATIC TRANSFER SWITCH	NEC	NATIONAL ELECTRICAL CODE
AUTO	AUTOMATIC	NEMA	NATIONAL ELECTRICAL MANUFACTURERS ASSOCIATION
AUX	AUXILIARY	NFDS	NON-FUSED SAFETY DISCONNECT SWITCH
AV	AUDIO VISUAL	NIC	NOT IN CONTRACT
AWG	AMERICAN WIRE GAUGE	NL	NIGHT LIGHT
BATT	BATTERY	N.O.	NORMALLY OPEN
BD	BOARD	NPF	NORMAL POWER FACTOR
BMS	BUILDING MANAGEMENT SYSTEM	NTS	NOT TO SCALE
C	CONDUIT	OH	OVERHEAD
CAB	CABINET	OL	OVERLOADS
CAT	CATALOG	PA	PUBLIC ADDRESS
CATV	CABLE TELEVISION	PA	PULL BOX OR PUSHBUTTON
CIR	CIRCUIT BREAKER	PE	PNEUMATIC ELECTRIC
CCTV	CLOSED CIRCUIT TELEVISION	PED	PEDESTAL
CKT	CIRCUIT	PF	POWER FACTOR
CLG	CEILING	PH	PHASE
COMB	COMBINATION	PIV	POST INDICATING VALVE
CMPR	COMPRESSOR	PNL	PANEL
CONN	CONNECTION	PP	POWER POLE
CONST	CONSTRUCTION	PR	PAIR
CONT	CONTINUATION OR CONTINUOUS	PRI	PRIMARY
CONTR	CONTRACTOR	PROJ	PROJECTION
CONV	CONVEYOR	PRV	POTENTIAL ROOF VENTILATOR
CIRC	CIRCULATING PUMP	PT	POTENTIAL TRANSFORMER
CRT	CATHODE-RAY TUBE	PVC	POLYVINYL CHLORIDE (CONDUIT)
CT	CURRENT TRANSFORMER	PWR	POWER
CTR	CENTER	QUAN	QUANTITY
CU	COPPER	RCPT	RECEPTACLE
DOP	DOMESTIC WATER CIRCULATING PUMP	REQD	REQUIRED
DEPT	DEPARTMENT	RM	ROOM
DET	DETAIL	RSC	RIGID STEEL CONDUIT
DIA	DIAMETER	RTU	ROOF TOP UNIT
DISC	DISCONNECT	SC	SURFACE CONDUIT
DIST	DISTRIBUTION	SEC	SECONDARY
DN	DOWN	SHT	SHEET
DPR	DAMPER	SIM	SIMILAR
DS	SAFETY DISCONNECT SWITCH	SIN	SOLID NEUTRAL
DT	DOUBLE THROW	SPEC	SPECIFICATION
DWG	DRAWING	SPKR	SPEAKER
EC	ELECTRICAL CONTRACTOR	SP	SPARE
ELEC	ELECTRIC, ELECTRICAL	SR	SURFACE RACEWAY
ELEV	ELEVATOR	SS	STAINLESS STEEL
ELU	EMERGENCY LIGHTING UNIT	SSW	SELECTOR SWITCH
EM	EMERGENCY	S/S	STOP/START PUSHBUTTONS
EMS	ENERGY MANAGEMENT SYSTEM	STA	STATION
EMT	ELECTRICAL METALLIC TUBING	STD	STANDARD
EP	ELECTRIC PNEUMATIC	SURF	SURFACE MOUNTED
EQUIP	EQUIPMENT	SW	SWITCH
EW	ELECTRIC WATER COOLER	SWBD	SWITCHBOARD
EXIST	EXISTING	SYM	SYMMETRICAL
EXH	EXHAUST	SYS	SYSTEM
EXP	EXPLOSION PROOF	TEL	TELEPHONE
FA	FIRE ALARM	TEL/DATA	TELEPHONE/DATA
FABP	FIRE ALARM BOOSTER POWER	TERM	TERMINAL
FACP	SUPPLY PANEL	TL	TWIST LOCK
FCU	FIRE ALARM CONTROL PANEL	TR	TAMPER RESISTANT
FCU	FAN COIL UNIT	T-STAT	THERMOSTAT
FIXT	FIXTURE	TTC	TELEPHONE TERMINAL CABINET
FLR	FLOOR	TV	TELEVISION
FLUOR	FLUORESCENT	TVTC	TELEVISION TERMINAL CABINET
FU	FUSE	TYP	TYPICAL
FUDS	FUSED SAFETY DISCONNECT SWITCH	UC	UNDER COUNTER
GAL	GAUGE	UE	UNDERGROUND ELECTRICAL
GAL	GALLON	UG	UNDERGROUND
GALV	GALVANIZED	UH	UNIT HEATER
GC	GENERAL CONTRACTOR	UT	UNDERGROUND TELEPHONE
GEN	GENERATOR	UTIL	UTILITY
GFI	GROUND FAULT CIRCUIT INTERRUPTER	UV	ULTRAVIOLET
GFP	GROUND FAULT PROTECTOR	V	VOLT
GND	GROUND	VA	VOLT-AMPERES
GRS	GALVANIZED RIGID STEEL (CONDUIT)	VDT	VIDEO DISPLAY TERMINAL
GYP BD	GYPSPUM BOARD	VERT	VERTICAL
HOA	HANDS-OFF-AUTOMATIC SWITCH	VFD	VARIABLE FREQUENCY DRIVE
HORIZ	HORIZONTAL	VOL	VOLUME
HP	HORSEPOWER	W	WATT
HPF	HIGH POWER FACTOR	WI	WITH
HT	HEIGHT	WG	WIRE GUARD
HTG	HEATING	WH	WATER HEATER
HTR	HEATER	W/O	WITHOUT
HV	HIGH VOLTAGE	WP	WEATHERPROOF
HVAC	HEATING, VENTILATING AND AIR CONDITIONING	XFMR	TRANSFORMER
IC	INTERRUPTING CAPACITY	XFR	TRANSFER
IC	ISOLATED GROUND		
IMC	INTERMEDIATE METAL CONDUIT		
INCAND	INCANDESCENT	∠	ANGLE
IR	INFRARED	@	AT
I/W	INTERLOCK WITH	Δ	DELTA
J-BOX	JUNCTION BOX	′	FEET
KV	KILOVOLT	″	INCHES
KVA	KILOVOLT-AMPERE	#	NUMBER
KVAR	KILOVOLT-AMPERE REACTIVE	Ø	PHASE
KW	KILOWATT	C	CENTER LINE
KWH	KILOWATT HOUR	P	PLATE
LOC	LOCATE OR LOCATION		
LT	LIGHT		
LTG	LIGHTING		
LTNG	LIGHTNING		
LV	LOW VOLTAGE		
MAX	MAXIMUM		
MAG S	MAGNETIC STARTER		
MC	MOMENTARY CONTACT		
MC	MECHANICAL CONTRACTOR		

ELECTRICAL SYMBOL LEGEND			
SYMBOL	DESCRIPTION	SYMBOL	DESCRIPTION
	LIGHTING FIXTURES, TYPICAL, RECTANGULAR		SINGLE RECEPT.
	FILLED CIRCLES INDICATE RECESSED, OPEN CIRCLES INDICATE SURFACE		DUPLEX RECEPT.
	DIAGONAL LINE INDICATES LENSED		(DESIGNATES SPECIFIC MOUNTING HEIGHT) DUPLEX RECEPT.
	OUTER DOTS INDICATE SUSPENDED		GFI DUPLEX RECEPT. (FEED THROUGH)
	LIGHTING FIXTURES, TYPICAL, ROUND		GFI WEATHERPROOF RECEPT.
	CENTER DOT INDICATES PENDANT		SPLIT DUPLEX RECEPT.
	CHEVRON INDICATES WALL WASH		DUPLEX ISOLATED GROUND RECEPT.
	WALL-MOUNTED FIXTURES, TYPICAL		DUPLEX RECEPT. ON EMERG. CIRCUIT
	STRIP FIXTURE		FLOOR DUPLEX RECEPT.
	DIRECTIONAL LIGHT, TRACK, FLOOD		CEILING DUPLEX RECEPT.
	LINEAR LIGHT, TAPE LIGHT		FOURPLEX RECEPT.
	EMERGENCY LIGHTING UNIT, CEILING-MOUNTED, INTEGRAL BATTERY		FOURPLEX RECEPT. ON EMERG. CIRCUIT
	EMERGENCY LIGHTING UNIT, CEILING-MOUNTED, REMOTE BATTERY		240V RECEPTACLE
	EMERGENCY LIGHTING UNIT, WALL-MOUNTED, INTEGRAL BATTERY		RECEPT. ON CORD REEL
	EMERGENCY LIGHTING UNIT, WALL-MOUNTED, REMOTE BATTERY		SPECIAL RECEPT.
	EXIT LIGHT, CEILING-MOUNTED, SHADING AND ARROWS INDICATE FACES AND DIRECTION		JUNCTION BOX
	EXIT LIGHT, WALL-MOUNTED, SHADING AND ARROWS INDICATE FACES AND DIRECTION		FLOOR JUNCTION BOX
	EXIT/ELU COMBO		CEILING JUNCTION BOX
	POLE/AREA LIGHTS		MULTIOUTLET ASSEMBLY
	POST-TOP AREA LIGHT		COMB. MOTOR STARTER (FUSED)
	BOLLARD LIGHT		SAFETY DISC. SW. (NON-FUSED)
	DIAGONAL HATCH INDICATES LIGHT ON A CRITICAL CIRCUIT		SAFETY DISC. SW. (FUSED)
	SOLID HATCH INDICATES LIGHT ON AN EMERGENCY OR LIFE SAFETY CIRCUIT		RELAY
	SINGLE POLE SWITCH		PUSH BUTTON
	3-WAY SWITCH		POWER POLE (OPEN OFFICE STYLE)
	4-WAY SWITCH		SURGERY SERVICE COLUMN
	KEYED SWITCH		STATIC GROUND RECEPTACLE
	SWITCH W/PILOT		UTILITY SERVICE POWER POLE
	DIMMER SWITCH		MOTOR
	OCCUPANCY SENSOR W/ MANUAL SWITCH		IDENTITY (SEE SCHEDULE)
	TIMER SWITCH		EXISTING TO REMAIN
	TIME DELAY SWITCH		RELOCATED
	TIME CONTROL SWITCH		DEMOLISHED
	FIRE ALARM PULL STATION		TRANSFORMER
	FIRE ALARM BELL		BUS DUCT W/ PLUG IN DISCONNECT
	FIRE ALARM HORN W/STROBE		CABLE TAP BOX
	FIRE ALARM SPEAKER W/STROBE		TELEPHONE OUTLET
	FIRE ALARM BELL W/STROBE		FLOOR TELEPHONE OUTLET
	FIRE ALARM CHIME W/STROBE		VOICE/DATA OUTLET
	FIRE ALARM DOOR HOLDER		FLOOR DATA OUTLET
	FIRE ALARM DOOR CLOSER		CEILING DATA OUTLET
	FIRE ALARM SHUT DOWN RELAY		MICROPHONE OUTLET
	SPRINKLER FLOW SWITCH		CATV OUTLET
	SPRINKLER VALVE TAMPER SWITCH		TV OUTLET
	THERMAL DETECTOR		VOLUME CONTROL
	DUCT SMOKE DETECTOR		DOOR BELL
	CEILING SMOKE DETECTOR		DOOR BUZZER
			DOOR CHIME
			DOOR SIGNAL
			AUTO DOOR PUSH PAD
			ELECTRIC STRIKE
			MAGNETIC LOCK
			COMBINATION LOCK
			DOOR CONTACT
			CARD READER
			SECURITY KEYPAD
			MOTION DETECTOR
			NURSE CALL EMERG. STATION
			NURSE CALL CODE BLUE STATION
			NURSE CALL DUTY STATION
			NURSE CALL STAFF STATION
			NURSE CALL PATIENT STATION
			NURSE CALL DOME LIGHT (1-COLOR)
			NURSE CALL DOME LIGHT (2-COLORS)

ELECTRICAL SYMBOL NOTES

LIGHTING FIXTURE TAG DESCRIPTORS:

TOP VALUE: FIXTURE TYPE ID.

BOTTOM VALUE, NUMBER: CIRCUIT NUMBER, REFER TO DRAWINGS FOR PANEL.

BOTTOM VALUE, LOWERCASE LETTER: SWITCH DESIGNATION.

ABSENCE OF A SWITCH ID INDICATES FIXTURE IS CONTROLLED BY THE ONLY SWITCH IN THE SPACE.

"X" IN PLACE OF THE SWITCH ID INDICATES NIGHT LIGHT, UNSWITCHED.

EXIT LIGHTS. STEM INDICATES WALL MOUNTING. NO STEM INDICATES CEILING MOUNTING. SHADED AREA INDICATES ILLUMINATED FACE(S). ARROW INDICATES DIRECTIONAL ARROW ON ILLUMINATED FACE(S). THE CIRCUIT DESIGNATION IS INDICATED BY A NUMBER. EXAMPLE: THE WALL MOUNTED EXIT LIGHT TYPE "E1" WITH SINGLE FACE AND DIRECTIONAL ARROW IS CONNECTED TO CIRCUIT 1.

DEVICES. THE CIRCUIT DESIGNATION IS INDICATED BY A NUMBER. THE SWITCH DESIGNATION IS INDICATED BY A LOWER CASE LETTER. EXAMPLE: SPLIT DUPLEX RECEPTACLE IS CONNECTED TO CIRCUIT 1 AND ONE RECEPTACLE OUTLET IS CONTROLLED BY SWITCH "d".

THE CONTROL DEVICE DESIGNATION IS INDICATED BY A LOWER CASE LETTER. EXAMPLE: SINGLE POLE SWITCH "d" TO CONTROL LIGHTING FIXTURES INDICATED BY "d".

WALL BOX DIMMER WITH SIZE AS INDICATED AT DEVICE. EXAMPLE: 600 WATT WALL BOX DIMMER TO CONTROL LIGHTING FIXTURES INDICATED BY "e". SEE SPECIFICATIONS FOR WATTAGE IF NOT INDICATED.

SPECIAL CONNECTIONS. THE EQUIPMENT IS INDICATED BY A NUMBER IN A CIRCLE. SEE THE MOTOR AND EQUIPMENT SCHEDULE FOR THE LOAD DESCRIPTION AND TYPE OF CONNECTION. THE CIRCUIT DESIGNATION IS INDICATED BY NUMBER(S) ADJACENT TO THE SYMBOL. EXAMPLE: EQUIPMENT NO. ELEC-1, 1 PHASE CONNECTION TO CIRCUITS 2, 4.

PANELBOARDS. PANELBOARD DOORS MAY BE SHOWN TO INDICATE OPENING SIDE OF RECESSED PANELBOARDS. SEE PANELBOARD IDENTIFICATION FOR DESIGNATION CODES.

FLOOR CLEARANCE AREA

MOTOR CONNECTIONS. THE MOTOR IS INDICATED BY A NUMBER WITHIN OR CHARACTERS ADJACENT TO THE MOTOR SYMBOL. SEE THE MOTOR AND EQUIPMENT SCHEDULE FOR THE MOTOR DESCRIPTION AND ELECTRICAL REQUIREMENTS.

TRANSFORMERS. THE TRANSFORMER TYPE IS INDICATED BY A NUMBER FOLLOWING THE UPPER CASE LETTER "T". SEE THE TRANSFORMER SCHEDULE OR THE SINGLE LINE DIAGRAM FOR THE TRANSFORMER DESCRIPTION AND REQUIREMENTS. EXAMPLE: TRANSFORMER TYPE "T1".

CONDUIT IN CEILING, FLOOR OR WALL AS REQUIRED BY FIELD CONDITIONS

CONDUIT IN FLOOR

CONDUIT SHOWN WITHOUT SLASH MARKS SHALL CONTAIN 1 # 12 CONDUCTOR PER PHASE, NEUTRAL, AND GROUND IN 1/2" CONDUIT UNLESS SPECIFIC EQUIPMENT REQUIRES A DIFFERENT SIZE.

CONDUIT SHOWN WITH SLASH MARKS SHALL CONTAIN 1 # 10 CONDUCTOR PER PHASE IN ELECTRICAL CODE SIZED MINIMUM CONDUIT UNLESS A CONDUCTOR AND CONDUIT SIZE IS SHOWN ADJACENT.

HOME RUN TO BRANCH CIRCUIT PANELBOARD. THE PANELBOARD DESIGNATION IS SHOWN ADJACENT TO THE HOME RUN ARROW AS A NUMERATOR AND THE CIRCUIT DESIGNATION IS SHOWN AS THE DENOMINATOR. CIRCUIT BREAKER SIZES (AMPS/NUMBER OF POLES) ARE SHOWN IN THE PANELBOARD SCHEDULE WITH THE CORRESPONDING PANELBOARD AND CIRCUIT DESIGNATION. EXAMPLE: HOME RUN TO PANELBOARD P4N-102; CIRCUITS 1, 3, 5.

GRAPHICAL REPRESENTATION OF PHASING, TYPICAL FOR ALL SYMBOLS.

EXISTING TO REMAIN

EXISTING TO BE REMOVED

NEW

ITEM TO BE REMOVED

AREA NOT IN CONTRACT

REVISION NUMBER - SHOWN ON PLANS

NUMBER OF DETAIL ON SHEET

NUMBER OF SHEET WHERE DETAIL APPEARS

KEYED NOTE (SEE SCHEDULE)

ROOM NAME AND NUMBER

PANELBOARD IDENTIFICATION

1. EQUIPMENT DESIGNATION:

L = LIGHTING

P = POWER

D = DISTRIBUTION

S = SWITCHBOARD

M = MOTOR CONTROL CENTER

R = RELAY PANEL

2. VOLTAGE DESIGNATION:

1 = 120/240V - 1PH

2 = 240V - 3PH

3 = 208Y/120V - 3PH

4 = 480Y/277V - 3PH

5 = 120/208 - 1PH

6 = SPECIAL

3. SYSTEM DESIGNATION:

N = NORMAL

E = EMERGENCY

C = POWER CONDITIONED

U = UNINTERRUPTIBLE POWER SOURCE

P4N-102

5. PANEL NO. DESIGNATION:

01 = PANELBOARD #1

02 = PANELBOARD #2

03 = PANELBOARD #3

ETC.

4. FLOOR DESIGNATION:

B = BASEMENT

G = GROUND



1 = FIRST FLOOR

2 = SECOND FLOOR

ETC.

RON W. WEBB
1659 W. HANRAHAN ROAD
AYDEN, NC. 28513
TEL: (252) 531-2711


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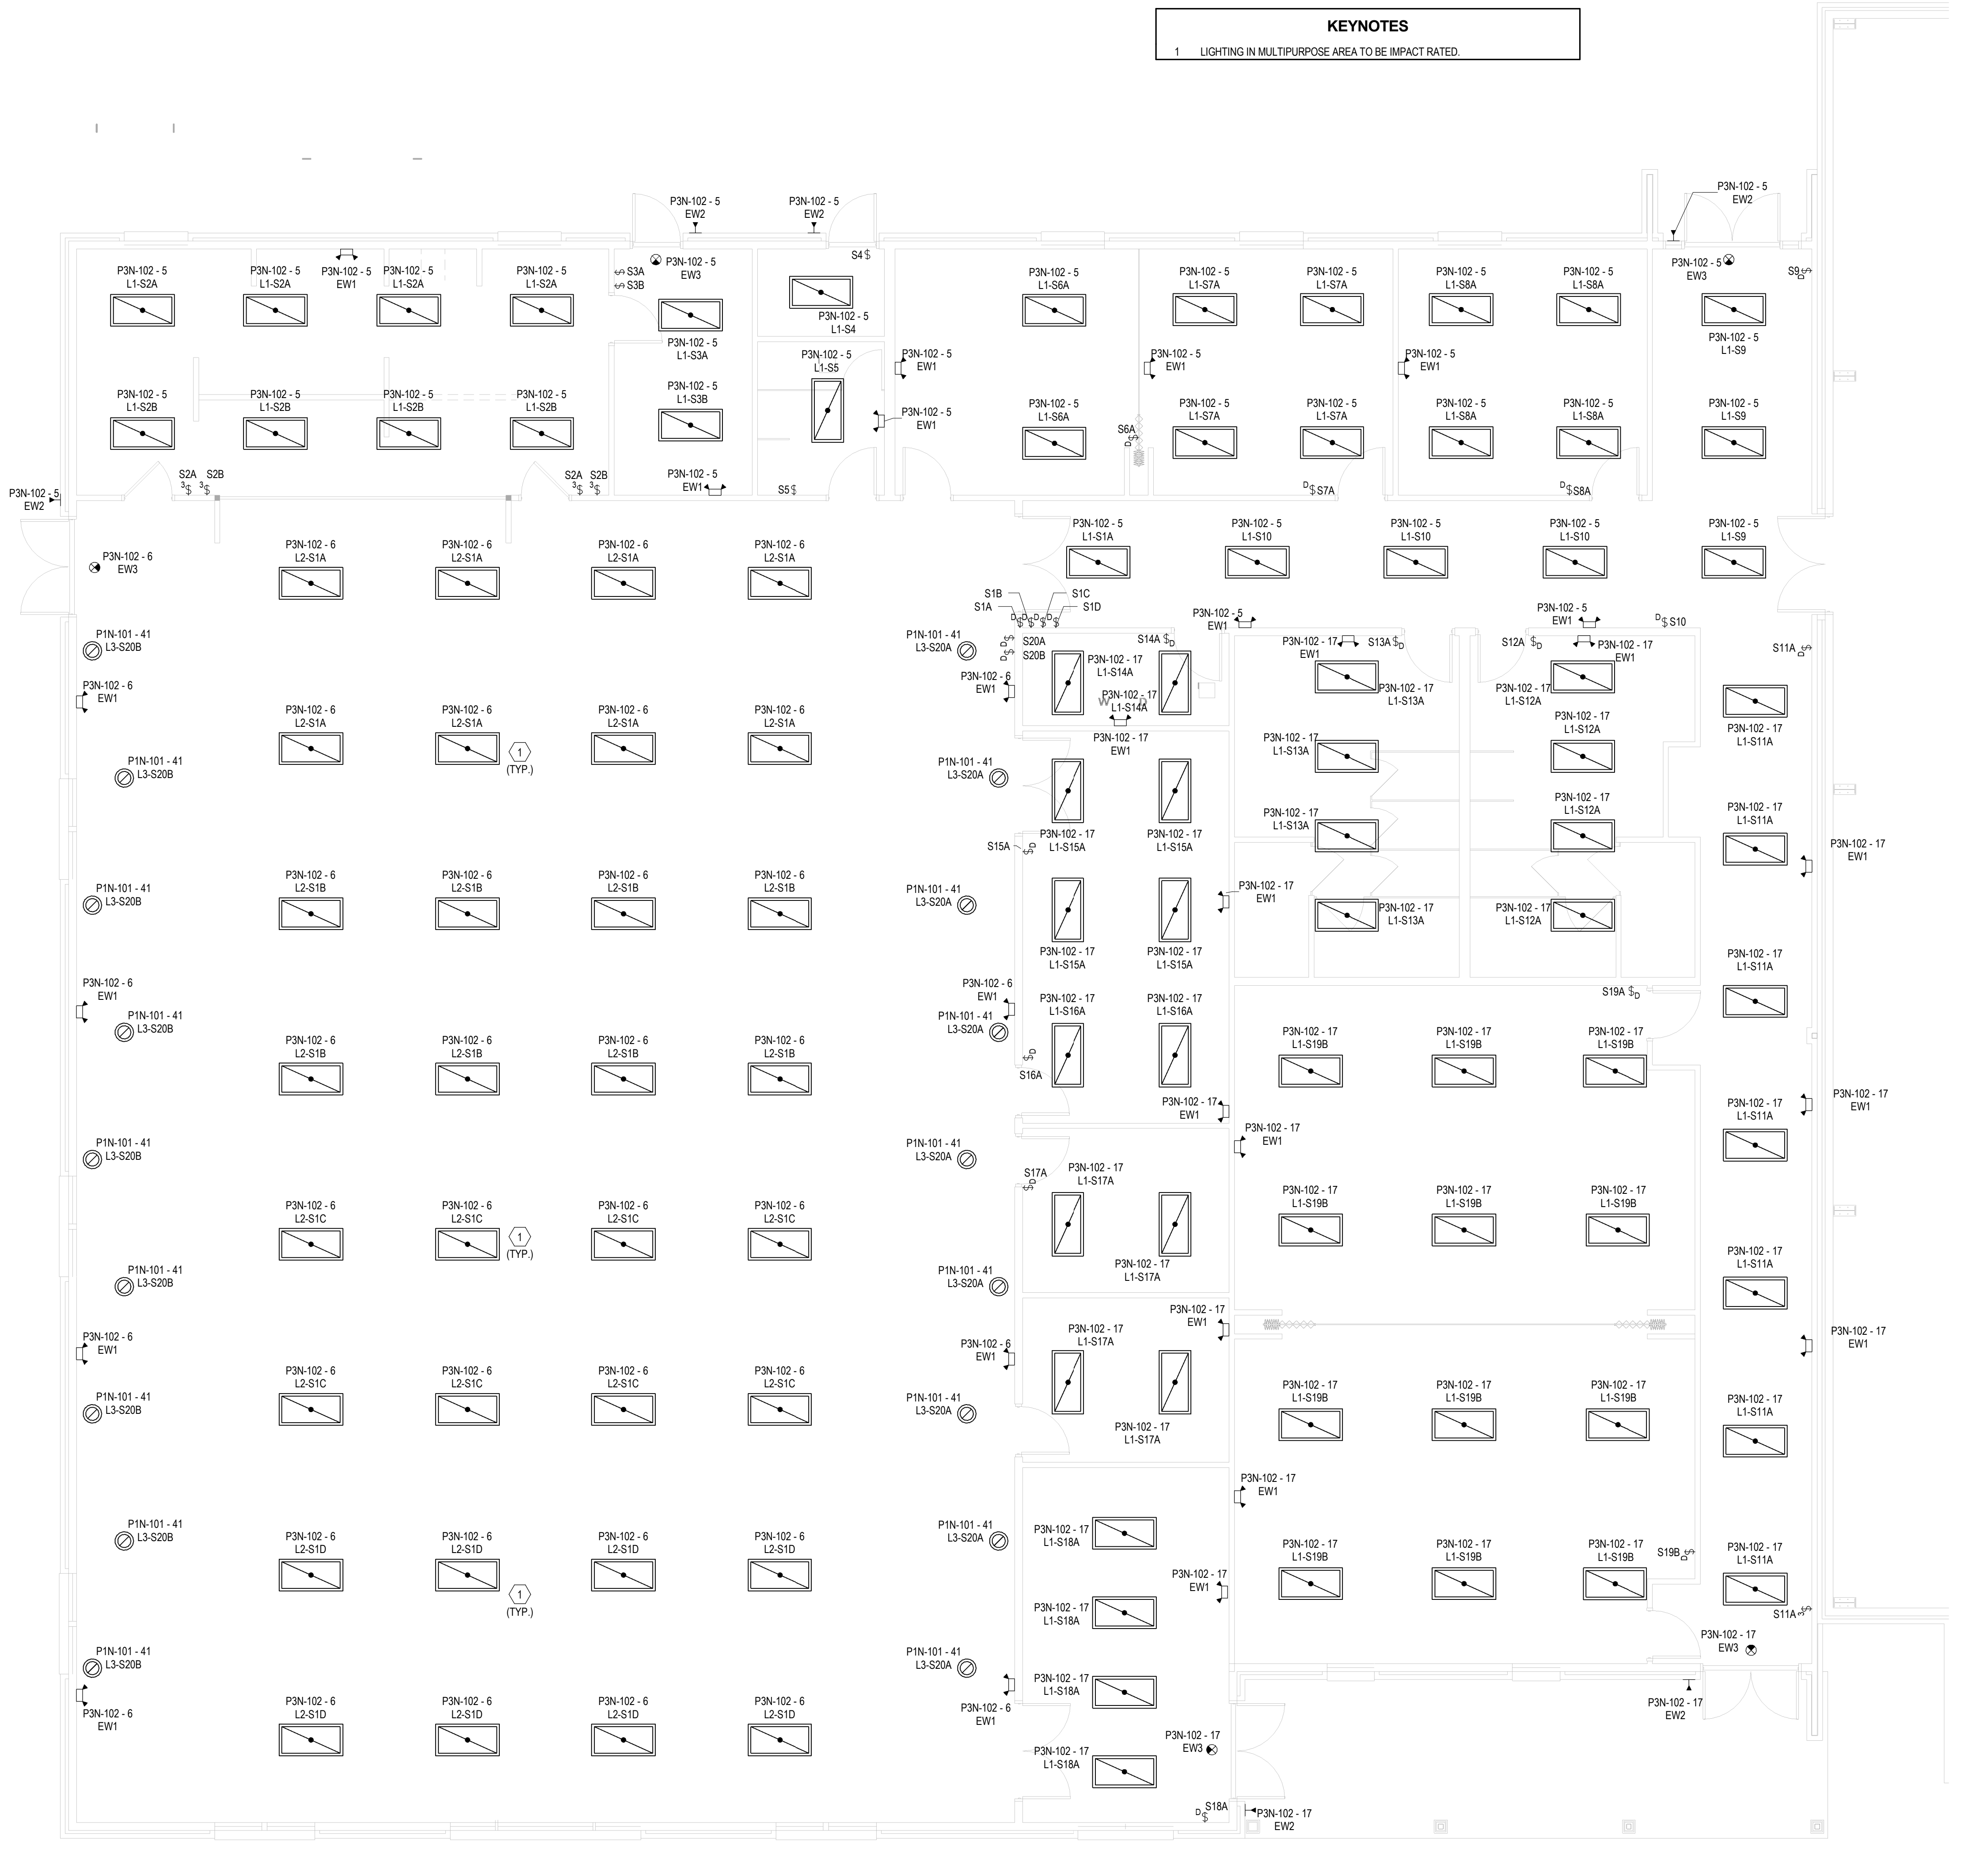

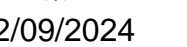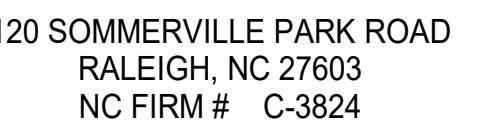
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ELECTRICAL POWER PLAN





KEYNOTES

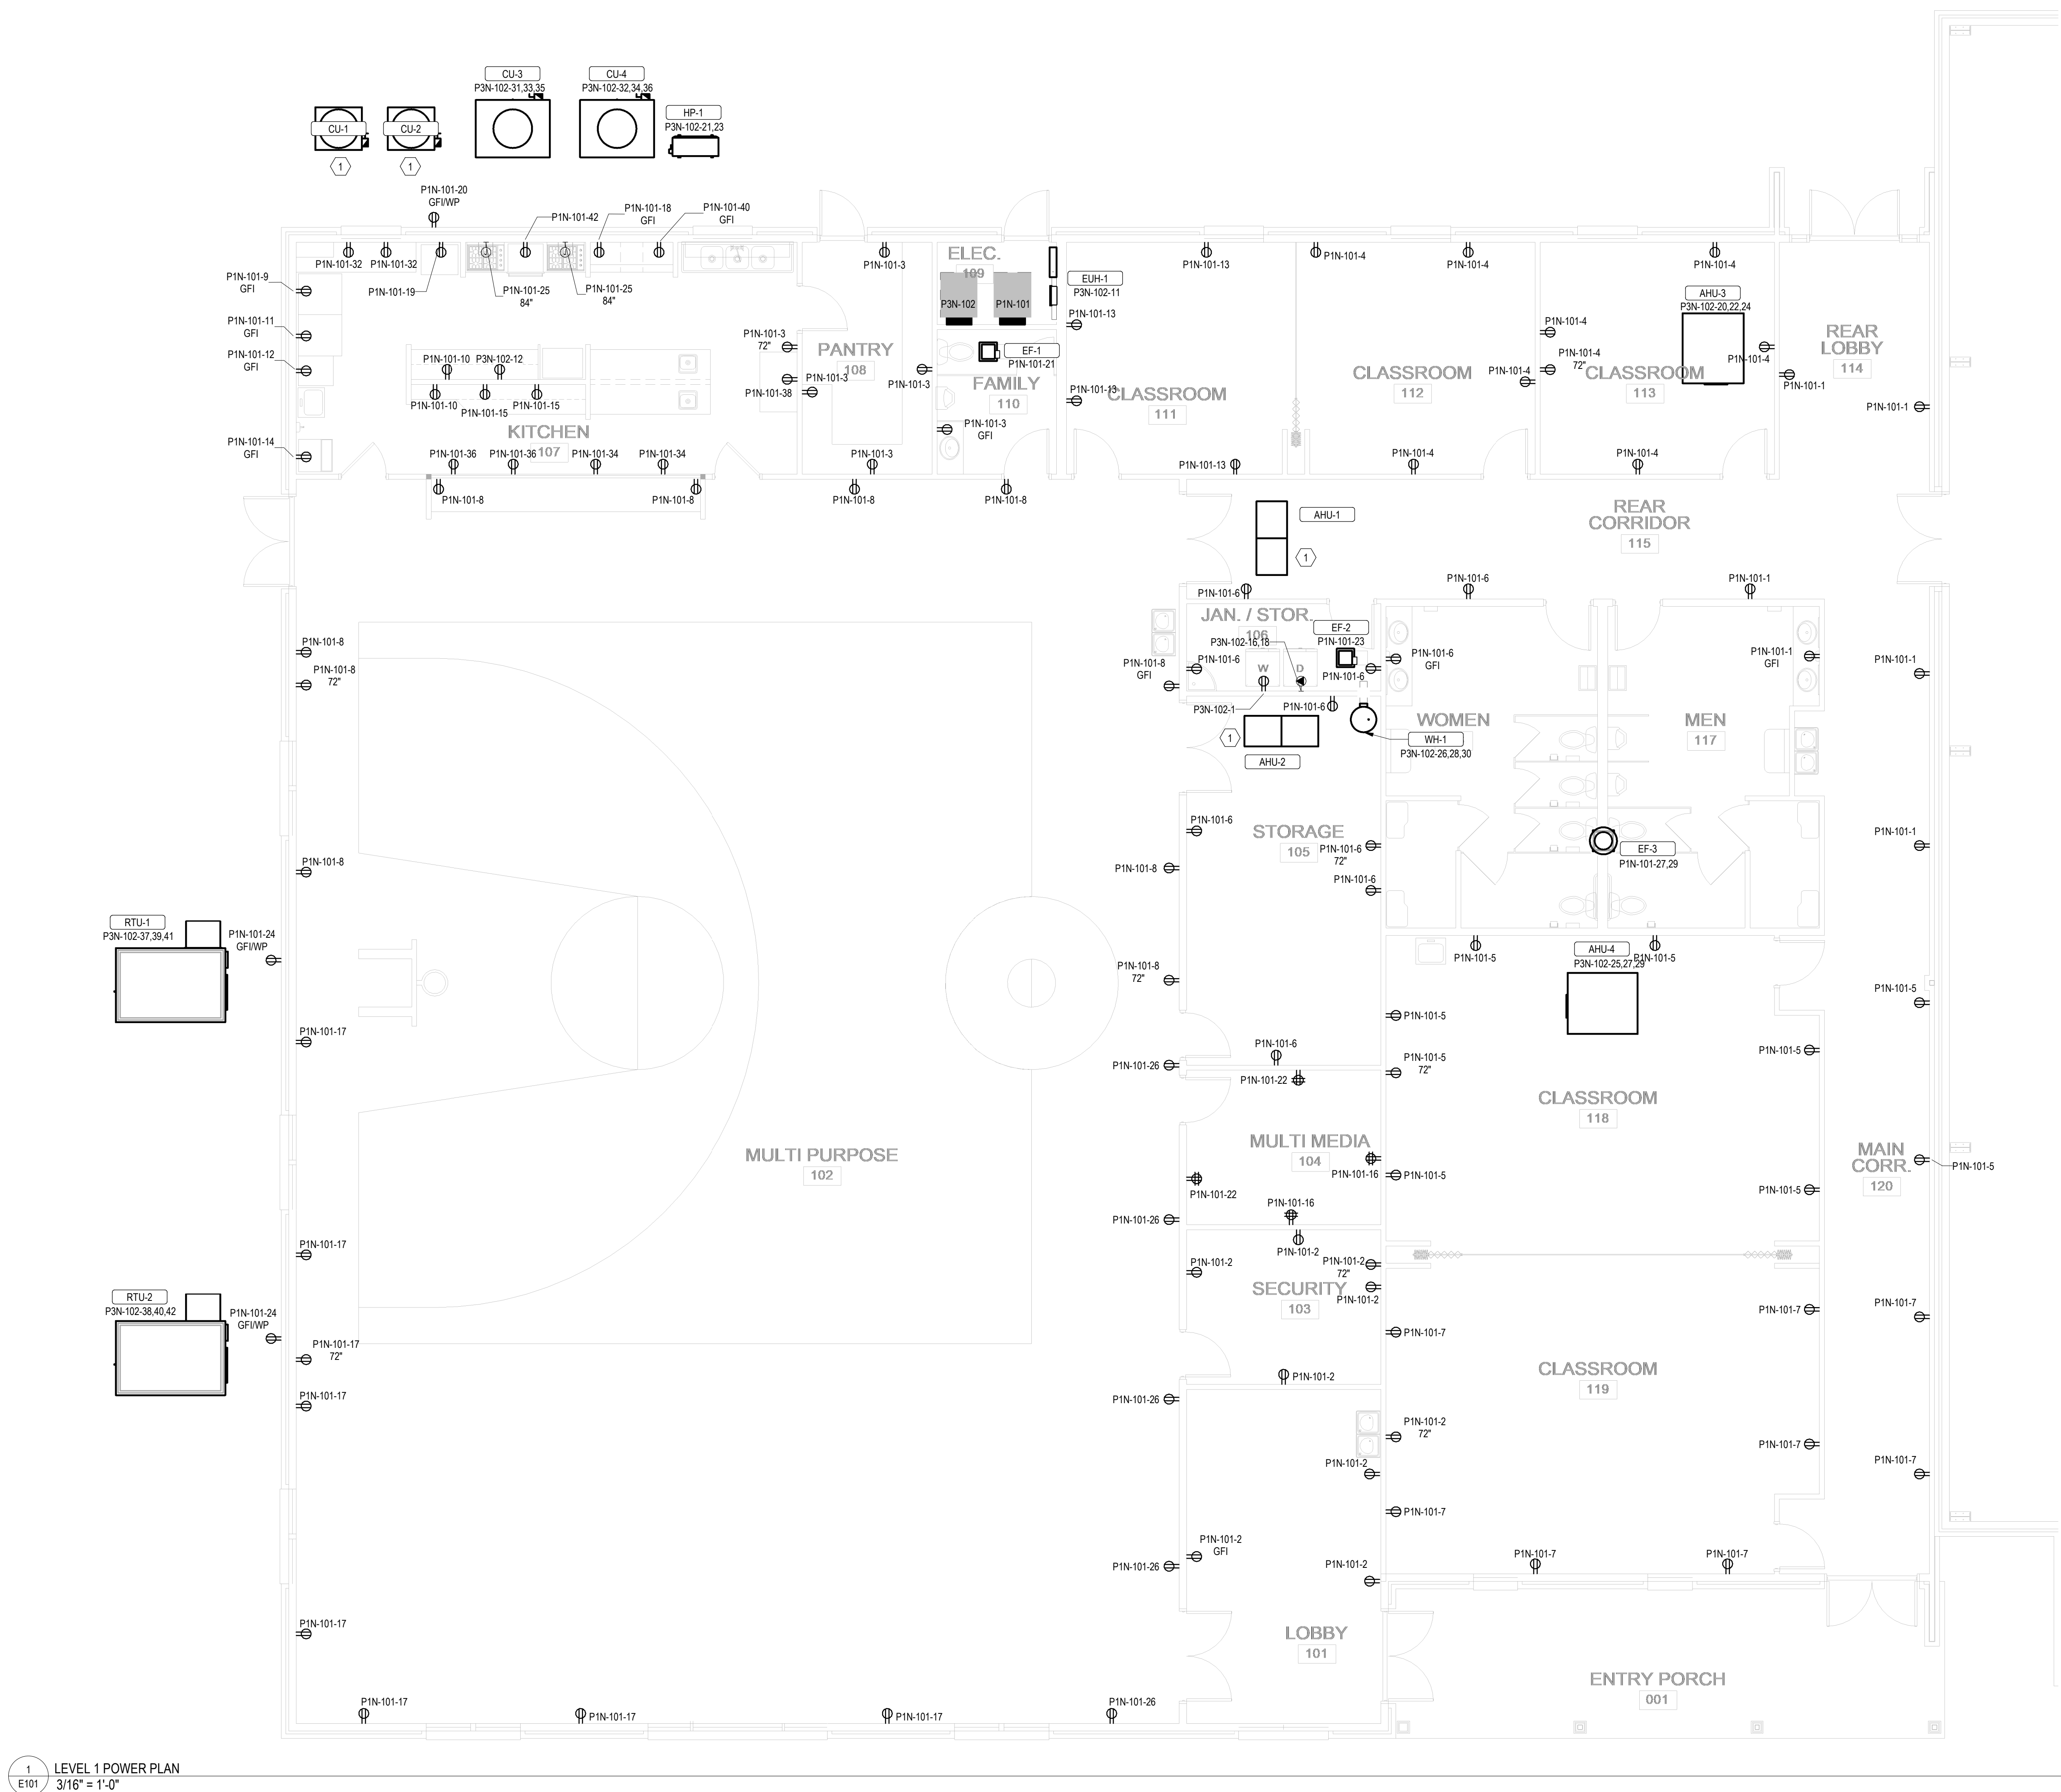1 LIGHTING IN MULTIPURPOSE AREA TO BE IMPACT RATED.

ARCHITECT

RON W. WEBB
1659 W. HANRAHAN ROAD
AYDEN, NC. 28513
TEL: (252) 531-2711


WEBB MT
PISGAH

145 PROSPECT CHURCH RD
ERWIN, NC 28339

PROJECT CONSULTANTS



120 SOMMERVILLE PARK ROAD
RALEIGH, NC 27603
NC FIRM # C-3824

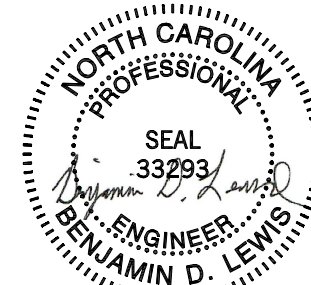

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☐ Not for Construction

☐ Review Set
☒ Bid Set

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Drawing No.

ELECTRICAL LIGHTING PLAN

E201

of

RON W. WEBB
1659 W. HANRAHAN ROAD
AYDEN, NC. 28513
TEL: (252) 531-2711


WEBB MT
PISGAH

145 PROSPECT CHURCH RD
ERWIN, NC 28339

PROJECT CONSULTANTS



120 SOMMERVILLE PARK ROAD
RALEIGH, NC 27603
NC FIRM # C-3824

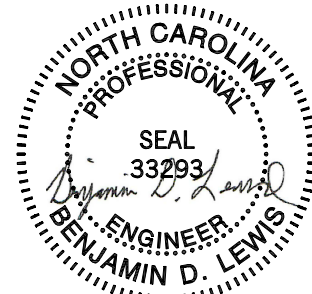

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Drawing No.

ELECTRICAL SCHEDULES

E301

of

Branch Panel: P1N-101

Location: Space 226

Supply From: P3N-102

Mounting: SURFACE

Enclosure: NEMA 1

Volts: 120/208

Phases: 1

Wires: 3

A.I.C. Rating: 10,000 AMPS SYMMETRICAL

Mains Type: MAIN CB

Mains Rating: 225.0 A

MCB Rating: 225.0 A

Notes:

CKT	Circuit Description	Trip	Poles	A		B		Poles	Trip	Circuit Description	CKT
1	RCPT	20.0 A	1	1080 VA	1620 VA			1	20.0 A	RCPT	2
3	RCPT	20.0 A	1			1080 VA	1620 VA	1	20.0 A	RCPT	4
5	RCPT	20.0 A	1	1620 VA	1800 VA			1	20.0 A	RCPT	6
7	RCPT	20.0 A	1			1440 VA	1800 VA	1	20.0 A	RCPT	8
9	REFRIGERATOR (GFI)	20.0 A	1	500 VA	360 VA			1	20.0 A	KITCHEN MISC RCPTS	10
11	REFRIGERATOR (GFI)	20.0 A	1			500 VA	500 VA	1	20.0 A	FREEZER (GFI)	12
13	RCPT	20.0 A	1	720 VA	200 VA			1	20.0 A	ICE MAKER (GFI)	14
15	KITCHEN MISC RCPTS	20.0 A	1			360 VA	360 VA	1	20.0 A	RCPT	16
17	RCPT	20.0 A	1	1440 VA	1500 VA			1	20.0 A	RCPT	18
19	FOOD WARMER	20.0 A	1			1200 VA	180 VA	1	20.0 A	RCPT	20
21	EF-1	20.0 A	1	24 VA	360 VA			1	20.0 A	RCPT	22
23	EF-2,3,4	20.0 A	1			24 VA	360 VA	1	20.0 A	RCPT	24
25	RANGE HOODS	20.0 A	1	472 VA	900 VA			1	20.0 A	RCPT	26
27	EF-3	20.0 A	2			156 VA					28
29				156 VA							30
31							360 VA	1	20.0 A	KITCHEN MISC RCPTS	32
33					360 VA			1	20.0 A	KITCHEN MISC RCPTS	34
35							360 VA	1	20.0 A	KITCHEN MISC RCPTS	36
37					180 VA			1	20.0 A	KITCHEN MISC RCPTS	38
39							1500 VA	1	20.0 A	RCPT Space 228	40
41	LITES Space 239	20.0 A	1	600 VA	180 VA			1	20.0 A	RCPT Space 228	42
Total Load:				14072 VA		11800 VA					
Total Amps:				132.4 A		113.5 A					

Legend:

Load Classification	Connected Load	Demand Factor	Estimated Demand	Panel Totals	
HVAC	360 VA	100.00%	360 VA		
LITES	600 VA	125.00%	750 VA	Total Conn. Load:	25872 VA
RCPT	24912 VA	70.07%	17456 VA	Total Est. Demand:	18566 VA
				Total Conn.:	124.4 A
				Total Est. Demand:	89.3 A

Notes:

AIC IS ASSUMED, EC TO VERIFY BEFORE PURCHASE AND INSTALL.

Branch Panel: P3N-102

Location: Space 226

Supply From:

Mounting: SURFACE

Enclosure: NEMA 1

Volts: 208Y/120

Phases: 3

Wires: 4

A.I.C. Rating: 10,000 AMPS SYMMETRICAL

Mains Type: MAIN CB

Mains Rating: 400.0 A

MCB Rating: 400.0 A

Notes:

CKT	Circuit Description	Trip	Poles	A		B		C		Poles	Trip	Circuit Description	CKT
1	WASHER	20.0 A	1	180 VA	14072 VA					2	20.0 A	P1N-101	2
3							11800 VA	1103 VA	1156 VA	1	20.0 A	LITES	4
5	LITES	20.0 A	1										6
7													8
9													10
11	C Space 226	20.0 A	1					1500 VA	1500 VA	1	20.0 A	MICROWAVE	12
13													14
15							900 VA						16
17	LITES	20.0 A	1					1585 VA	900 VA	2	20.0 A	DRYER	18
19					555 VA								20
21	HP-1	20.0 A	2			1950 VA	555 VA			3	20.0 A	AHU-3	22
23								1950 VA	555 VA				24
25				555 VA	1000 VA								26
27	AHU-4	20.0 A	3			555 VA	1000 VA			3	20.0 A	WH-1	28
29								555 VA	1000 VA				30
31				2402 VA	2402 VA								32
33	CU-3	30.0 A	3			2402 VA	2402 VA			3	60.0 A	CU-4	34
35								2402 VA	2402 VA				36
37				10315 VA	10315 VA								38
39	RTU-1	125.0 A	3			10315 VA	10315 VA			3	125.0 A	RTU-2	40
41								10315 VA	10315 VA				42
Total Load:				41796 VA		42194 VA		37238 VA					
Total Amps:				354.1 A		357.5 A		310.3 A					

Legend:


Load Classification	Connected Load	Demand Factor	Estimated Demand	Panel Totals	
HVAC	83891 VA	100.00%	83891 VA		
POWER	1800 VA	100.00%	1800 VA	Total Conn. Load:	121227 VA
LITES	4444 VA	125.00%	5555 VA	Total Est. Demand:	114042 VA
HEAT	4500 VA	100.00%	4500 VA	Total Conn.:	336.5 A
RCPT	26592 VA	68.80%	18296 VA	Total Est. Demand:	316.5 A

Notes:


AIC IS ASSUMED, EC TO VERIFY BEFORE PURCHASE AND INSTALL.

LIGHTING FIXTURE SCHEDULE																	
	CONSTRUCTION			LIGHT SOURCE						ELECTRICAL			PRODUCT				
TYPE	DESCRIPTION	LENS/LOUVER	MOUNTING	LAMP	LUMENS DOWN	LUMENS UP	CCT	CRI	PROJECTED LIFE	BALLAST/DRIVER	VOLT	WATTS	EMERGENCY COMPONENT	MFR	Model	NOTE	
EW1	ELU INDOOR, TWO HEAD	--	SURFACE WALL	LED	1100 lm	0 lm	6500 K	80	--	--	120 V	3 W	BATTERY	LITHONIA	ELM6L UVOLT LTP	EC TO INSTALL EQUAL OR EQUIVALENT.	
EW2	ELU SINGLE REMOTE HEAD	--	SURFACE WALL	LED	220 lm	0 lm	6500 K	80	--	--	120 V	11 W	REMOTE BATTERY	LITHONIA	ELMRE LP220L SGL	EC TO INSTALL EQUAL OR EQUIVALENT.	
EW3	EXIT SIGN, EDGE-LIT, 1-SIDED	--	CEILING	LED	0 lm	0 lm	0 K	0	--	--	120 V	5 W	BATTERY	LITHONIA	EDGR 1 R EL	EC TO INSTALL EQUAL OR EQUIVALENT.	
L1	2X4 RECESSED	CURVED RIBBED	LAY-IN	LED	4000 lm	0 lm	3500 K	82	60,000 HOURS	LED DRIVER, 0-10V DIMMING, 1%	120 V	32 W	--	LITHONIA	2BLT4 40L ADP EZ1 LP835	EC TO INSTALL EQUAL OR EQUIVALENT.	
L2	2X4 SUSPENDED	CURVED RIBBED	CEILING SUSPENDED	LED	4000 lm	0 lm	3500 K	82	60,000 HOURS	LED DRIVER, 0-10V DIMMING, 1%	120 V	32 W	--	LITHONIA	2BLT4 40L ADP EZ1 LP835	EC TO INSTALL EQUAL OR EQUIVALENT.	
L3	14" ROUND RECESSED	FROSTED ACRYLIC	RECESSED	LED	2040 lm	0 lm	3500 K	80	30,000 HOURS	LED DRIVER	120 V	30 W	--	LITHONIA	FMHLDL 14 208 35K	EC TO INSTALL EQUAL OR EQUIVALENT.	

Mark	Date	Description

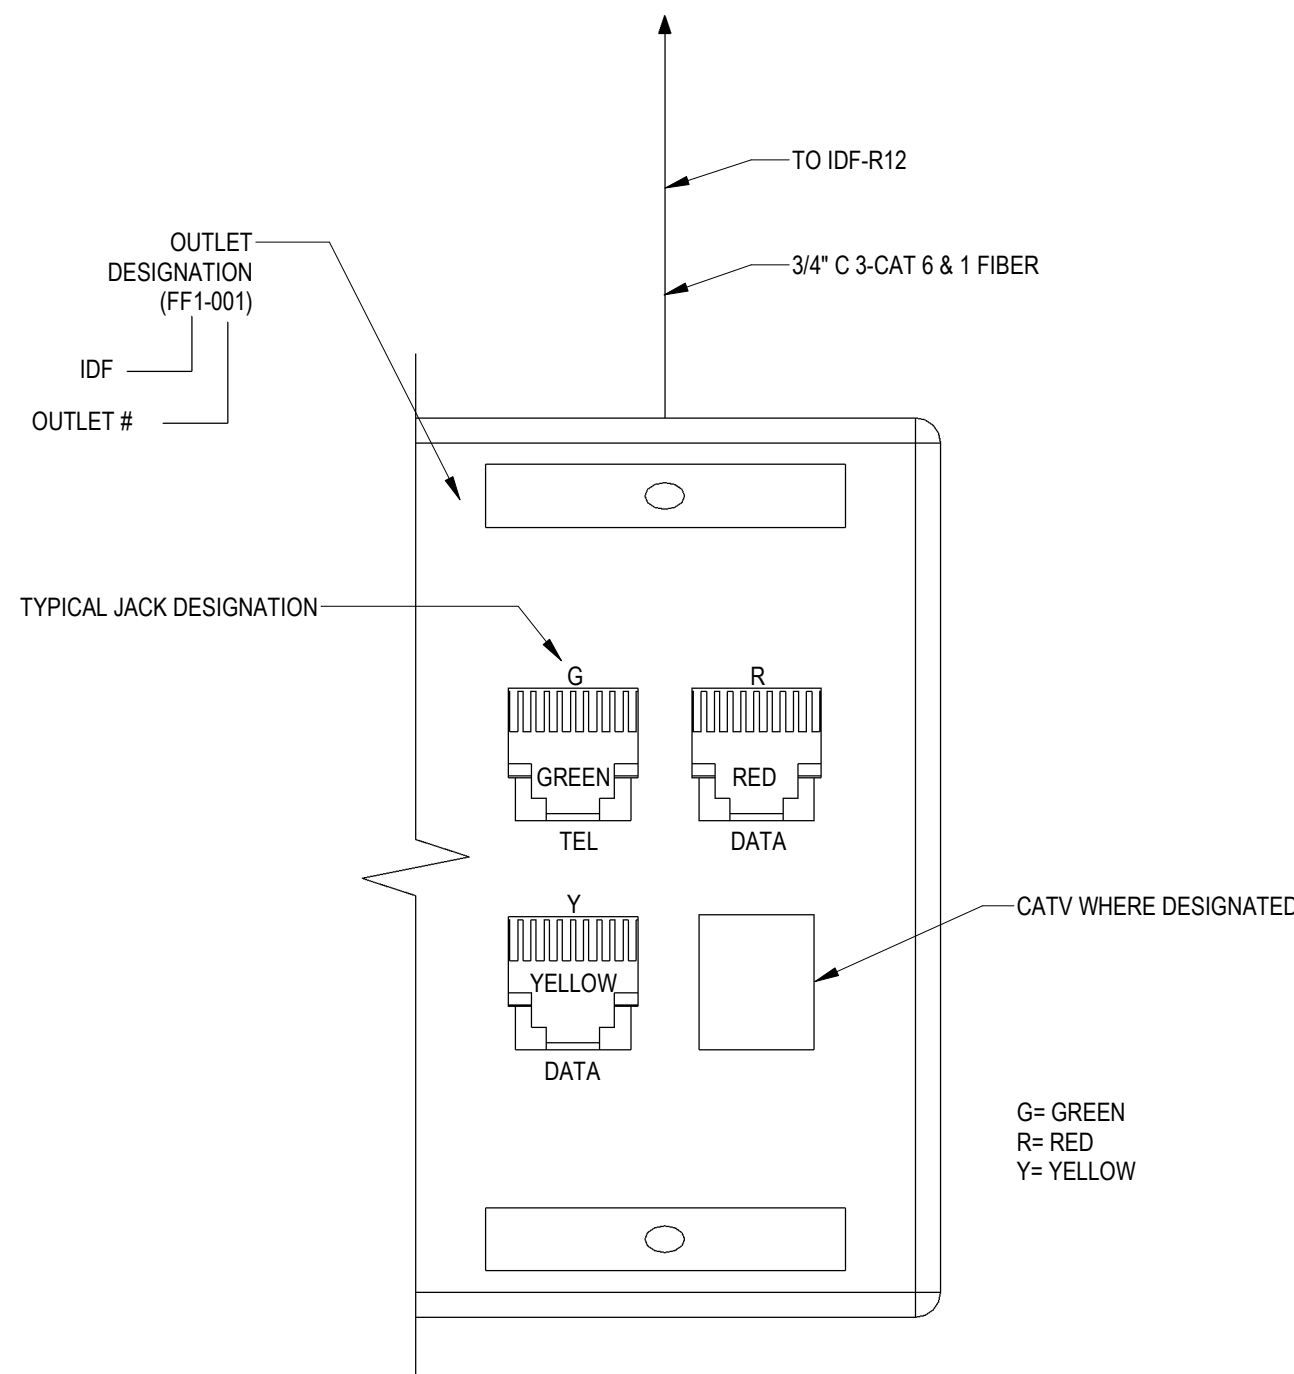

1
E401 TYPICAL TELEPHONE/DATA DEVICE DETAIL 4 PORT
NOT TO SCALE

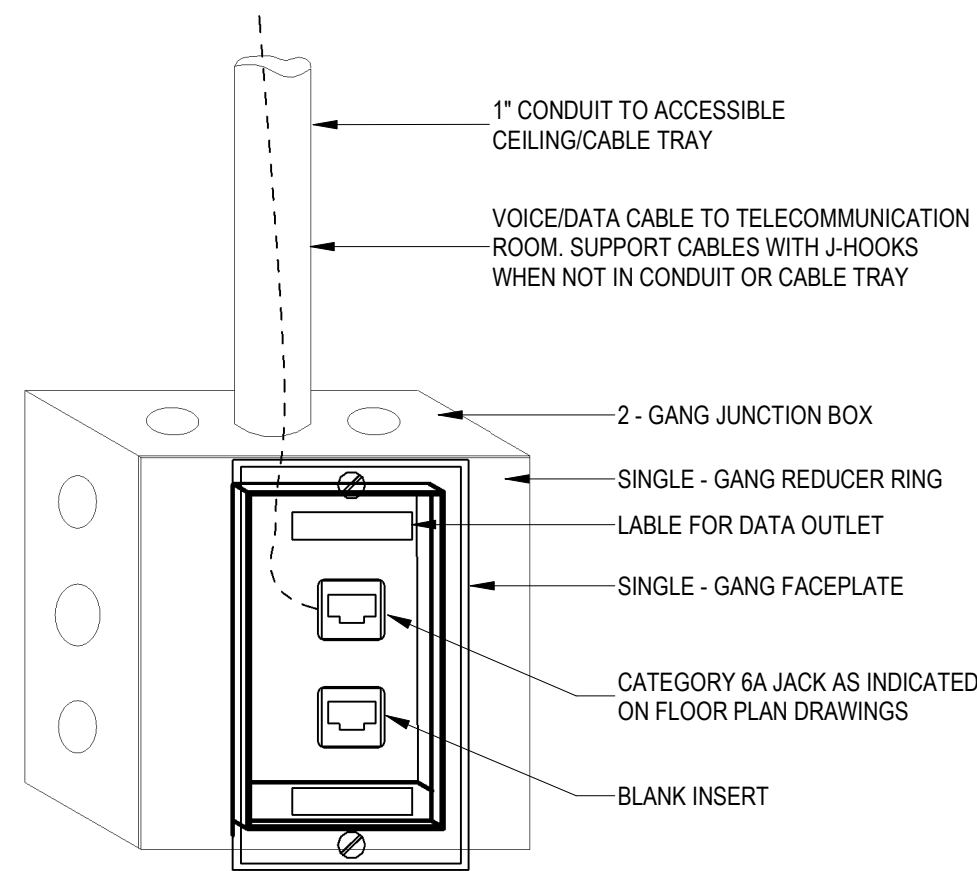


NOTES:

1. TERMINATE VOICE AND DATA OUTLETS WITH T568B/T568A PIN-OUT SEQUENCE. ROUTE CABLES TO TELECOMMUNICATION ROOMS AND TERMINATE ON RACK-MOUNTED CATEGORY 6A PATCH PANELS.
3. LABEL VOICE AND DATA JACK WITH THE TELECOMMUNICATION ROOM NUMBER, PATCH PANEL NUMBER AND JACK POSITION NUMBER (EX. 005-A-18)
4. INSTALL BLANK INSERT ON OPEN PORTS WHEN JACKS ARE NOT INSTALLED.
5. WHEN VOICE/DATA OUTLETS ARE INSTALLED AT MODULAR FURNITURE OR FLOOR BOX LOCATIONS, PROVIDED COMPATIBLE ADAPTER PLATES.

ENGINEER EDIT NOTE: VERIFY CABLE TYPE AND REVISE DETAIL AS REQUIRED.

2
E401 2-PORT SINGLE DROP VOICE/DATA OUTLET DETAIL
NOT TO SCALE

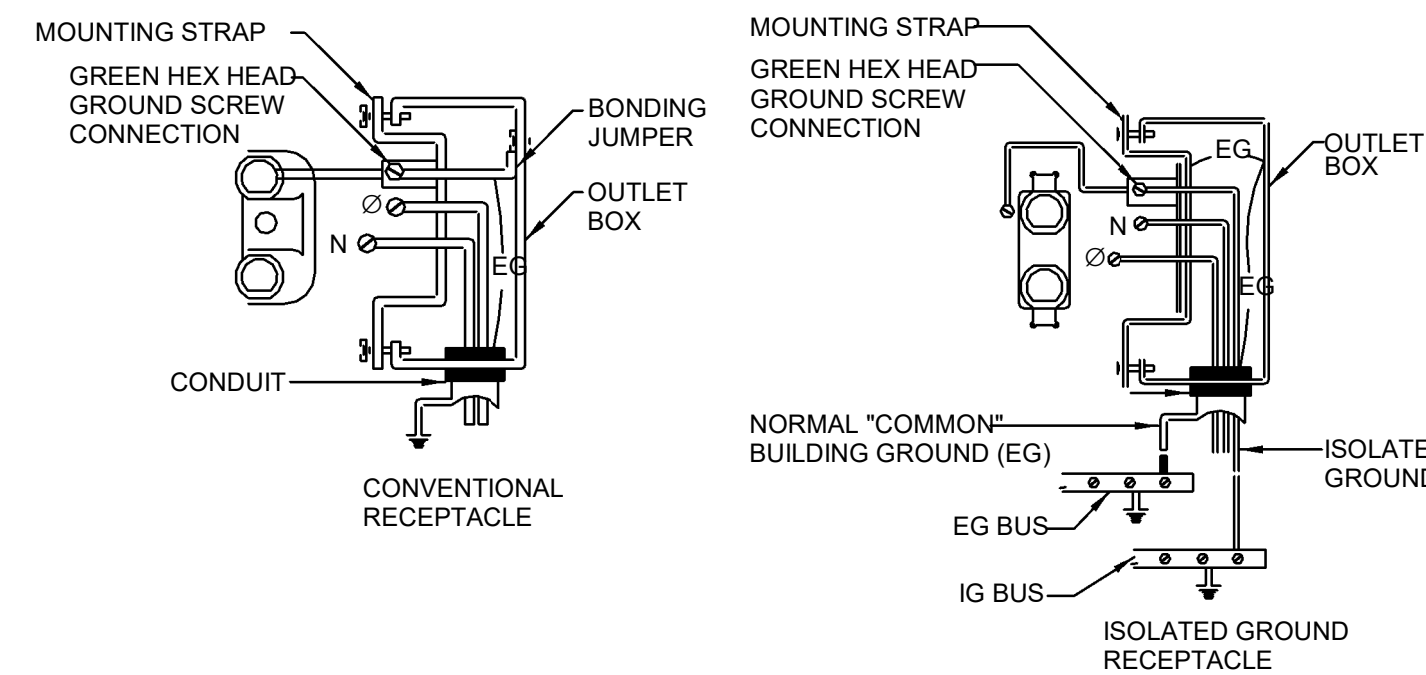

4
E401 RECEPTACLE WIRING DETAILS
NOT TO SCALE



CONDUIT AND WIRE SCHEDULE							
FEEDER TYPE	COPPER CONDUCTORS		CONDUIT SIZE				
	Ø & N	GND	2Ø+N+GND	3Ø+GND	3Ø+N+GND	3Ø+2N+2GND	
20	#12	#12	16 (1/2")	16 (1/2")	16 (1/2")	21 (3/4")	
30	#10	#10	16 (1/2")	16 (1/2")	21 (3/4")	21 (3/4")	
40	#8	#10	21 (3/4")	21 (3/4")	27 (1")	27 (1")	
55	#6	#10	27 (1")	27 (1")	27 (1")	27 (1")	
70	#4	#8	35 (1 1/4")	35 (1 1/4")	35 (1 1/4")	35 (1 1/4")	
85	#3	#8	35 (1 1/4")	35 (1 1/4")	35 (1 1/4")	41 (1 1/2")	
95	#2	#8	35 (1 1/4")	35 (1 1/4")	41 (1 1/2")	41 (1 1/2")	
110	#1	#6	41 (1 1/2")	41 (1 1/2")	41 (1 1/2")	53 (2")	
150	#1/0	#6	41 (1 1/2")	41 (1 1/2")	53 (2")	53 (2")	
175	#2/0	#6	53 (2")	53 (2")	53 (2")	63 (2 1/2")	
200	#3/0	#6	53 (2")	53 (2")	53 (2")	63 (2 1/2")	
230	#4/0	#4	53 (2")	53 (2")	63 (2 1/2")	63 (2 1/2")	
255	250 kCM	#4	63 (2 1/2")	63 (2 1/2")	63 (2 1/2")	78 (3")	
285	300 kCM	#4	63 (2 1/2")	78 (3")	78 (3")	78 (3")	
310	350 kCM	#3	78 (3")	78 (3")	78 (3")	91 (3 1/2")	
335	400 kCM	#3	78 (3")	78 (3")	78 (3")	91 (3 1/2")	
380	500 kCM	#3	78 (3")	78 (3")	91 (3 1/2")	103 (4")	
510	(2) 250 kCM	(2) #1	(2) 63 (2 1/2")	(2) 63 (2 1/2")	(2) 78 (3")	(2) 78 (3")	
570	(2) 300 kCM	(2) #1	(2) 63 (2 1/2")	(2) 63 (2 1/2")	(2) 78 (3")	(2) 91 (3 1/2")	
620	(2) 350 kCM	(2) #1	(2) 78 (3")	(2) 78 (3")	(2) 78 (3")	(2) 91 (3 1/2")	
760	(2) 500 kCM	(2) #1/0	(2) 78 (3")	(2) 78 (3")	(2) 91 (3 1/2")	(2) 103 (4")	
1005	(3) 400 kCM	(3) #2/0	(3) 78 (3")	(3) 78 (3")	(3) 78 (3")	(3) 91 (3 1/2")	
1240	(4) 350 kCM	(4) #3/0	(4) 78 (3")	(4) 78 (3")	(4) 78 (3")	(4) 91 (3 1/2")	
1260	(3) 600 kCM	(3) #3/0	(3) 91 (3 1/2")	(3) 91 (3 1/2")	(3) 103 (4")	(3) 129 (5")	
1675	(5) 400 kCM	(5) #4/0	(5) 78 (3")	(5) 78 (3")	(5) 91 (3 1/2")	(5) 103 (4")	
1680	(4) 600 kCM	(4) #4/0	(4) 91 (3 1/2")	(4) 91 (3 1/2")	(4) 103 (4")	(4) 129 (5")	
2010	(6) 400 kCM	(6) 250 kCM	(6) 78 (3")	(6) 78 (3")	(6) 91 (3 1/2")	(6) 103 (4")	
2100	(5) 600 kCM	(5) 250 kCM	(5) 91 (3 1/2")	(5) 91 (3 1/2")	(5) 103 (4")	(5) 129 (5")	
2520	(6) 600 kCM	(6) 350 kCM	(6) 91 (3 1/2")	(6) 91 (3 1/2")	(6) 103 (4")	(6) 129 (5")	
2660	(7) 500 kCM	(7) 350 kCM	(7) 91 (3 1/2")	(7) 91 (3 1/2")	(7) 91 (3 1/2")	(7) 129 (5")	
3040	(8) 500 kCM	(8) 400 kCM	(8) 91 (3 1/2")	(8) 91 (3 1/2")	(8) 91 (3 1/2")	(8) 129 (5")	
4275	(8) 750 kCM	(8) 500 kCM	(8) 103 (4")	(8) 103 (4")	(8) 129 (5")	(8) 129 (5")	

EQ EQUIPMENT FEEDER - REFER TO ELECTRICAL EQUIPMENT SCHEDULE	
200 - 4 - 1G	FEEDER DESIGNATION
GROUND CONDUCTORS:	
(1G) - NO GROUND	
(1G) - EQUIPMENT GND OR ISOLATED GND	
(2G) - EQUIPMENT GND AND ISOLATED GND	
SYSTEM DESCRIPTION:	
(3) - 10, 3W OR 3Ø, 3W	
(4) - 3Ø, 4W	
(5) - 3Ø, 5W (2 NEUTRALS)	
CONDUCTOR AMPACITY:	
(SEE FEEDER SCHEDULE)	


GENERAL NOTES:

- A. THE ABOVE FEEDER SCHEDULE IS A SCHEDULE OF TYPICAL FEEDERS AND SOME SIZES MAY NOT BE UTILIZED.
- B. ALL CONDUCTOR AMPACITIES ARE BASED ON TABLE 310-15(b)(16) OF THE NEC FOR COPPER CONDUCTOR TYPE THW/THWN.
- C. FEEDER SIZES SHOWN ON THE RISER DIAGRAM INDICATE FEEDER AMPACITIES AND DO NOT NECESSARILY CORRESPOND TO CIRCUIT BREAKER AMPACITIES. CERTAIN FEEDERS MAY BE SIZED FOR THE DERATION FACTORS REQUIRED BY CODE AND/OR ARE OVERSIZED FOR VOLTAGE DROP.
- D. WHERE MULTIPLE CONDUITS AND CONDUCTORS ARE INDICATED FOR A SINGLE FEEDER, EACH CONDUIT SHALL CONTAIN 1 PARALLEL PHASE, NEUTRAL, AND GROUND CONDUCTORS INDICATED.
- E. CONDUIT ABOVE GRADE INDOORS SHALL BE EMT. CONDUIT ABOVE GRADE OUTDOORS SHALL BE GALVANIZED IMC OR RMC. CONDUIT BELOW GRADE SHALL BE PVC WITH GALVANIZED RMC ELBOWS. CONDUIT SIZE INDICATED IS MINIMUM SIZE REGARDLESS OF CONDUIT TYPE.
- F. CONDUITS SIZED LARGER THAN INDICATED SHALL BE PERMITTED FOR RUNS WITH UP TO (4) 90° ELBOWS, OR FOR PULLING LONGER RUNS.

5
E401 CONDUIT AND WIRE SCHEDULE
NOT TO SCALE

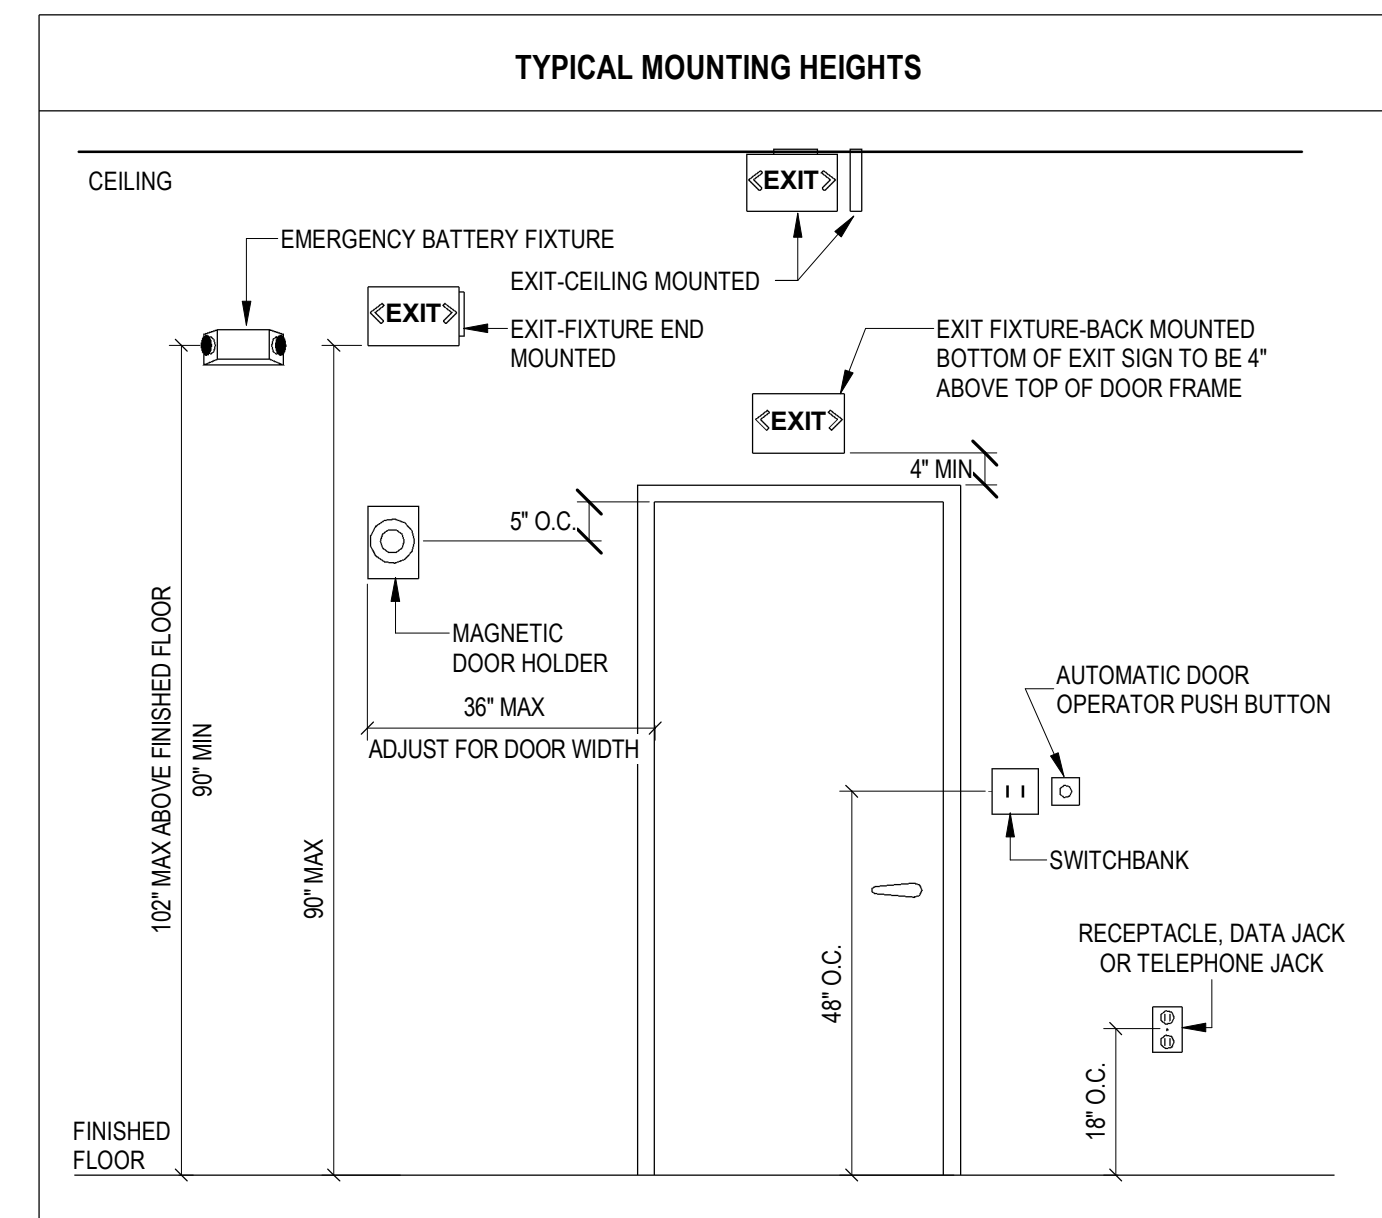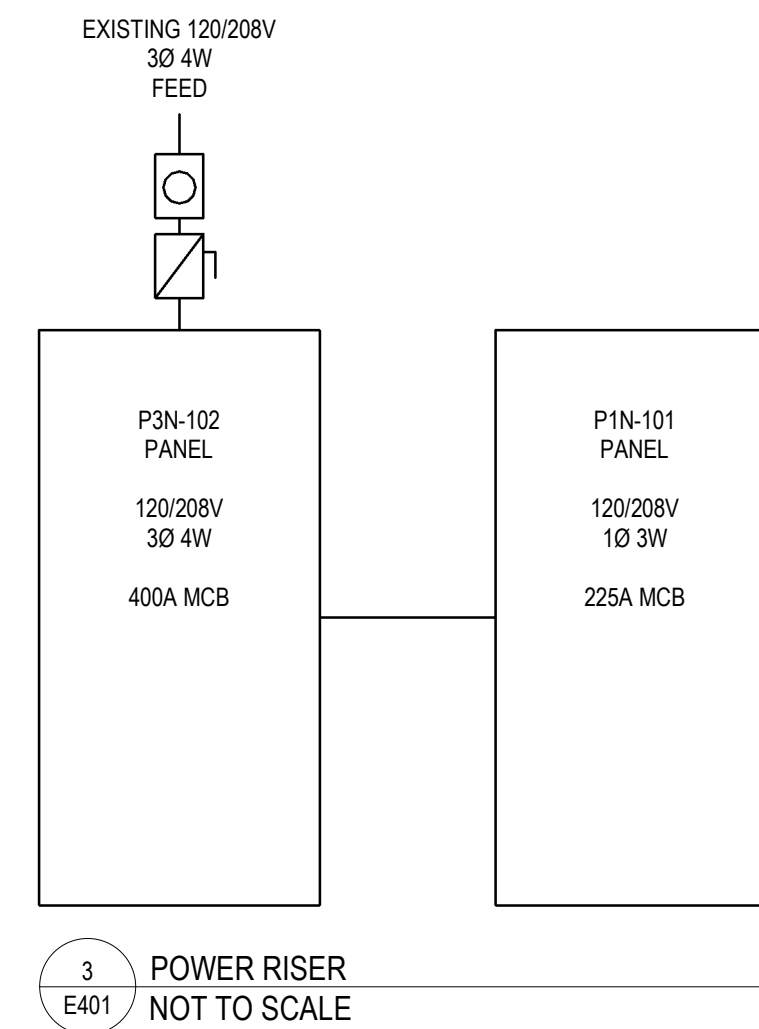

6
E401 TYPICAL MOUNTING HEIGHTS
NOT TO SCALE

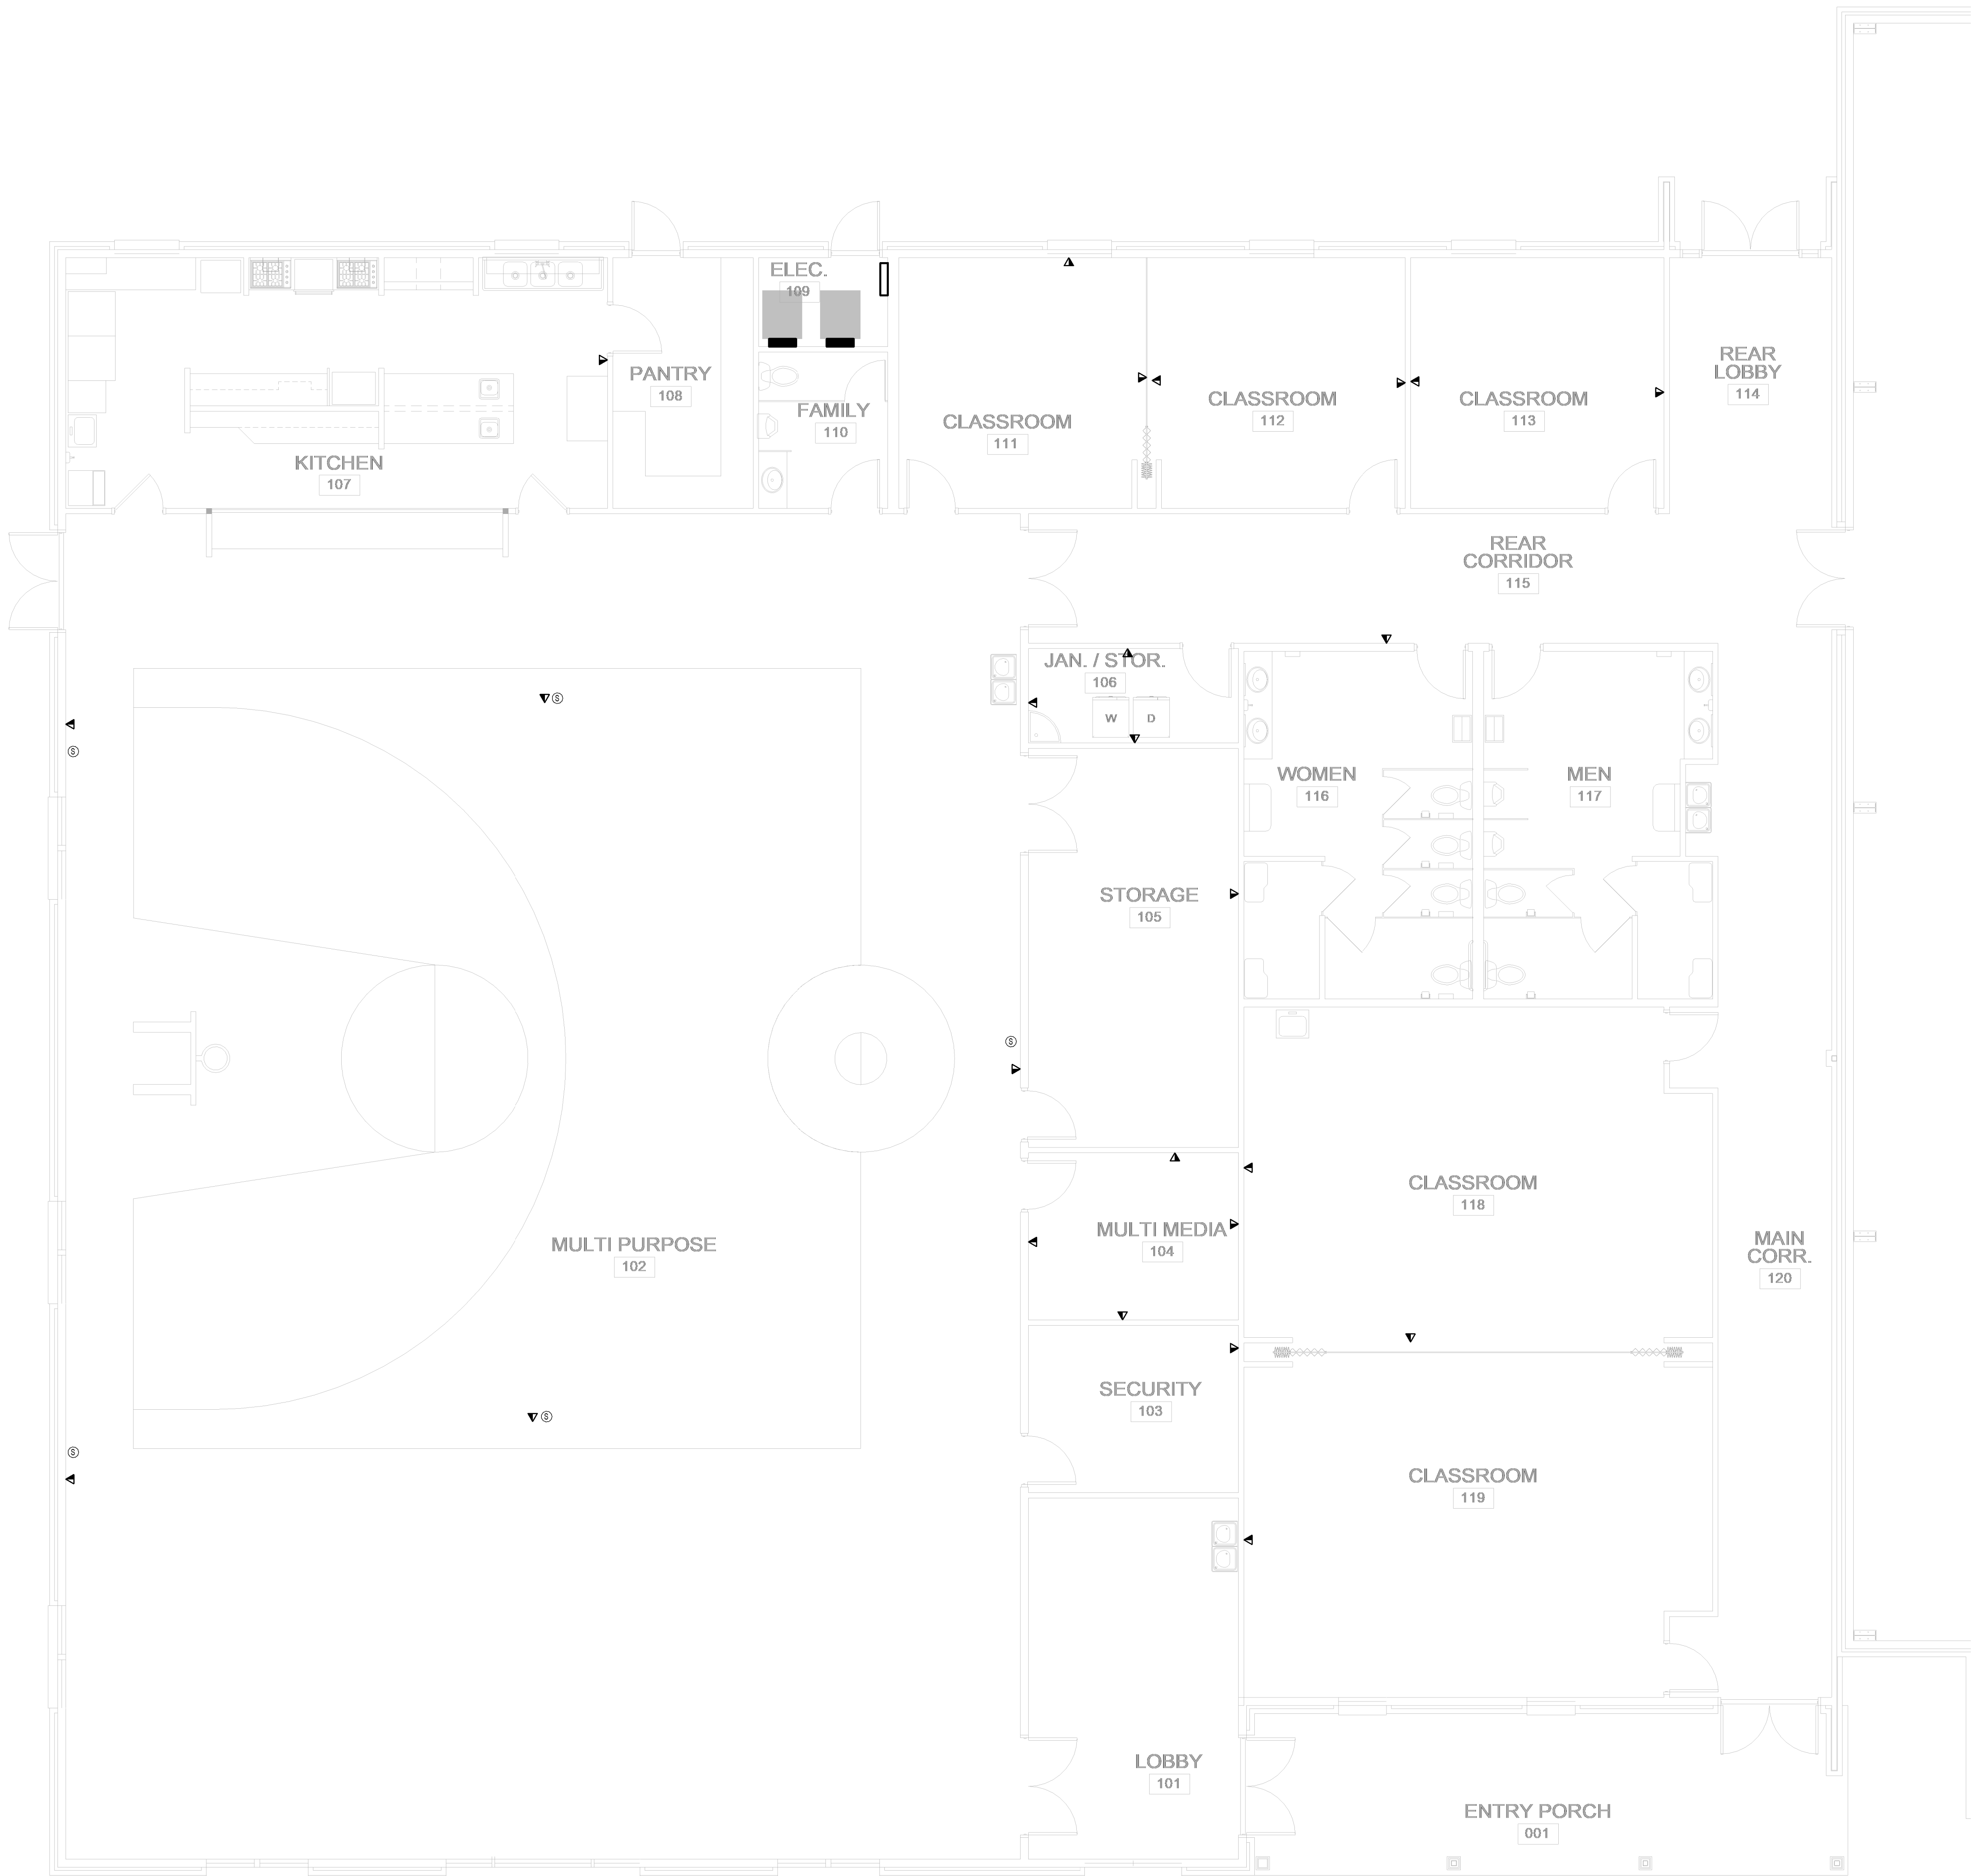

ARCHITECT

RON W. WEBB
1659 W. HANRAHAN ROAD
AYDEN, NC. 28513
TEL: (252) 531-2711


WEBB MT
PISGAH

145 PROSPECT CHURCH RD
ERWIN, NC 28339

PROJECT CONSULTANTS



120 SOMMERVILLE PARK ROAD
RALEIGH, NC 27603
NC FIRM # C-3824

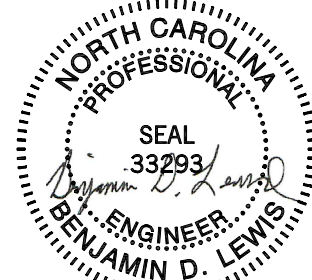

12/09/2024

☒ For Construction
☐ Not for Construction
☐ Review Set
☒ Bid Set

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Issue Date: Issue Date

Plot Date: 10/23/2023 4:27:01 PM

Revisions

Mark	Date	Description

ELECTRICAL SYSTEMS PLAN

E501

of



ARCHITECT

RON W. WEBB
1659 W. HANRAHAN ROAD
AYDEN, NC. 28513
TEL: (252) 531-2711


WEBB MT PISGAH

145 PROSPECT CHURCH RD
ERWIN, NC 28339

PROJECT CONSULTANTS



120 SOMMERVILLE PARK ROAD
RALEIGH, NC 27603
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12/09/2024
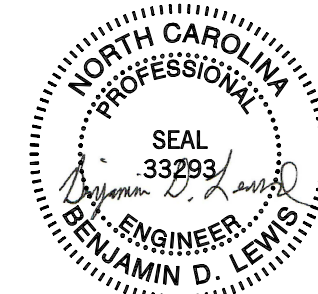
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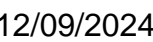
Mark	Date	Description

Drawing No.

FIRE ALARM PLAN

E601

of



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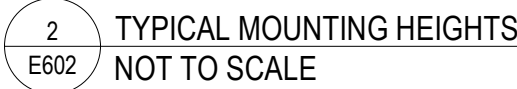
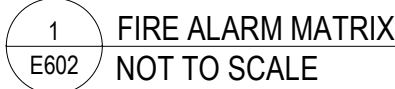
Plot Date: 10/23/2023 4:27:05 PM

Revisions


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Drawing No.


FIRE ALARM DETAILS



SEE FIRE ALARM SHOP DRAWING FOR NUMBER OF LOOPS REQUIRED TO SUPPORT
HORN/STROBE CURRENT DRAW.

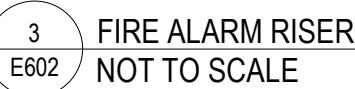

ROOM FINISH SCHEDULE							
No.	NAME	FLOOR	BASE	WALLS	CEILING	HT.	REMARKS
001	ENTRY PORCH	EXPOSED CONC.	N/A	N/A	VENTED VINYL	11'-0"	BROOM FINISH CONC.
101	LOBBY	VCT	4" RUBBER	PAINTED GWB	2x2 AC. TILE	10'-0"	
102	MULTI PURPOSE	VCT	4" RUBBER	PAINTED GWB	2x2 AC. TILE	SLOPED	
103	SECURITY	CARPET	4" RUBBER	PAINTED GWB	2x2 AC. TILE	10'-0"	
104	MULTI MEDIA	CARPET	4" RUBBER	PAINTED GWB	2x2 AC. TILE	10'-0"	
105	STORAGE	VCT	4" RUBBER	PAINTED GWB	2x2 AC. TILE	10'-0"	
106	JAN. / STORAGE	VCT	4" RUBBER	PAINTED GWB	2x2 AC. TILE	10'-0"	
107	KITCHEN	VCT	4" RUBBER	PAINTED GWB	2x2 AC. TILE	10'-0"	FRP PANELS 6'-0" HIGH, EPOXY PAINT ABOVE
108	PANTRY	VCT	4" RUBBER	PAINTED GWB	2x2 AC. TILE	10'-0"	
109	ELECTRIC	EXPOSED CONC.	4" RUBBER	PAINTED GWB	PAINTED GWB	16'-0"	
110	FAMILY TOILET	VCT	4" RUBBER	PAINT & TILE	2x2 AC. TILE	10'-0"	TILE TO 7'-0" HIGH, EPOXY PAINT ABOVE
111	CLASSROOM	CARPET	4" RUBBER	PAINTED GWB	2x2 AC. TILE	10'-0"	
112	CLASSROOM	CARPET	4" RUBBER	PAINTED GWB	2x2 AC. TILE	10'-0"	
113	CLASSROOM	CARPET	4" RUBBER	PAINTED GWB	2x2 AC. TILE	10'-0"	
114	REAR LOBBY	VCT	4" RUBBER	PAINTED GWB	2x2 AC. TILE	10'-0"	
115	REAR CORRIDOR	VCT	4" RUBBER	PAINTED GWB	2x2 AC. TILE	10'-0"	
116	WOMEN	CERAMIC TILE	CERAMIC TILE	PAINT & TILE	2x2 AC. TILE	10'-0"	TILE TO 7'-0" HIGH, EPOXY PAINT ABOVE
117	MEN	CERAMIC TILE	CERAMIC TILE	PAINT & TILE	2x2 AC. TILE	10'-0"	TILE TO 7'-0" HIGH, EPOXY PAINT ABOVE
118	CLASSROOM	CARPET	4" RUBBER	PAINTED GWB	2x2 AC. TILE	10'-0"	
119	CLASSROOM	CARPET	4" RUBBER	PAINTED GWB	2x2 AC. TILE	10'-0"	
120	MAIN CORRIDOR	VCT	4" RUBBER	PAINTED GWB	2x2 AC. TILE	10'-0"	

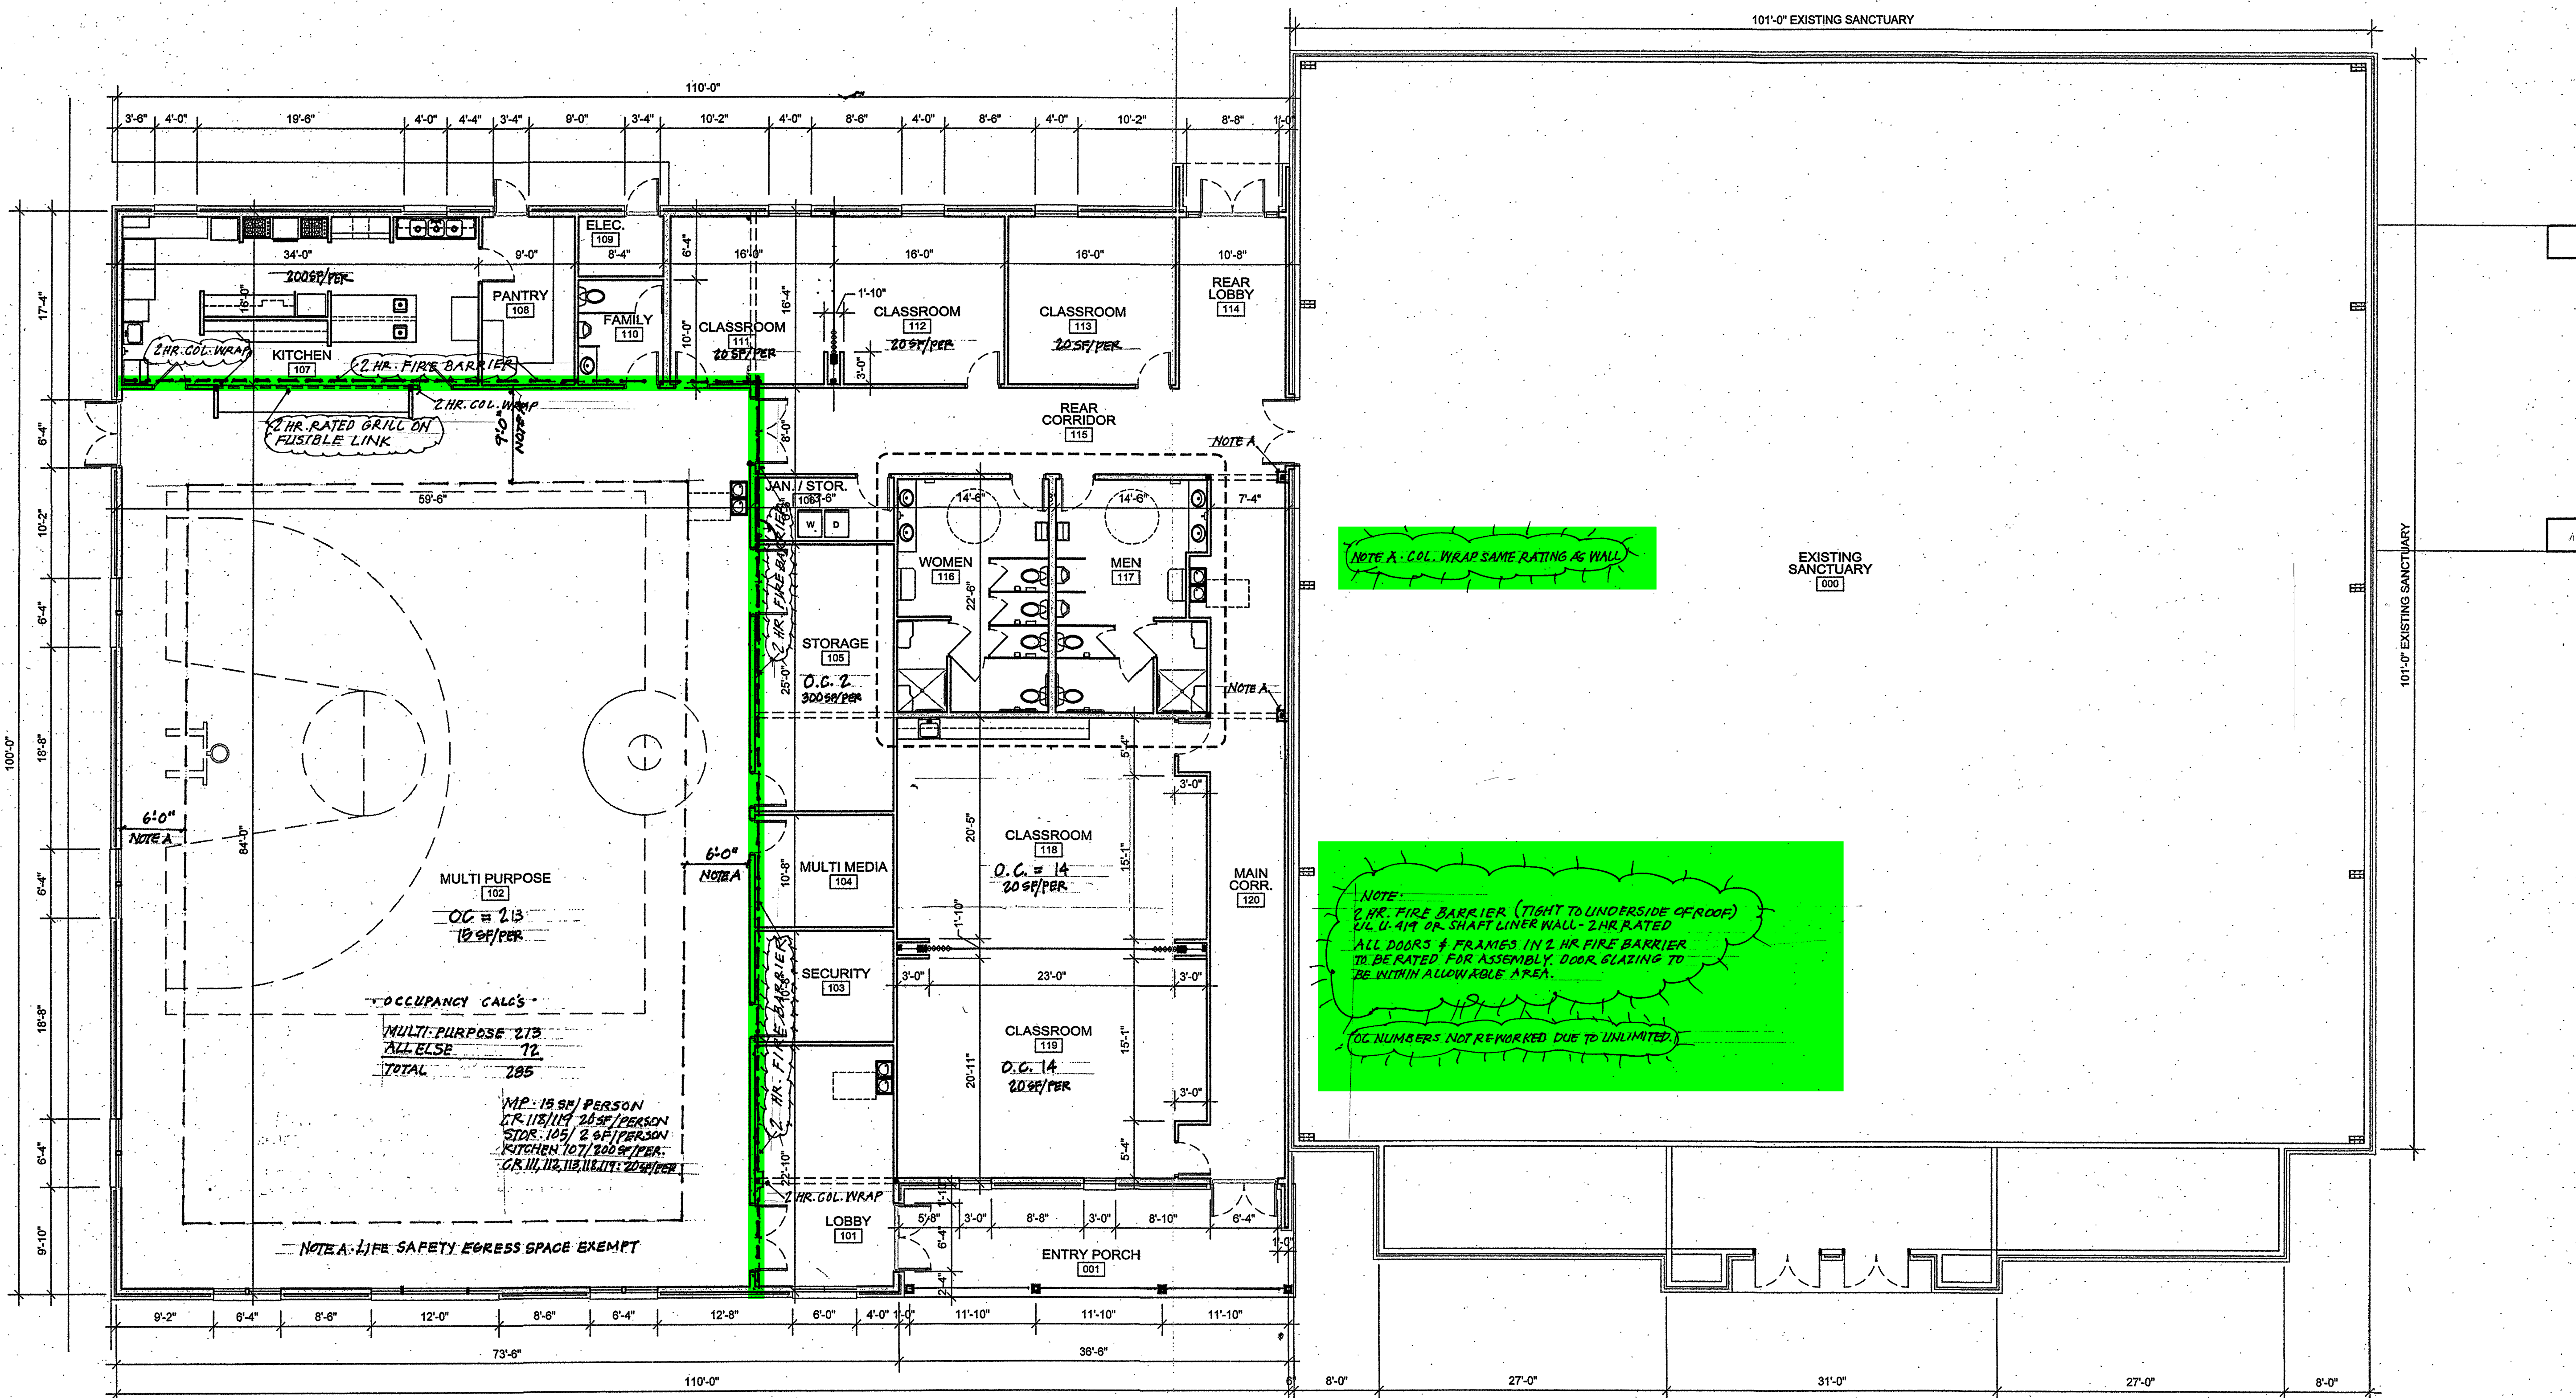

OCCUPANT CONTENT
OVERALL FLOOR PLAN
 SCALE: 1/8" = 1'-0"

ARCHITECT

RON W. WEBB
 1659 W. HANRAHAN ROAD
 AYDEN, NC. 28513
 TEL: (252) 531-2711

**Ministries Activity
 Center Addition
 Mount Pisgah Harnett
 Original Free Will
 Baptist Church**


145 Prospect Church Road
 Erwin, NC.

PROJECT CONSULTANTS



STRUCTURAL

NEVILLE ENGINEERING
 AUGUSTUS NEVILLE, PE
 100-B CULBRETH RD.
 CHAPEL HILL, NC 27516
 TEL: (919) 740-3427

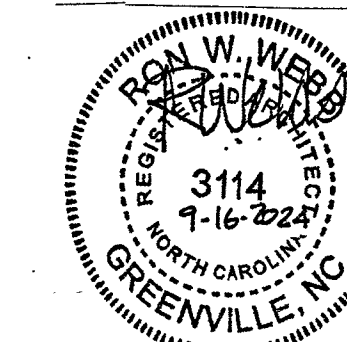

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Plot Date:

Revisions

Mark	Date	Description

Drawing No.
OCCUPANT CONTENT
 OVERALL
 FLOOR
 PLAN **A-5**
 of




THIS IS A TRUSS PLACEMENT DIAGRAM ONLY.

These trusses are designed as individual building components to be incorporated into the building design as part of the overall design of the building designer. See individual design sheets for each truss design identified on the placement drawing. The building designer is responsible for temporary and permanent bracing of the roof and floor system and for the overall structure. The design of the truss support structure including headers, beams, walls and columns is the responsibility of the building designer. For general guidance regarding bracing, consult BCS-B1 and BCS-B3 provided with the truss delivery package or online at sbcindustrial.com

Bearing reactions less than or equal to 3000# are deemed to comply with the prescriptive Code requirements. The contractor shall refer to the attached Tables (derived from the prescriptive Code requirements) to determine the minimum foundation size and number of wood studs required to support reactions greater than 3000# but not greater than 15000#. A registered design professional shall be retained to design the support system for any reaction that exceeds those specified in the attached Tables. Registered design professionals shall be retained to design the support system for all reactions that exceed 15000#.

Signature Anthony Williams
Anthony Williams

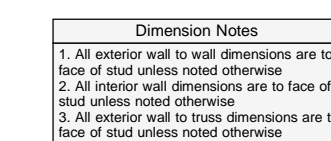

All Walls Shown Are
Considered Load Bearing

▲ = Indicates Left End of Truss
(Reference Engineered Truss Drawing)
Do Not Erect Trusses Backwards

Roof Area	= 11891.82 sq.ft.
Ridge Line	= 164 ft.
Hip Line	= 0 ft.
Horiz. OH	= 253 ft.
Raked OH	= 290.97 ft.
Decking	= 409 sheets

Connector Information					Nail Information	
Sym	Product	Manuf	Qty	Supported Member	Header	Truss
	HUS26	USP	25	NA	16d/3-1/2"	16d/3-1/2"

Truss Placement Plan
SCALE: 3/16" = 1'-0"

BUILDER		STE General Contractors		CITY / CO.	
JOB NAME	MT Pisgah Church	ADDRESS	145 Prospect Church Rd.		Erwin / Harnett
PLAN	Ministries Activity Center	MODEL	Roof		
SEAL DATE	9/16/24	DATE REV.	2/12/25		
QUOTE #	B0124-0243	DRAWN BY	Anthony Williams		
JOB #	J0225-0815	SALES REP.	Anthony Williams		
LOAD CHART FOR JACK STUDS					
(BASED ON TABLES K002 S01 & S03)					
NUMBER OF JACK STUDS REQUIRED @ 6" X 6" @ 10' SPACING					
END SECTION (JP 70)	REQ. 5 STUDS FOR 10' X 10' HEAD	END SECTION (JP 70)	REQ. 5 STUDS FOR 10' X 10' HEAD	END SECTION (JP 70)	REQ. 5 STUDS FOR 10' X 10' HEAD
1700 1		2550 1		3400 1	
3400 2		5100 2		6800 2	
6800 4		7650 3		10200 3	
8900 5		12750 5		13600 4	
10200 6		15300 6		17000 5	
11500 7					
13600 8					
19300 9					



Architect

Ron Ward Webb

1659 W. Hanrahan Road
Ayden, NC, 28513
Tel: (252) 606-7860
Email: Wgarryowen@cs.com

To: Mr. Brad Sutton, Code Enforcement Officer, Harnett County Inspections
From: Ron Ward Webb, Architect
Date: March 10, 2025
Re: Mount Pisgah Harnett OFWB Church

Mr. Sutton

Thank you for your most recent Plan Review comments. Without taking away from Mr. Tommy McLeod's comments, I will offer the following additional comments:

Your Item No. 1: No Structural Trusses will bear on or penetrate the rated 2 Hour Fire Barrier. The Fire Barrier will be parallel and tight to the bearing wall of the Multi-Purpose Room, but on the Educational side and the Contractor will set the first truss on the Educational side to allow for the Fire Barrier to extend tight to the underside of the Educational Roof. The bearing wall of the Multi Purpose Room will be braced by the trusses for the Multi Purpose Room, and the Fire Barrier wall will be braced by the incoming roof of the Educational Building. The trusses for the Educational Building are running from front to back so that the Fire Barrier will be running parallel to the Educational trusses, thus allowing it to run up tight to the underside of the roof.

Your Item No. 2: The column which receives Girder Truss GRD is just outside of the Fire Barrier, but all columns will be wrapped with 2 hour rated construction in compliance with UL Design No. U-419.

Your Item No. 3: All doors and frames within the Fire Barrier will be 90 minute rated with limiting glass area per Code.

Your Item No. 4: There will now be rated dampers within the penetrations of the Fire Barrier in ductwork. The reason these were not in the original plans is because the rated Fire Barrier was not. Now that the Fire Barrier is in the Scope of Work, the rated dampers will also be in the ductwork.

Your Item No. 5: Drawing M000, Note P states to provide duct smoke detectors. Also Drawing M401, Detail #3 shows the duct mounted Smoke Detectors.

Please do not hesitate to call if I may offer further clarifications. Thank you very much.

Sincerely

Ron Ward Webb, Architect

cc: R. Hinton, G. Surles, G. Blue, T. McLeod, file
code: PR Response #2