

LOCATION MAP

FROM RALEIGH, NC: TAKE PREFERRED ROUTE TO US-401 S/US-70 E/

DAWSON ST. CONTINUE TO FOLLOW US-401 S/US-70 E. KEEP RIGHT TO CONTINUE ON US-401 S/FAYETTVILLE RD. TURN LEFT ON OLD STAGE RD. TURN RIGHT TO STAY ON OLD STAGE ROAD. CONTINUE STRAIGHT ONTO

NC-27 W. AFTER PASSING LESLIE CAMPBELL AVE, TURN LEFT ONTO THI ACCESS ROAD IN ABOUT 600 FEET. THE SITE WILL BE ON THE RIGHT.

PROPOSED TELECOMMUNICATIONS POLE

SITE NAME:

BUIES CREEK 230 SUB

SUBSTATION NUMBER (TELCOM ABBREVIATION):

T5504 (NCBCU011)

SITE ADDRESS:

1716 NC-27 LILLINGTON, NC 27546 (HARNETT COUNTY)





401 SOUTH WILMINGTON STREET RALEIGH, NC 27601 OFFICE: (800) 452-2777




Know what's **below Call** before you dig.

THE UTILITIES SHOWN HEREON ARE FOR THE CONTRACTORS CONVENIENCE ONLY THERE MAY BE OTHER UTILITIES NOT SHOWN ON THESE PLANS. THE ENGINEER/ SURVEYOR ASSUMES NO RESPONSIBILITY FOR THE LOCATIONS SHOWN AND IT SHALL BE THE CONTRACTOR'S RESPONSIBILITY TO VERIFY ALL UTILITIES WITHIN THE LIMITS OF THE WORK. ALL DAMAGE MADE TO EXISTING UTILITIES BY THE CONTRACTOR SHALL BE THE SOLE RESPONSIBILITY OF THE CONTRACTOR.

UTILITY STATEMENT

INDEX OF SHEETS


SHEET	DESCRIPTION	REV
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N.C. LICENSE # C-1794

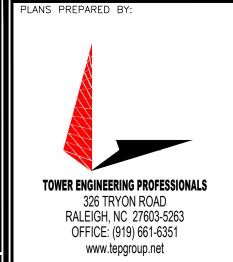4	02-23-24	JURISDICTION COMMENTS
3	05-30-23	ADD POLE CONNECTION
2	10-28-22	CONSTRUCTION
1	08-29-22	PRELIMINARY CONSTRUCTION
0	07-07-22	PRELIMINARY CONSTRUCTION
REV	DATE	ISSUED FOR:

DRAWN BY: GAH CHECKED BY:



Harnett

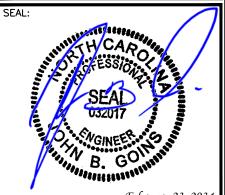SEAL:

1-1

TEP#:310886.67708

LATITUDE N 35' 24' 41.70" (35.411583')* (NAD '83) LONGITUDE W 78' 42' 42.18" (-78.711715')* (NAD '83)

GROUND ELEVATION (AMSL) = 226.9'*

*LATITUDE, LONGITUDE AND GROUND ELEVATION INFORMATION PER 1A BY TOWER ENGINEERING PROFESSIONALS DATED JUNE 1, 2022

ANSI/TIA-222-H LOCAL BUILDING CODE **CODE COMPLIANCE**

LATEST EDITIONS OF THE FOLLOWING

2018 NORTH CAROLINA BUILDING CODE (2015 IBC W/ AMENDMENTS)

NORTH CAROLINA CODE COUNCIL

POLE OWNER:

DUKE ENERGY 401 SOUTH WILMINGTON STREET RALEIGH, NC 27601 BAILEY OUTEN (919) 334-0797

POLE COORDINATES

PROPERTY OWNER:

CAROLINA POWER & LIGHT CO UNKNOWN UNKNOWN TODD HARRIS (919) 546-7996

SITE APPLICANT:

DUKE ENERGY 401 SOUTH WILMINGTON STREET RALEIGH, NC 27601 AARON COOK (919) 546-2036

AREA OF CONSTRUCTION: PRESENT OCCUPANCY TYPE: PROPOSED OCCUPANCY TYPE: PARCEL ID:

070680 0017 01 HARNETT COUNTY

180± S.F.

ELECTRICAL SUBSTATION

MICROWAVE POLE

UTILITIES:

JURISDICTION:

POWER COMPANY: CONTACT: POLE # NEAR SITE:

TELEPHONE COMPANY: CONTACT: PHONE: PEDESTAL # NEAR SITE:

SURVEYOR:

NAME ADDRESS CITY, STATE, ZIP CONTACT PHONE

CIVIL ENGINEER:

TOWER ENGINEERING PROFESSIONALS, INC. 326 TRYON ROAD RALEIGH, NC 27603 JOHN B. GOINS, P.E. (919) 661–6351

ALL WORK AND MATERIALS SHALL BE PERFORMED AND INSTALLED

ACCORDANCE WITH THE CURRENT EDITIONS OF THE FOLLOWING CODES
AS ADOPTED BY THE LOCAL GOVERNING AUTHORITIES. NOTHING IN THESE PLANS IS TO BE CONSTRUED TO PERMIT WORK NOT CONFORMING TO THE

4. NATIONAL ELECTRIC CODE

5. CITY/COUNTY ORDINANCES

(2020 EDITION)

STRUCTURAL ENGINEER:

(919) 661-6351

ELECTRICAL ENGINEER:

TOWER ENGINEERING PROFESSIONALS, INC. 326 TRYON ROAD RALEIGH, NC 27603 MARK S. QUAKENBUSH, P.E. (919) 661–6351 NAME ADDRESS CITY, STATE, ZIP CONTACT PHONE

GEOTECHNICAL ENGINEER:

TOWER ENGINEERING PROFESSIONALS, INC. 326 TRYON ROAD RALEIGH, NC 27603 JOHN D. LONGEST, P.E. (919) 661–6351

PROJECT TEAM

PROJECT SUMMARY DRIVING DIRECTIONS

DUKE ENERGY CUSTOMER SERVICE **POLE MANUFACTURER:** (800) 452-2777 LINKNOWN

GENERAL NOTES:

- ALL REFERENCES TO OWNER IN THESE DOCUMENTS SHALL BE CONSIDERED DUKE ENERGY OR ITS DESIGNATED REPRESENTATIVE
- ALL WORK PRESENTED ON THESE DRAWINGS MUST BE COMPLETED BY THE CONTRACTOR UNLESS NOTED OTHERWISE. THE CONTRACTOR MUST HAVE CONSIDERABLE EXPERIENCE IN PERFORMANCE OF WORK SIMILAR TO THAT DESCRIBED HEREIN. BY ACCEPTANCE OF THIS ASSIGNMENT, THE CONTRACTOR IS ATTESTING THAT HE DOES HAVE SUFFICIENT EXPERIENCE AND ABILITY, THAT HE IS KNOWLEDGABLE OF THE WORK TO BE PERFORMED AND THAT HE IS PROPERLY LICENSED AND PROPERLY REGISTERED TO DO THIS WORK IN THE STATE OF NORTH CAROLINA.
- STRUCTURE IS DESIGNED IN ACCORDANCE WITH ANSI/TIA-222-H STRUCTURAL STANDARD FOR ANTENNA SUPPORTING STRUCTURES. ANTENNAS, AND SMALL WIND TURBINE SUPPORT STRUCTURES AND THE 2018 NORTH CAROLINA STATE BUILDING CODE.
- WORK SHALL BE COMPLETED IN ACCORDANCE WITH THE 2018 NC BUILDING CODE (2015 IBC W/ AMENDMENTS)
- UNLESS SHOWN OR NOTED OTHERWISE ON THE CONTRACT DRAWINGS, OR IN THE SPECIFICATIONS, THE FOLLOWING NOTES SHALL APPLY TO THE MATERIALS LISTED HEREIN, AND TO THE PROCEDURES TO BE USED ON THIS PROJECT.
- 6. ALL HARDWARE ASSEMBLY MANUFACTURER'S INSTRUCTIONS SHALL BE FOLLOWED EXACTLY AND SHALL SUPERSEDE ANY CONFLICTING NOTES ENCLOSED HEREIN.
- 7. IT IS THE CONTRACTOR'S SOLE RESPONSIBILITY TO DETERMINE ERECTION PROCEDURE AND SEQUENCE. TO INSURE THE SAFETY OF THE STRUCTURE AND ITS COMPONENT PARTS DURING ERECTION AND/OR FIELD MODIFICATIONS. THIS INCLUDES, BUT IS NOT LIMITED TO, THE ADDITION OF TEMPORARY BRACING, GUYS OR TIE DOWNS THAT MAY BE NECESSARY. SUCH MATERIAL SHALL BE REMOVED AND SHALL REMAIN THE PROPERTY OF THE CONTRACTOR AFTER THE COMPLETION OF THE PROJECT.
- ALL DIMENSIONS, ELEVATIONS, AND EXISTING CONDITIONS SHOWN ON THE DRAWINGS SHALL BE FIELD VERIFIED BY THE CONTRACTOR PRIOR TO BEGINNING ANY MATERIALS ORDERING, FABRICATION OR CONSTRUCTION WORK ON THIS PROJECT. CONTRACTOR SHALL NOT SCALE CONTRACT DRAWINGS IN LIEU OF FIELD VERIFICATIONS. ANY DISCREPANCIES SHALL BE IMMEDIATELY BROUGHT TO THE ATTENTION OF THE OWNER AND THE OWNER'S ENGINEER. THE DISCREPANCIES MUST BE RESOLVED BEFORE THE CONTRACTOR IS TO PROCEED WITH THE WORK. THE CONTRACT DOCUMENTS DO NOT INDICATE THE METHOD OF CONSTRUCTION. THE CONTRACTOR SHALL SUPERVISE AND DIRECT THE WORK AND SHALL BE SOLELY RESPONSIBLE FOR ALL CONSTRUCTION MEANS, METHODS, TECHNIQUES, SEQUENCES, AND PROCEDURES. OBSERVATION VISITS TO THE SITE BY THE OWNER AND/OR THE ENGINEER SHALL NOT INCLUDE INSPECTION OF THE PROTECTIVE MEASURES OR THE PROCEDURES.
- ALL MATERIALS AND EQUIPMENT FURNISHED SHALL BE NEW AND OF GOOD QUALITY, FREE FROM FAULTS AND DEFECTS AND IN CONFORMANCE WITH THE CONTRACT DOCUMENTS. ANY AND ALL SUBSTITUTIONS MUST BE PROPERLY APPROVED AND AUTHORIZED IN WRITING BY THE OWNER AND ENGINEER PRIOR TO INSTALLATION. THE CONTRACTOR SHALL FURNISH SATISFACTORY EVIDENCE AS TO THE KIND AND QUALITY OF THE MATERIALS AND EQUIPMENT BEING SUBSTITUTED.
- 10. THE CONTRACTOR SHALL BE RESPONSIBLE FOR INITIATING, MAINTAINING, AND SUPERVISING ALL SAFETY PRECAUTIONS AND PROGRAMS IN CONNECTION WITH THE WORK. THE CONTRACTOR IS RESPONSIBLE FOR INSURING THAT THIS PROJECT AND RELATED WORK COMPLIES WITH ALL APPLICABLE LOCAL, STATE, AND FEDERAL SAFETY CODES AND REGULATIONS GOVERNING THIS WORK
- 11. ACCESS TO THE PROPOSED WORK SITE MAY BE RESTRICTED. THE CONTRACTOR SHALL COORDINATE INTENDED CONSTRUCTION ACTIVITY, INCLUDING WORK SCHEDULE AND MATERIALS ACCESS, WITH THE RESIDENT LEASING AGENT FOR APPROVAL.
- 12. BILL OF MATERIALS AND PART NUMBERS LISTED ON CONSTRUCTION DRAWINGS ARE INTENDED TO AID CONTRACTOR. CONTRACTOR SHALL VERIFY PARTS AND QUANTITIES WITH MANUFACTURER PRIOR TO BIDDING AND/OR ORDERING MATERIALS.
- 13. ALL PERMITS THAT MUST BE OBTAINED ARE THE RESPONSIBILITY OF THE CONTRACTOR. THE CONTRACTOR WILL BE RESPONSIBLE FOR ABIDING BY ALL CONDITIONS AND REQUIREMENTS OF THE PERMITS.
- 14. 24 HOURS PRIOR TO THE BEGINNING OF ANY CONSTRUCTION, THE CONTRACTOR MUST NOTIFY THE APPLICABLE JURISDICTIONAL (STATE, COUNTY OR CITY) ENGINEER.
- 15. THE CONTRACTOR SHALL REWORK (DRY, SCARIFY, ETC.) ALL MATERIAL NOT SUITABLE FOR SUBGRADE IN ITS PRESENT STATE. AFTER REWORKING, IF THE MATERIAL REMAINS UNSUITABLE, THE CONTRACTOR SHALL UNDERCUT THIS MATERIAL AND REPLACE WITH APPROVED MATERIAL. ALL SUBGRADES SHALL BE PROOFROLLED WITH A FULLY LOADED TANDEM AXLE DUMP TRUCK PRIOR TO PAVING. ANY SOFTER MATERIAL SHALL BE REWORKED OR REPLACED.
- 16. THE CONTRACTOR IS REQUIRED TO MAINTAIN ALL PIPES, DITCHES, AND OTHER DRAINAGE STRUCTURES FREE FROM OBSTRUCTION UNTIL WORK IS ACCEPTED BY THE OWNER. THE CONTRACTOR IS RESPONSIBLE FOR ANY DAMAGES CAUSED BY FAILURE TO MAINTAIN DRAINAGE STRUCTURE IN OPERABLE CONDITION.
- 17. ALL MATERIALS AND WORKMANSHIP SHALL BE WARRANTED FOR ONE YEAR FROM ACCEPTANCE DATE.
- 18. ALL BUILDING DIMENSIONS SHALL BE VERIFIED WITH THE PLANS (LATEST REVISION) PRIOR TO COMMENCING CONSTRUCTION. NOTIFY THE ENGINEER IMMEDIATELY IF ANY DESCREPANCEIES ARE DISCOVERED. THE OWNER SHALL HAVE A SET OF APPROVED PLANS AVAILABLE AT THE SITE AT ALL TIMES WHILE WORK IS BEING PERFORMED. A DESIGNATED RESPONSIBLE EMPLOYEE SHALL BE AVAILABLE FOR CONTACT BY GOVERNING AGENCY INSPECTORS.

STRUCTURAL STEEL NOTES:

- 1. THE FABRICATION AND ERECTION OF STRUCTURAL STEEL SHALL CONFORM TO THE AISC SPECIFICATIONS AND MANUAL OF STEEL CONSTRUCTION, LOAD AND RESISTANCE FACTOR DESIGN, 13TH EDITION.
- 2. UNLESS OTHERWISE NOTED, ALL STRUCTURAL ELEMENTS SHALL CONFORM TO THE FOLLOWING REQUIREMENTS:
 - STRUCTURAL STEEL, ASTM DESIGNATION A36 OR A992.
 - B. ALL BOLTS, ASTM A325 TYPE I GALVANIZED HIGH STRENGTH BOLTS.
 - ALL NUTS, ASTM A563 CARBON AND ALLOY STEEL NUTS.
 - ALL WASHERS, ASTM F436 HARDENED STEEL WASHERS.
- 3. ALL CONNECTIONS NOT FULLY DETAILED ON THESE PLANS SHALL BE DETAILED BY THE STEEL FABRICATOR IN ACCORDANCE WITH AISC SPECIFICATIONS AND MANUAL OF STEEL CONSTRUCTION, LOAD AND, RESISTANCE FACTOR DESIGN, 13TH EDITION.
- 4. HOLES SHALL NOT BE FLAME CUT THRU STEEL UNLESS APPROVED BY THE ENGINEER.
- 5. HOT-DIP GALVANIZE ALL ITEMS UNLESS OTHERWISE NOTED, AFTER FABRICATION WHERE PRACTICABLE. GALVANIZING: ASTM A123, ASTM, A153/A153M OR ASTM A653/A653M, G90, AS APPLICABLE.
- 6. REPAIR DAMAGED SURFACES WITH GALVANIZING REPAIR METHOD AND PAINT CONFORMING TO ASTM A780 OR BY APPLICATION OF STICK OR THICK PASTED MATERIAL SPECIFICALLY DESIGNED FOR REPAIR OF GALVANIZING. CLEAN AREAS TO BE REPAIRED AND REMOVE SLAG FROM WELDS. HEAT SURFACES TO WHICH STICK OR PASTE MATERIAL IS APPLIED, WITH A TORCH TO A TEMPERATURE SUFFICIENT TO MELT THE METALLICS IN STICK OR PASTE; SPREAD MOLTEN MATERIAL UNIFORMLY OVER SURFACES TO BE COATED AND WIPE OFF ANY
- 7. A NUT LOCKING DEVICE SHALL BE INSTALLED ON ALL PROPOSED AND/OR REPLACED BOLTS.
- 8. ALL PROPOSED AND/OR REPLACED BOLTS SHALL BE OF SUFFICIENT LENGTH TO EXCLUDE THE THREADS FROM THE SHEAR PLANE.
- 9. ALL PROPOSED AND/OR REPLACED BOLTS SHALL BE OF SUFFICIENT LENGTH SUCH THAT THE END OF THE BOLT BE AT LEAST FLUSH WITH THE FACE OF THE NUT. IT IS NOT PERMITTED FOR THE BOLT END TO BE BELOW THE FACE OF THE NUT AFTER TIGHTENING IS
- 10. ALL ASSEMBLY AND ANCHOR BOLTS ARE TO BE TIGHTENED TO A "SNUG TIGHT" CONDITION AS DEFINED IN SECTION 8.1 OF THE AISC, "SPECIFICATION FOR STRUCTURAL JOINTS USING ASTM A325 OR A490 BOLTS", DATED JUNE 30, 2004.
- 11. FLAT WASHERS ARE TO BE INSTALLED WITH BOLTS OVER SLOTTED HOLES.
- 12. DO NOT OVER TORQUE ASSEMBLY BOLTS. GALVANIZING ON BOLTS, NUTS, AND STEEL PARTS MAY ACT AS A LUBRICANT, THUS OVER TIGHTENING MAY OCCUR AND MAY CAUSE BOLTS TO CRACK AND SNAP OFF.
- 13. PAL NUTS ARE TO BE INSTALLED AFTER NUTS ARE TIGHT AND WITH EDGE LIP OUT. PAL NUTS ARE NOT REQUIRED WHEN SELF-LOCKING NUTS ARE PROVIDED.
- 14. GALVANIZED ASTM A325 BOLTS SHALL NOT BE REUSED.
- 15. WELDING SHALL BE PERFORMED IN ACCORDANCE WITH AMERICAN WELDING SOCIETY (AWS) D1.1-2010 STRUCTURAL WELDING CODE - STEEL.

FIBER NOTES:

FOR VERTICAL RUNS: ON TOWERS OR POLES, ALWAYS UNREEL THE SPOOL FROM THE TOP DOWN. ENSURE NO STRAIN IS PLACED ON THE FIRST 3 FEET OF THE CABLE, AND THAT THE CABLE IS SUPPORTED EVERY THREE FEET VERTICALLY. NEVER ALLOW THE CABLE TO EXPERIENCE THE STRAIN OF THE CABLE SPOOL WEIGHT. ANY BENDS SHALL BE SUPPORTED DIRECTLY ABOVE AND BELOW THE BEND. THE BOTTOM BEND SHALL HAVE A DRIP LOOP WITH A MINIMUM ONE FOOT BEND RADIUS AT 120°. IT IS RECOMMENDED THE FIBER BE TESTED BEFORE AND AFTER INSTALLATION FOR NO GREATER THAN .02 DB LOSS.



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BUIES CREEK **230 SUB** T5504 (NCBCU011)

1716 NC-27 LILLINGTON, NC 27546 (HARNETT COUNTY)





TOWER ENGINEERING PROFESSIONALS

326 TRYON ROAD RALEIGH, NC 27603 OFFICE: (919) 661-6351 www.tepgroup.net

N.C. LICENSE #C-1794



REV	DATE	ISSUED FOR:
0	07-07-22	PRELIMINARY CONSTRUCITON
- 1	08-29-22	PRELIMINARY CONSTRUCTION
2	10-28-22	CONSTRUCTION


DRAWN BY: GAH | CHECKED BY:

SHEET TITLE:

PROJECT NOTES


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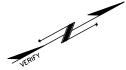
REVISION:

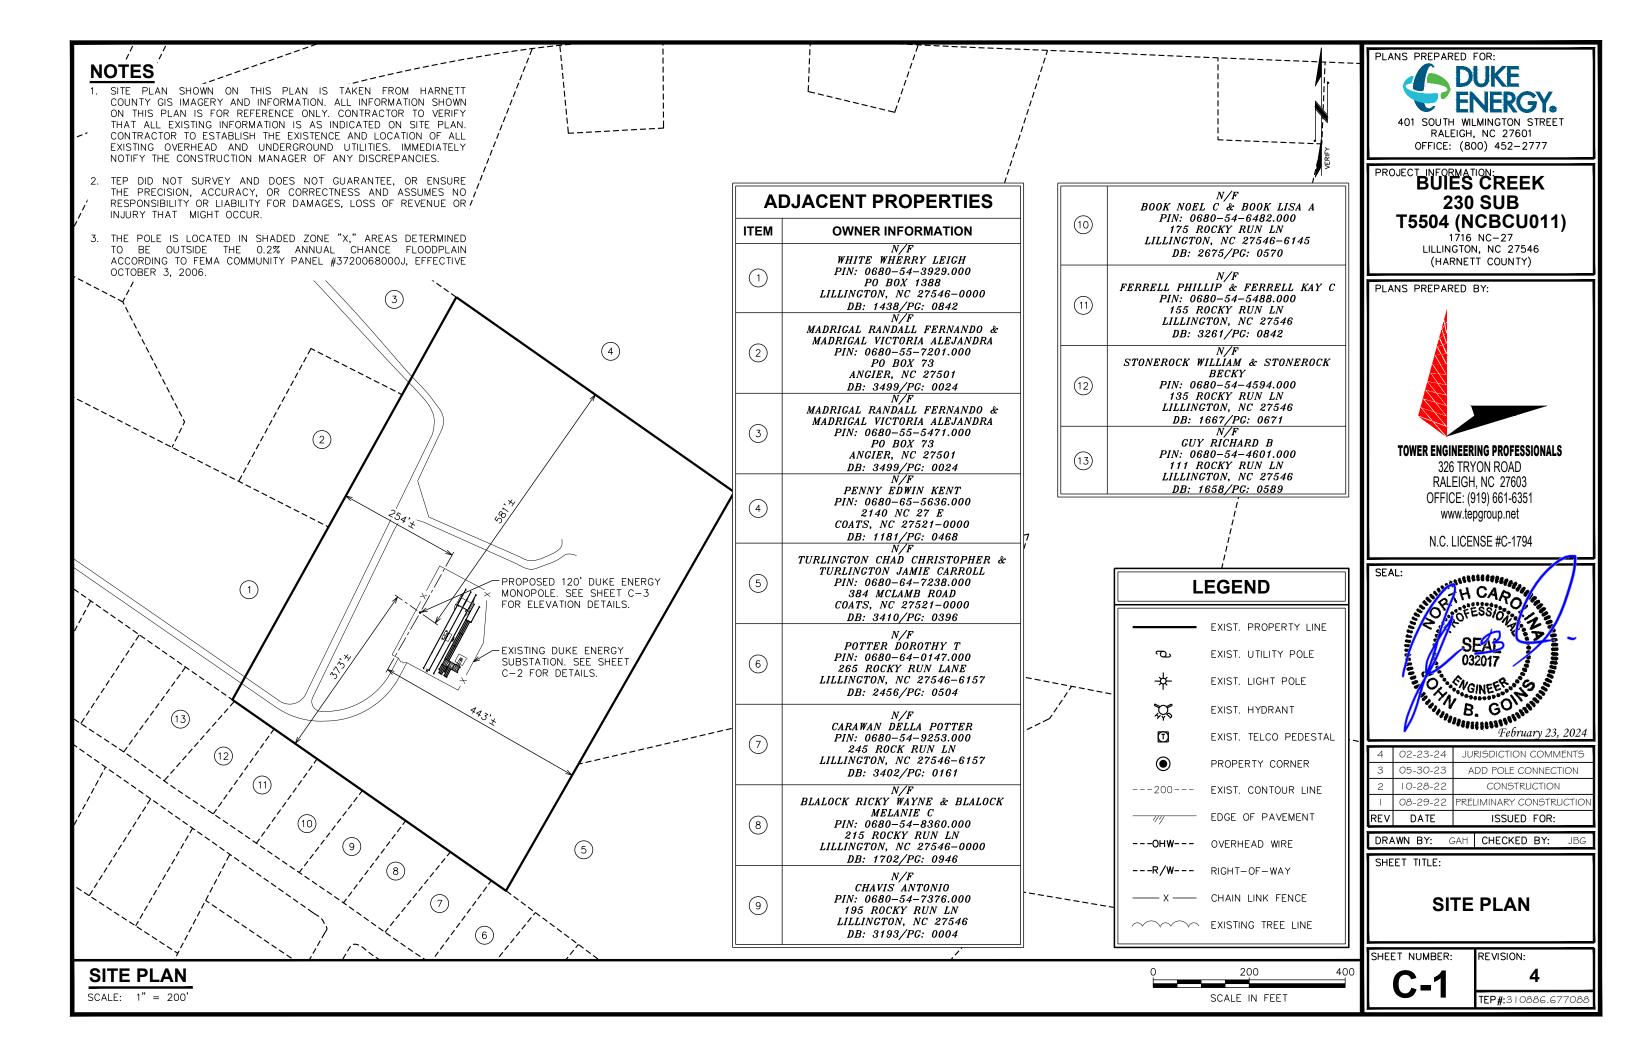

NOTES

- 1. SITE PLAN SHOWN ON THIS PLAN IS TAKEN FROM HARNETT COUNTY GIS IMAGERY AND INFORMATION. ALL INFORMATION SHOWN ON THIS PLAN IS FOR REFERENCE ONLY. CONTRACTOR TO VERIFY THAT ALL EXISTING INFORMATION IS AS INDICATED ON SITE PLAN. CONTRACTOR TO ESTABLISH THE EXISTENCE AND LOCATION OF ALL EXISTING OVERHEAD AND UNDERGROUND UTILITIES. IMMEDIATELY NOTIFY THE CONSTRUCTION MANAGER OF ANY DISCREPANCIES.
- 2. TEP DID NOT SURVEY AND DOES NOT GUARANTEE, OR ENSURE THE PRECISION, ACCURACY, OR CORRECTNESS AND ASSUMES NO RESPONSIBILITY OR LIABILITY FOR DAMAGES, LOSS OF REVENUE OR INJURY THAT MIGHT OCCUR.
- 3. THE POLE IS LOCATED IN SHADED ZONE "X," AREAS DETERMINED TO BE OUTSIDE THE 0.2% ANNUAL CHANCE FLOODPLAIN ACCORDING TO FEMA COMMUNITY PANEL #3720068000J, EFFECTIVE OCTOBER 3, 2006.



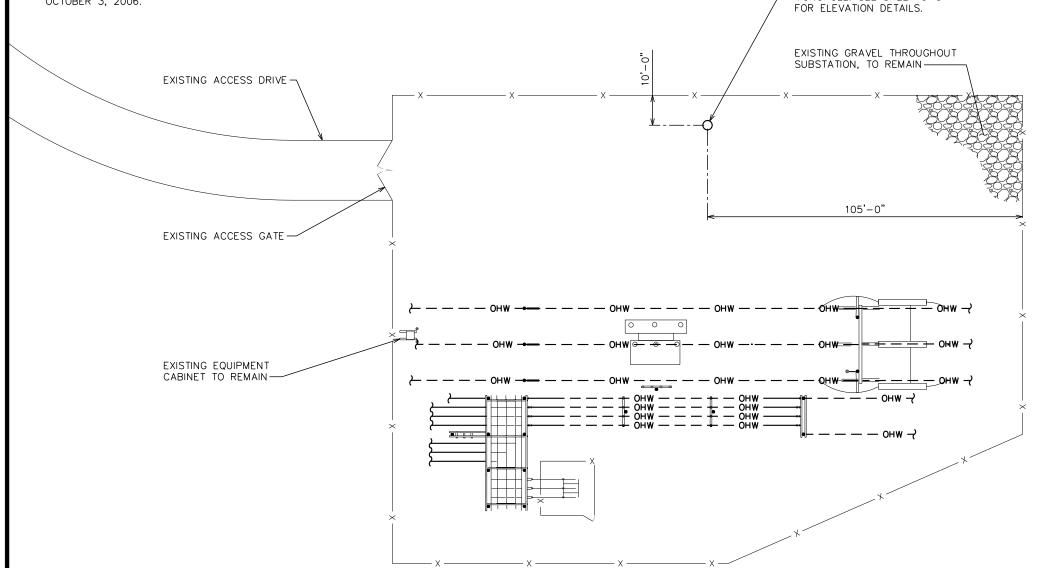

PROPOSED 120' DUKE ENERGY

MONOPOLE. SEE SHEET C-3




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BUIES CREEK 230 SUB T5504 (NCBCU011)

1716 NC-27 LILLINGTON, NC 27546 (HARNETT COUNTY)


PLANS PREPARED BY:

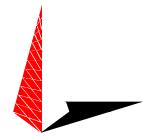

TOWER ENGINEERING PROFESSIONALS

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N.C. LICENSE #C-1794

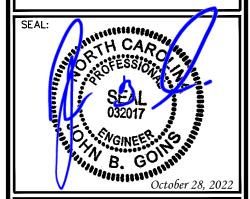

REV	V	DATE	ISSUED FOR:
0		07-07-22	PRELIMINARY CONSTRUCITON
- 1		08-29-22	PRELIMINARY CONSTRUCTION
2		10-28-22	CONSTRUCTION

DRAWN BY: GAH CHECKED BY: JB

SHEET TITLE:

COMPOUND DETAIL


SHEET NUMBER:

REVISION:

TEP#:310886.6770

COMPOUND DETAIL

SCALE IN FEET

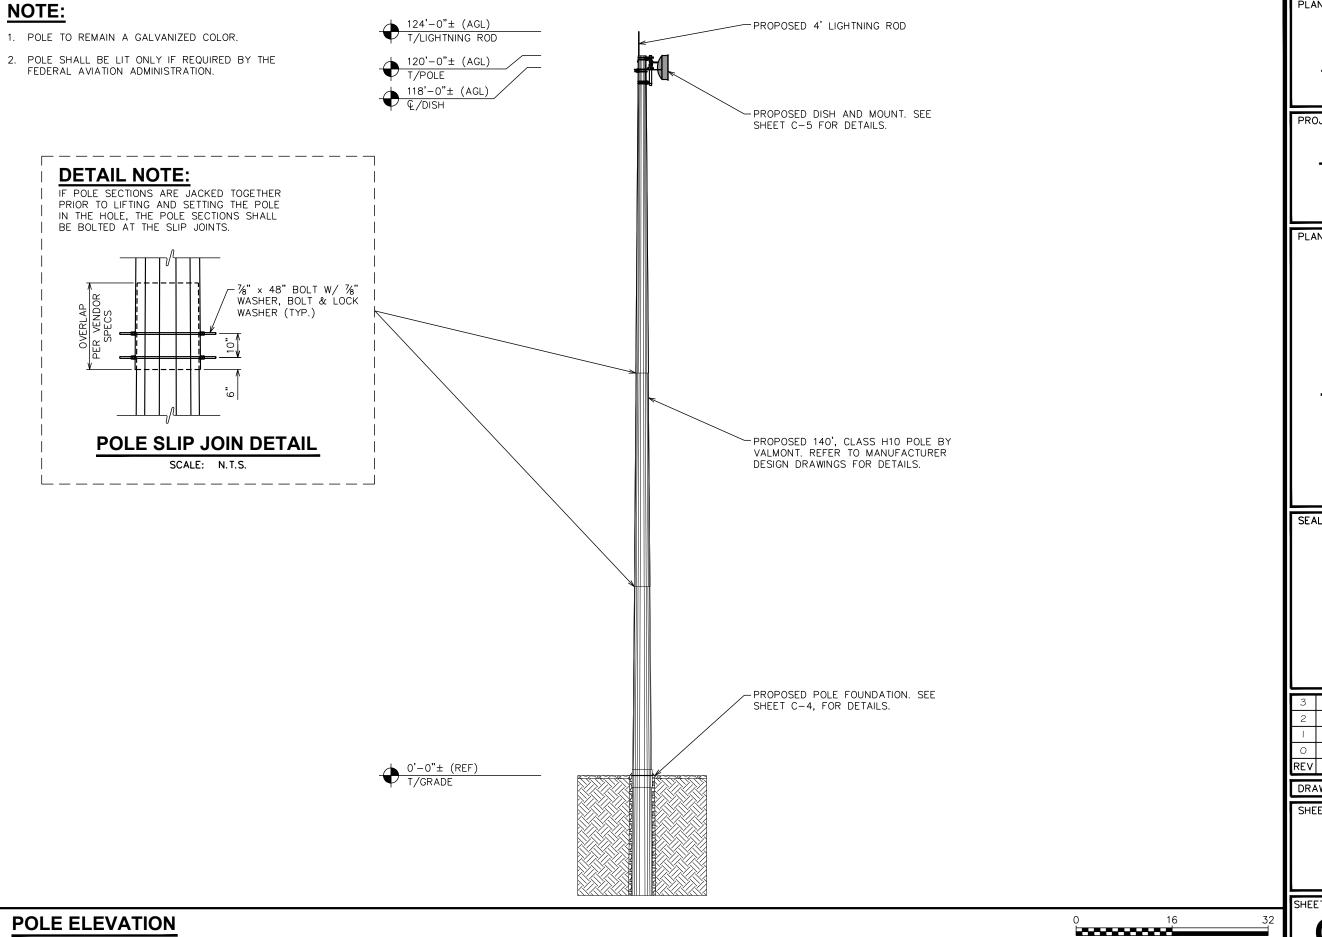

SCALE: $k_6'' = 1'-0''$

PLANS PREPARED FOR:


DUKE
ENERGY.

401 SOUTH WILMINGTON STREET
RALEIGH, NC 27601
OFFICE: (800) 452-2777

PROJECT INFORMATION: BUIES CREEK 230 SUB T5504 (NCBCU011)

1716 NC-27 LILLINGTON, NC 27546 (HARNETT COUNTY)

PLANS PREPARED BY:

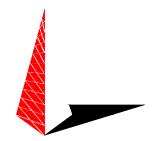

TOWER ENGINEERING PROFESSIONALS

326 TRYON ROAD RALEIGH, NC 27603 OFFICE: (919) 661-6351 www.tepgroup.net

N.C. LICENSE #C-1794



3	05-30-23	ADD POLE CONNECTION
2	10-28-22	CONSTRUCTION
1	08-29-22	PRELIMINARY CONSTRUCTION
0	07-07-22	PRELIMINARY CONSTRUCITON
REV	DATE	ISSUED FOR:

DRAWN BY: GAH CHECKED BY: JB

SHEET TITLE:

POLE ELEVATION

SHEET NUMBER:

SCALE IN FEET

REVISION:

C-3

CONTRACTOR SHALL FIELD VERIFY ALL: DIMENSIONS, QUANTITIES, PART NUMBERS AND COAX/ANTENNA PLACEMENTS PRIOR TO: BIDDING ORDERING MATERIALS, AND CONSTRUCTION.

REFERENCED DOCUMENTS			
DOCUMENT	REMARKS	DATE	
GEOTECHNICAL REPORT	TEP PROJECT NO.: 310886.677089	07-29-22	
POLE DESIGN DRAWINGS	VALMONT INDUSTRIES	06-22-22	
STRUCTURAL ANALYSIS	TEP PROJECT NO.: 310886.677091	08-25-22	

NOTE:

TOP OD

37.27"

BEARING PLATE DETAILS ARE SPECIFIED IN THE POLE MFG'S DRAWINGS. VERIFY PRIOR TO CONSTRUCTION.

BASE OD

41.00"

BACKFILL NOTES: FOUNDATION DESIGN

EMBEDMENT DEPTH	OVERALL POLE LENGTH		HOLE SHALL BE EXCAVATED BY AN AUGER OF SUFFI MINIMUM OF 6" BETWEEN THE SIDES OF THE HOLE APPROPER TAMPING/RODDING OF THE GRAVEL BACKFILL CITHE BOTTOM OF THE HOLD TO THE GROUND SURFACE.
20'	140.00'	2.	IF THE HOLE IS DRILLED DEEPER THAN REQUIRED. THE BACKFILLED WITH #57 STONE AND TAMPED BEFORE T BOTTOM OF THE HOLE IS SOFT OR IF WATER IS IN THE

- D DEEPER THAN REQUIRED. THE EXTRA DEPTH IS TO BE STONE AND TAMPED BEFORE THE POLE IS SET. IF THE BOTTOM OF THE HOLE IS SOFT OR IF WATER IS IN THE HOLE, #57 STONE SHALL BE USED TO FILL THE OVER-EXCAVATION.
- THE #57 STONE BACKFILL SHALL BE PLACED IN EVEN LIFTS WITH A MAXIMUM DEPTH OF 6" PER LIFT. THE STONE BACKFILL SHALL BE COMPACTED BY MECHANICALLY OR MANUALLY RODDING EACH LIFT AFTER PLACEMENT IN THE HOLE. THE MAXIMUM UNIFORM DENSITY FROM THE BOTTOM OF THE HOLE TO THE NATURAL GROUND SURFACE SHALL BE ATTAINED.
- AFTER COMPLETION OF BACKFILLING, THE BACKFILL SHALL BE BANKED AROUND THE POLE TO AN ELEVATION OF 6" ABOVE THE EXISTING GRADE.

/ATED BY AN AUGER OF SUFFICIENT SIZE TO ALLOW A EN THE SIDES OF THE HOLE AND THE POLE SO THAT ING OF THE GRAVEL BACKFILL CAN BE PERFORMED FROM 401 SOUTH WILMINGTON STREET RALEIGH, NC 27601 OFFICE: (800) 452-2777


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DRAWN BY: GAH | CHECKED BY:

SHEET TITLE:

POLE FOUNDATION **DETAIL & NOTES**

SHEET NUMBER:

REVISION:

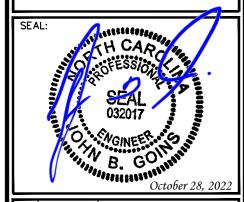TEP#:310886.677088

APPLIED LOADS

AXIAL	11898 LBS
MOMENT	848418 LB-FT
SHEAR	12785 LBS
DESIGN REACTIONS TAKEN FRO	OM THE STRUCTURAL


ANALYSIS LISTED IN THE REFERENCED DOCUMENTS CHART ABOVE.

DESIGN NOTE:


REFER TO VALMONT INDUSTRIES DRAWINGS FOR FINAL POLE AND FOUNDATION CONSTRUCTION, AND ASSEMBLY DETAILS. ANY INFORMATION SHOWN IN THIS DRAWING SHALL BE SUPERSEDED BY MANUFACTURER DESIGN DOCUMENTS.

FOUNDATION CONSTRUCTION:

THE FOUNDATION DESIGN IS BASED ON THE GEOTECHNICAL REPORT REFERENCED ABOVE. CONTRACTOR SHALL CONSULT THE GEOTECHNICAL REPORT PRIOR TO BIDDING AND CONSTRUCTION.

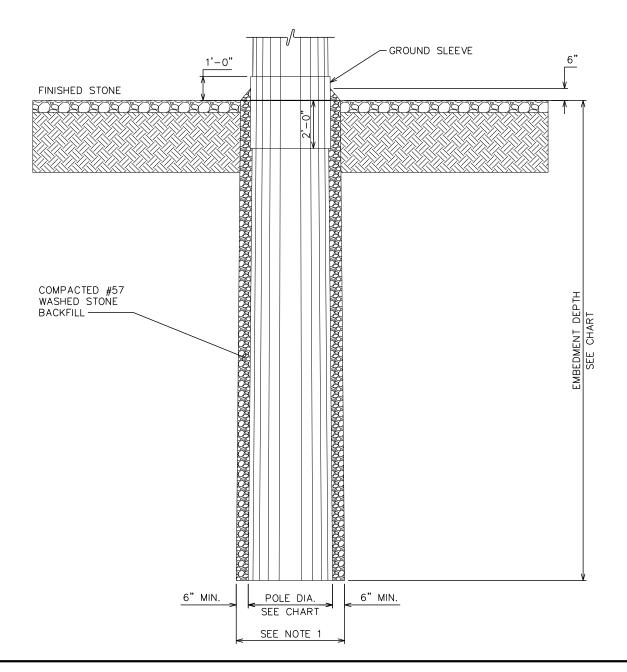

POLE FOUNDATION DETAIL

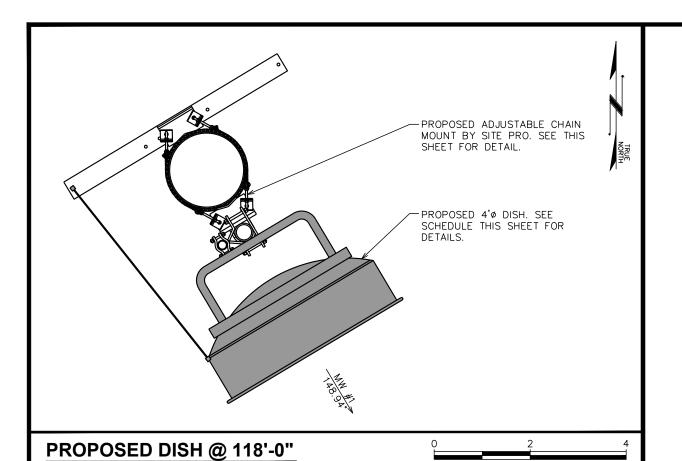



SCALE: $\frac{1}{2}$ " = 1'-0"


SCALE IN FEET


NOTE:

POLE DIAMETER AT 118': REFER TO POLE MANUFACTURER DRAWINGS

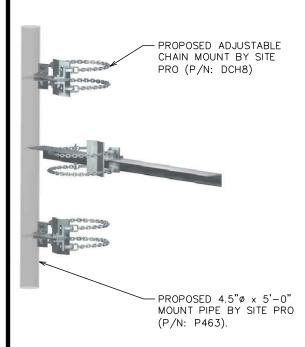

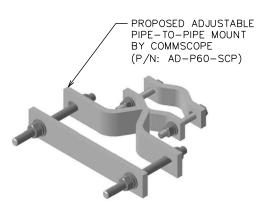

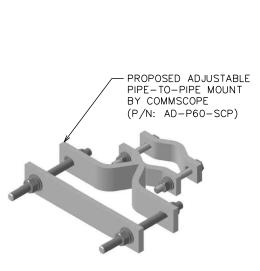

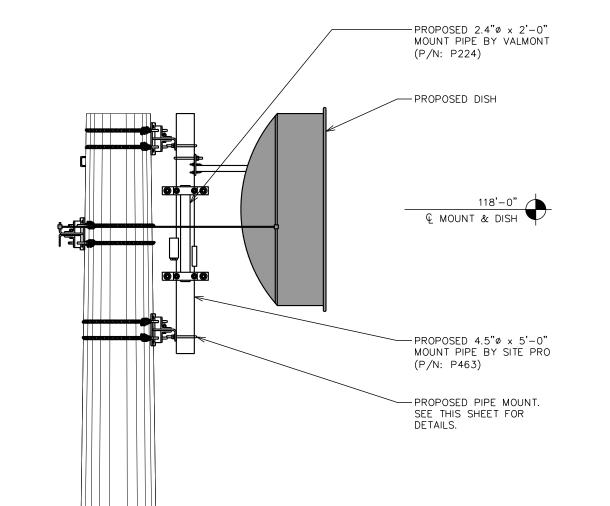

PROPOSED PIPE MOUNT PROFILE

SCALE: N.T.S.

PROPOSED ANTENNA/CABLE SCHEDULE					
TECHNOLOGY	MANUFACTURER (MODEL #)	MOUNTING HEIGHT	AZIMUTH	CABLE SIZE	CABLE LENGTH
DISH	RADIOWAVES (HPD4-5.2)	Ç ⊚ 118'-0"	148.94°	(1) CAT5e	*270'+
_	CAMBIUM (PMP450i NON-INTEGRATED)	¥ 9 110 0	140.54	(1) 0/1100	2701

*CONTRACTOR SHALL FIELD VERIFY COAX LENGTH PRIOR TO CONSTRUCTION.

PROPOSED PIPE MOUNT

PROP. PIPE-TO-PIPE MOUNT

PROPOSED ANTENNA/COAX SCHEDULE

SCALE: N.T.S.




401 SOUTH WILMINGTON STREET RALEIGH, NC 27601 OFFICE: (800) 452-2777

BUIES CREEK 230 SUB T5504 (NCBCU011)

1716 NC-27 LILLINGTON, NC 27546 (HARNETT COUNTY)


PLANS PREPARED BY:

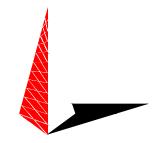

TOWER ENGINEERING PROFESSIONALS

326 TRYON ROAD RALEIGH, NC 27603 OFFICE: (919) 661-6351 www.tepgroup.net

N.C. LICENSE #C-1794

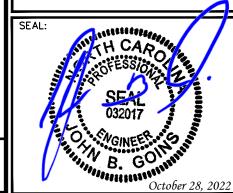

REV	DATE	ISSUED FOR:
0	07-07-22	PRELIMINARY CONSTRUCITON
-1	08-29-22	PRELIMINARY CONSTRUCTION
2	10-28-22	CONSTRUCTION


DRAWN BY: GAH CHECKED BY:

SHEET TITLE:

ANTENNA MOUNTING DETAILS

SHEET NUMBER:

REVISION:

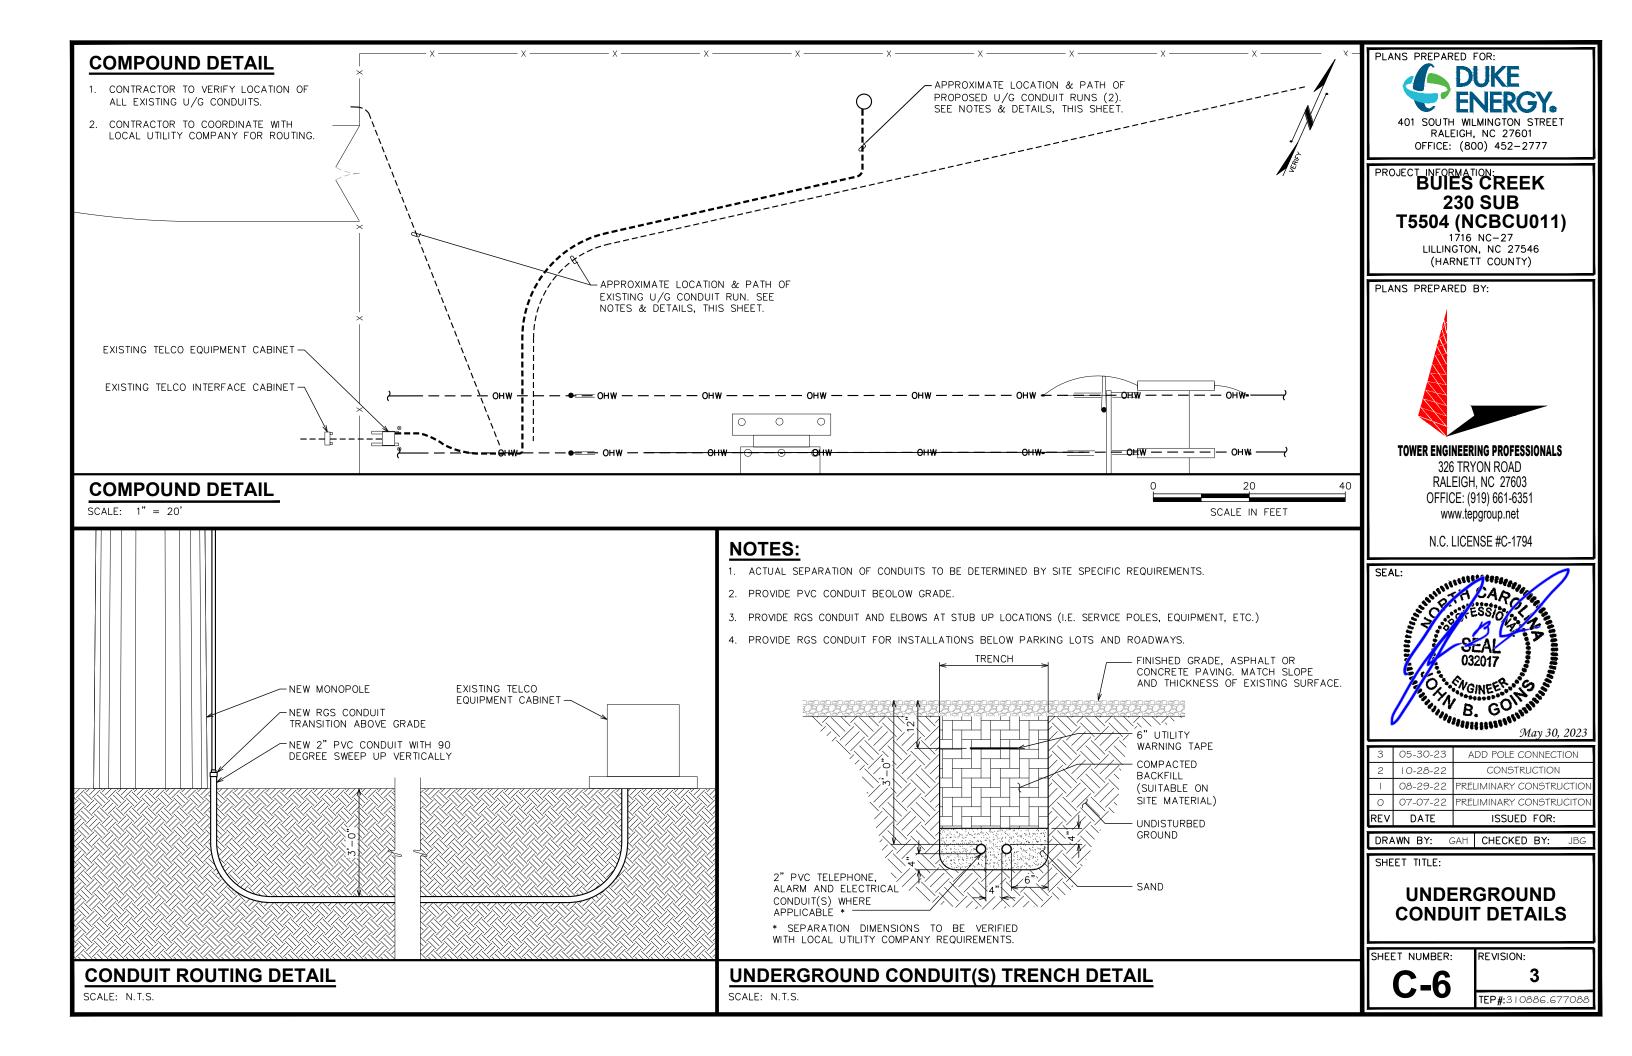

SCOPE:

 PROVIDE LABOR, MATERIALS, INSPECTION, AND TESTING TO PROVIDE CODE COMPLIANCE FOR ELECTRIC, TELEPHONE, AND GROUNDING/LIGHTNING SYSTEMS.

CODES:

- 1. THE INSTALLATION SHALL COMPLY WITH APPLICABLE LAWS AND CODES. THESE INCLUDE BUT ARE NOT LIMITED TO THE LATEST ADOPTED EDITIONS OF:
 - A. THE NATIONAL ELECTRICAL SAFETY CODE
- D. LOCAL AND STATE AMENDMENTS
- B. THE NATIONAL ELECTRIC CODE NFPA-70 C. REGULATIONS OF THE SERVING UTILITY COMPANY
- E. THE INTERNATIONAL ELECTRIC CODE IEC (WHERE APPLICABLE)
- 2. PERMITS REQUIRED SHALL BE OBTAINED BY THE CONTRACTOR.
- 3. AFTER COMPLETION AND FINAL INSPECTION OF THE WORK, THE OWNER SHALL BE FURNISHED A CERTIFICATE OF COMPLETION AND APPROVAL.

TESTING:

1. UPON COMPLETION OF THE INSTALLATION, OPERATE AND ADJUST THE EQUIPMENT AND SYSTEMS TO MEET SPECIFIED PERFORMANCE REQUIREMENTS. THE TESTING SHALL BE DONE BY QUALIFIED PERSONNEL.

GUARANTEE

- 1. IN ADDITION TO THE GUARANTEE OF THE EQUIPMENT BY THE MANUFACTURER, EACH PIECE OF EQUIPMENT SPECIFIED HEREIN SHALL ALSO BE GUARANTEED FOR DEFECTS OF MATERIAL OR WORKMANSHIP OCCURRING DURING A PERIOD OF ONE (1) YEAR FROM FINAL ACCEPTANCE OF THE WORK BY THE OWNER AND WITHOUT EXPENSE TO THE OWNER
- 2. THE WARRANTEE CERTIFICATES & GUARANTEES FURNISHED BY THE MANUFACTURERS SHALL BE TURNED OVER TO THE OWNER.

UTILITY CO-ORDINATION:

 CONTRACTOR SHALL COORDINATE WORK WITH THE POWER AND TELEPHONE COMPANIES AND SHALL COMPLY WITH THE SERVICE REQUIREMENTS OF EACH UTILITY COMPANY.

EXAMINATION OF SITE:

1. PRIOR TO BEGINNING WORK, THE CONTRACTOR SHALL VISIT THE SITE OF THE JOB AND SHALL FAMILIARIZE HIMSELF WITH THE CONDITIONS AFFECTING THE PROPOSED ELECTRICAL INSTALLATION AND SHALL MAKE PROVISIONS AS TO THE COST THEREOF. FAILURE TO COMPLY WITH THE INTENT OF THIS SECTION WILL IN NO WAY RELIEVE THE CONTRACTOR OF PERFORMING THE WORK NECESSARY FOR A COMPLETE AND WORKING SYSTEM OR SYSTEMS.

CUTTING, PATCHING AND EXCAVATION:

- COORDINATION OF SLEEVES, CHASES, ETC., BETWEEN SUBCONTRACTORS WILL BE REQUIRED PRIOR TO THE CONSTRUCTION OF ANY PORTION OF THE WORK. CUTTING AND PATCHING OF WALLS, PARTITIONS, FLOORS, AND CHASES IN CONCRETE, WOOD, STEEL OR MASONRY SHALL BE DONE AS PROVIDED ON THE DRAWINGS.
- 2. NECESSARY EXCAVATIONS AND BACKFILLING INCIDENTAL TO THE ELECTRICAL WORK SHALL BE PROVIDED BY THE ELECTRICAL CONTRACTOR UNLESS SPECIFICALLY NOTED OTHERWISE ON THE DRAWING.
- 3. SEAL PENETRATIONS THROUGH RATED WALLS, FLOORS, ETC., WITH APPROVED METHOD AS LISTED BY UL.

RACEWAYS / CONDUITS GENERAL:

- 1. CONDUCTORS SHALL BE INSTALLED IN LISTED RACEWAYS. CONDUIT SHALL BE RIGID STEEL, EMT, SCH40 PVC, OR SCH80PVC AS INDICATED ON THE DRAWINGS. THE RACEWAY SYSTEM SHALL BE COMPLETE COMPLETE BEFORE INSTALLING CONDUCTORS.
- 2. EXTERIOR RACEWAYS AND GROUNDING SLEEVES SHALL BE SEALED AT POINTS OF ENTRANCE AND EXIT. THE RACEWAY SYSTEM SHALL BE BONDED PER NEC.

EXTERIOR CONDUIT:

- EXPOSED CONDUIT SHALL BE NEATLY INSTALLED AND RUN PARALLEL OR PERPENDICULAR TO STRUCTURAL ELEMENTS. SUPPORTS AND MOUNTING HARDWARE SHALL BE HOT DIPPED GALVANIZED STEEL.
- 2. WHERE INSTALLED ON EXTERIOR STRUCTURES OR EXPOSED TO DAMAGE, THE CONDUIT SHALL BE RIGID STEEL.
- 3. UNDERGROUND CONDUITS SHALL BE RIGID STEEL, SCH40 PVC, OR SCH80 PVC AS INDICATED ON THE DRAWINGS
- 4. BURIAL DEPTH OF CONDUITS SHALL BE AS REQUIRED BY CODE FOR EACH SPECIFIC CONDUIT TYPE AND APPLICATION. BUT SHALL NOT BE LESS THAN THE FROST DEPTH AT THE SITE.
- 5. CONDUIT ROUTES ARE SCHEMATIC. CONTRACTOR SHALL FIELD VERIFY ROUTES BEFORE BID. COORDINATE ROUTE WITH WIRELESS CARRIER AND/OR BUILDING OWNER.

INTERIOR CONDUIT:

- I. CONCEALED CONDUIT IN WALLS OR INTERIOR SPACES ABOVE GRADE MAY BE EMT.
- 2. CONDUIT RUNS SHALL USE APPROVED COUPLINGS AND CONNECTORS. PROVIDE INSULATED BUSHING FOR ALL CONDUIT TERMINATIONS. CONDUIT RUNS IN A WET LOCATION SHALL HAVE WATERPROOF FITTINGS.
- 3. PROVIDE SUPPORTS FOR CONDUITS IN ACCORDANCE WITH NEC REQUIREMENTS. CONDUITS SHALL BE SIZED AS REQUIRED BY NEC.

EQUIPMENT:

- 1. DISCONNECT SWITCHES SHALL BE SERVICE ENTRANCE RATED, HEAVY DUTY TYPE.
- 2. CONTRACTOR SHALL VERIFY MAXIMUM AVAILABLE FAULT CURRENT AND COORDINATE INSTALLATION WITH THE LOCAL UTILITY BEFORE STARTING WORK. CONTRACTOR WILL VERIFY THAT EXISTING CIRCUIT BREAKERS ARE RATED FOR MORE THAN AVAILABLE FAULT CURRENT AND REPLACE AS NECESSARY.
- 3. NEW CIRCUIT BREAKERS SHALL BE RATED TO WITHSTAND THE MAXIMUM AVAILABLE FAULT CURRENT AS DETERMINED BY THE LOCAL UTILITY.

UL COMPLIANCE:

1. ELECTRICAL MATERIALS, DEVICES, CONDUCTORS, APPLIANCES, AND EQUIPMENT SHALL BE LABELED/LISTED BY UL OR ACCEPTED BY JURISDICTION (I.E., LOCAL COUNTY OR STATE) APPROVED THIRD PARTY TESTING AGENCY.

GROUNDING:

- 1. ELECTRICAL NEUTRALS, RACEWAYS AND NON-CURRENT CARRYING PARTS OF ELECTRICAL EQUIPMENT AND ASSOCIATED ENCLOSURES SHALL BE GROUNDED IN ACCORDANCE WITH NEC ARTICLE 250. THIS SHALL INCLUDE NEUTRAL CONDUCTORS, CONDUITS, SUPPORTS, CABINETS, BOXES, GROUND BUSSES, ETC. THE NEUTRAL CONDUCTOR FOR EACH SYSTEM SHALL BE GROUNDED AT A SINGLE POINT.
- 2. PROVIDE GROUND CONDUCTOR IN RACEWAYS PER NEC.
- 3. PROVIDE BONDING AND GROUND TO MEET NFPA 780 "LIGHTNING PROTECTION" AS A MINIMUM.
- 4. PROVIDE GROUNDING SYSTEM AS INDICATED ON THE DRAWINGS, AS REQUIRED BY THE NATIONAL ELECTRIC CODE, RADIO EQUIPMENT MANUFACTURERS, AND MOTOROLA R56 (AS APPLICABLE).

ABBREVIATIONS AND LEGEND

A - AMPERE PNLE
AFG - ABOVE FINISHED GRADE PVC

ATS - AUTOMATIC TRANSFER SWITCH AWG - AMERICAN WIRE GAUGE

BCW - BARE COPPER WIRE
BFG - BELOW FINISHED GRADE

BKR - BREAKER
C - CONDUIT
CKT - CIRCUIT

DISC - DISCONNECT

EGR — EXTERNAL GROUND RING
EMT — ELECTRIC METALLIC TUBING

FSC - FLEXIBLE STEEL CONDUIT

GEN - GENERATOR

GPS - GLOBAL POSITIONING SYSTEM

GRD - GROUND

IGB - ISOLATED GROUND BAR

IGR - INTERIOR GROUND RING (HALO)

KW - KILOWATTS

NEC - NATIONAL ELECTRIC CODE
PCS - PERSONAL COMMUNICATION SYSTEM

PH - PHASE

PNL – PANEL

PNLBD - PANELBOARD

PVC - RIGID NON-METALLIC CONDUIT RGS - RIGID GALVANIZED STEEL CONDUIT

SW - SWITCH

TGB - TOWER GROUND BAR

UL - UNDERWRITERS LABORATORIES

V - VOLTAGE W - WATTS XFMR - TRANSFORME

XFMR – TRANSFORMER XMTR – TRANSMITTER

---E--- UNDERGROUND ELECTRICAL CONDUIT
---T--- UNDERGROUND TELEPHONE CONDUIT

凸 KII ______ GF

KILOWATT-HOUR METER

UNDERGROUND BONDING AND
GROUNDING CONDUCTOR.

Ø GROUND ROD

EXOTHERMIC WELD

GROUND ROD WITH INSPECTION WELL




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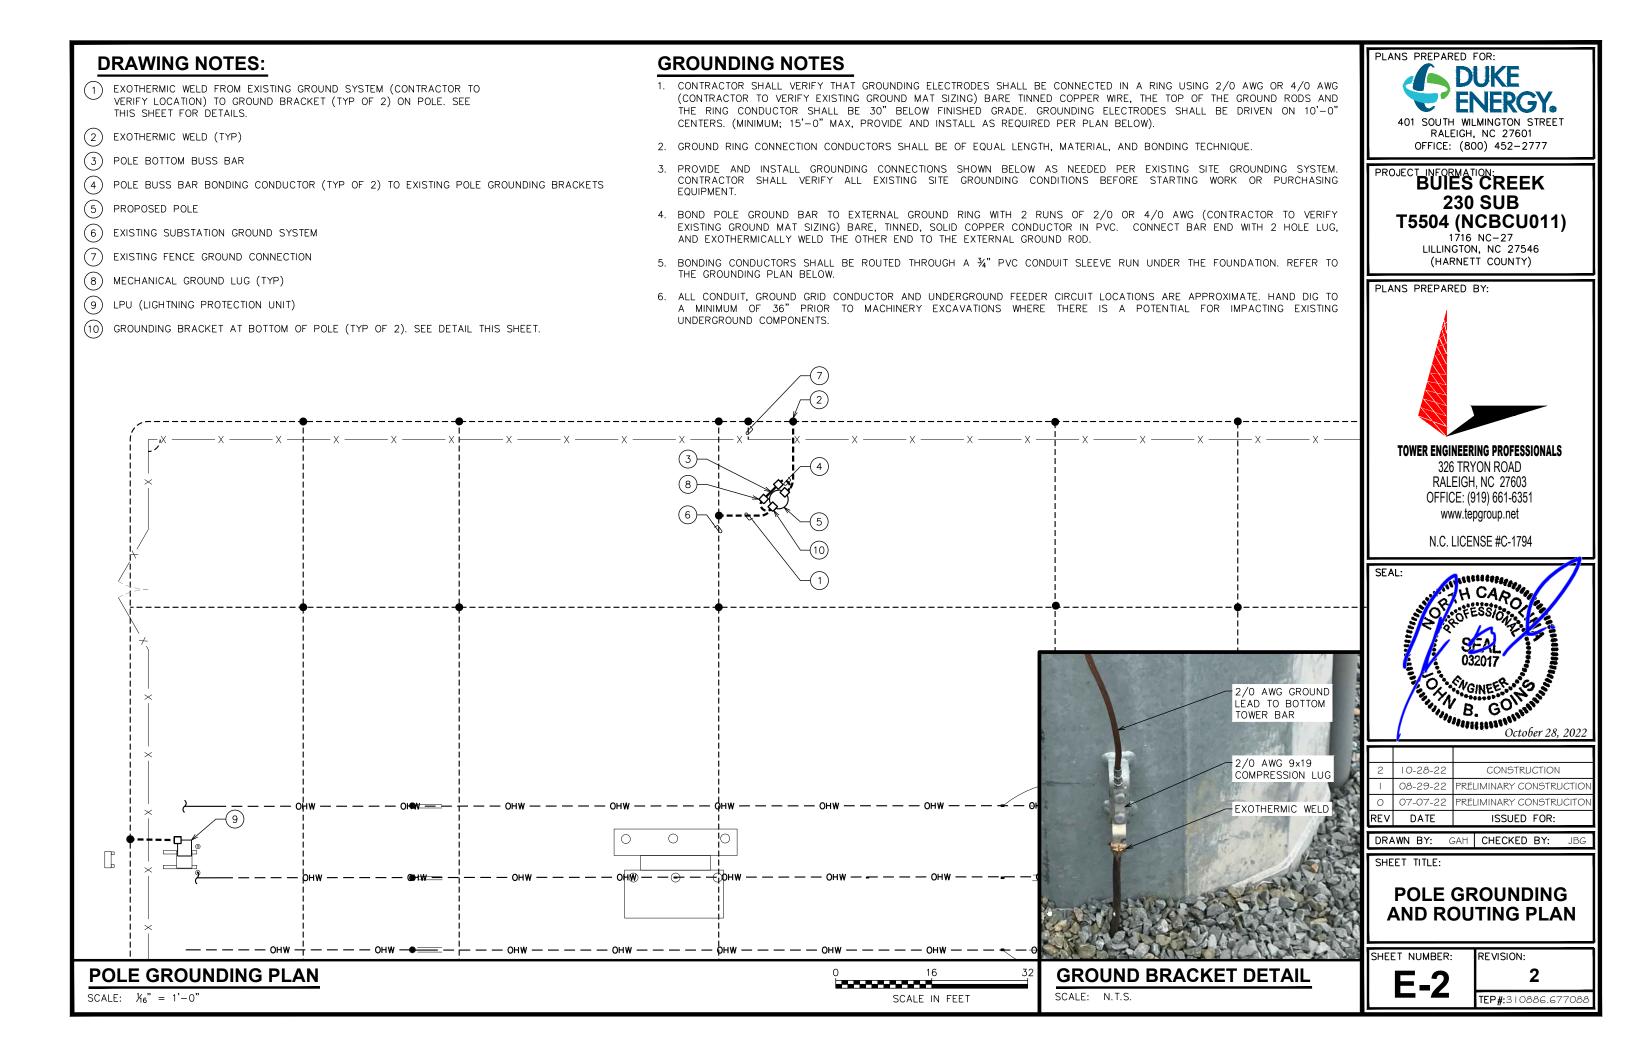
ELECTRICAL NOTES


SHEET NUMBER:

1

2

REVISION:

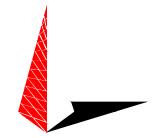

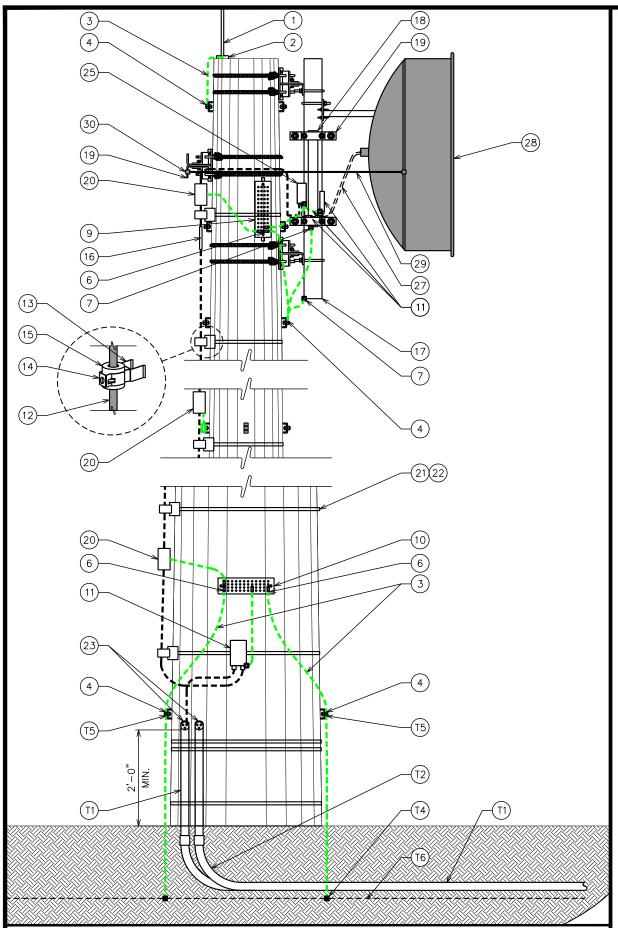

ITEM		BILL OF MATERIALS - TELECOMMUNICATIONS					
2 1 EA 1479387 TERMINAL, BRONZE AIR BASE, 1/2" DIA. INTERNALLY THREADED HUB 3 1 RO 1502506 WRE/CABLE, 2/0 AWG, CU, SOFT DRAWN, 19 STR, BARE CU, CLASS B, PACKAGED IN 25' HAND COILS. 4 6 EA 1503888 TERMINAL, LUG, 2/0 AWG CONDUCTOR, (2) 1/2" HOLE, 1" CTR, BLACK, LONG 5 1 EA 1612775 TERMINAL, LUG, 2/0 AWG CONDUCTOR, (2) 1/2" HOLE, 1" CTR, BLACK, LONG 6 3 EA 1504572 TERMINAL, LUG, 2/0 AWG CONDUCTOR, SIGL HOLE, 1" CTR, BLACK, LONG 8 3 EA LOOSE TERMINAL, LUG, 2/0 AWG CONDUCTOR, SIGL HOLE 3/8" POST F/ 8 3 EA LOOSE TERMINAL, LUG, 2/0 AWG CONDUCTOR, SIGL HOLE 3/8" POST F/ 8 3 EA LOOSE TERMINAL, LUG, #6 AWG, (2) 1/2" HOLE, 1 3/4" SPACE BLUE, LONG 9 1 EA 1525371 BAR, GROUND, 2" WD X 12" LG X 1/4" THK, W/ INSULATORS & BRACKETS, (18) PRE-DRILLED 7/16" HOLE 10 1 EA 1505048 BAR, GROUND, BUSS, 4" WD X 14" LG X 1/4" THK, INNED, W/ HARWARE 11 1 KT 1539777 LPU KIT, GROUNDING, LIGHTINING PROTECTION UNIT, ETHERNET CABLE, PREFITTED CABLE GLAND, WRE/CABLE, ELECTRICAL, CATS, 4 PAIR, 24 AWG, CU, SHIELDED INSULATION 13 4 PK 1505037 HANGER, CABLE, SNAP—IN STACKABLE, F/ 1-5/6" CABLE 15 4 PK 1564840 CUSHION, BARREL, 1-5/8", UNIVERSAL, 14-36MM, SNAP—IN, 10 PER BOX 16 1 EA 1503531 PIPE, 5' LG, ALUM, 4-1/2" OD, F/ ANTENNA MOUNT 18 1 EA 1503531 PIPE, 5' LG, ALUM, 4-1/2" OD, F/ ANTENNA MOUNT 19 1 EA 1501289 BRACKET, MOING, BOT DIP GALV STIL, BOOM GATE CLAMP SET, 4-1/2" TO 20 3 EA 1539778 KIT, SHIELD GROUNDING, GROUND STRIPS, MASTIC TAPE, ELECTRICAL TAPE, GROUND BOLT & NUT, RETAINING ZIP TIES, F/ 21 4 RO 1490605 BAND, STRAPPING, 3/4" WD, DO' LG, D.03" THK, 316 SS, 1800 LB 22 100 EA 1490606 BUCKLE, BANDING, 3/4" WD, SS 23 2 EA 904105 HEAD, SERVICE ENTERNACE, RIGID, 2", SLIP—ON-PVC, WEATHER HD, STD PKG/S 24 1 EA 1539782 MODULE, RADIO FROUNDING, CAMBIUM TICT BRACKET ASSY DISCRIBES SIP MODULE. 26 1 EA 1539782 MODULE, RADIO FROUNDING, CAMBIUM TICT BRACKET ASSY DISCRIBES SIP MODULE. 27 2 EA 1603548 JANTENNA, PARABOULE DISH, 5.25–5.85GHZ, N-FEMALE CONNECTOR, 4' HPDP, 34.1 DBI GAIN 28 1 EA 1501100 BRACKET, MOUNTING, STABILIZER B	ITEM	QTY	UNIT	MAXIMO PART NUMBER	DESCRIPTION		
1	1	1	EA	1505632	AIR TERMINAL, COPPER CLAD AIR BASE, ½° DIA. X 48°		
1	2	1	EA	1479387	TERMINAL, BRONZE AIR BASE, 1/2" DIA. INTERNALLY THREADED HUB		
1	3	1	RO	1502506			
6 3 EA 1504572 TERMINAL, LUG, 2/0 AWG, COMP. CU., (2) 3/8" HOLE, 1" CTR 7 2 EA 1505554 TERMINAL, LUG, 2/0 AWG CONDUCTOR, SGL HOLE 3/8" POST F/ 8 3 EA LOOSE TERMINAL, LUG, 2/0 AWG CONDUCTOR, SGL HOLE 3/8" POST F/ 8 15 EA LOOSE TERMINAL, LUG, 2/0 AWG CONDUCTOR, SGL HOLE 3/8" POST F/ 8 16 LOOSE TERMINAL, LUG, 2/0 AWG CONDUCTOR, SGL HOLE 3/8" POST F/ 8 17 EA 1525371 BAR, GROUND, 2" WD X 12" LG X 1/4" HOLE, 1 3/4" SPACE BLUE, LONG 9 1 EA 1525371 BAR, GROUND, 2" WD X 12" LG X 1/4" THK, W/ INSULATORS & BRACKETS, (18) PRE-DRILLED 7/16" HOLE 10 1 EA 1505048 BAR, GROUND, BUSS, 4" WD X 14" LG X 1/4" THK, TINNED, W/ HARWARE 11 1 KT 1539777 LPU KIT, GROUNDING, LIGHTNING PROTECTION UNIT, ETHERNET CABLE, PREFITTED CABLE GLAND. 12 1 SP 1539773 WIRE/CABLE, ELECTRICAL, CAT5, 4 PAIR, 24 AWG, CU, SHIELDED INSULATION 13 4 PK 1473338 BRACKET, UNIVERSAL STANDOFF MOUNTING, NO ADAPTER 14 4 PK 1505037 HANGER, CABLE, SNAP—IN STACKABLE, F/ 1–5/8" CABLE 15 4 PK 1564840 CUSHION, BARREL, 1–5/8", UNIVERSAL, 14–36MM, SNAP—IN, 10 PER BOX 16 1 EA 1554484 GRIP, CABLE, HOISTING, 3/8" CABLE, SS, PRE-LACED 17 1 EA 1503531 PIPE, 5' LG, ALUM, 4–1/2" OD, F/ ANTENNA MOUNT 18 1 EA 1479381 PIPE, 2–3/8", 2' LG, PLAIN ENDS, STL, F/ ANTENNA MOUNT 19 1 EA 1501289 BRACKET, MOUNTING, HOT DIP GALV STL, BOOM GATE CLAMP SET, 4–1/2" TO 12", 60 DEG ANGLE LEGS 20 3 EA 1539778 KIT, SHIELD GROUNDING, GROUND STRIPS, MASTIC TAPE, ELECTRICAL TAPE, GROUND BOLT & NUT, RETAINING ZIP TIES, F/ 21 4 RO 1490605 BAND, STRAPPING, 3/4" WD, 150 LG, 0.03" THK, 316 SS, 1800 LB 22 100 EA 1490606 BUCKLE, BANDING, 3/4" WD, 50 LG, 0.03" THK, 316 SS, 1800 LB 21 54 EA 154589 BRACKET, MOUNTING, CAMBIUM TILT BRACKET ASSY 22 EA 904105 HEAD, SERVICE ENTRANCE, RIGID, 2", SLIP—ON, PVC, WEATHER HD, STD PKG/5 23 1 EA 1539782 MODULE, RADIO FREQUENCY, CAMBIUM 5X GHZ PUMP 450I CONNECTORIZED SUBSCRIBER MODULE 24 1 EA 1546958 ANTENNA W/ SDE SUPPORT BRACKETS, F/ 4–1/2" DIA – 25 1 EA 1564958 ANTENNA W/ SDE SUPPORT BRACKETS, F/ 4–1/2" DIA – 26 1 EA 1603548 JUMPER, COAX, S' LG, N MALE TO N MALE, LMR-4-00, W	4	6	EA	1503888	TERMINAL, LUG, 2/0 AWG CONDUCTOR, (2) 1/2" HOLE BLACK, 1-3/4" CTR		
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15	13	4	PK	1473338	BRACKET, UNIVERSAL STANDOFF MOUNTING, NO ADAPTER		
16 1 EA 1554484 GRIP,CABLE, HOISTING, 3/8" CABLE, SS, PRE-LACED 17 1 EA 1503531 PIPE, 5' LG, ALUM, 4-1/2" OD, F/ ANTENNA MOUNT 18 1 EA 1479381 PIPE, 2-3/8", 2' LG, PLAIN ENDS, STL, F/ ANTENNA MOUNT 19 1 EA 1501289 BRACKET, MOUNTING, HOT DIP GALV STL, BOOM GATE CLAMP SET, 4-1/2" TO 12", 60 DEG ANGLE LEGS 20 3 EA 1539778 KIT, SHIELD GROUNDING, GROUND STRIPS, MASTIC TAPE, ELECTRICAL TAPE, GROUND BOLT & NUT, RETAINING ZIP TIES, F/ 21 4 RO 1490605 BAND,STRAPPING, 3/4" WD, 100' LG, 0.03" THK, 316 SS, 1800 LB 22 100 EA 1490606 BUCKLE, BANDING, 3/4" WD, SS 23 2 EA 904105 HEAD,SERVICE ENTRANCE,RIGID,2",SLIP-ON,PVC,WEATHER HD,STD PKG/5 24 1 EA 1545989 BRACKET, MOUNTING, CAMBIUM TILT BRACKET ASSY 25 1 EA 1539782 MODULE, RADIO FREQUENCY, CAMBIUM 5X GHZ PUMP 450I CONNECTORIZED SUBSCRIBER MODULE 26 1 EA 1588737 CHAIN MOUNT, FLUSH ANTENNA, CHAIN MOUNT, TIE BACK ARMS, U-BOLTS, F/DISH ANTENNA W/SIDE SUPPORT BRACKETS, F	14	4	PK	1505037	HANGER, CABLE, SNAP-IN STACKABLE, F/ 1-5/8" CABLE		
17 1 EA 1503531 PIPE, 5' LG, ALUM, 4-1/2" OD, F/ ANTENNA MOUNT 18 1 EA 1479381 PIPE, 2-3/8", 2' LG, PLAIN ENDS, STL, F/ ANTENNA MOUNT 19 1 EA 1501289 BRACKET, MOUNTING, HOT DIP GALV STL, BOOM GATE CLAMP SET, 4-1/2" TO 12", 60 DEG ANGLE LEGS 20 3 EA 1539778 KIT, SHIELD GROUNDING, GROUND STRIPS, MASTIC TAPE, ELECTRICAL TAPE, GROUND BOLT & NUT, RETAINING ZIP TIES, F/ 21 4 RO 1490605 BAND,STRAPPING, 3/4" WD, 100' LG, 0.03" THK, 316 SS, 1800 LB 22 100 EA 1490606 BUCKLE, BANDING, 3/4" WD, SS 23 2 EA 904105 HEAD,SERVICE ENTRANCE,RIGID,2",SLIP-ON,PVC,WEATHER HD,STD PKG/5 24 1 EA 1545989 BRACKET, MOUNTING, CAMBIUM TILT BRACKET ASSY 25 1 EA 1539782 MODULE, RADIO FREQUENCY, CAMBIUM 5X GHZ PUMP 450I CONNECTORIZED SUBSCRIBER MODULE 26 1 EA 1588737 CHAIN MOUNT, FLUSH ANTENNA, CHAIN MOUNT, TIE BACK ARMS, U-BOLTS, F/DISH ANTENNA W/ SIDE SUPPORT BRACKETS, F/4-1/2" DIA - 27 2 EA 1603548 JUMPER, COAX, 5' LG, N MALE TO N	15	4	PK	1564840	CUSHION, BARREL, 1-5/8", UNIVERSAL, 14-36MM, SNAP-IN, 10 PER BOX		
18 1 EA 1479381 PIPE, 2-3/8", 2' LG, PLAIN ENDS, STL, F/ ANTENNA MOUNT 19 1 EA 1501289 BRACKET, MOUNTING, HOT DIP GALV STL, BOOM GATE CLAMP SET, 4-1/2" TO 12", 60 DEG ANGLE LEGS 20 3 EA 1539778 KIT, SHIELD GROUNDING, GROUND STRIPS, MASTIC TAPE, ELECTRICAL TAPE, GROUND BOLT & NUT, RETAINING ZIP TIES, F/ 21 4 RO 1490605 BAND,STRAPPING, 3/4" WD, 100' LG, 0.03" THK, 316 SS, 1800 LB 22 100 EA 1490606 BUCKLE, BANDING, 3/4" WD, SS 23 2 EA 904105 HEAD,SERVICE ENTRANCE,RIGID,2",SLIP-ON,PVC,WEATHER HD,STD PKG/5 24 1 EA 1545989 BRACKET, MOUNTING, CAMBIUM TILT BRACKET ASSY 25 1 EA 1539782 MODULE, RADIO FREQUENCY, CAMBIUM 5X GHZ PUMP 450I CONNECTORIZED SUBSCRIBER MODULE 26 1 EA 1588737 CHAIN MOUNT, FLUSH ANTENNA, CHAIN MOUNT, TIE BACK ARMS, U-BOLTS, F/DISH ANTENNA W/SIDE SUPPORT BRACKETS, F/4-1/2" DIA - 27 2 EA 1603548 JUMPER, COAX, 5' LG, N MALE TO N MALE, LMR-400, W/WEATHER BOOTS 28 1 EA 1564958 ANTENNA, PARABOLI	16	1	EA	1554484	GRIP, CABLE, HOISTING, 3/8" CABLE, SS, PRE-LACED		
1	17	1	EA	1503531	PIPE, 5' LG, ALUM, 4-1/2" OD, F/ ANTENNA MOUNT		
12", 60 DEG ANGLE LEGS 12", 60 DEG ANGLE LEGS 1539778 KIT, SHIELD GROUNDING, GROUND STRIPS, MASTIC TAPE, ELECTRICAL TAPE, GROUND BOLT & NUT, RETAINING ZIP TIES, F/ 14 RO 1490605 BAND,STRAPPING, 3/4" WD, 100' LG, 0.03" THK, 316 SS, 1800 LB 1490606 BUCKLE, BANDING, 3/4" WD, SS 23 2 EA 904105 HEAD,SERVICE ENTRANCE,RIGID,2",SLIP-ON,PVC,WEATHER HD,STD PKG/5 24 1 EA 1545989 BRACKET, MOUNTING, CAMBIUM TILT BRACKET ASSY 25 1 EA 1539782 MODULE, RADIO FREQUENCY, CAMBIUM 5X GHZ PUMP 450I CONNECTORIZED SUBSCRIBER MODULE 26 1 EA 1588737 CHAIN MOUNT, FLUSH ANTENNA, CHAIN MOUNT, TIE BACK ARMS, U-BOLTS, F/DISH ANTENNA W/ SIDE SUPPORT BRACKETS, F/4-1/2" DIA - 27 2 EA 1603548 JUMPER, COAX, 5' LG, N MALE TO N MALE, LMR-400, W/ WEATHER BOOTS ANTENNA, PARABOLIC DISH, 5.25-5.85GHZ, N-FEMALE CONNECTOR, 4' HPDP, 34.1 DBI GAIN BRACKET, MOUNTING, STABILIZER BARS-STIFF ARM, F/4' & 6' DISH ANTENNA SERIES SP	18	1	EA	1479381	PIPE, 2-3/8", 2' LG, PLAIN ENDS, STL, F/ ANTENNA MOUNT		
20 3 EA 1539778 GROUND BOLT & NUT, RETAINING ZIP TIES, F/ 21 4 RO 1490605 BAND,STRAPPING, 3/4" WD, 100' LG, 0.03" THK, 316 SS, 1800 LB 22 100 EA 1490606 BUCKLE, BANDING, 3/4" WD, SS 23 2 EA 904105 HEAD,SERVICE ENTRANCE,RIGID,2",SLIP-ON,PVC, WEATHER HD,STD PKG/5 24 1 EA 1545989 BRACKET, MOUNTING, CAMBIUM TILT BRACKET ASSY 25 1 EA 1539782 MODULE, RADIO FREQUENCY, CAMBIUM 5X GHZ PUMP 450I CONNECTORIZED SUBSCRIBER MODULE 26 1 EA 1588737 CHAIN MOUNT, FLUSH ANTENNA, CHAIN MOUNT, TIE BACK ARMS, U-BOLTS, F/DISH ANTENNA W/ SIDE SUPPORT BRACKETS, F/4-1/2" DIA - 27 2 EA 1603548 JUMPER, COAX, 5' LG, N MALE TO N MALE, LMR-400, W/ WEATHER BOOTS 28 1 EA 1564958 ANTENNA, PARABOLIC DISH, 5.25-5.85GHZ, N-FEMALE CONNECTOR, 4' HPDP, 34.1 DBI GAIN 29 1 EA 1501100 BRACKET, MOUNTING, STABILIZER BARS-STIFF ARM, F/4' & 6' DISH ANTENNA SERIES SP	19	1	EA	1501289			
22 100 EA 1490606 BUCKLE, BANDING, 3/4" WD, SS 23 2 EA 904105 HEAD,SERVICE ENTRANCE,RIGID,2",SLIP-ON,PVC,WEATHER HD,STD PKG/5 24 1 EA 1545989 BRACKET, MOUNTING, CAMBIUM TILT BRACKET ASSY 25 1 EA 1539782 MODULE, RADIO FREQUENCY, CAMBIUM 5X GHZ PUMP 450I CONNECTORIZED SUBSCRIBER MODULE 26 1 EA 1588737 CHAIN MOUNT, FLUSH ANTENNA, CHAIN MOUNT, TIE BACK ARMS, U-BOLTS, F/DISH ANTENNA W/SIDE SUPPORT BRACKETS, F/4-1/2" DIA - 27 2 EA 1603548 JUMPER, COAX, 5' LG, N MALE TO N MALE, LMR-400, W/WEATHER BOOTS 28 1 EA 1564958 ANTENNA, PARABOLIC DISH, 5.25-5.85GHZ, N-FEMALE CONNECTOR, 4' HPDP, 34.1 DBI GAIN 29 1 EA 1501100 BRACKET, MOUNTING, STABILIZER BARS-STIFF ARM, F/4' & 6' DISH ANTENNA SERIES SP	20	3	EA	1539778	, , , , , , , , , , , , , , , , , , ,		
23 2 EA 904105 HEAD, SERVICE ENTRANCE, RIGID, 2", SLIP-ON, PVC, WEATHER HD, STD PKG/5 24 1 EA 1545989 BRACKET, MOUNTING, CAMBIUM TILT BRACKET ASSY 25 1 EA 1539782 MODULE, RADIO FREQUENCY, CAMBIUM 5X GHZ PUMP 450I CONNECTORIZED SUBSCRIBER MODULE 26 1 EA 1588737 CHAIN MOUNT, FLUSH ANTENNA, CHAIN MOUNT, TIE BACK ARMS, U-BOLTS, F/DISH ANTENNA W/SIDE SUPPORT BRACKETS, F/4-1/2" DIA - 27 2 EA 1603548 JUMPER, COAX, 5' LG, N MALE TO N MALE, LMR-400, W/WEATHER BOOTS 28 1 EA 1564958 ANTENNA, PARABOLIC DISH, 5.25-5.85GHZ, N-FEMALE CONNECTOR, 4' HPDP, 34.1 DBI GAIN 29 1 EA 1501100 BRACKET, MOUNTING, STABILIZER BARS-STIFF ARM, F/4' & 6' DISH ANTENNA	21	4	RO	1490605	BAND,STRAPPING, 3/4" WD, 100' LG, 0.03" THK, 316 SS, 1800 LB		
24 1 EA 1545989 BRACKET, MOUNTING, CAMBIUM TILT BRACKET ASSY 25 1 EA 1539782 MODULE, RADIO FREQUENCY, CAMBIUM 5X GHZ PUMP 450I CONNECTORIZED SUBSCRIBER MODULE 26 1 EA 1588737 CHAIN MOUNT, FLUSH ANTENNA, CHAIN MOUNT, TIE BACK ARMS, U-BOLTS, F/DISH ANTENNA W/ SIDE SUPPORT BRACKETS, F/4-1/2" DIA – 27 2 EA 1603548 JUMPER, COAX, 5' LG, N MALE TO N MALE, LMR-400, W/ WEATHER BOOTS 28 1 EA 1564958 ANTENNA, PARABOLIC DISH, 5.25-5.85GHZ, N-FEMALE CONNECTOR, 4' HPDP, 34.1 DBI GAIN 29 1 EA 1501100 BRACKET, MOUNTING, STABILIZER BARS-STIFF ARM, F/4' & 6' DISH ANTENNA SERIES SP	22	100	EA	1490606	BUCKLE, BANDING, 3/4" WD, SS		
25 1 EA 1539782 MODULE, RADIO FREQUENCY, CAMBIUM 5X GHZ PUMP 450I CONNECTORIZED SUBSCRIBER MODULE 26 1 EA 1588737 CHAIN MOUNT, FLUSH ANTENNA, CHAIN MOUNT, TIE BACK ARMS, U-BOLTS, F/DISH ANTENNA W/SIDE SUPPORT BRACKETS, F/4-1/2" DIA – 27 2 EA 1603548 JUMPER, COAX, 5' LG, N MALE TO N MALE, LMR-400, W/WEATHER BOOTS 28 1 EA 1564958 ANTENNA, PARABOLIC DISH, 5.25-5.85GHZ, N-FEMALE CONNECTOR, 4' HPDP, 34.1 DBI GAIN 29 1 EA 1501100 BRACKET, MOUNTING, STABILIZER BARS-STIFF ARM, F/4' & 6' DISH ANTENNA SERIES SP	23	2	EA	904105	HEAD, SERVICE ENTRANCE, RIGID, 2", SLIP-ON, PVC, WEATHER HD, STD PKG/5		
SUBSCRIBER MODULE 26 1 EA 1588737 CHAIN MOUNT, FLUSH ANTENNA, CHAIN MOUNT, TIE BACK ARMS, U-BOLTS, F/DISH ANTENNA W/SIDE SUPPORT BRACKETS, F/4-1/2" DIA – 27 2 EA 1603548 JUMPER, COAX, 5' LG, N MALE TO N MALE, LMR-400, W/WEATHER BOOTS 28 1 EA 1564958 ANTENNA, PARABOLIC DISH, 5.25-5.85GHZ, N-FEMALE CONNECTOR, 4' HPDP, 34.1 DBI GAIN 29 1 EA 1501100 BRACKET, MOUNTING, STABILIZER BARS-STIFF ARM, F/4' & 6' DISH ANTENNA	24	1	EA	1545989	BRACKET, MOUNTING, CAMBIUM TILT BRACKET ASSY		
DISH ANTENNA W/ SIDE SUPPORT BRACKETS, F/ 4-1/2" DIA - 27 2 EA 1603548 JUMPER, COAX, 5' LG, N MALE TO N MALE, LMR-400, W/ WEATHER BOOTS 28 1 EA 1564958 ANTENNA, PARABOLIC DISH, 5.25-5.85GHZ, N-FEMALE CONNECTOR, 4' HPDP, 34.1 DBI GAIN 29 1 EA 1501100 BRACKET, MOUNTING, STABILIZER BARS-STIFF ARM, F/ 4' & 6' DISH ANTENNA SERIES SP	25	1	EA	1539782			
28 1 EA 1564958 ANTENNA, PARABOLIC DISH, 5.25-5.85GHZ, N-FEMALE CONNECTOR, 4' HPDP, 34.1 DBI GAIN 29 1 EA 1501100 BRACKET, MOUNTING, STABILIZER BARS-STIFF ARM, F/ 4' & 6' DISH ANTENNA SERIES SP	26	1	EA	1588737			
29 1 EA 1501100 BRACKET, MOUNTING, STABILIZER BARS-STIFF ARM, F/ 4' & 6' DISH ANTENNA SERIES SP	27	2	EA	1603548	JUMPER, COAX, 5' LG, N MALE TO N MALE, LMR-400, W/ WEATHER BOOTS		
SERIES SP	28	1	EA	1564958			
30 1 EA NONE STIFF ARM SUPPORT BRACKET FOR 2-3/8 IN OD PIPE	29	1	EA	1501100			
	30	1	EA	NONE	STIFF ARM SUPPORT BRACKET FOR 2-3/8 IN OD PIPE		

BILL OF MATERIALS - TRANSMISSION					
ITEM	QTY	UNIT	MAXIMO PART NUMBER	DESCRIPTION	
T1	32	EA	61354	CONDUIT, RIGID, HEAVY WALL, 2", 10' LG, SCH 40, PVC, LG BELLED ONE END, RATED F/ 90 DEG C	
Т2	2	EA	79433	ELBOW, CONDUIT, RIGID, 2", GRAY PVC, 90 DEG, 9-1/2" RADIUS, PLAIN END, F/2" CONDUIT; PACKAGING: 15 PER PACK	
Т3	16	FT	4177461	WIRE/CABLE, ELECTRICAL, BARE, GROUND, 19 STR SOL SD, 9 AWG, DEAD SOFT ANNEALED COPPERCLAD	
T4	1	вх	50130218	POWDER, WELDING, EXO., #300PLUS20, LIGHT GREEN	
T5	2	EA	67295	TERMINAL, TIN PLTD CU CONDUCTOR, WELDED CONDUCTOR CONNECTION, (2)	

EXISTING SUBSTATION GROUND MAT

1/2" HOLE 1-3/4" CTR

N/A

PLANS PREPARED FOR: 401 SOUTH WILMINGTON STREET RALEIGH, NC 27601 OFFICE: (800) 452-2777

PROJECT INFORMATION:
BUIES CREEK 230 SUB T5504 (NCBCU011)

1716 NC-27 LILLINGTON, NC 27546 (HARNETT COUNTY)


PLANS PREPARED BY:



TOWER ENGINEERING PROFESSIONALS

326 TRYON ROAD RALEIGH, NC 27603 OFFICE: (919) 661-6351 www.tepgroup.net

N.C. LICENSE #C-1794

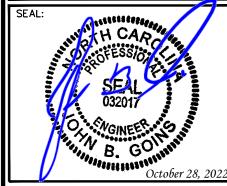

RFV	DATE	ISSUED FOR:
0	07-07-22	PRELIMINARY CONSTRUCITO
1	08-29-22	PRELIMINARY CONSTRUCTION
2	10-28-22	CONSTRUCTION

DRAWN BY: GAH CHECKED BY:

SHEET TITLE:


BILL OF MATERIALS

SHEET NUMBER:

TEP#:310886.6770


REVISION:

MONOPOLE ELEVATION (FRONT VIEW) SCALE: N.T.S.

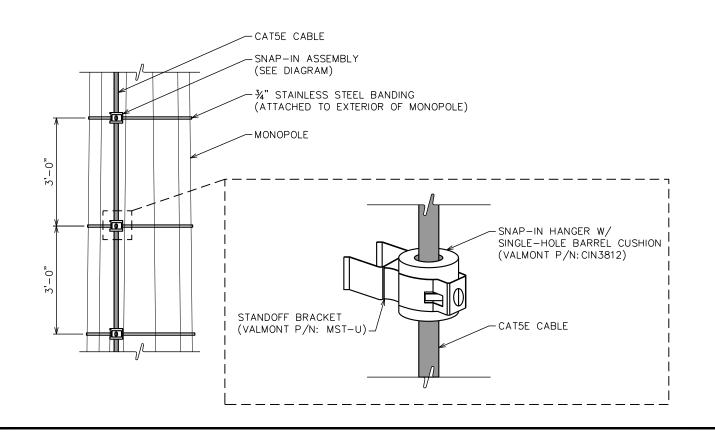

MONOPOLE GROUNDING

SCALE: N.T.S.

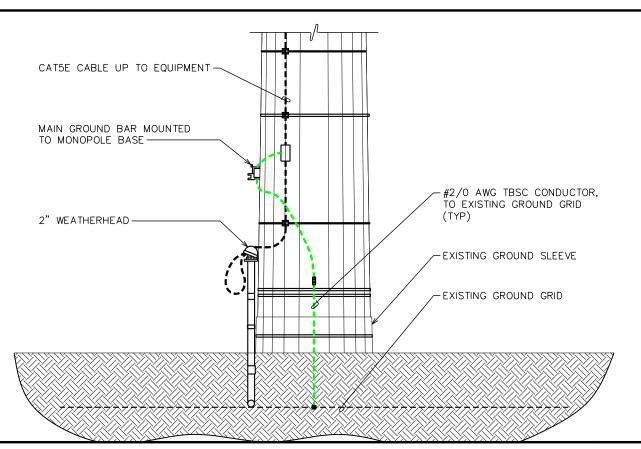

MONOPOLE BASE DETAIL (SIDE VIEW)

SCALE: N.T.S.



PROJECT INFORMATION: BUIES CREEK 230 SUB T5504 (NCBCU011)

1716 NC-27 LILLINGTON, NC 27546 (HARNETT COUNTY)


PLANS PREPARED BY:



TOWER ENGINEERING PROFESSIONALS

326 TRYON ROAD RALEIGH, NC 27603 OFFICE: (919) 661-6351 www.tepgroup.net

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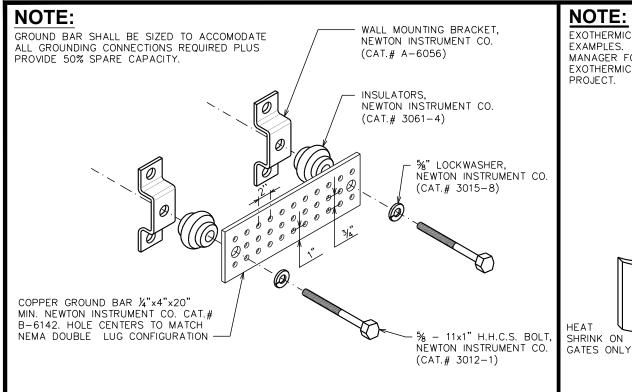
DRAWN BY: GAH CHECKED BY: JE

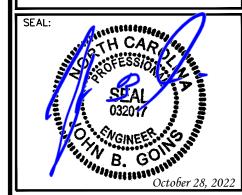SHEET TITLE:

GROUNDING DETAILS I


SHEET NUMBER:

REVISION:




NOTE:


EXOTHERMIC WELD "TYPES" SHOWN ARE EXAMPLES. CONSULT WITH PROJECT MANAGER FOR SPECIFIC TYPES OF EXOTHERMIC WELDS TO BE USED FOR THIS

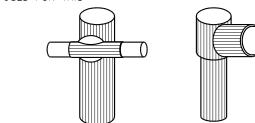


TYPE GY

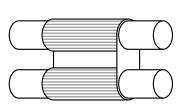



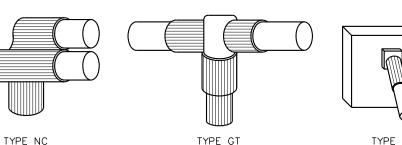

TYPE GR

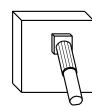


TYPE VB (POLE GROUNDING TAB)

401 SOUTH WILMINGTON STREET RALEIGH, NC 27601 OFFICE: (800) 452-2777

BUIES CREEK 230 SUB T5504 (NCBCU011)

1716 NC-27 LILLINGTON, NC 27546 (HARNETT COUNTY)

PLANS PREPARED BY:

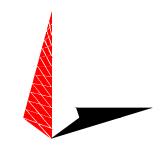

326 TRYON ROAD RALEIGH, NC 27603 OFFICE: (919) 661-6351 www.tepgroup.net

TOWER ENGINEERING PROFESSIONALS

N.C. LICENSE #C-1794

SEAL: Junentetetet B. GUIN October 28, 2022

RFV	DATE	ISSUED FOR:
0	07-07-22	PRELIMINARY CONSTRUCITON
- 1	08-29-22	PRELIMINARY CONSTRUCTION
2	10-28-22	CONSTRUCTION

DRAWN BY: GAH CHECKED BY:

SHEET TITLE:

GROUNDING DETAILS II

SHEET NUMBER:

REVISION:

TEP#:310886.6770


STANDARD GROUND BAR DETAIL

SCALE: N.T.S.

EXOTHERMIC WELD DETAILS

TYPE VBC

SCALE: N.T.S.

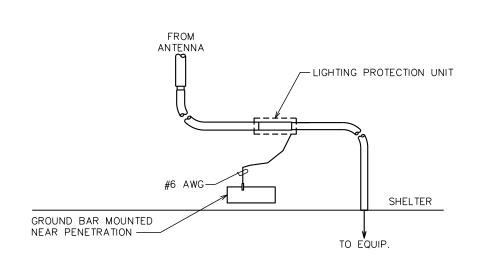

NOTE: MINIMUM SPACING OF GROUND WIRE 12" BETWEEN ALL EXOTHERMIC WELDS. (TYP) - GROUND ROD EXOTHERMIC WELD (TYP) **TOP VIEW** - GROUND WIRE - EXOTHERMIC WELD (TYP) GROUND ROD **SIDE VIEW**

POE CABLE GROUNDING DETAIL

EXOTHERMIC WELD GROUNDING DETAIL

SCALE: N.T.S.