

Submittal Record

Date: December 3, 2024

LS3P ASSOCIATES LTD. 205 1/2 KING STREET, CHARLESTON, SC 29401

Attn: Anne Bean

Submittal # 283100.001

Cycle

Sub-Section

Description Fire Alarm
Type Shop Drawings
Status Open

Copies

Subcontractor SOUTH-FAIR ELECTRIC

Chris Duven

CONTRACTORS, INC

Contact Name

Returned Due Date

12/17/2024

Submittal Stamp
Swinerton Builders

Submittal # 283100.001

Reviewed only as to the general design and requirements of the contract documents. Subcontractor to verify dimensions, quantities, and field conditions for proper and complete installation of this work. Approval shall not relieve subcontractor or supplier from responsibility for errors or deviations from the contract documents

By Kwizera Josephat Date 12/3/2024

STAMPS:

SUBMITTAL REVIEW

THIS REVIEW IS FOR GENERAL COMPLIANCE WITH THE DESIGN INTENT OF THE CONTRACT DOCUMENTS. ALL COORDINATION OF THE WORK AND STRICT COMPLIANCE WITH THE CONTRACT DOCUMENTS IS THE SOLE RESPONSIBILITY OF THE CONTRACTOR. THE ENGINEER ASSUMES NO RESPONSIBILITY FOR THE SUITABLITY OF ANY SUBSTITUTE MATERIALS AS DEPICTED IN THIS SUBMITTAL

	REVIEWED
\checkmark	REVIEWED AS NOTED
	REVISE AND RESUBMIT
	REJECTED

BARRETT, WOODYARD, & ASSOCIATES, INC.
BY: AMR
DATE: 12/05/24

Sincerely,

Kwizera Josephat Swinerton Builders

Page 1 of 1 Print Date: 12/3/2024 10:56 AM

SCOPE OF WORK

STAR LIFE SAFETY SHALL INSTALL A NEW ADDRESSABLE FIRE ALARM SYSTEM. THE ADDRESSABLE FIRE ALARM SYSTEM WILL HAVE VOICE COMMUNICATION IN THE USE OF HORN/STROBE NOTIFICATION DEVICES. SIGNAL LINE CIRCUITS FOR INITIATING DEVICES WILL ALSO BE INSTALLED. INSTALLATION OF ALL DEVICES SHALL MEET LOCAL AHJ & NFPA REQUIREMENTS.

SYSTEM INFORMATION:

BUILDING INFORMATION:

F.B.O. FURNISHED BY OTHERS

SYSTEM TYPE: SIEMENS ADDRESSABLE FIRE ALARM SYSTEM NOTIFICATION CIRCUIT: [4 CLASS "B" CIRCUIT]

NOTIFICATION CIRCUIT: [4 CLASS "B" CIRCUIT]
SLC CIRCUIT: [1 CLASS "B" CIRCUIT]

BUILDING STORIES: [1 STORY BUILDING]
BUILDING SQUARE FOOTAGE: [22,725 S.F.]

FIRE ALARM LEGEND SYMBOL MODEL NO. DESCRIPTION MAN. FACP FIRE ALARM CONTROL PANEL SIEMENS FC922 FCPS | FIELD CHARGING POWER SUPPLY SIEMENS PAD-5-6A FAA FIRE ALARM REMOTE ANNUNCIATOR SIEMENS FT2015-U3 F PULL STATION [DUAL ACTION] SIEMENS XMS-DS PHOTOELECTRIC SMOKE DETECTOR W/ MOUNTING BASE SIEMENS HORN STROBE [CEILING MOUNTED] [RED] [FIRE]

SEE FLOOR PLAN FOR CANDELA RATING SIEMENS SL2HSCR-F XX STROBE [CEILING MOUNTED] [RED] [FIRE]

SEE FLOOR PLAN FOR CANDELA RATING SIEMENS SL2SCR-F SP1 SURGE PROTECTOR [120V]
[FOR USE WITH PRIMARY/SECONDARY CONTROLS] DITEK DTK-120SRD END OF LINE RESISTOR F.B.O. F.B.O.

	<u>REVISION LEGEND</u>
PAGE #	DESCRIPTION
FA-001	FIRE ALARM SCOPE OF WORK, LEGEND, MATRIX & RISER DIAGRAM
FA-002	FIRE ALARM FLOOR PLAN
FA-003	FIRE ALARM DEVICE WIRING DETAILS
FA-004	FIRE ALARM CONTROL PANEL WIRING DIAGRAM

<u>FIRE ALARM NOTES</u>

FACP & ANNUNCIATOR INFORMATION

1. THE FIRE ALARM SYSTEM SHALL BE A NEW ADDRESSABLE SYSTEM.

2. THE FIRE ALARM CONTROL PANEL (FACP) SHALL BE LOCATED IN THE BACK OF TRUCK BAY AREA.

THE FIRE ALARM CONTROL PANEL (FACP) SHALL BE LOCATED IN THE BACK OF TRUCK BAY AREA.
 ALL ALARMS SHALL BE TRANSMITTED BY A UL LISTED COMMUNICATOR TO UL LISTED CENTRAL STATION.
 REMOTE ANNUNCIATOR SHALL BE READABLE AND VISIBLE FROM OUTSIDE THE BUILDING AND LOCATED AT THE MAIN ENTRANCE.

SPRINKLER INFORMATION

1. ENTIRE BUILDING SHALL BE PROTECTED BY A SPRINKLER SYSTEM.

2. SPRINKLER SYSTEM SHALL BE MONITORED VIA WATERFLOW & TAMPER SWITCH.

INITIATING DEVICES

1. ALL EQUIPMENT SHALL BE INSTALLED IN COMPLIANCE WITH ALL LISTED DISTANCES, LOCAL ORDINANCES AND NFPA-72 RECOMMENDATIONS.


2. ALL MANUAL PULL STATIONS SHALL BE MOUNTED 48-INCHES FROM FINISHED FLOOR TO THE TOP OF THE DEVICE.

NOTIFICATION DEVICES

1. ALL AUDIBLE/STROBE DEVICES SHALL HAVE A TEMPORAL—3 CODE.


ALL STROBE DEVICES SHALL REMAIN ACTIVE AFTER SILENCE FUNCTION OCCURS.

ALL AUDIBLE/STROBE AND STROBE DEVICES SHALL BE MOUNTED 80—INCHES FROM THE FINISHED FLOOR TO THE BOTTOM OF THE

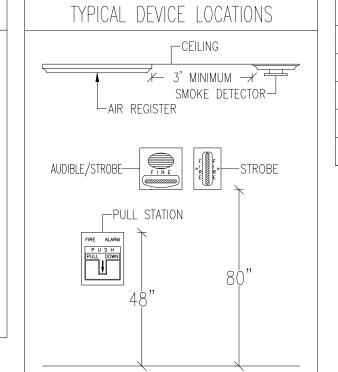


F		WIRE LEGEND	
	TYPE	WIRE DESCRIPTION	SYMB0L
	FPLP	16-2 TWISTED / NON-SHIELDED	Α
	FPLP	14-2 NON-SHIELDED	В
	FPLP	12-2 NON-SHIELDED	С
	FPLP	16-2 TWISTED / SHEILDED	D
		•	

FIRE ALARM SYSTEM	MA	ΔT	RI)	Χ		ВΙ	JILI	DIN	1G	SY	/ST	EM	0	UT	PU	TS						CENTRAL COMM
		A CT. COM.	CIVATE AUDIDIO ALARM S.	ACT. COMMO. ALARM S.	ACT. AUDIO. SUPERWSON.	ACTI TO COMIC. SUPERVISOR MINIC.	CITY AUDIN TROUBLE OF WOICATOR	NSD. GENERAL MOUBLE SIGNAL MOUSE	1. LAY CHANGE EVACUATIONAL SICATOR	IRM. FEXTER STATIS SIGNAL	TRAMITY FIRE ALL HORNES	RANG SUPERING SIGNAL TO BES	RETHER TROUBLE SIGNAL TO CENTRAL ST.	RETINGUE LEVATOR SIGNAL TO CENTRAL STATION	HIMT ELEVATOR - ALTERNA - STATION	SHITT ATER BE FIRST FISH	JOOWN RESPECT	THOW CHANGE OF HYAC	RAMOF OF STATUES OF	IRANGE STATUS ON AUMUNICATION ON STATUS ON STA	TRAM. SIPERISORY SIGNAL TO PAME.	TO CENTRAL STATON TO CENTRAL STATON SONAL TO CENTRAL STATON TO CENTRAL STATON
MANUAL FIRE ALARM PULL BOXES	X	X					/ x	/ X	X	X		\vdash					Х	X	X	\vdash	\vdash	
BUILDING SMOKE DETECTOR	Х	Х					Х	Χ	Χ	Х							Х	Х	Х			
DUCT SMOKE DETECTOR			Х	Х				Χ			Х					Х	Х	Х		Х		
SPRINKLER WATER FLOW	Х	Χ					Χ	Χ	Χ	Χ							Χ	Х	Х			
SPRINKLER TAMPER			Χ	Χ				Χ			Х						Χ	Х		Χ		
ELEV. EQ. ROOM SMOKE DETECTOR	Х	Х					Χ	Χ	Χ	Х				Х			Х	Х	Х			
ELEV. EQ. ROOM HEAT DETECTOR	Х	Х					Χ	Χ	Χ	Х				Χ	Х		Х	Х	Χ			
ELEV. SHAFT HEAT DETECTORS	Х	Х					Χ	Χ	Χ	Х					Х		Χ	Х	Х			
1ST FLOOR ELEV. LOBBY SMOKE DETECTOR	Х	Х					Χ	Χ	Χ	Х			Х				Χ	Х	Χ			
UPPER FLOOR ELEV. LOBBY SMOKE DETECTOR	Х	Х					Χ	Χ	Χ	Х				Х			Χ	Х	Х			
HOOD SUPPRESSION SYSTEM	Х	Х					Х	Χ	Χ	Х							Х	Х	Х			
NOTIFICATION APPLIANCE CIRCUIT SHORT					Х	Χ		Χ				Х					Χ	Х			Χ	
OPEN CIRCUIT					Х	Χ		Χ				Х					Х	Х			Х	
GROUND FAULT					Х	Χ		Χ				Х					Х	Х			Χ	
FIRE ALARM AC POWER FAILURE					Х	Χ		Χ				Х					Х	Х			Χ	
FIRE ALARM SYSTEM LOW BATTERY					Х	Х		Х				Х					Х	Х			Х	

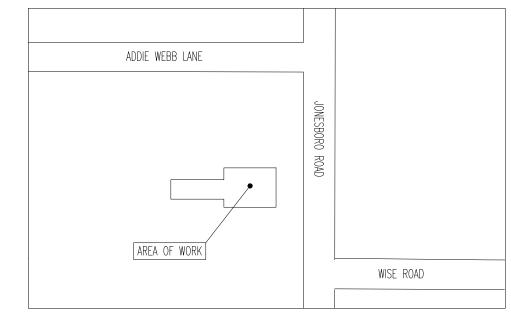



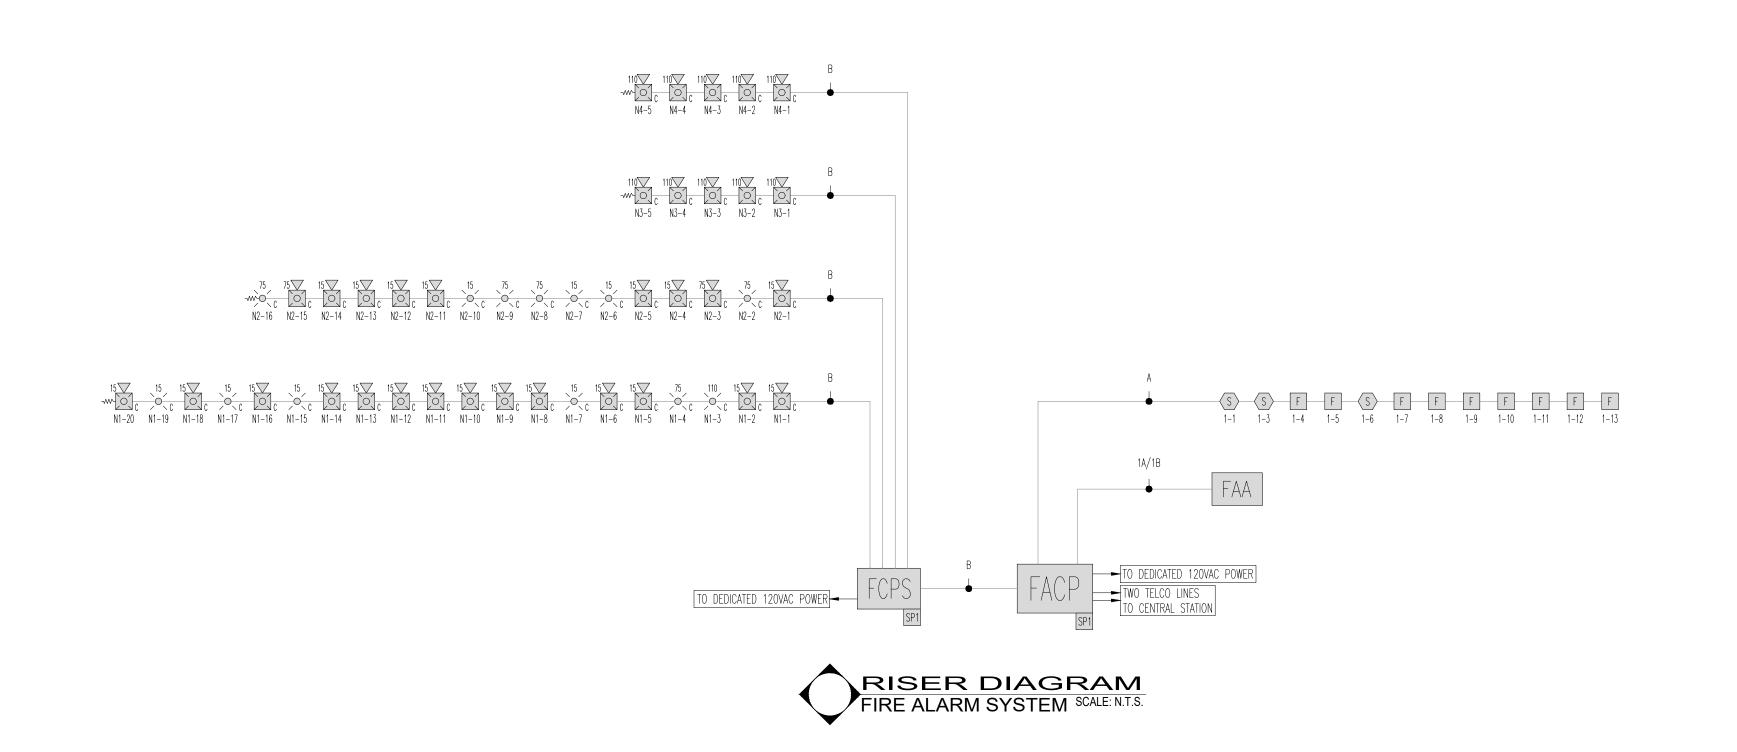





1000 N. MAIN ST., STE. 201 FUQUAY VARINA, N.C. 27526 Ph. 919.346.4630 NC LICENSE #: SP.FA/LV.31726

11.25.2024	ORIGINAL RELEASE	A
<u>DATE</u>	DESCRIPTION	REVISION
PROJECT:	DUNN OPERATIONS CENTER — OPERATIONS BUILDING	<u>'</u>
	1269 JONESBORO RD	
	HARNETT COUNTY	
	N.C. 28334	
FLOOR NUMBER:	OPERATIONS BUILDING	
	OT ENVITORIO BOTEBINO	
DRAWING TITLE:	TIDE ALADM NOTEC LECEND 0.	
	FIRE ALARM NOTES, LEGEND &	
	RISER DIAGRAM	
CEAL O. CIONIATUE	r. Cheet .	
SEAL & SIGNATUR	<u>SHEET #:</u> 1 OF 4	
	DRAWN BY: M.H.	
	CHECKED BY: M.H.	
	WO#:	
	SCALE: AS NOTED	
	CONTACT:	
	DRAWING NO:	

FA-001


PLOT DATE / TIME: LAST SAVE DATE / TIME: 11/26/2024 4:28 PM Tuesday, November 26, 2024 4:09:45 PM

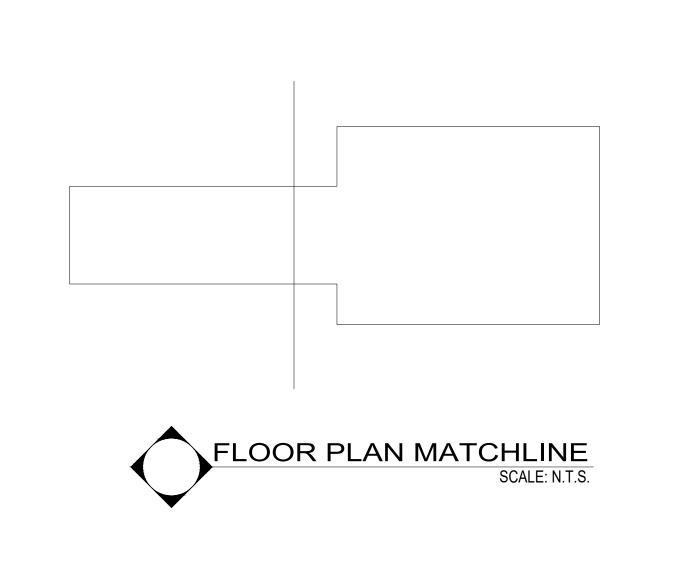

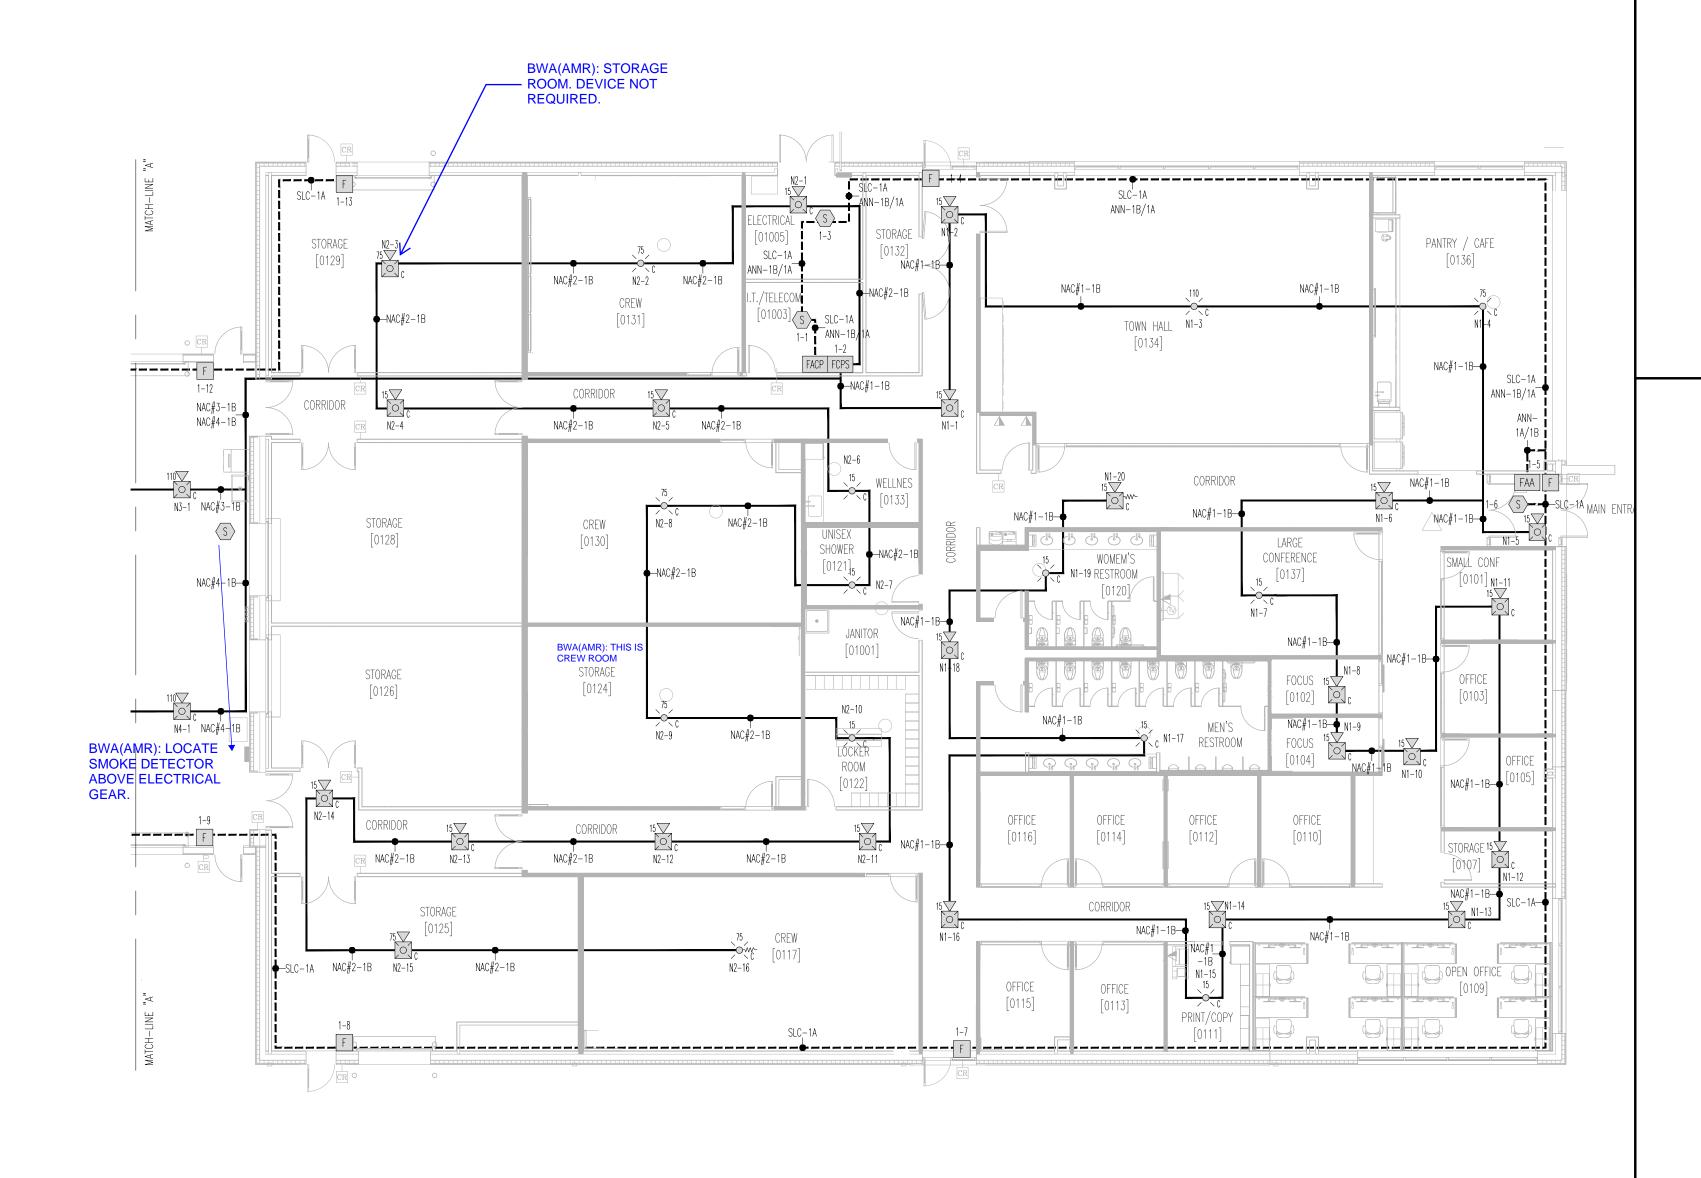



1000 N. MAIN ST., STE. 201 FUQUAY VARINA, N.C. 27526 Ph. 919.346.4630 NC LICENSE #: SP.FA/LV.31726

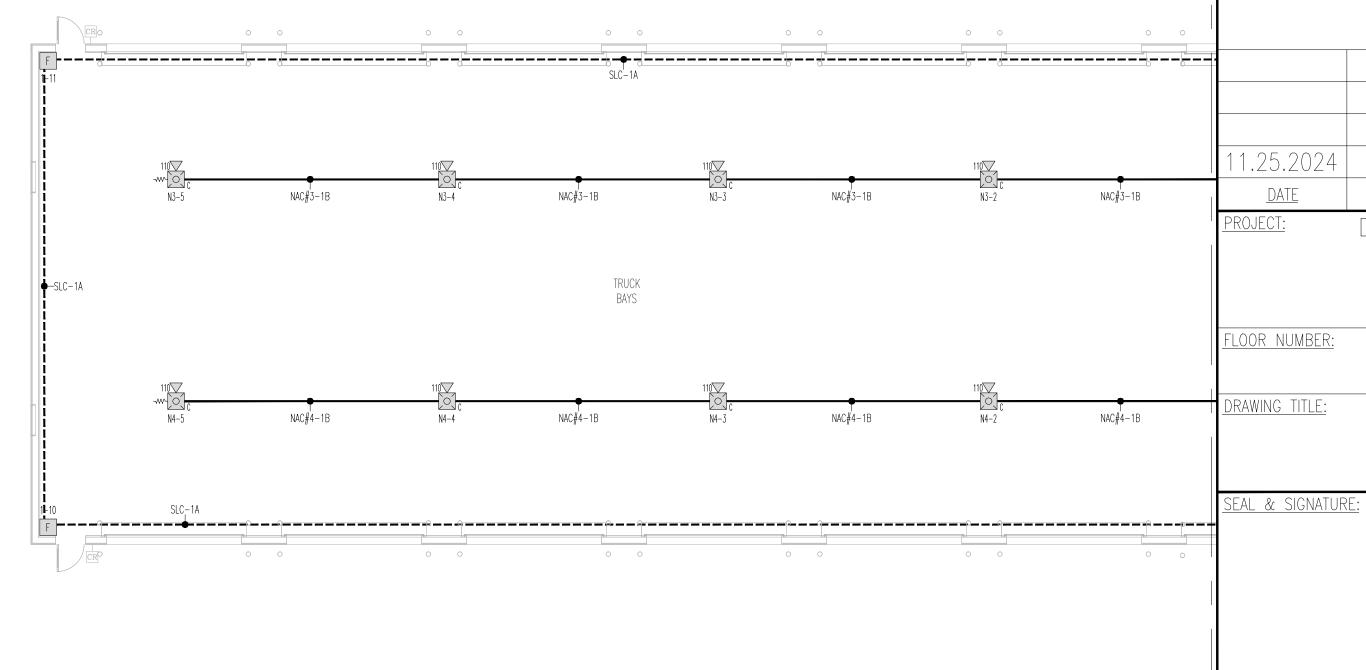

11.25.2024 ORIGINAL RELEASE

DATE

DESCRIPTION

PROJECT:

DUNN OPERATIONS CENTER — OPERATIONS BUILDING

1269 JONESBORO RD

HARNETT COUNTY

N.C. 28334

FLOOR NUMBER:

OPERATIONS BUILDING

DRAWING TITLE: OPERATIONS BUILDING

FIRE ALARM FLOOR PLAN

FIRE ALARM FLOOR PLAN GROUND FLOOR

SHEET #: 2 OF 4

DRAWN BY: M.H.

CHECKED BY: M.H.

WO#:


SCALE: AS NOTED

CONTACT:

DRAWING NO:

FA-002

GROUND FLOOF FIRE ALARM FLOOR PLAN SCALE: 3/32=1-

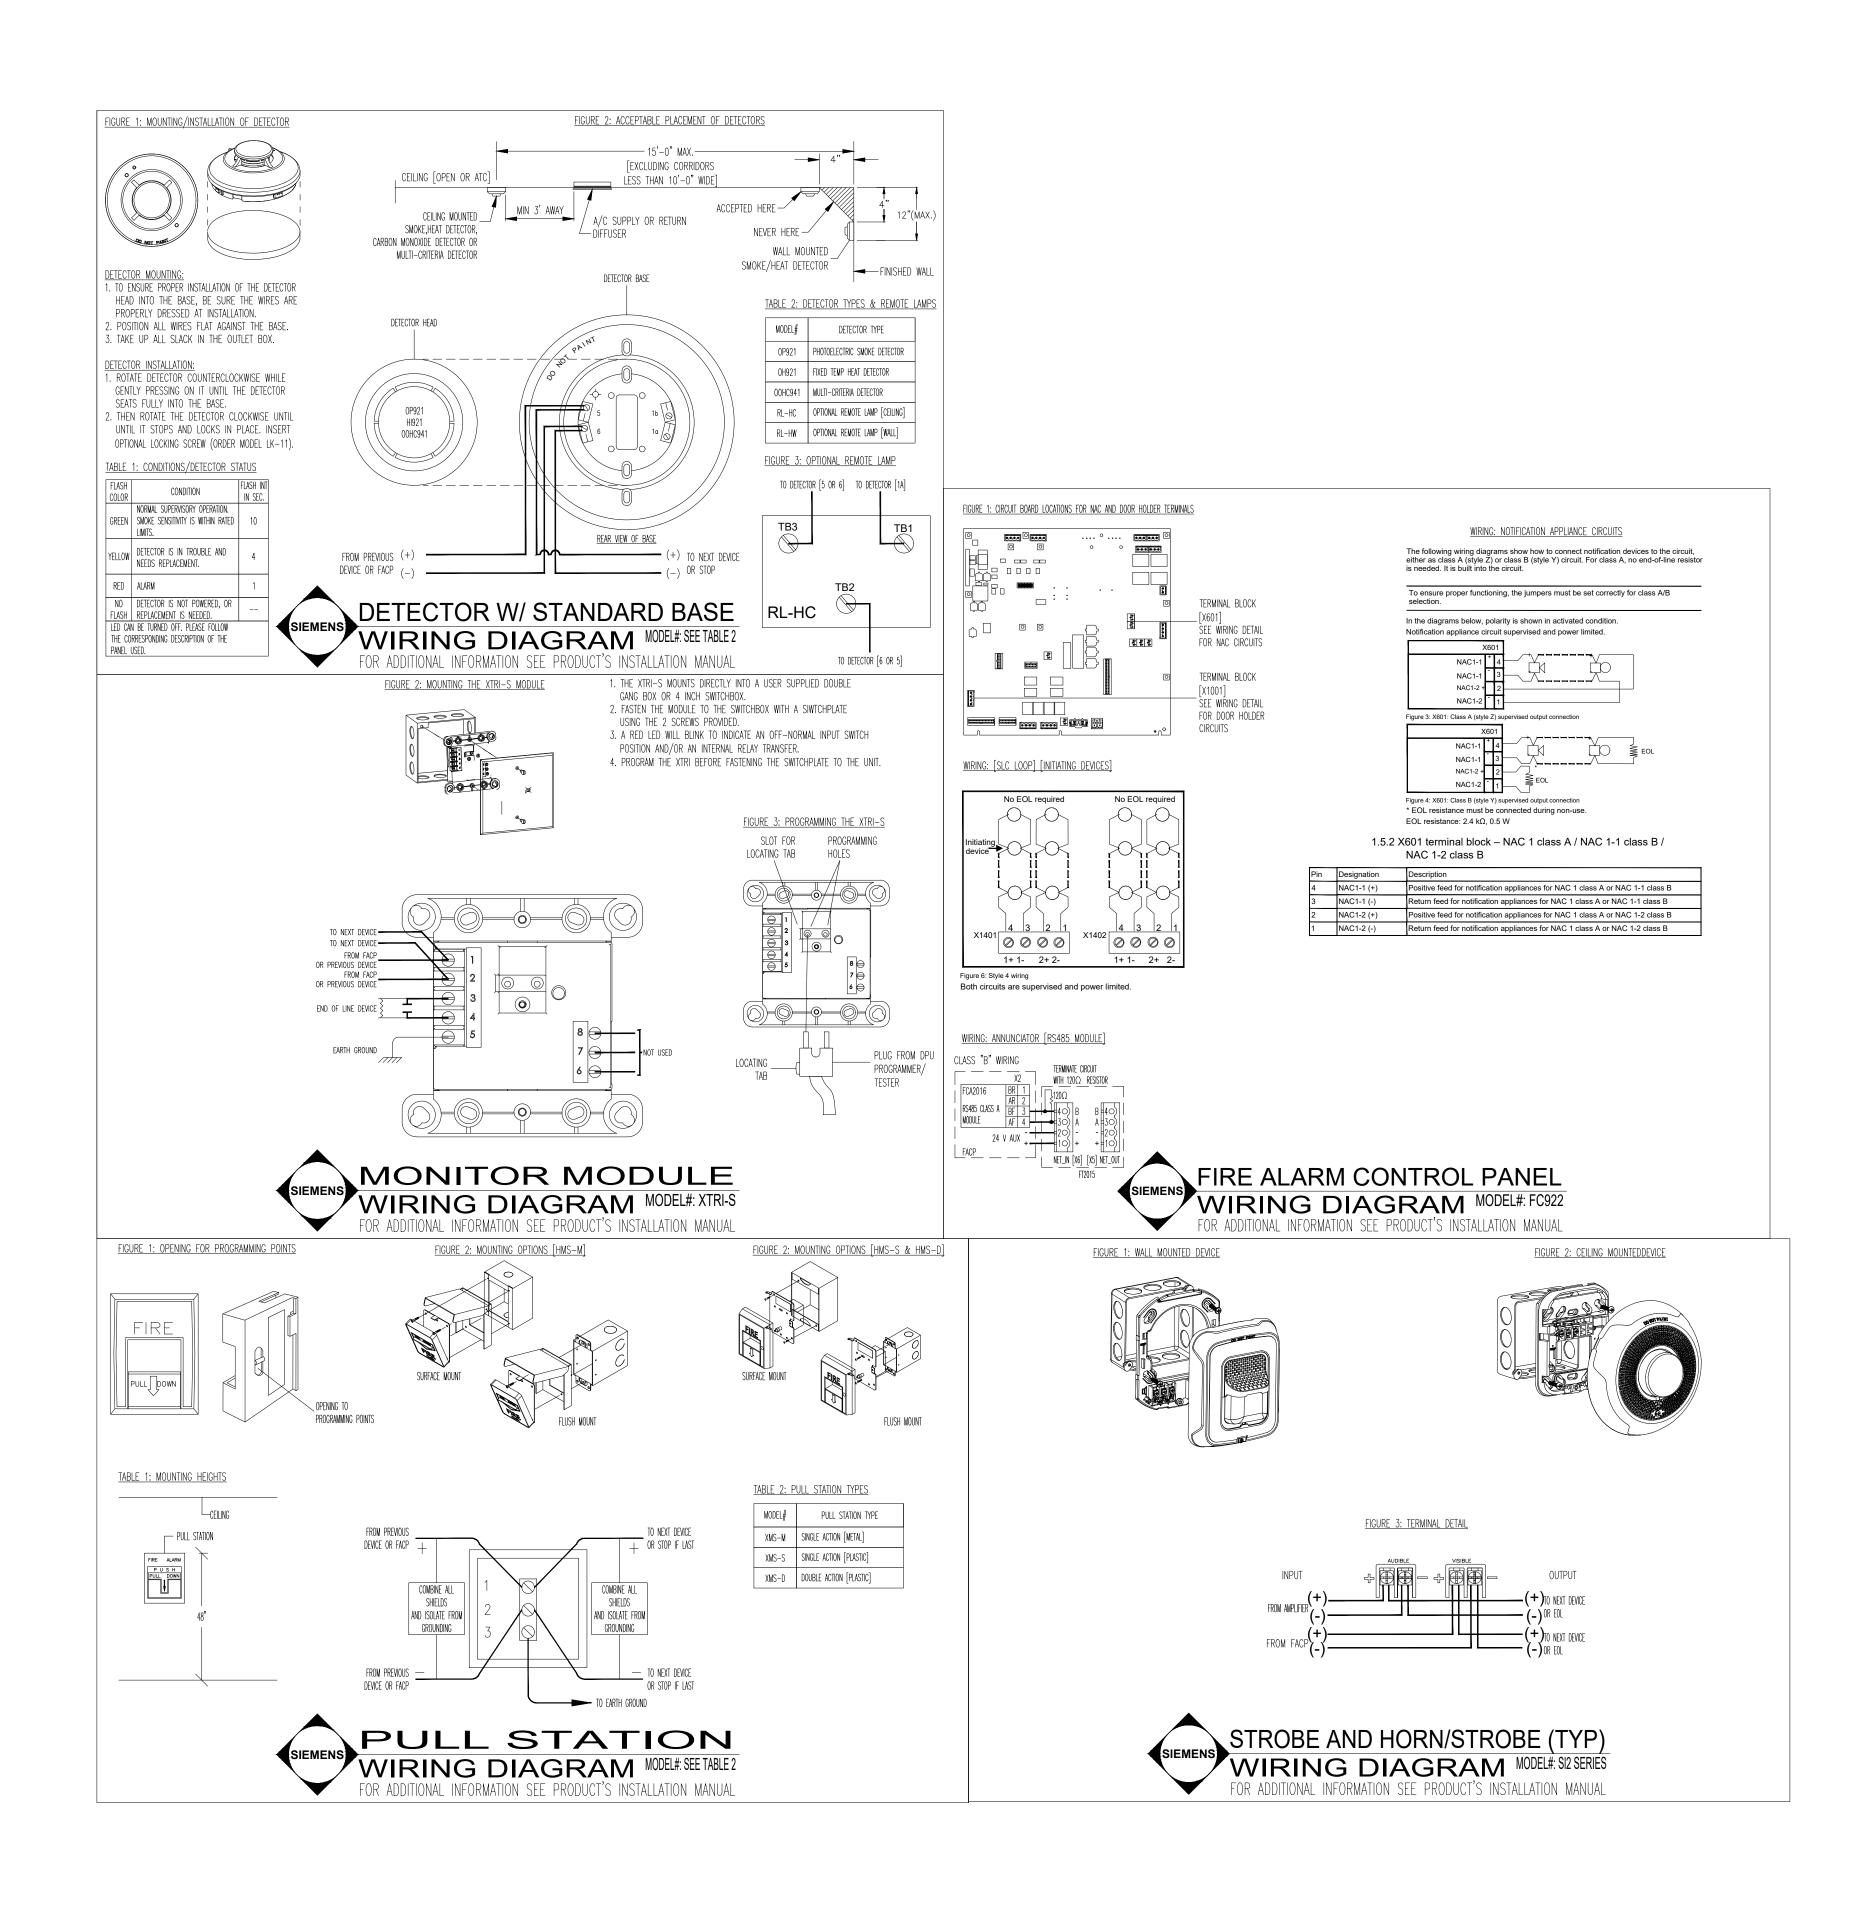




1000 N. MAIN ST., STE. 201 FUQUAY VARINA, N.C. 27526 Ph. 919.346.4630 NC LICENSE #: SP.FA/LV.31726

11.25.2024	ORIGINAL RELEASE	А
<u>DATE</u>	<u>DESCRIPTION</u>	REVISION
PROJECT:	DUNN OPERATIONS CENTER — OPERATIONS BUILDING 1269 JONESBORO RD HARNETT COUNTY N.C. 28334	
FLOOR NUMBER:	OPERATIONS BUILDING	
DRAWING TITLE:	WIRING DETAILS FIRE ALARM DEVICES	
SEAL & SIGNATUR	E: 3 OF 4	
	DRAWN BY: M.H.	
	CHECKED BY: M.H.	
	<u>WO#:</u>	
	scale: AS NOTED	
	<u>CONTACT:</u>	
	DRAWING NO:	
	FA-003	

TE / TIME: LAST SAVE DATE / TIME: 24 4:28 PM Tuesday, November 26, 2024 4:09:45 PM



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25.2024	ORIGINAL RELEASE	A
<u>DATE</u>	<u>DESCRIPTION</u>	REVISION
	1269 JONESBORO RD HARNETT COUNTY N.C. 28334	
R NUMBER:	OPERATIONS BUILDING	
ING TITLE:	PANEL WIRING DETAIL	
& SIGNATUR	SHEET #: 4 OF 4	
	DRAWN BY: M.H.	
	CHECKED BY: M.H.	
	<u>WO#:</u>	

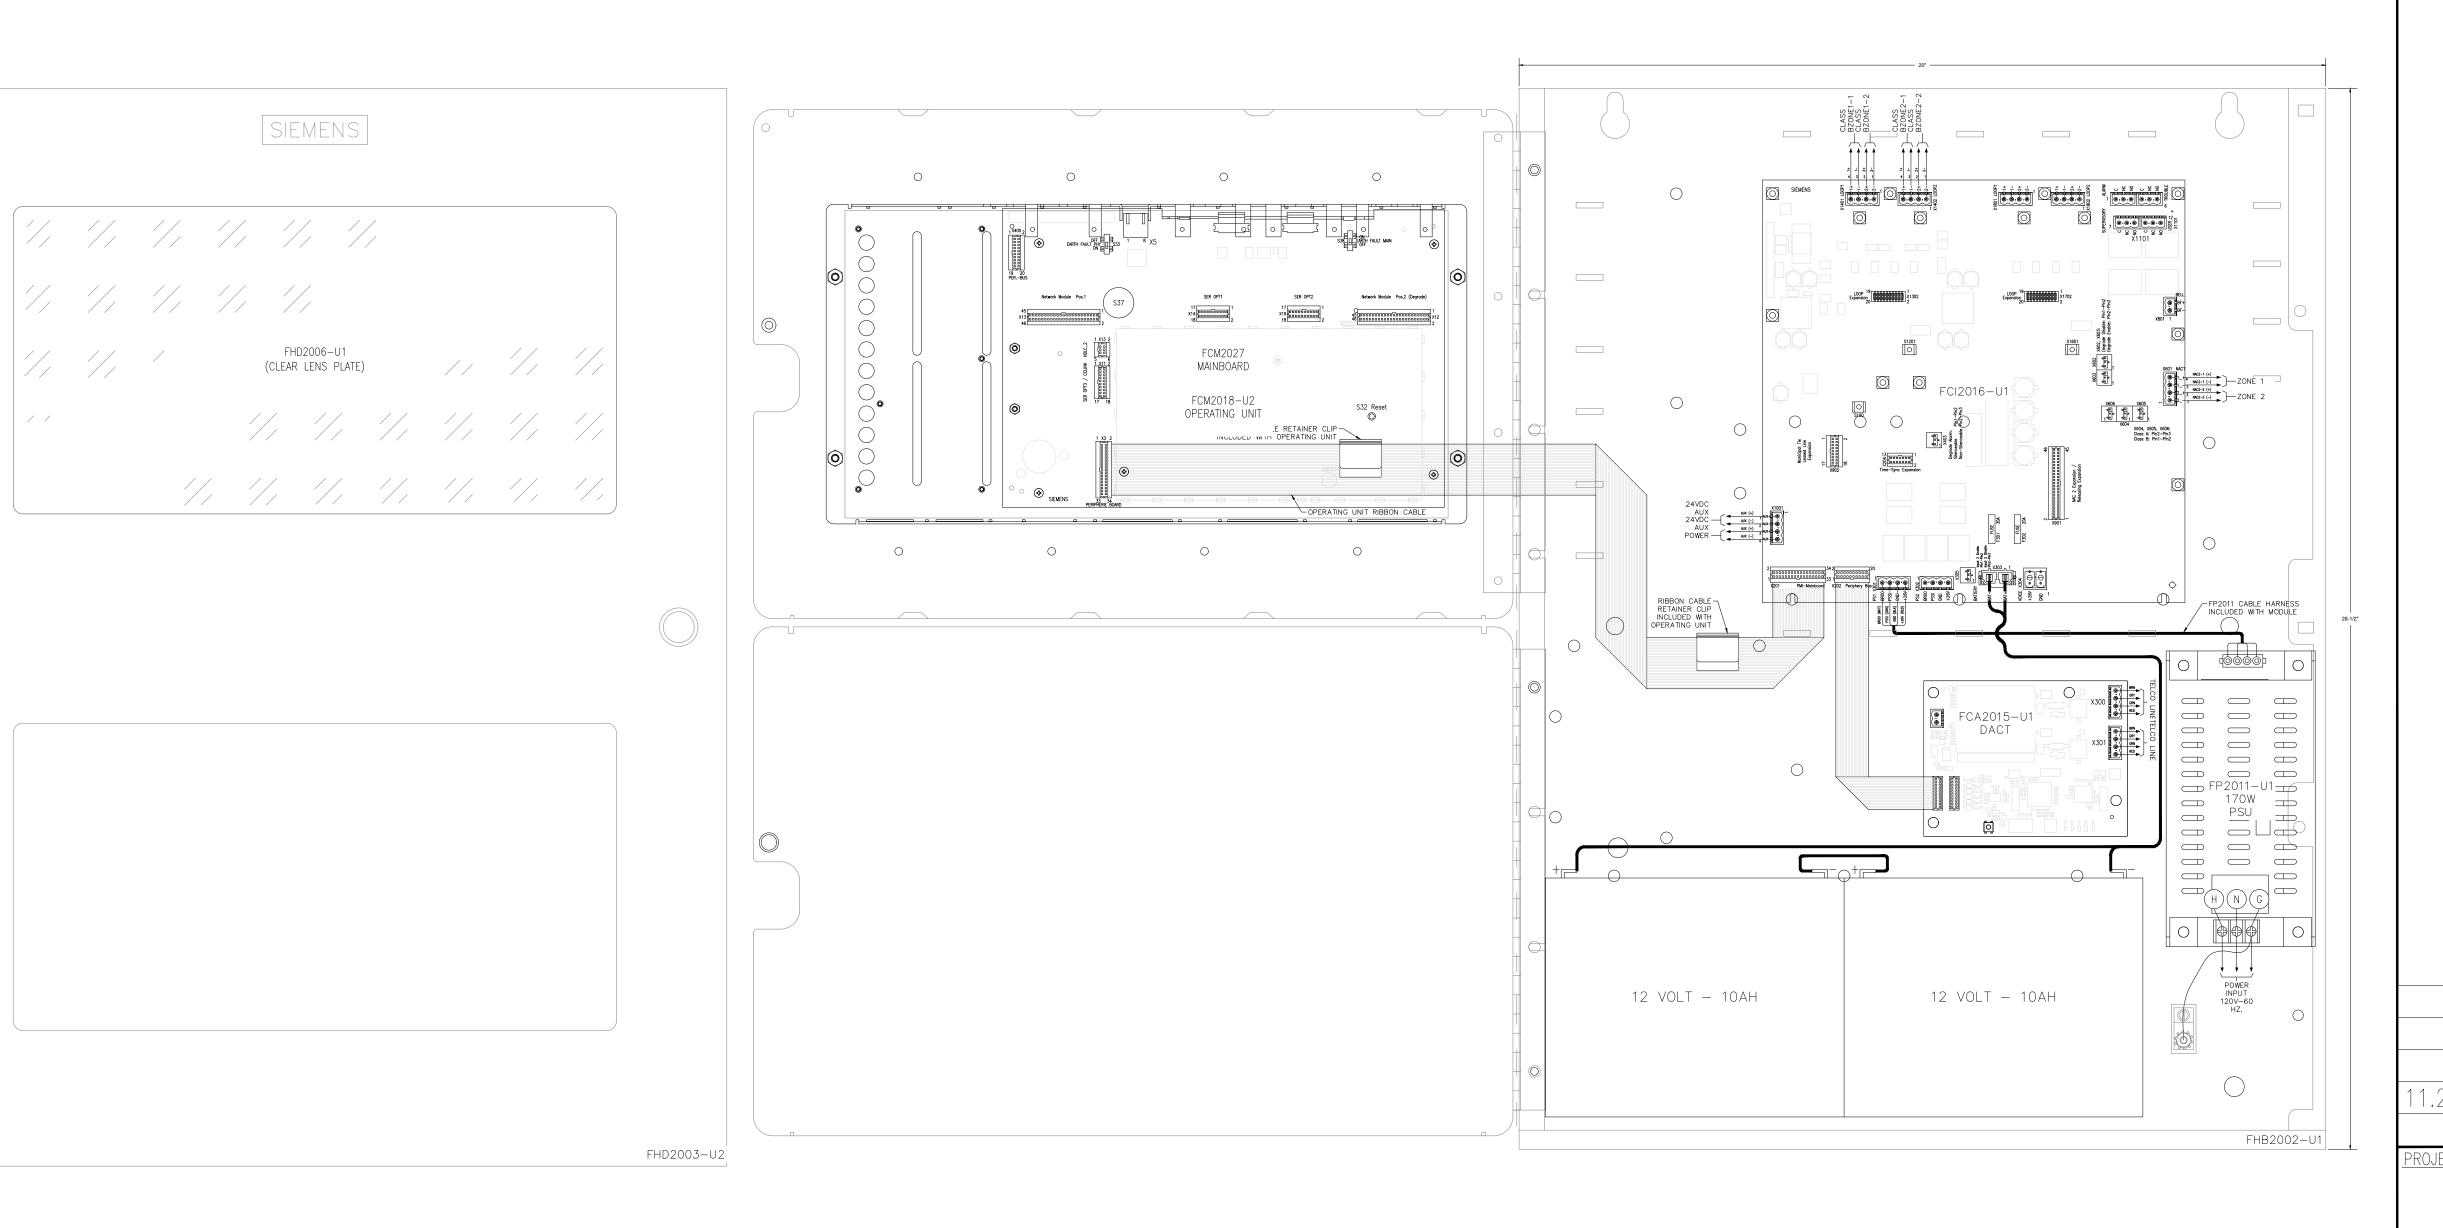DRAWING NO:

AS NOTED

FA-004

