



# GENERAL NOTES:

- MATERIALS AND INSTALLATION SHALL COMPLY WITH APPLICABLE NFPA CODES (NFPA 13 2013 EDITION), STATE BUILDING CODE, LOCAL AUTHORITY HAVING JURISDICTION, AND INSURANCE UNDERWRITER'S REQUIREMENTS.
- ALL MATERIALS AND EQUIPMENT SHALL BE NEW, UL LISTED FOR THE INTENDED USE AND SHALL BE INSTALLED IN FULL COMPLIANCE WITH MANUFACTURER'S RECOMMENDATIONS.
- ALL NEW SPRINKLER PIPE 1" AND SMALLER IS SCHEDULE-40 BLACK STEEL WITH THREADED ENDS AND FITTINGS. ALL NEW SPRINKLER PIPE 1 1/4" AND LARGER IS SCHEDULE-10 BLACK STEEL WITH GROOVED ENDS AND FITTINGS.
- SPRINKLER HEAD SPACING IS BASED ON THE NFPA STANDARDS FOR ORDINARY HAZARD OCCUPANCIES ALLOWING A MAXIMUM HEAD SPACING OF 130 S.F. PER HEAD.
- LOCATIONS OF PIPING AS SHOWN ON THE DRAWINGS ARE APPROXIMATE AND SUBJECT TO MINOR ADJUSTMENTS IN THE FIELD.
- SCOPE OF WORK IS TO INSTALL A NEW ONE RISER SPRINKLER SYSTEM FOR NEW SHELL BUILDING.
- THE WATER TEST INFORMATION HAS BEEN PROVIDED BY J&D SPRINKLER DATED 2/6/2024 INDICATES THE FOLLOWING...




STATIC: 52 PSI  
 RESIDUAL: 36 PSI  
 FLOW: 840 GPM

## SYMBOLS:

- DENOTES A HYDRAULIC CALCULATION POINT OF REFERENCE
- DENOTES A HYDRAULIC REMOTE AREA
- DENOTES NEW SPRINKLER PIPE
- DENOTES UNDERGROUND PIPE
- DENOTES PIPE CENTERLINE ELEVATION AFF
- DENOTES PIPE CENTERLINE BELOW TOP OF STEEL

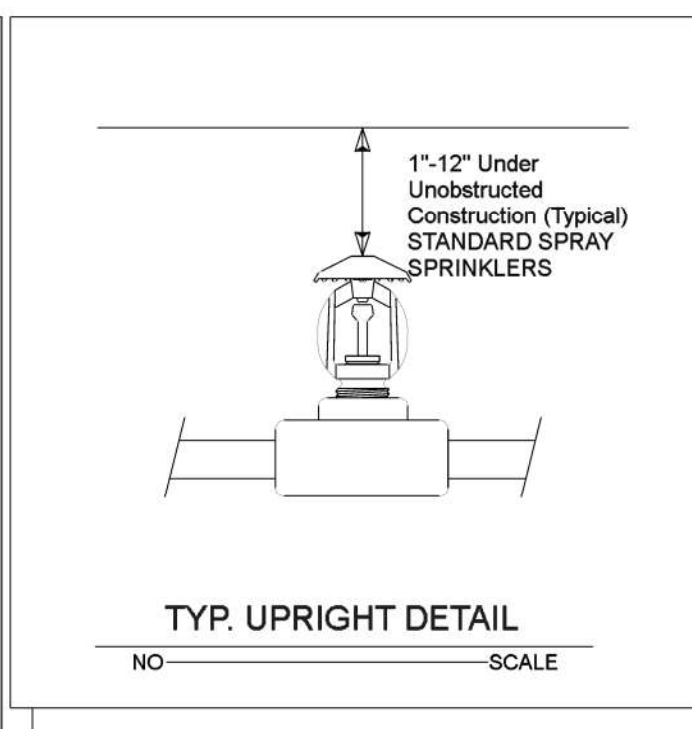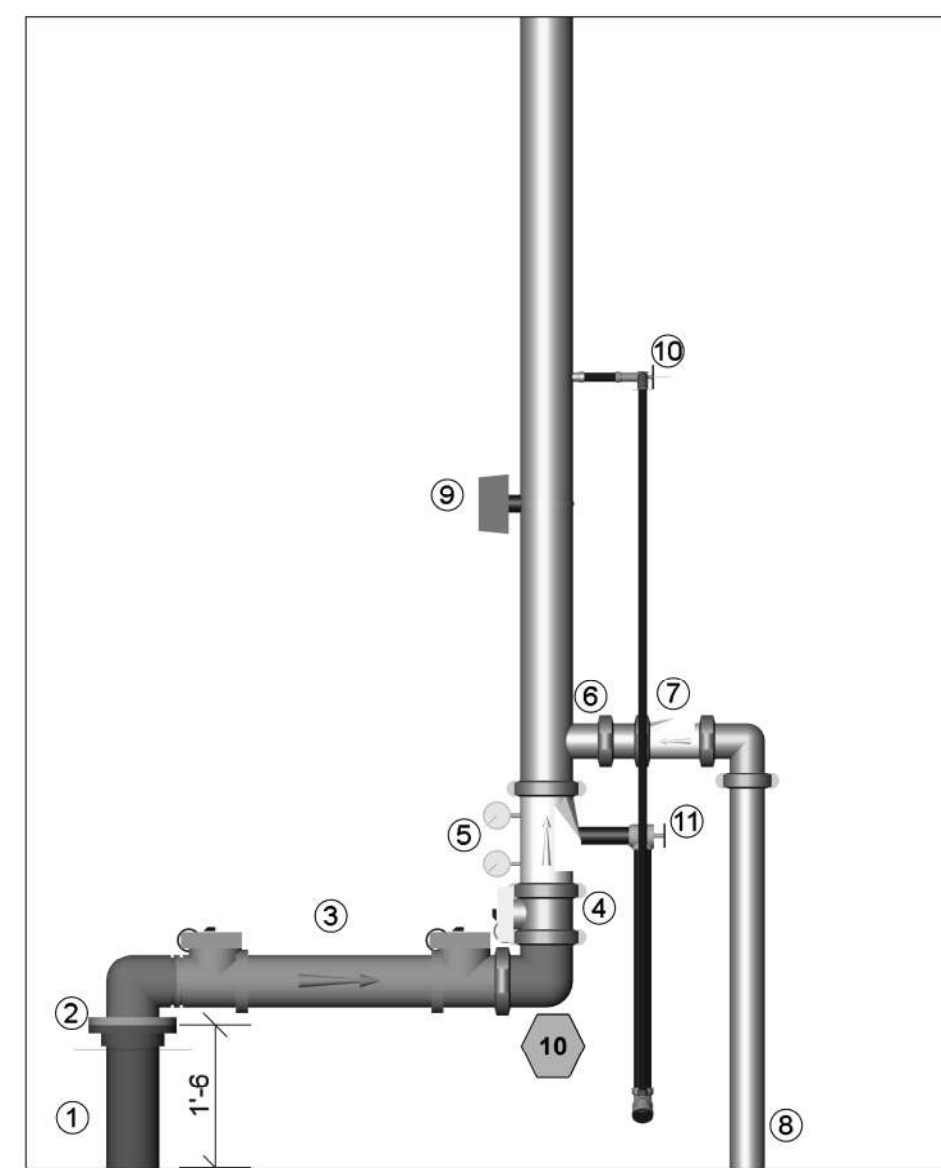


- ### RISER LEGEND
- 6" RUN-IN BY OTHERS
  - 6" GRV-SPLIT FLANGE
  - 6" WILKINS 375ASTDA BACKFLOW
  - 6" BUTTERFLY CONTROL VALVE W/TAMPER
  - 6" VIKING EZ RISER CHECK VALVE
  - 4" GRV OUTLET
  - 4" SWING CHECK VALVE
  - OUT TO YARD FDC
  - FLOW SWITCH
  - TEST & DRAIN ASSMBLY
  - 2" MAIN DRAIN

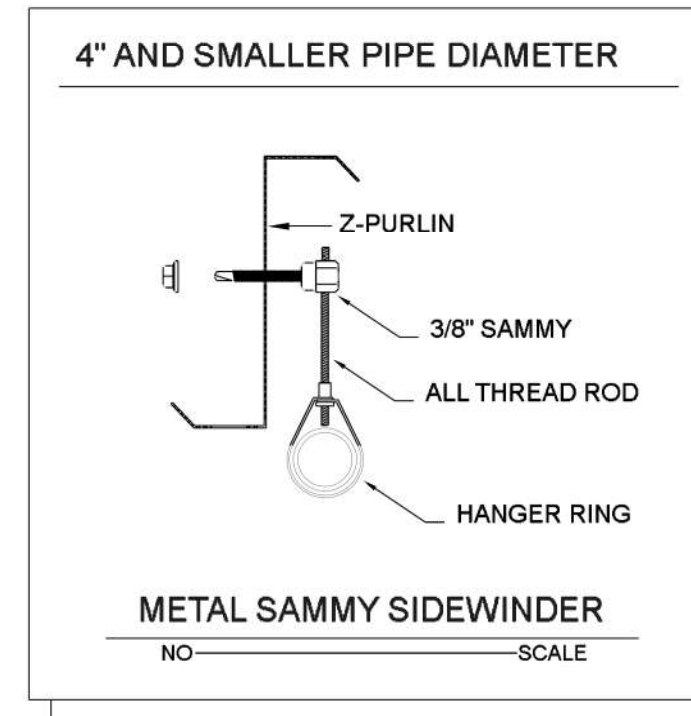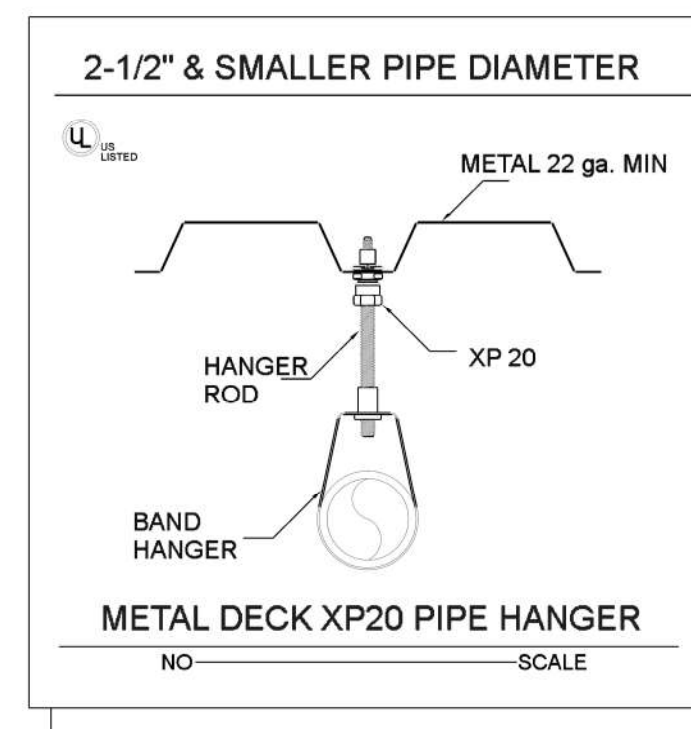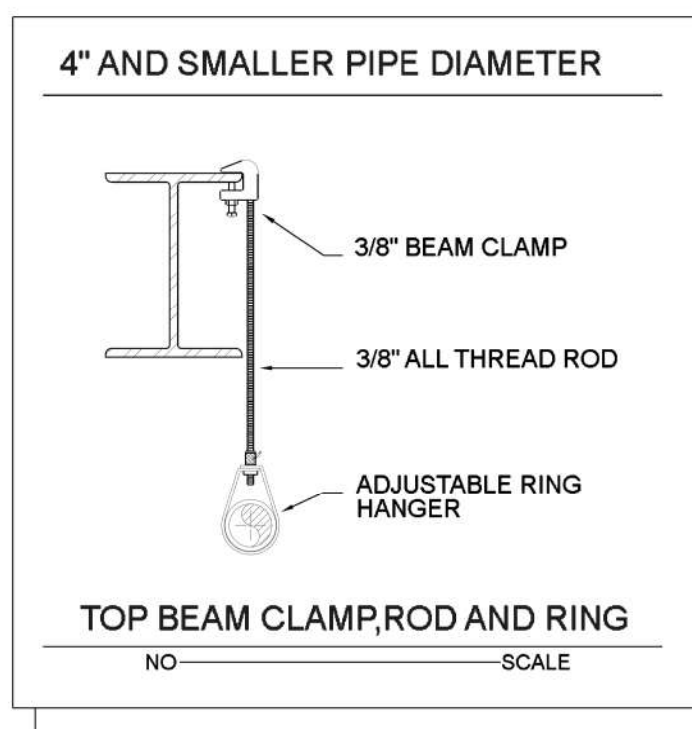

HANGER INSTALLATION REQUIREMENTS										
MAXIMUM DISTANCE BETWEEN HANGERS										
NOMINAL PIPE SIZE	3/4"	1"	1-1/4"	1-1/2"	2"	2-1/2"	3"	4"	6"	
BLAZEMASTER CPVC	5' 6"	6' 0"	6' 6"	7' 0"	8' 0"	9' 0"	10' 0"	N/A	N/A	
THREADABLE LIGHTWALL	N/A	12' 0"	12' 0"	12' 0"	12' 0"	12' 0"	12' 0"	N/A	N/A	
STEEL PIPE (10' 40')	N/A	12' 0"	12' 0"	15' 0"	15' 0"	15' 0"	15' 0"	15' 0"	15' 0"	

100 PSI STATIC PRESSURE ON SYSTEM REQUIRES UP-LIFT RESTRAINT WITHIN 12 INCHES HORIZONTALLY OF HEAD FOR ARM-OVERS AND END OF BRANCH LINE  
 THE UNSUPPORTED LENGTH BETWEEN THE END SPRINKLER AND THE LAST HANGER ON THE LINE SHALL NOT EXCEED 36' FOR 1" PIPE, 48' FOR 1 1/4" PIPE AND 60' FOR 1 1/2" PIPE OR LARGER  
 THE CUMULATIVE HORIZONTAL LENGTH OF AN UNSUPPORTED ARM/OVER TO A SPRINKLER, SPRINKLER DROP, OR SPRING-UP SHALL NOT EXCEED 24'

TRAPEZE INSTALLATION REQUIREMENTS									
SPAN OF TRAPEZE (Schedule 10)	NOMINAL PIPE SIZE SUPPORTED								
	1"	1-1/4"	1-1/2"	2"	2-1/2"	3"	4"	6"	
1 FT. 6 IN.	1"	1"	1"	1"	1"	1"	1-1/4"	1-1/4"	
2 FT. 0 IN.	1"	1"	1"	1-1/4"	1-1/4"	1-1/4"	1-1/4"	1-1/2"	2"
3 FT. 0 IN.	1-1/4"	1-1/4"	1-1/4"	1-1/4"	1-1/2"	1-1/2"	1-1/2"	2"	
4 FT. 0 IN.	1-1/2"	1-1/2"	1-1/2"	1-1/2"	2"	2"	2"	2-1/2"	2-1/2"
5 FT. 0 IN.	2"	2"	2"	2"	2"	2"	2"	2-1/2"	2-1/2"
6 FT. 0 IN.	2"	2"	2"	2"	2"	2-1/2"	2-1/2"	3"	
7 FT. 0 IN.	2"	2"	2"	2-1/2"	2-1/2"	2-1/2"	2-1/2"	3"	
8 FT. 0 IN.	2-1/2"	2-1/2"	2-1/2"	2-1/2"	2-1/2"	2-1/2"	2-1/2"	3"	
9 FT. 0 IN.	2-1/2"	2-1/2"	2-1/2"	2-1/2"	2-1/2"	2-1/2"	3"	4"	
10 FT. 0 IN.	2-1/2"	2-1/2"	2-1/2"	2-1/2"	2-1/2"	3"	3"	4"	

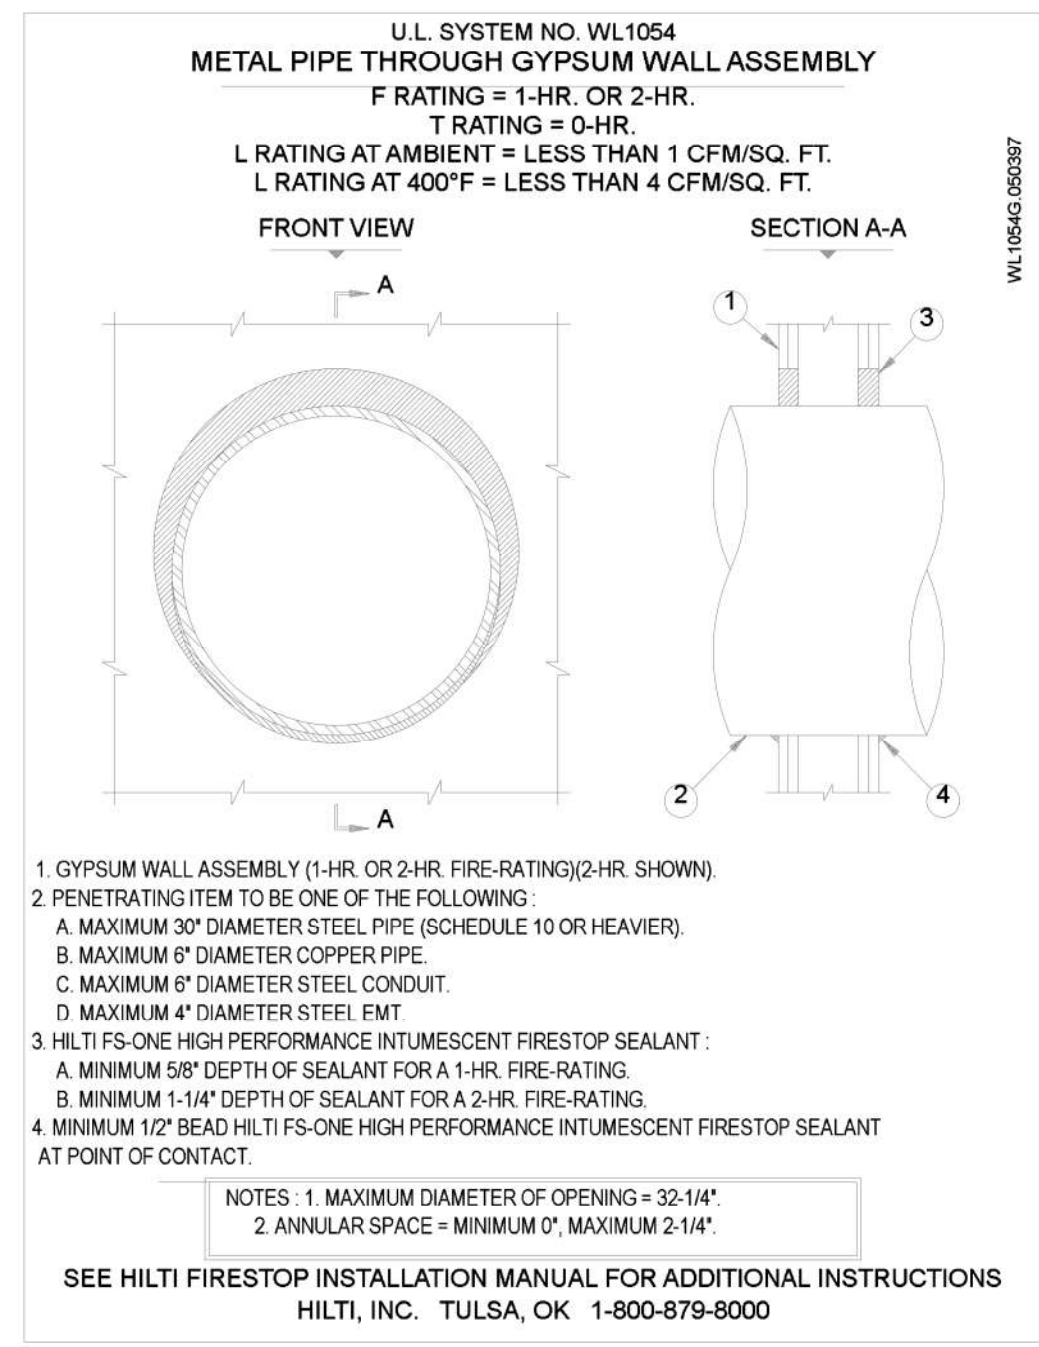

## Sprinkler Design Data

Project Name: HARBOR FREIGHT TOOLS	System: WET
Project Street Address: 46 SHRIJI LN, ERWIN NC	Sys. Sq. Ft.: 15,632
Suite: -	Floor#: -
Designed By: J&D SPRINKLER CO	Phone: 919-553-2356
Occupancy: MERCHANTILE	Hazard: ORDINARY GRP II
	Ceiling Height: VARIES
	Total Bldg. Hgt.: 22'-0"

## Design Summary

Design Method	CALCULATED	-	-	-	-
Design Area #	1	-	-	-	-
Location	-	-	-	-	-
Type of System	WET	-	-	-	-
Hazard Class	ORDINARY GRP II	-	-	-	-
Criteria From	NFPA13 2013 ED	-	-	-	-
Design Area	1500 S.F.	-	-	-	-
Sprinkler Spacing	130 S.F. MAX	-	-	-	-
Density	.20	-	-	-	-
K-factor	5.6	-	-	-	-
Hose Allowance	250 GPM	-	-	-	-
# Design Sprinklers	13	-	-	-	-
Special Application Spk.	-	-	-	-	-
Requirement @ BASE					
G.P.M. Req'd	329.08	-	-	-	-
P.S.I. Req'd	30.630	-	-	-	-
Requirement @ TEST					
GPM Required	579.08	-	-	-	-
PSI Required	41.467	-	-	-	-
Safety factor @ Test	2.493	-	-	-	-
Dry Sys. Volume (gal)	-	-	-	-	-

## Water Supply Information

Tested by	J&D SPRINKLER CO	Date/Time	2/6/2024 @ 1:45PM	Pressure Hydrant	-
Hydrant Elevation	-	Flow Hydrant # 1	-	Flow Hydrant #2	-
Static (PSI)	52	Residual (PSI)	36	Flow (gpm)	840

Copy of Water Test Data Included with Calculation is required

HARBOR FREIGHT TOOLS

46 SHRIJI LN  
 ERWIN, NC

J & D SPRINKLER CO. INC.  
 315 W. MAIN ST., CLAYTON, NC 27520  
 PHONE: (919)553-2356 FAX: (919) 359-0622

SHEET TITLE:  
 NOTES/DETAILS

This fire sprinkler planning and design drawing has been prepared by J & D Sprinkler Co. as a licensed fire sprinkler contractor under Article 2 of Chapter 87 of the General Statutes for a & D Sprinkler's scope of work must perform any and all installation work and other work performed in reliance on this drawing pursuant to G.S. § 55B-15(a)(2). Installation work or any other work performed by any other person or entity in reliance on this drawing or any copy thereof is strictly prohibited.  
 c. 2013 J & D Sprinkler Co., Inc.



DANA GRAHAM

NC # 16269FS CERT # 71075  
 NICET LEVEL III

JASON GRAHAM

NC # 16269FS CERT # 121842  
 NICET LEVEL III

REVISION:  
 NO. DATE

Date:  
 4/24/2024

Scale:  
 1/8" = 1'-0"

Job Number:  
 F24084


Drawn By:  
 MWL

Sheet Number  
 FP-1

Supply Flow Test Data	
Test Conducted By	J&D SPRINKLER CO
Test Witnessed By	FARRIN DUNN/TRAVIS CURRY
Date of Test	2/6/2024
Time of Test	1:45PM
Location	46 SHRJIJ LN
Static Pressure	52.000
Residual Pressure:	36.000
Flow	840.00

Reviewed for Fire Code Compliance  
 Harnett County  
 Leslie Jackson  
 05/21/2024 10:46:33 AM

- SYMBOLS:**
- XX DENOTES A HYDRAULIC CALCULATION POINT OF REFERENCE
  - DENOTES A HYDRAULIC REMOTE AREA
  - DENOTES NEW SPRINKLER PIPE
  - - - DENOTES UNDERGROUND PIPE
  - \*'-0" FF Ⓢ DENOTES PIPE CENTERLINE ELEVATION AFF
  - \*'-0" TS Ⓢ DENOTES PIPE CENTERLINE BELOW TOP OF STEEL

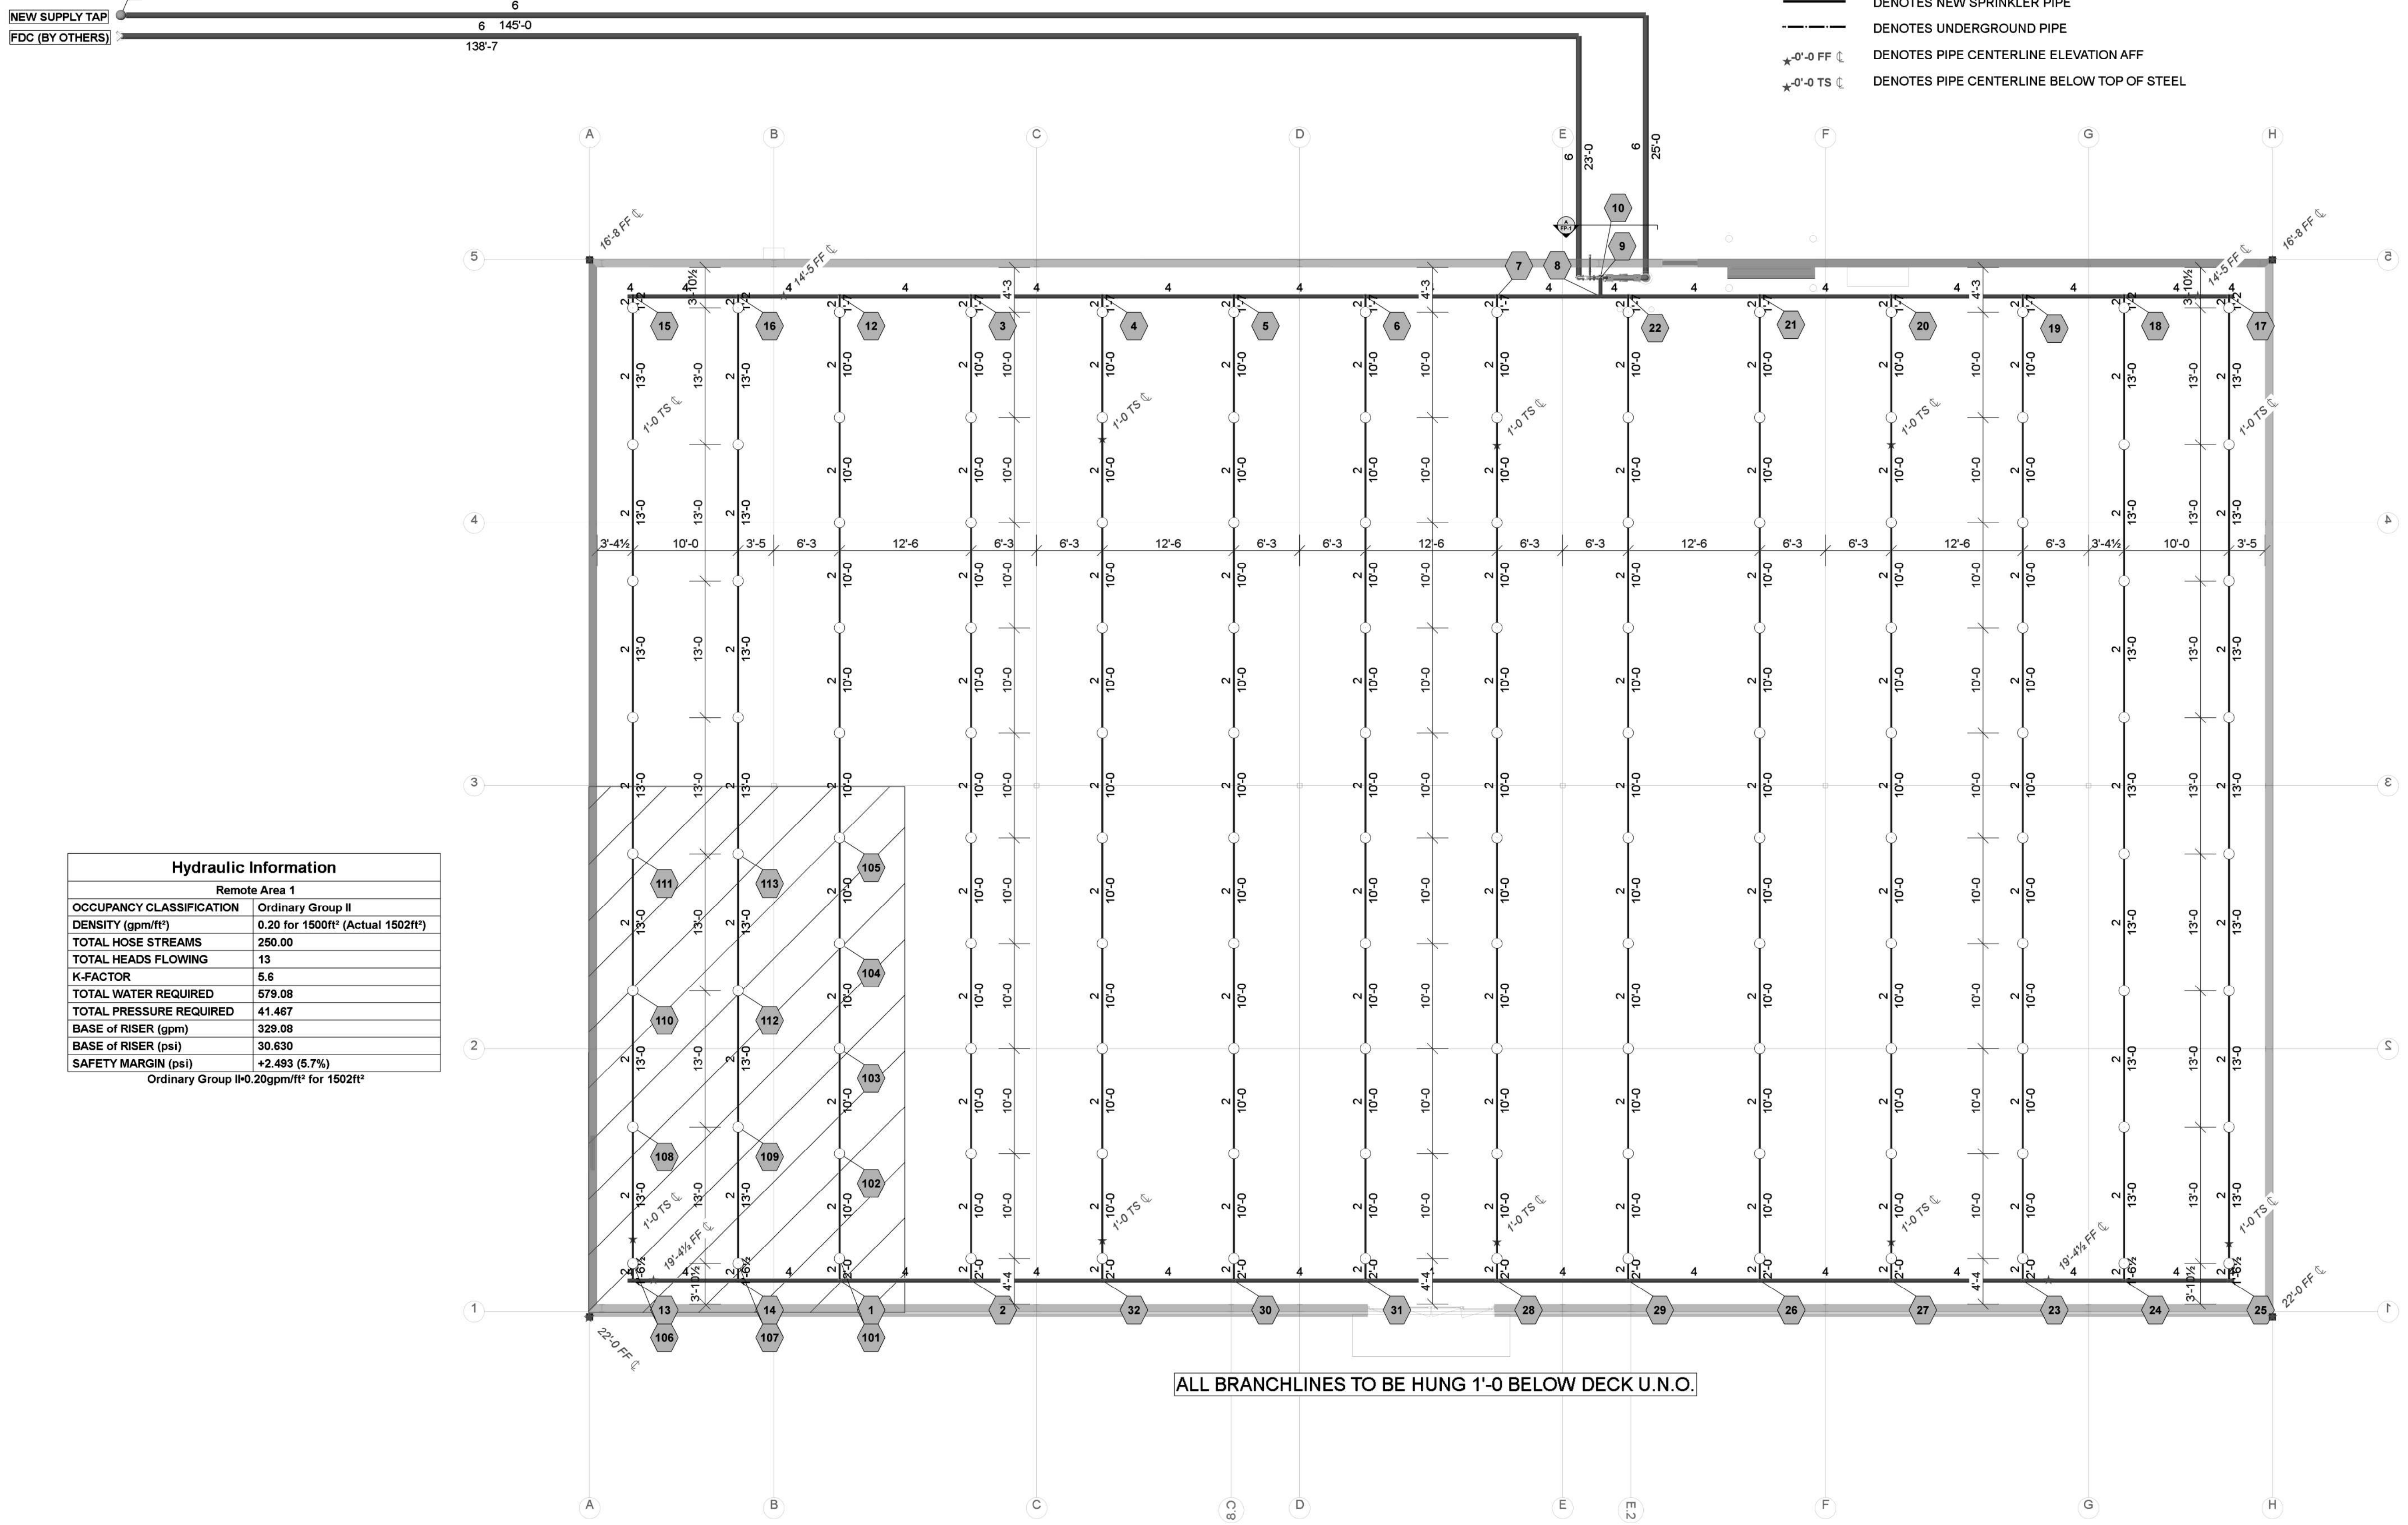

Hydraulic Information	
Remote Area 1	
OCCUPANCY CLASSIFICATION	Ordinary Group II
DENSITY (gpm/ft²)	0.20 for 1500ft² (Actual 1502ft²)
TOTAL HOSE STREAMS	250.00
TOTAL HEADS FLOWING	13
K-FACTOR	5.6
TOTAL WATER REQUIRED	579.08
TOTAL PRESSURE REQUIRED	41.467
BASE OF RISER (gpm)	329.08
BASE OF RISER (psi)	30.630
SAFETY MARGIN (psi)	+2.493 (5.7%)
Ordinary Group II=0.20gpm/ft² for 1502ft²	

ALL BRANCHLINES TO BE HUNG 1'-0" BELOW DECK U.N.O.

Sprinkler Legend											
Symbol	Manufacturer	SIN	Model	Quantity	K-Factor	Type	Size	Response	Finish	Temperature	Note
○	Victaulic	V2704	FL-QR	132	5.6	Upright	½"	Quick	Brass	200°F	
				Total =	132						

Plan North  
 PIPING PLAN  
 1/8"=1'-0"

HARBOR FREIGHT TOOLS  
 46 SHRJIJ LN  
 ERWIN, NC

**J & D SPRINKLER CO. INC.**  
 315 W. MAIN ST., CLAYTON, NC 27520  
 PHONE: (919)553-2356 FAX: (919) 359-0622

SHEET TITLE:  
 PIPING PLAN

This fire sprinkler planning and design drawing has been prepared by J & D Sprinkler Co. as a licensed fire sprinkler contractor under Article 2 of Chapter 87 of the General Statutes for J & D Sprinkler Co. The designer must perform any and all installation work and other work performed in reliance on this drawing pursuant to G.S. § 55B-15(a)(2). Installation work or any other work performed by any other person or entity in reliance on this drawing or any copy thereof is strictly prohibited.  
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**J&D SPRINKLER CO. INC.**  
 DANA GRAHAM  
 NC # 16269FS CERT # 71075  
 NICET LEVEL III  
 JASON GRAHAM  
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